ADDITION / ALTERATIONS AND RENOVATIONS TO JOSEPH C. SHANER MEMORIAL ELEMENTARY SCHOOL 5801 3RD ST, MAYS LANDING, NJ 08330 HAMILTON TOWNSHIP BOARD OF EDUCATION

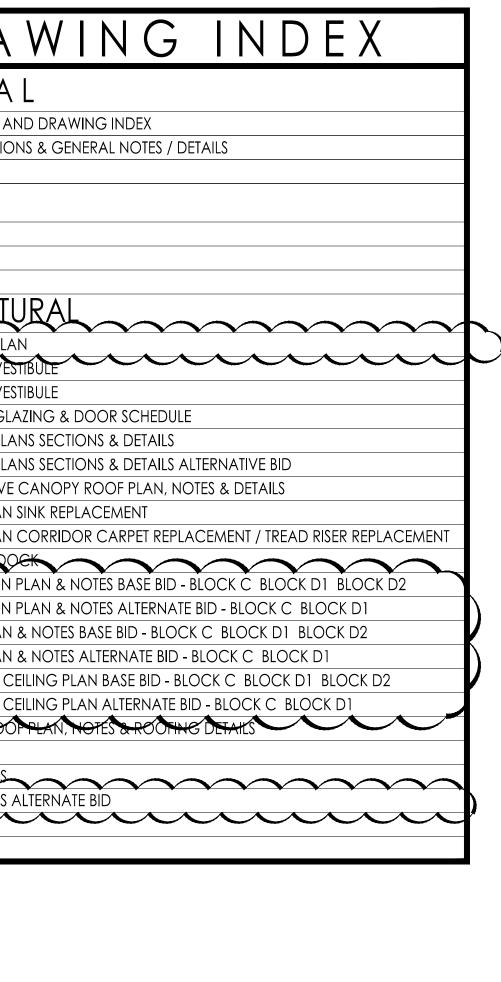
5801 3rd, MAYS LANDING, NJ 08330



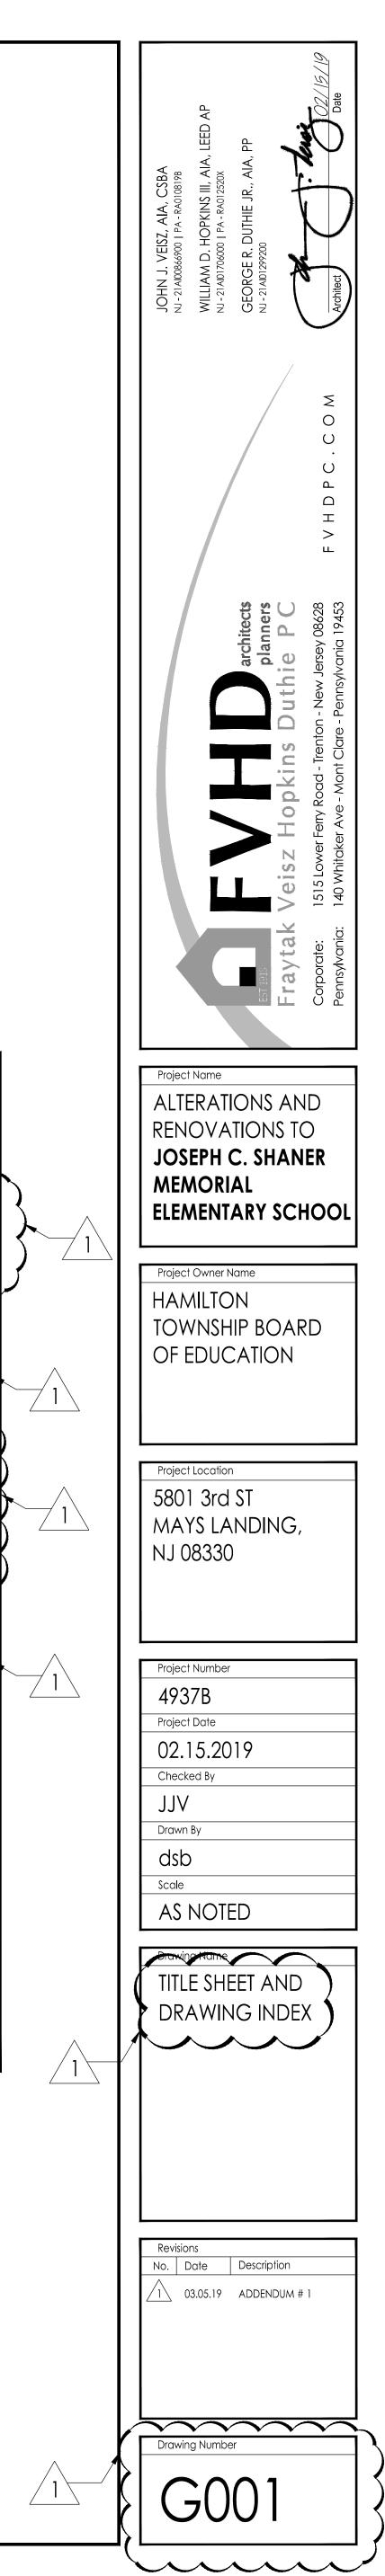
GILLAN & HARTMANN, INC MEP ENGINEERS | MONT CLARE - PA

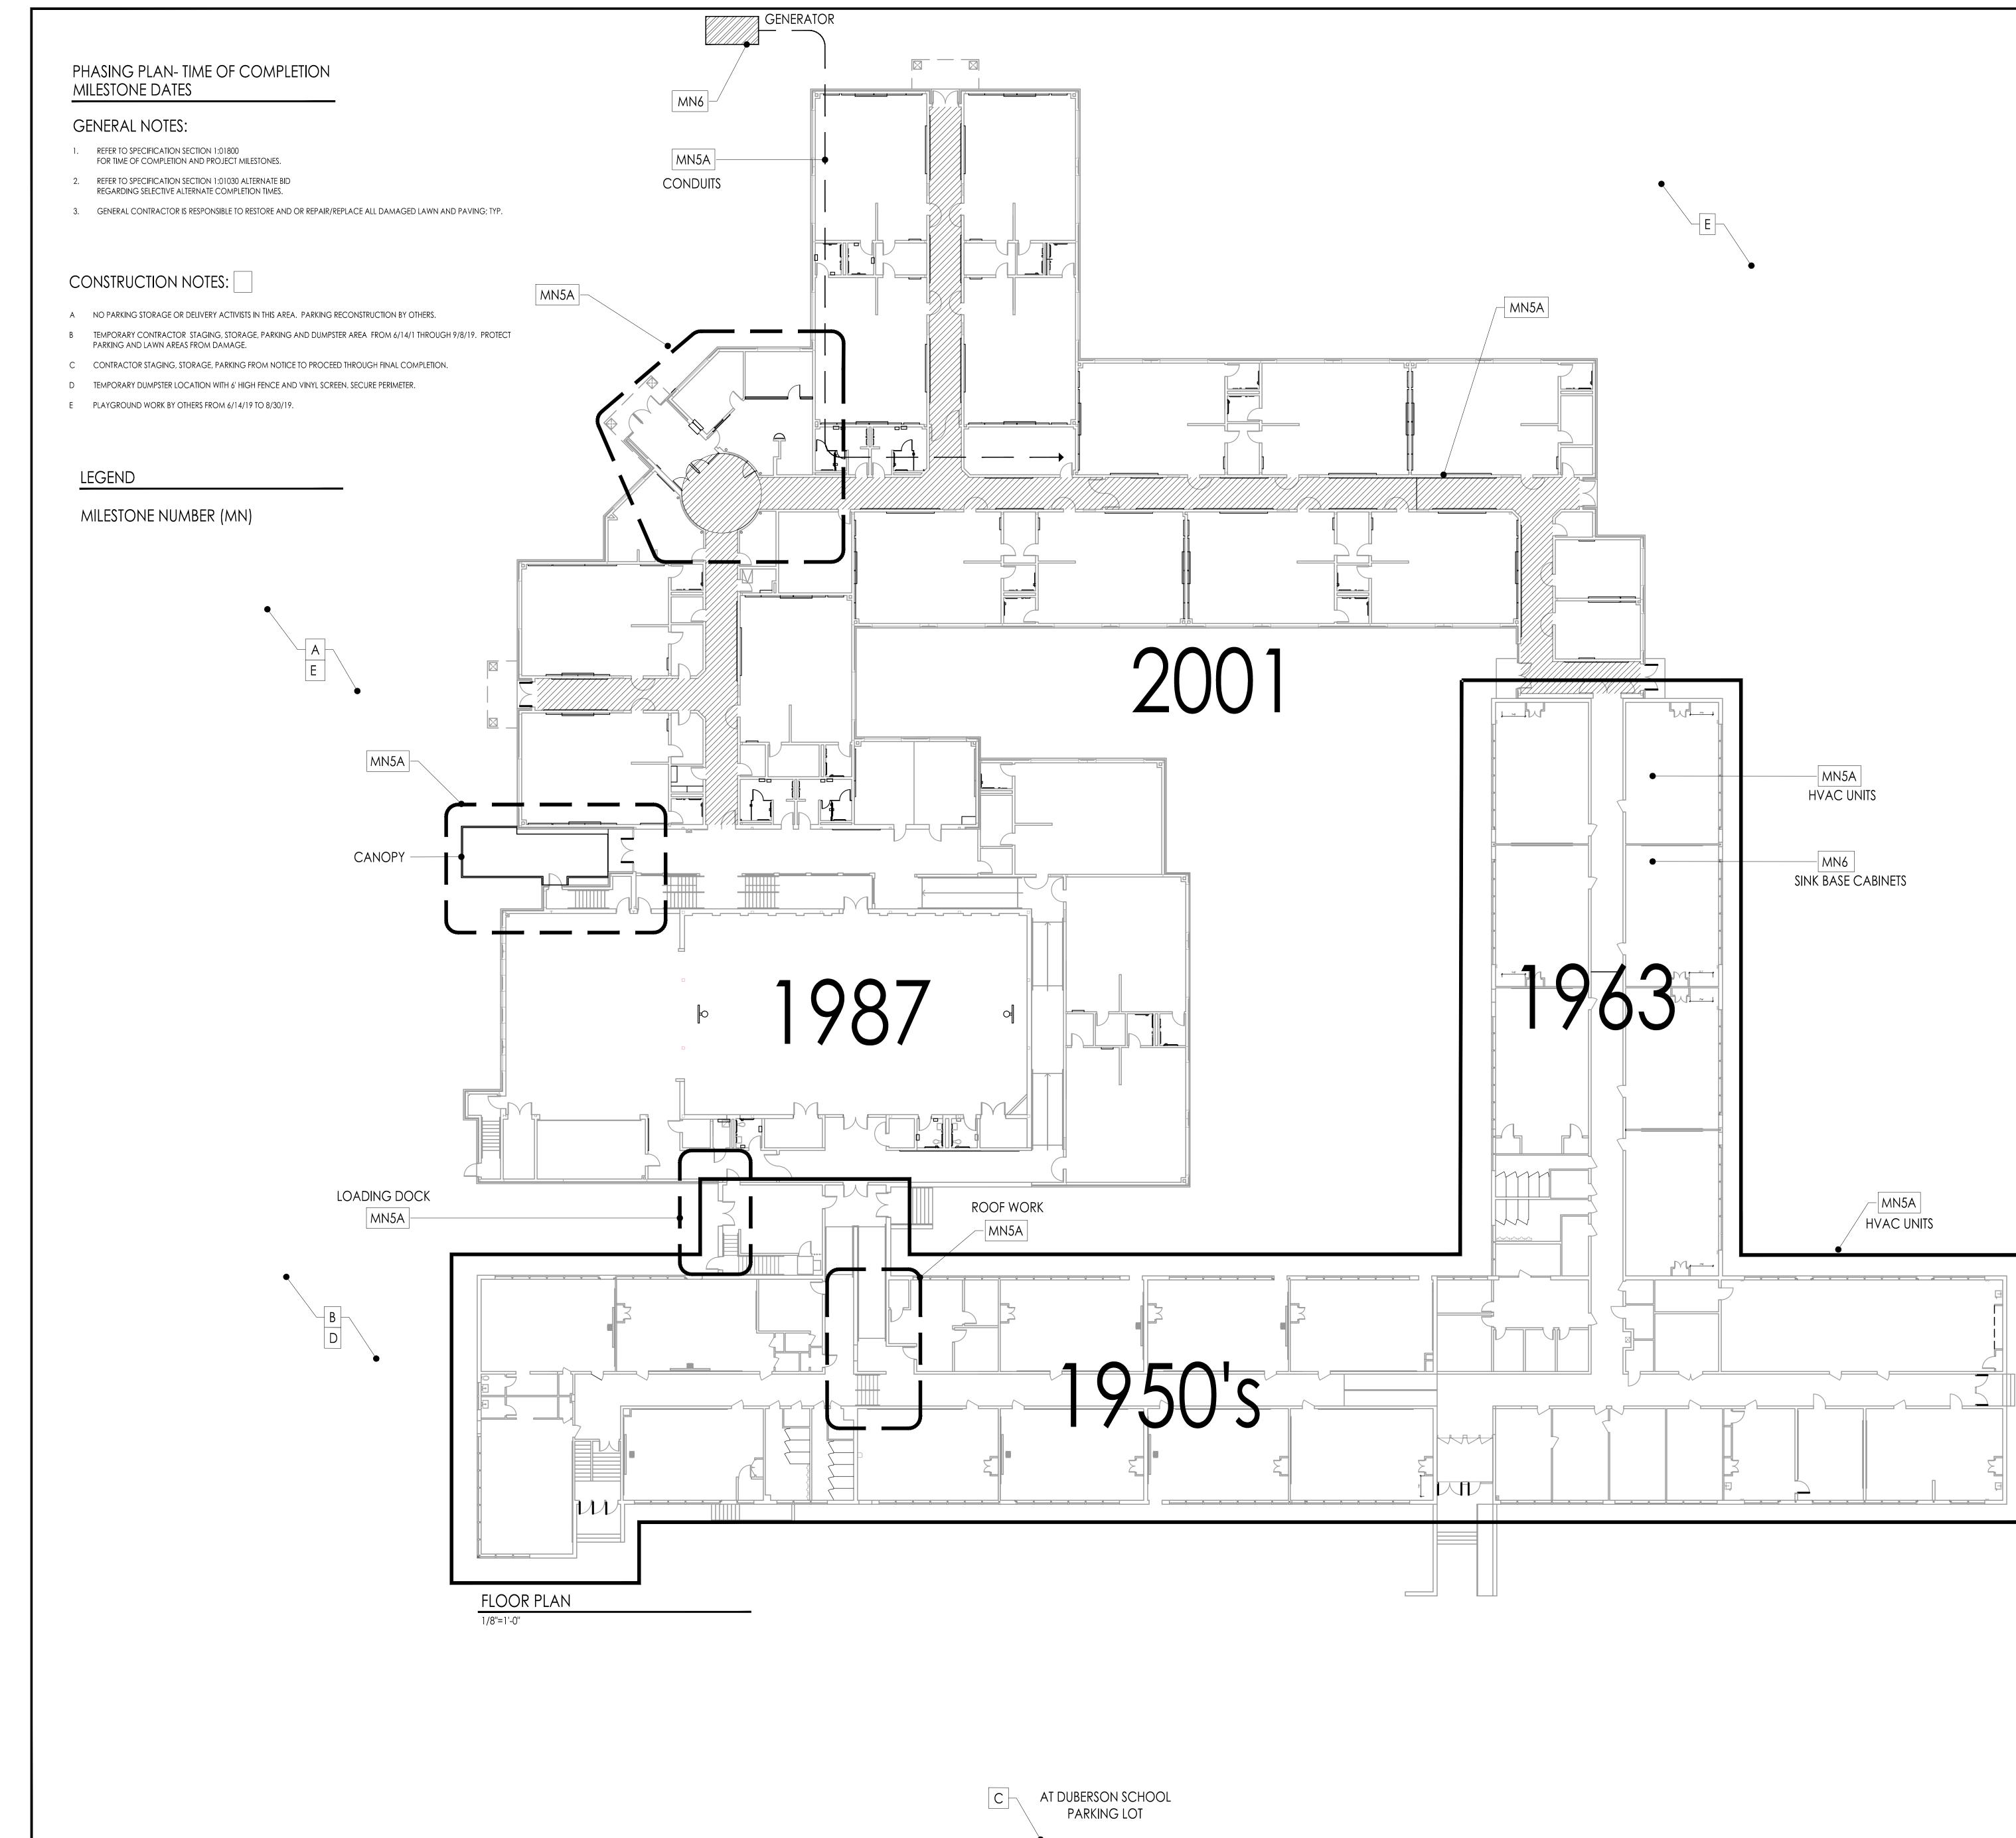
Addition / Alterations / Renovations at Joesph C. Shaner Memorial Elementary School FVHD 4937B - NJ DOE No. 1940-060-18-1000

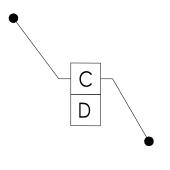
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	A102	SECURITY GI
	A103	
vhdpc.com	A104	
	A105 A106	ALTERNATIV
	A100	FLOOR PLAN
		LOADING
	A109	DEMOLITION
	A 109a	DEMOLITION
	A110	FLOOR PLAN
	A110a	FLOOR PLAN
	A111	REFLECTED (
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	A201	ELEVATIONS
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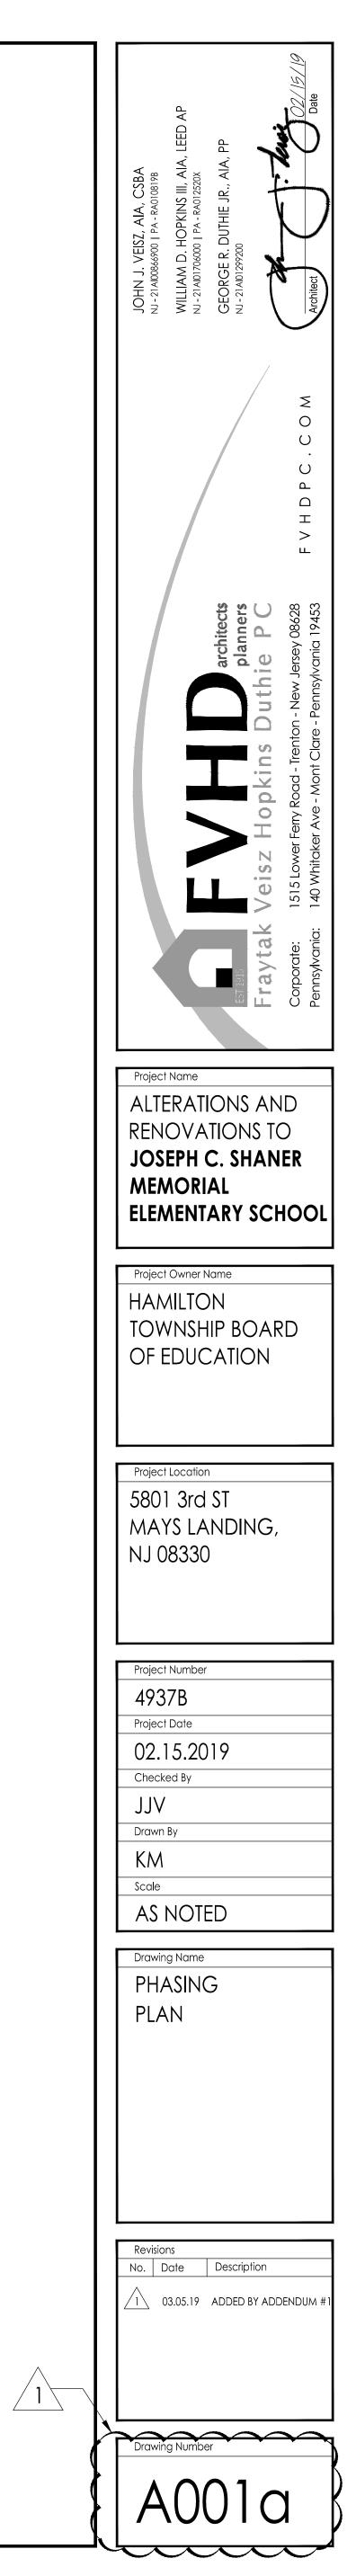


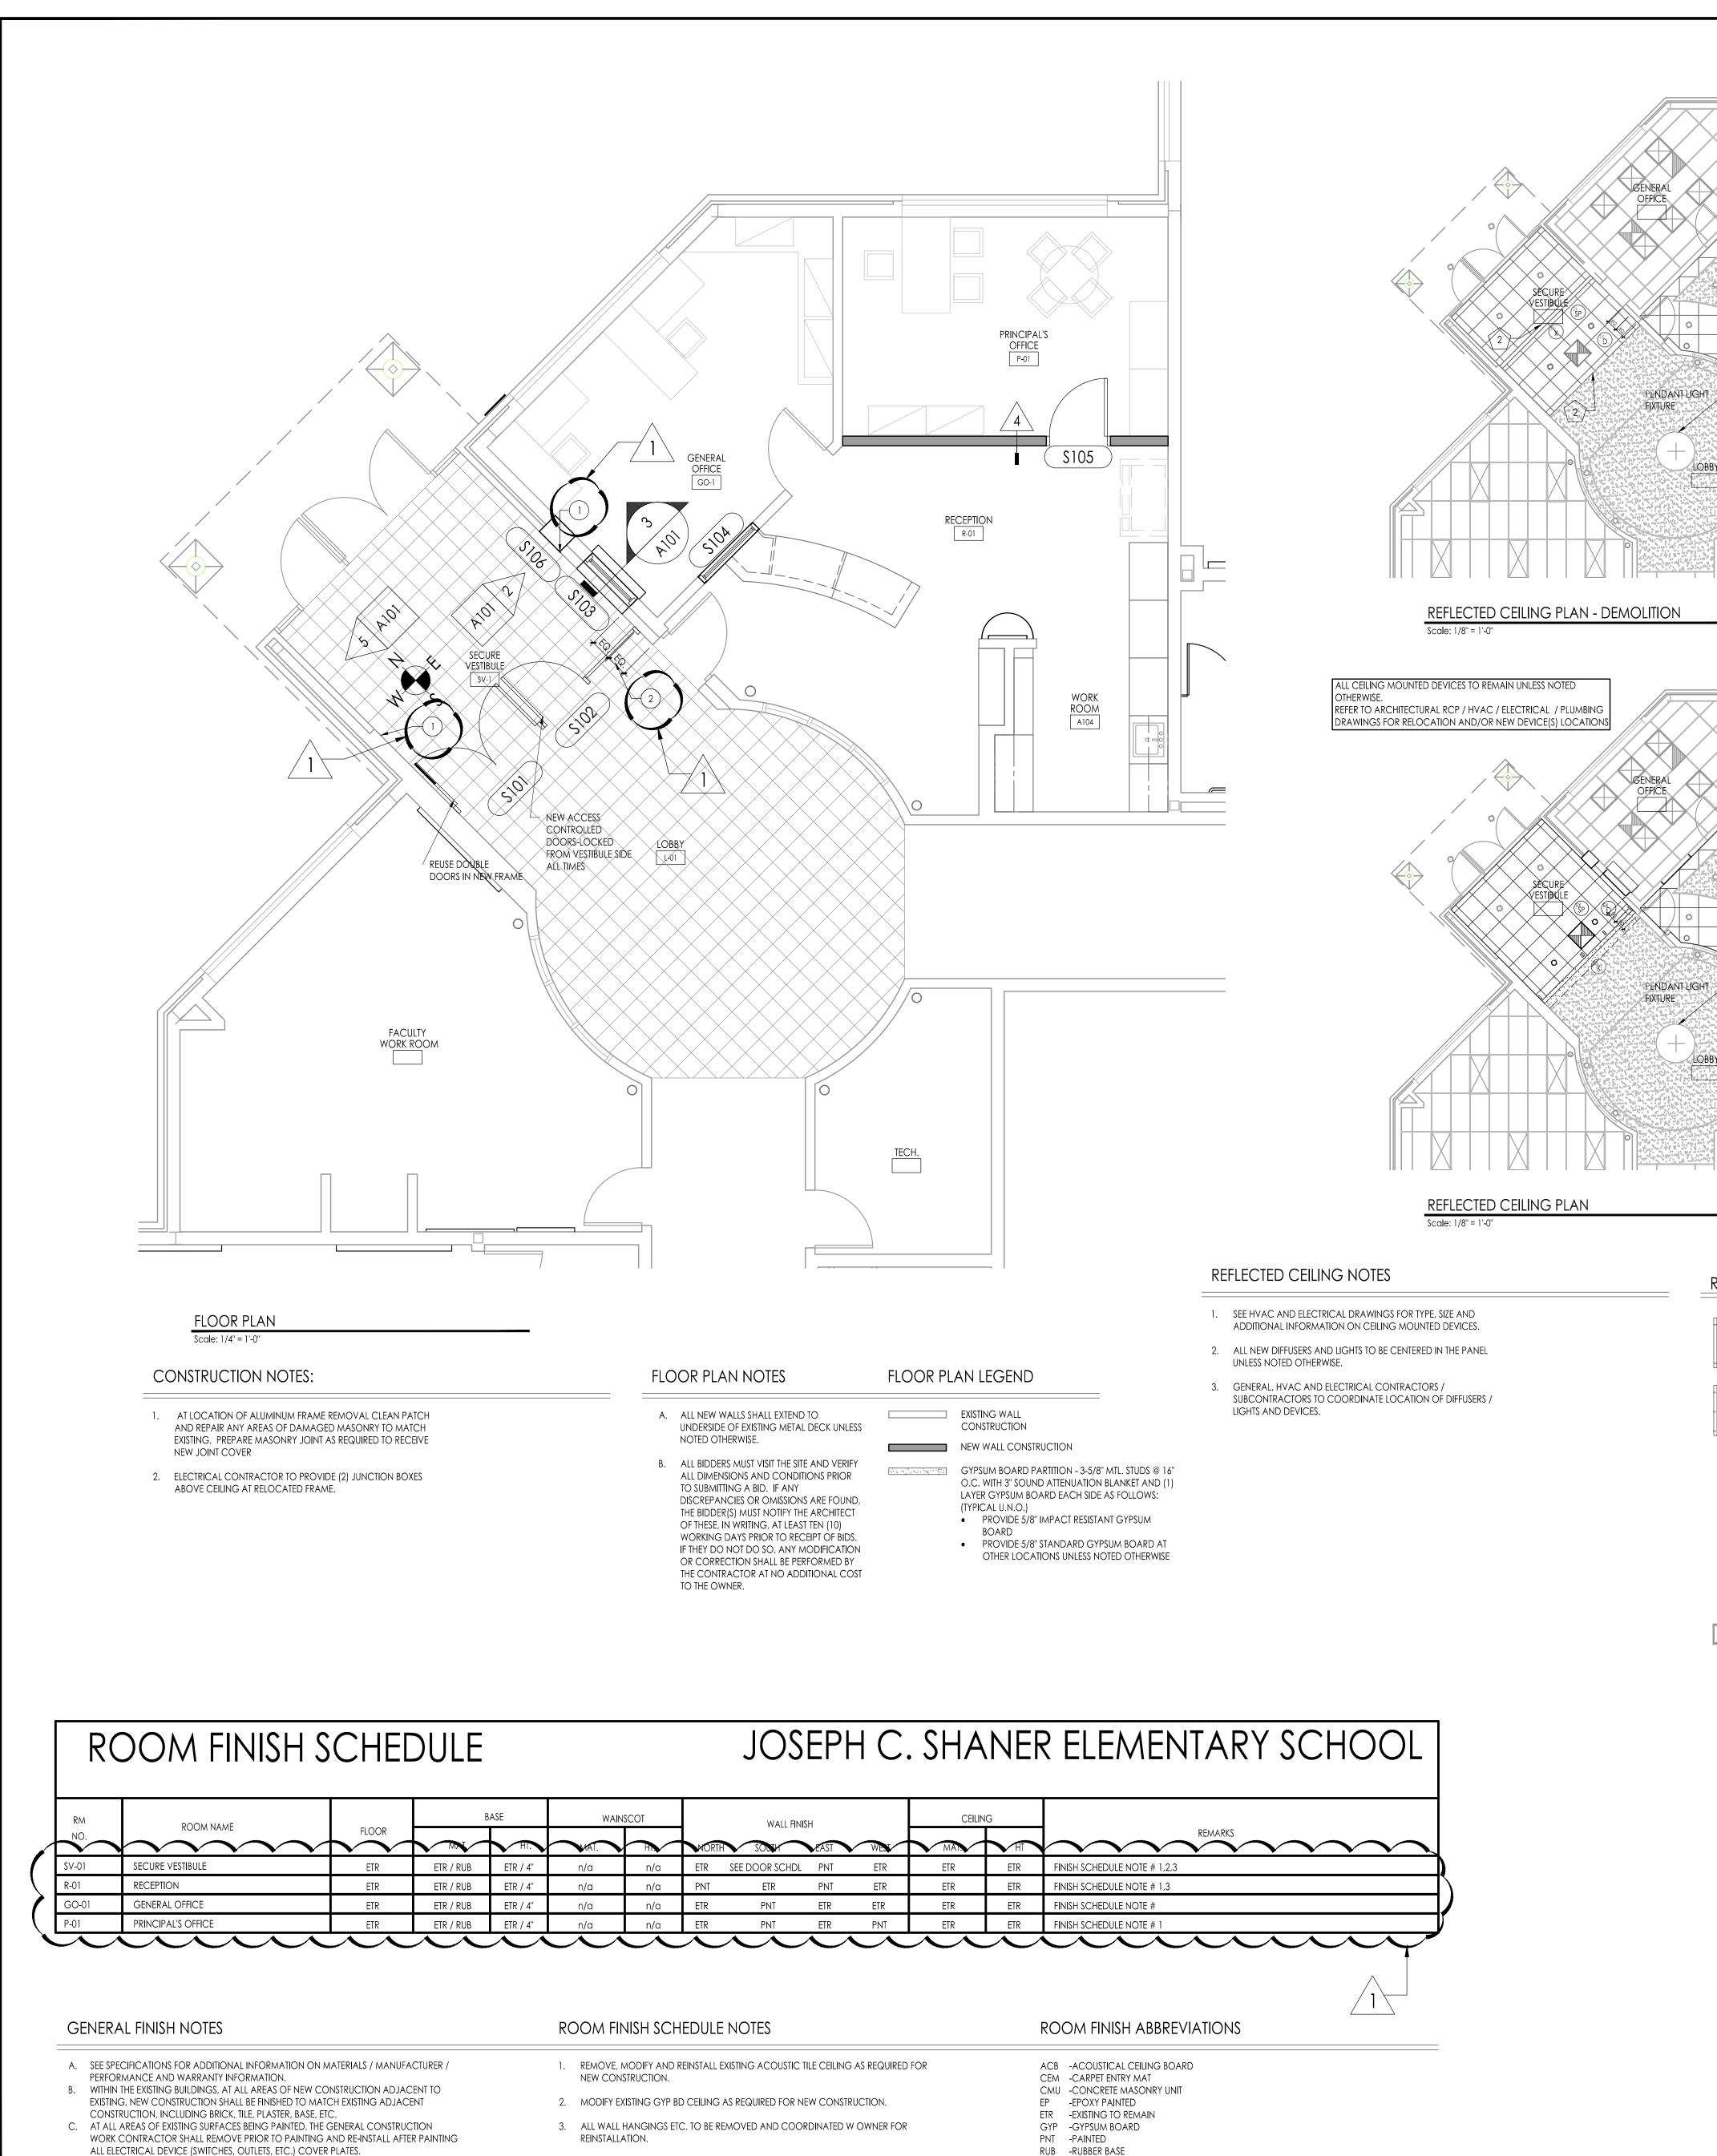
	PL	UMBING
-	P001	PLUMBING GENERAL NOTES, LEGEND, ABBREVIATIONS, SCHEDULES, & DETAILS
(P101	PARTIAL FLOOR PLAN: PLUMBING REMOVALS-BLOCK C & D1
	•	
	P201	PARTIAL FLOOR PLANS: PLUMBING NEW WORK-BLOCKS C&D1
-	ME	CHANICAL
	H001	HVAC GENERAL NOTES, LEGENDS, & ABBREVIATIONS
	H101 H102	PARTIAL BASEMENT & FIRST FLOOR PLANS: PLUMBING HVAC-BLOCKS A & C PARTIAL FIRST FLOOR PLANS: HVAC REMOVALS- BLOCKS D1 & D2
-		
-	H201	PARTIAL BASEMENT & FIRST FLOOR PLANS: HVAC NEW WORK- BLOCKS A&C- DUCTWORK
-	H202	PARTIAL FIRST FLOOR PLANS: PLUMBING NEW WORK- BLOCKS D1 & D2- DUCTWORK
	H211	PARTIAL BASEMENT & FIRST FLOOR PLANS: HVAC NEW WORK- BLOCKS A,C&E- PIPING
K	H212	PARTIAL FIRST FLOOR PLANS: PLUMBING NEW WORK- BLOCKS D1 & D2- PIPING
l l		
1	H501	HVAC DETAILS
-	H601	HVAC SCHEDULES
	ELI	ECTRICAL
/	E001	ELECTRICAL GENERAL NOTES, LEGENDS & ABBREVIATIONS
	E002	ELECTRICAL SINGLE LINE DIAGRAM
_	E003 E004	ELECTRICAL LOCATION PLAN AT GRADE ELECTRICAL PARTIAL ROOF LOCATION PLAN
	E101	PARTIAL BASEMENT & FIRST FLOOR PLANS: ELECTRICAL REMOVALS- BLOCKS A,B,C, &
	E102	PARTIAL FIRST FLOOR PLAN: ELECTRICAL REMOVALS- BLOCKS D1 & D2
	E201	PARTIAL BASEMENT & FIRST FLOOR PLANS: ELECTRICAL NEW WORK- BLOCKS A,B,C, & E- POWER & SYSTEMS
	E202	PARTIAL FIRST FLOOR PLANS: ELECTRICAL NEW WORK-BLOCKS D1 & D2 POWER SYSTEMS
	E500	ELECTRICAL DETAILS
	E600	ELECTRICAL PANEL SCHEDULES





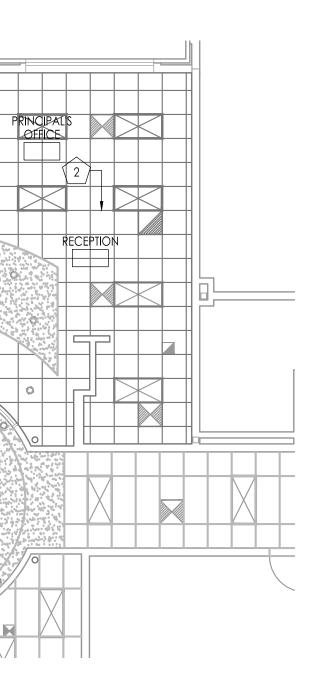


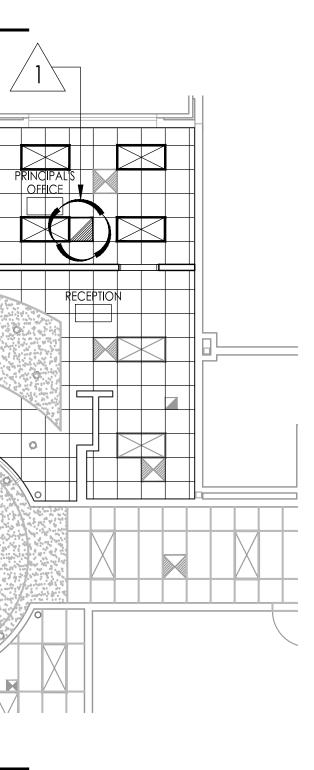




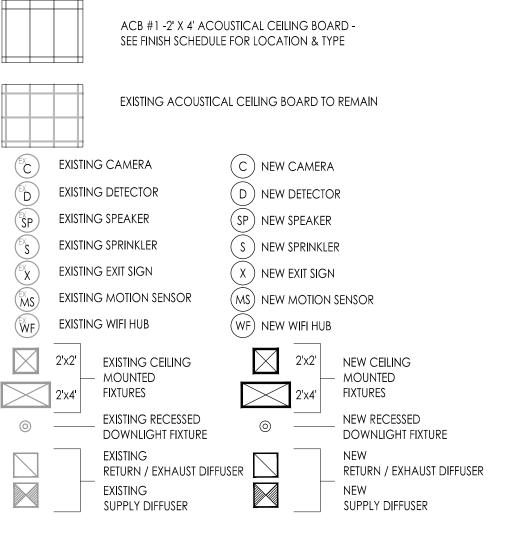
- D. MATERIALS LISTED ON THE FINISH SCHEDULE REFER TO THE MAJORITY OF WALLS, FLOOR AND CEILING OF ROOMS SCHEDULED, REFER TO PLANS, DETAILS, INTERIOR ELEVATIONS, SECTIONS, CEILING PLANS, AND NOTES FOR THOSE MATERIALS NOT INDICATED ON THE SCHEDULE BUT ARE STILL REQUIRED IN THE ROOM.

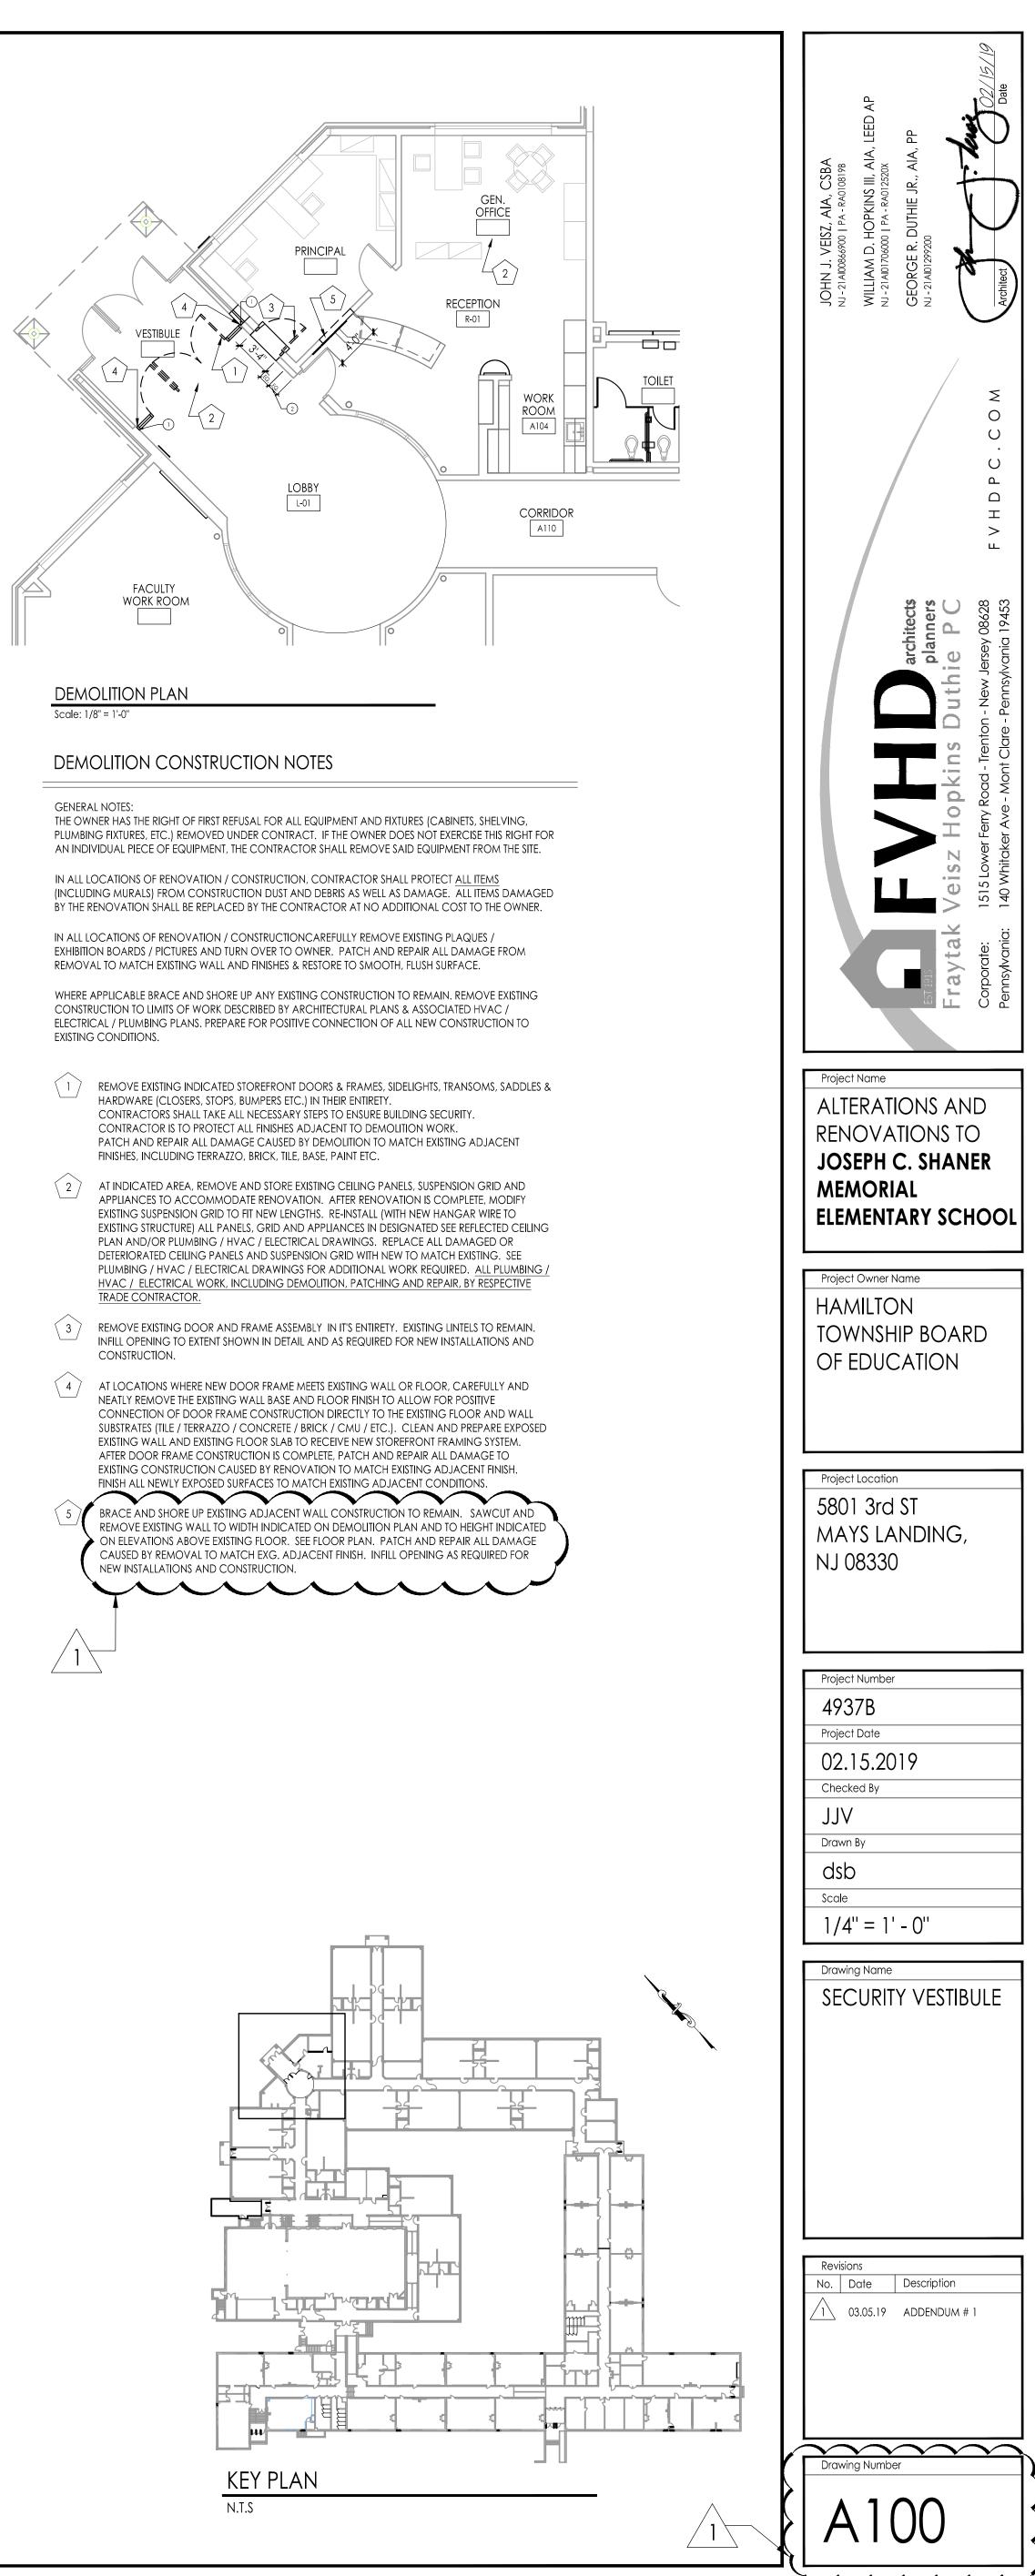
- SFT -SOFFIT VCT -VINYL COMPOSITION TILE
- n/a -NOT APPLICABLE

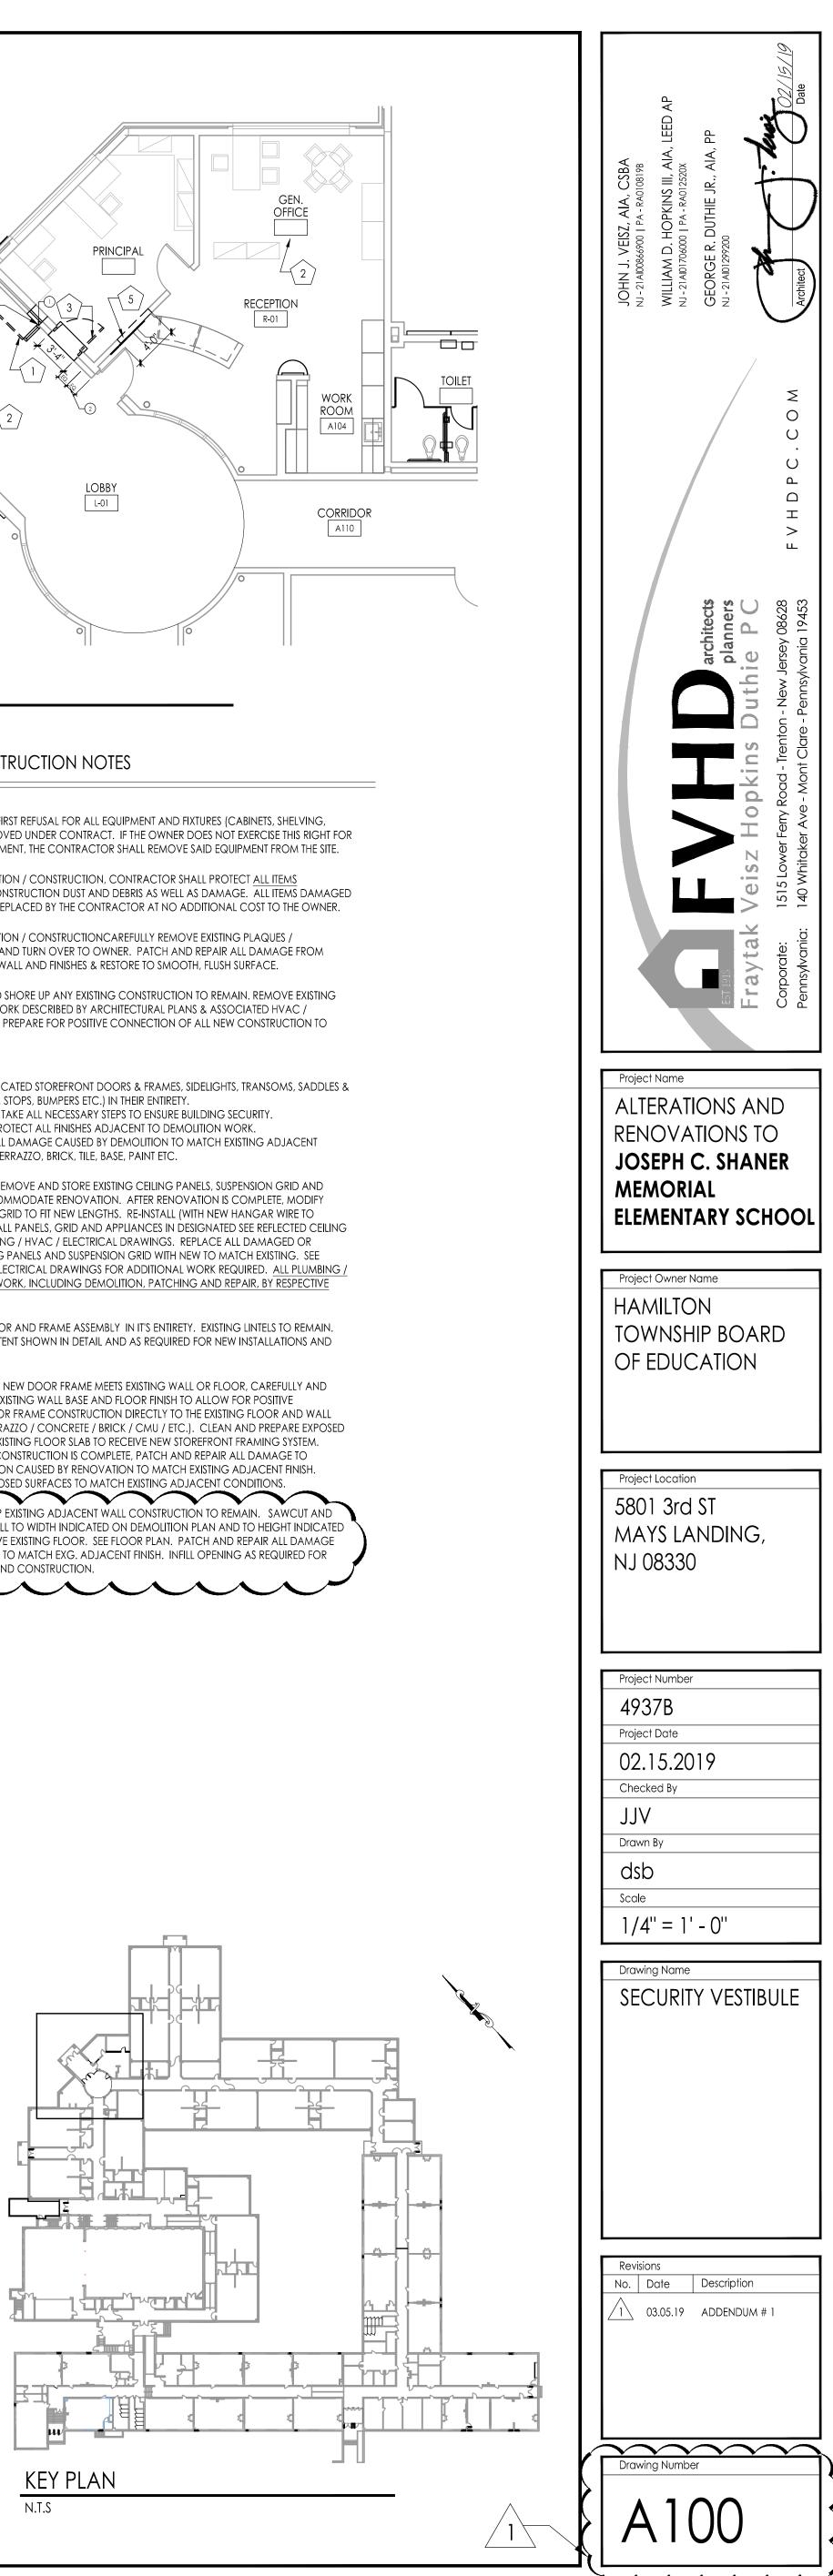


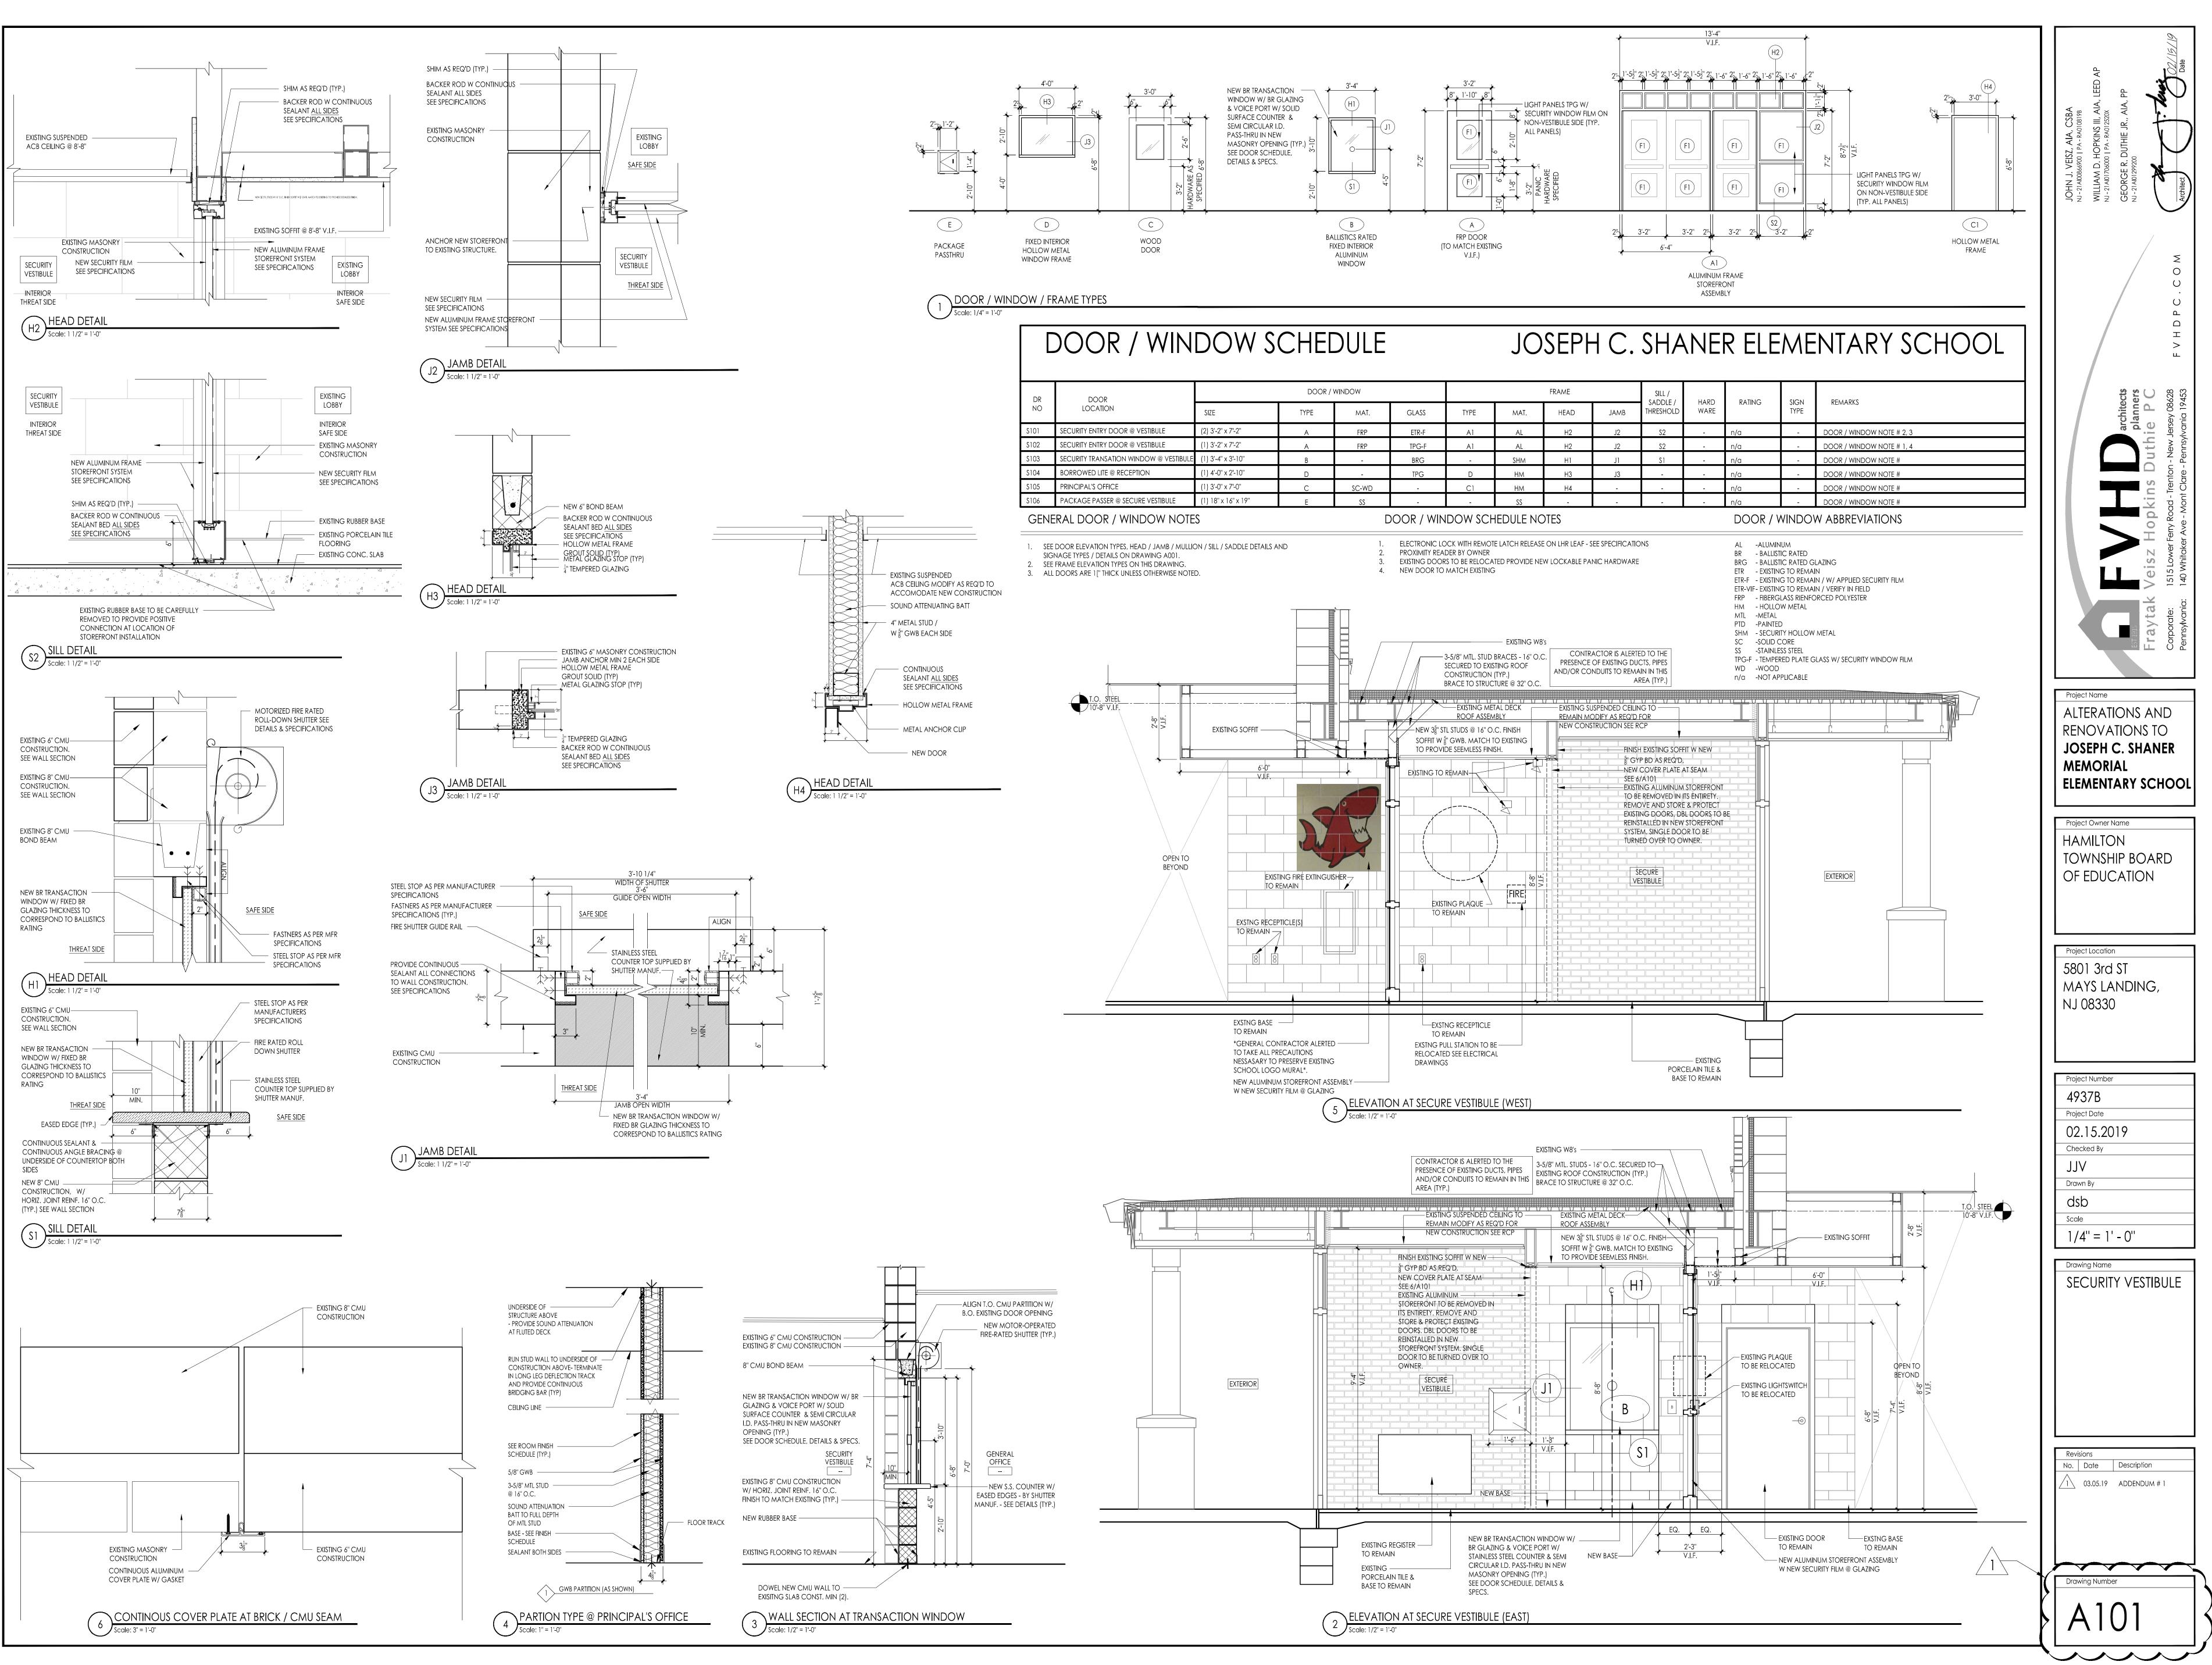


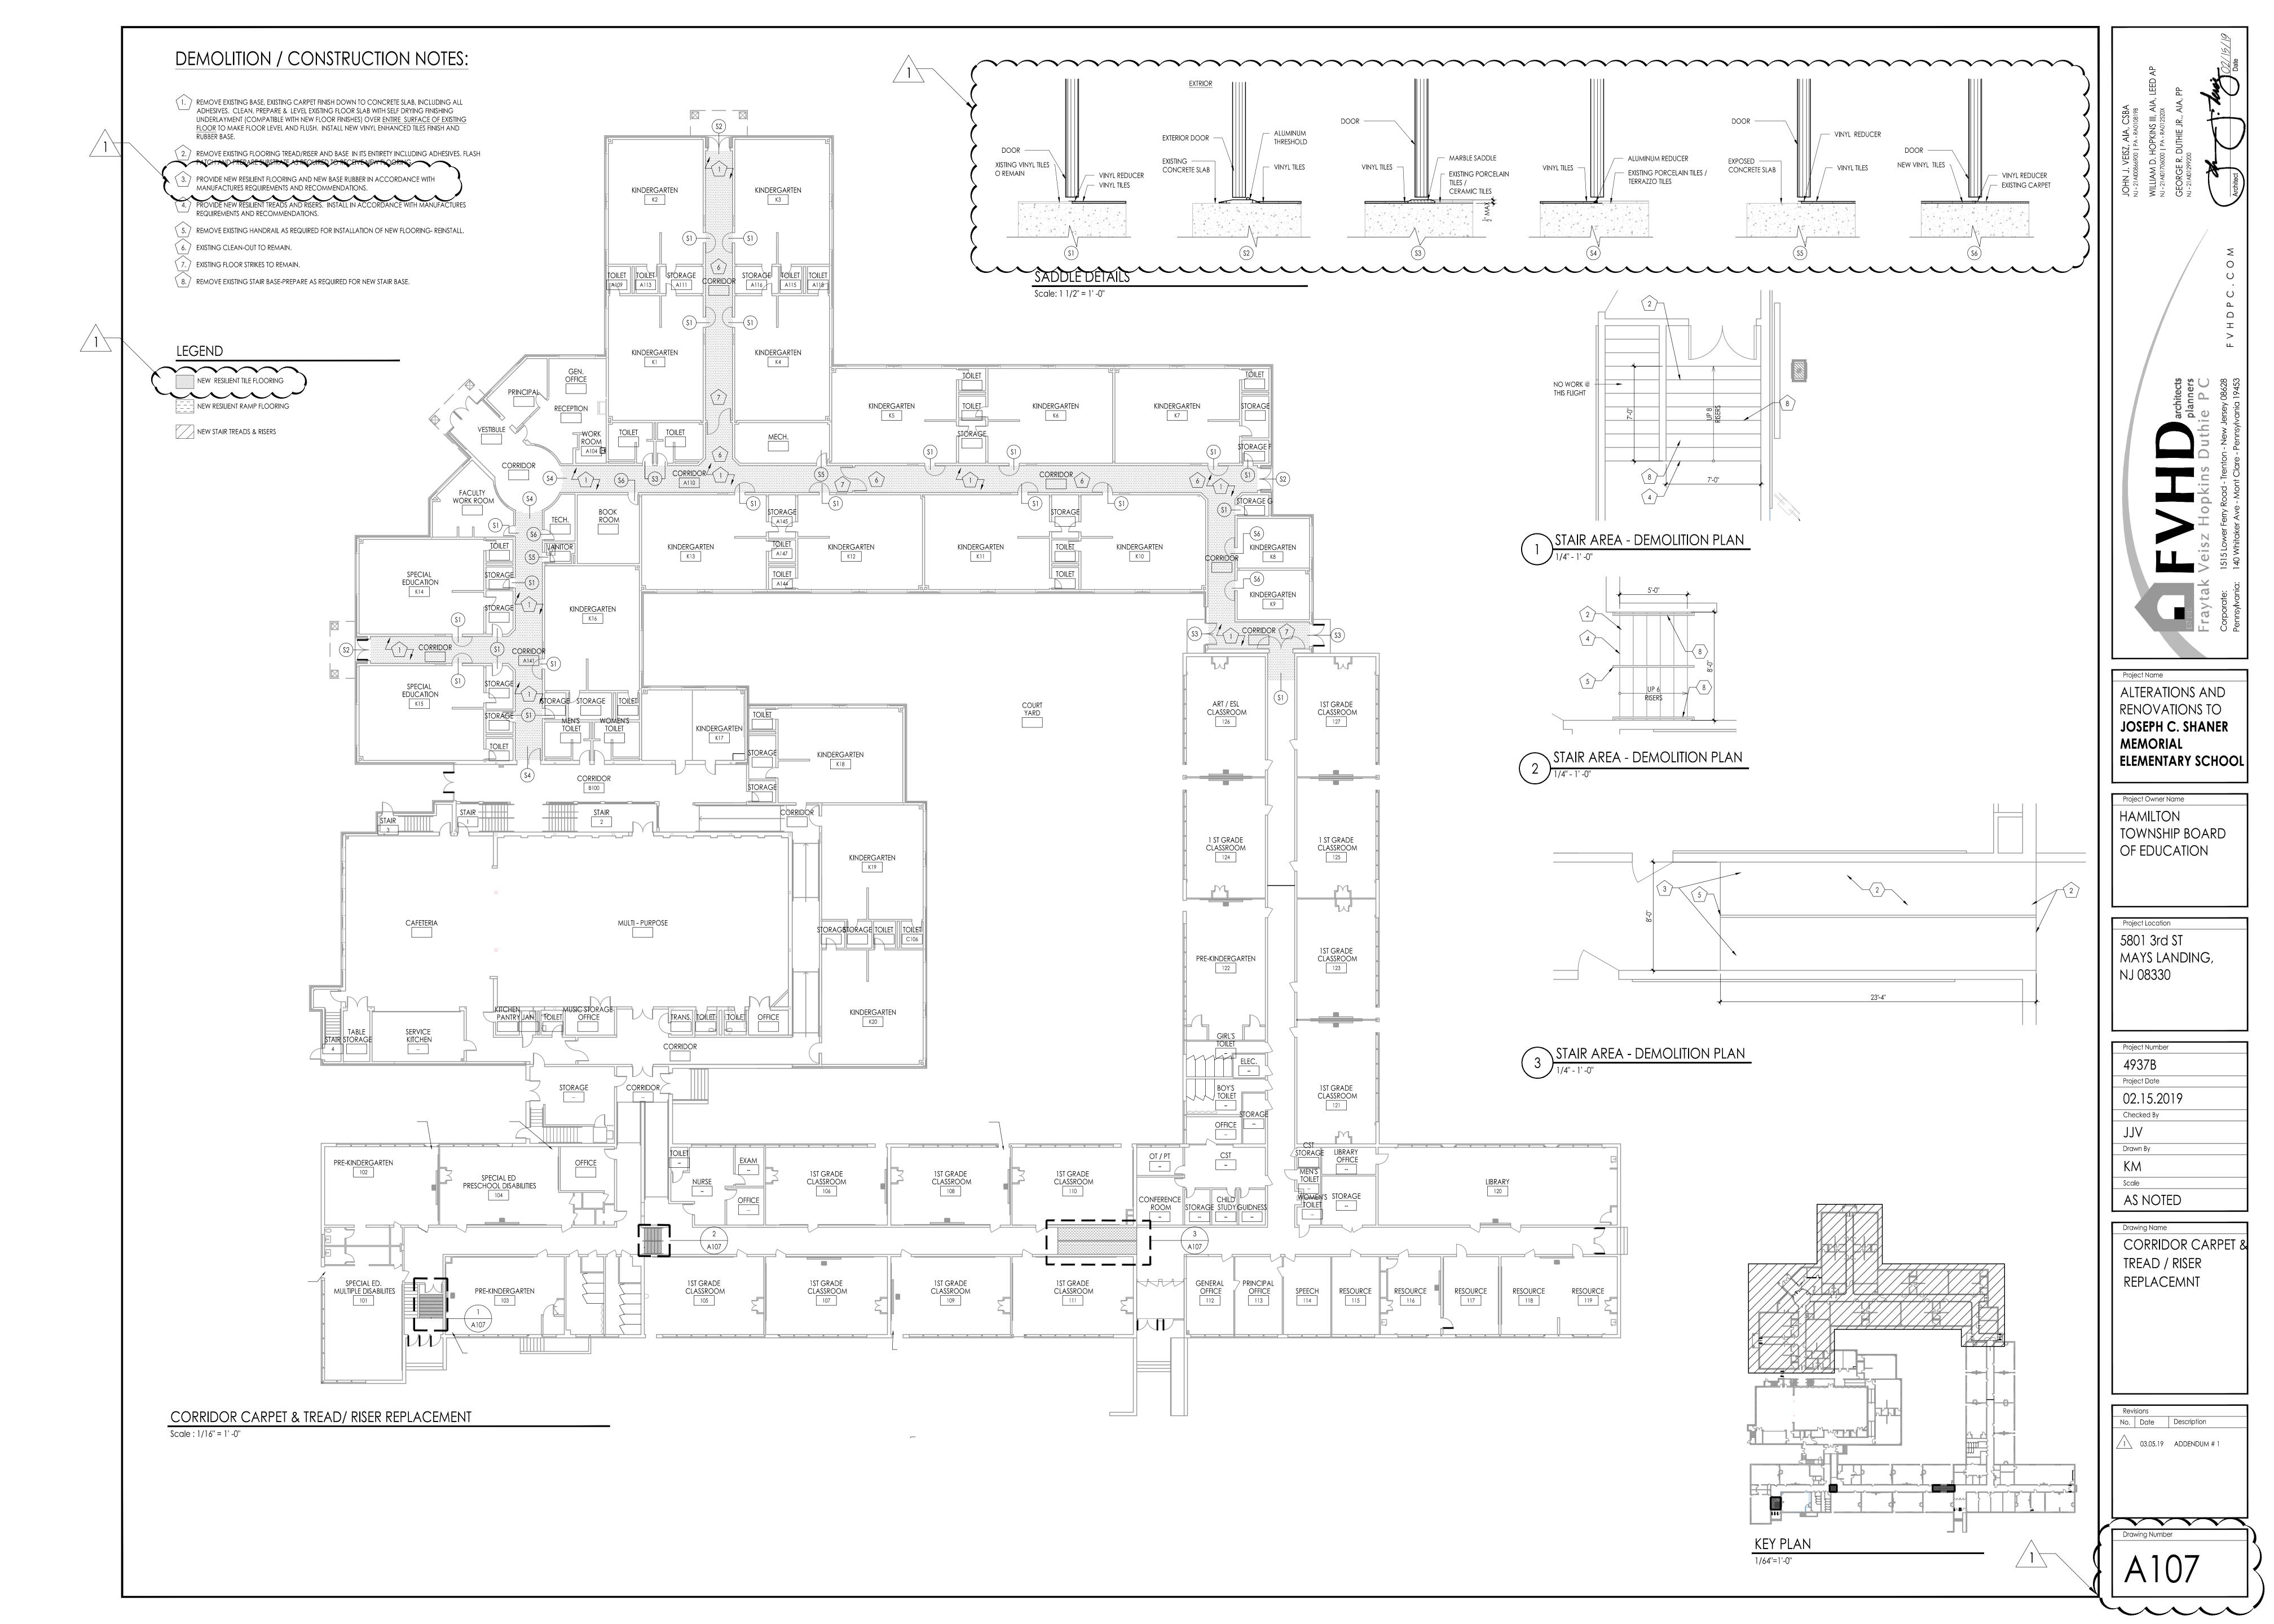
REFLECTED CEILING PLAN LEGEND

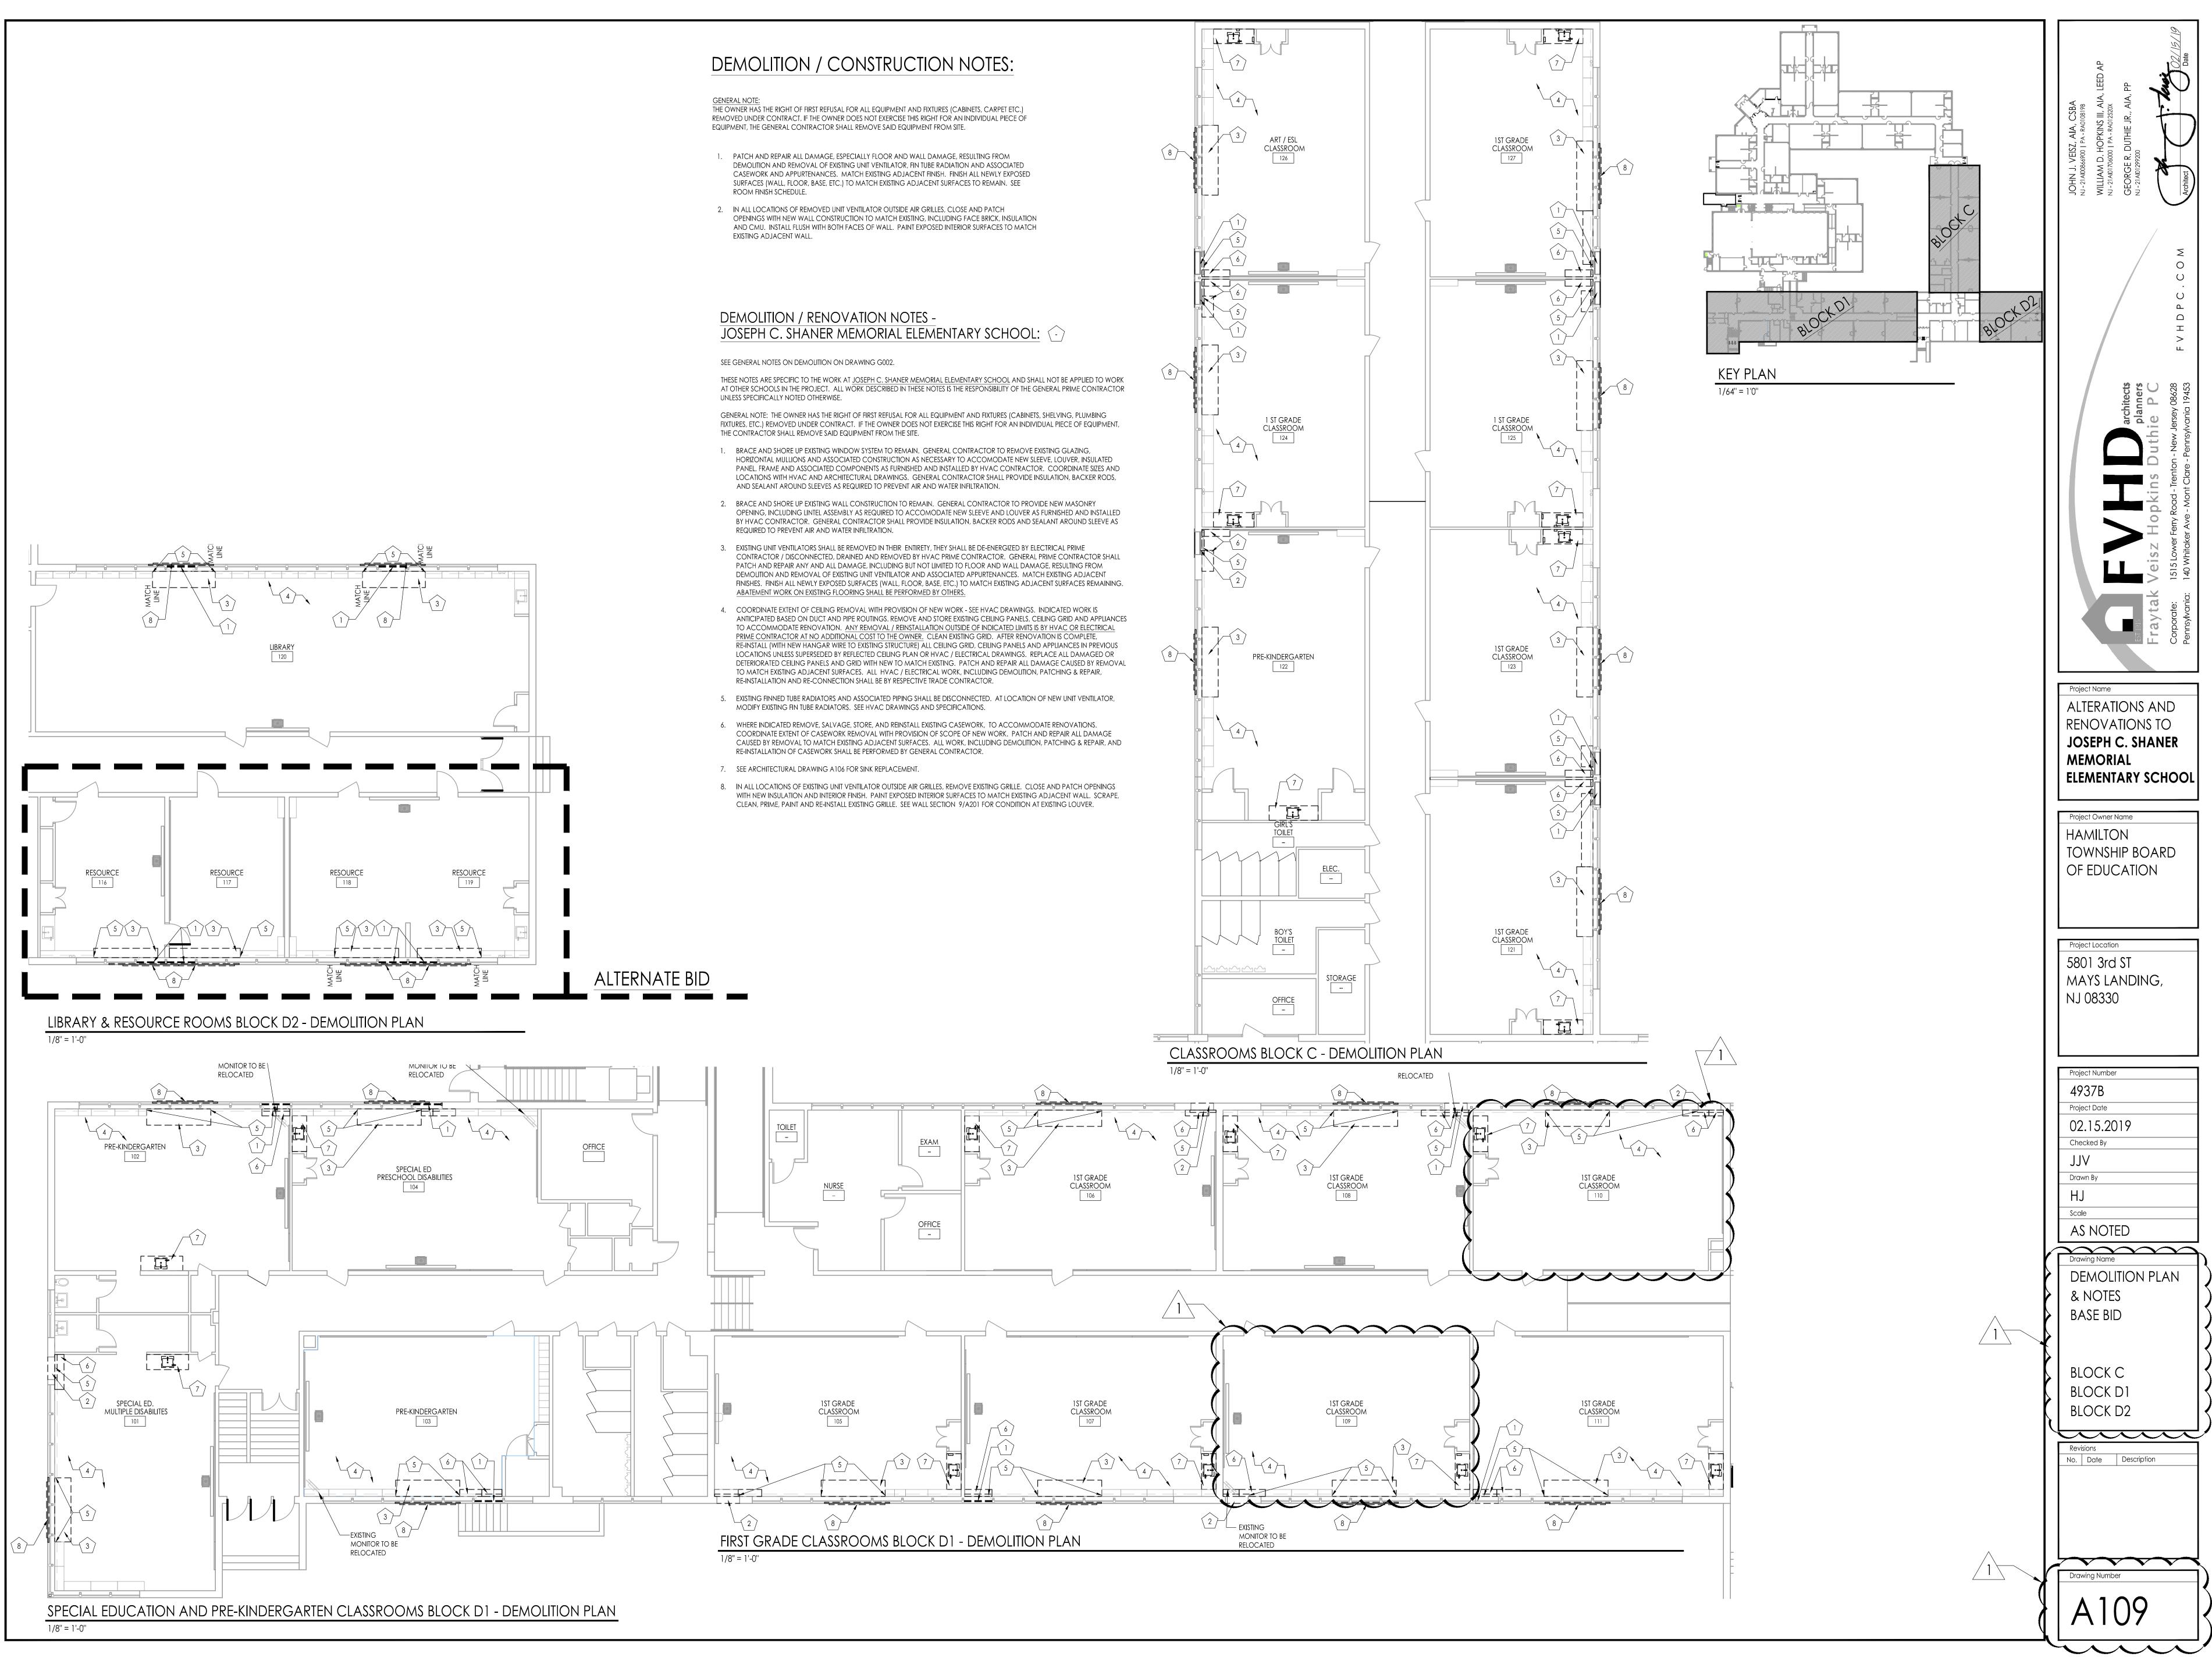


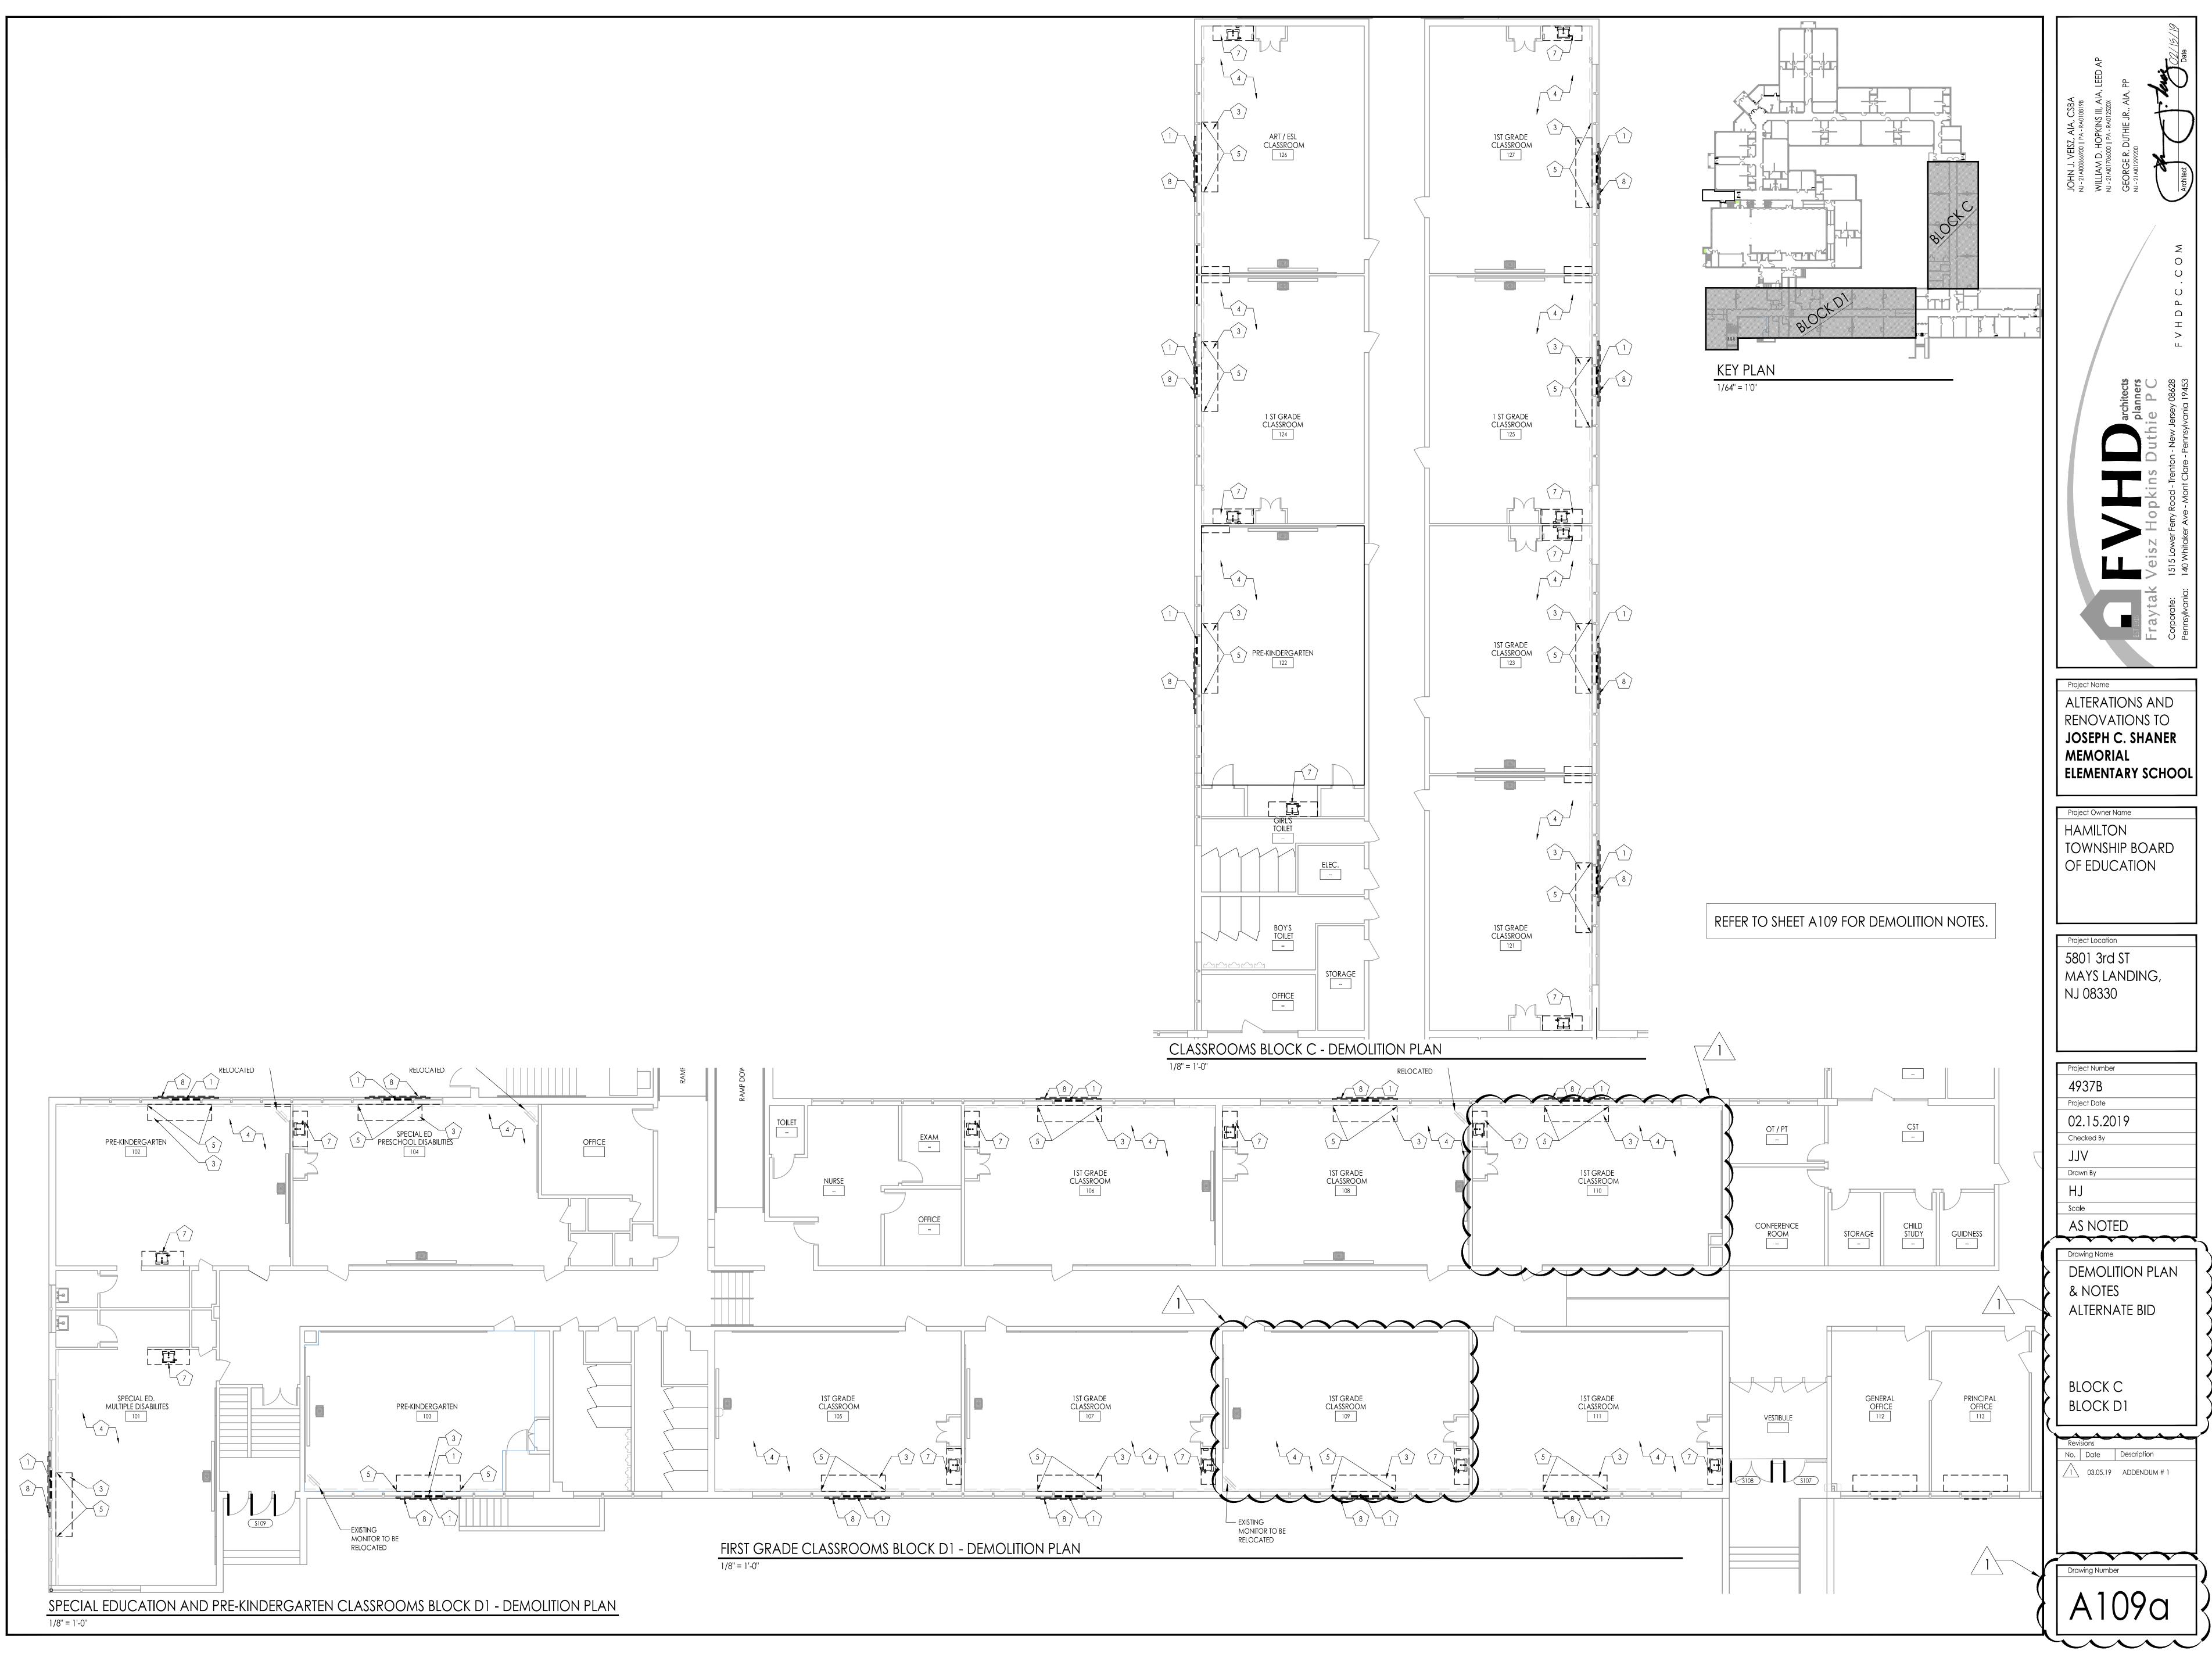


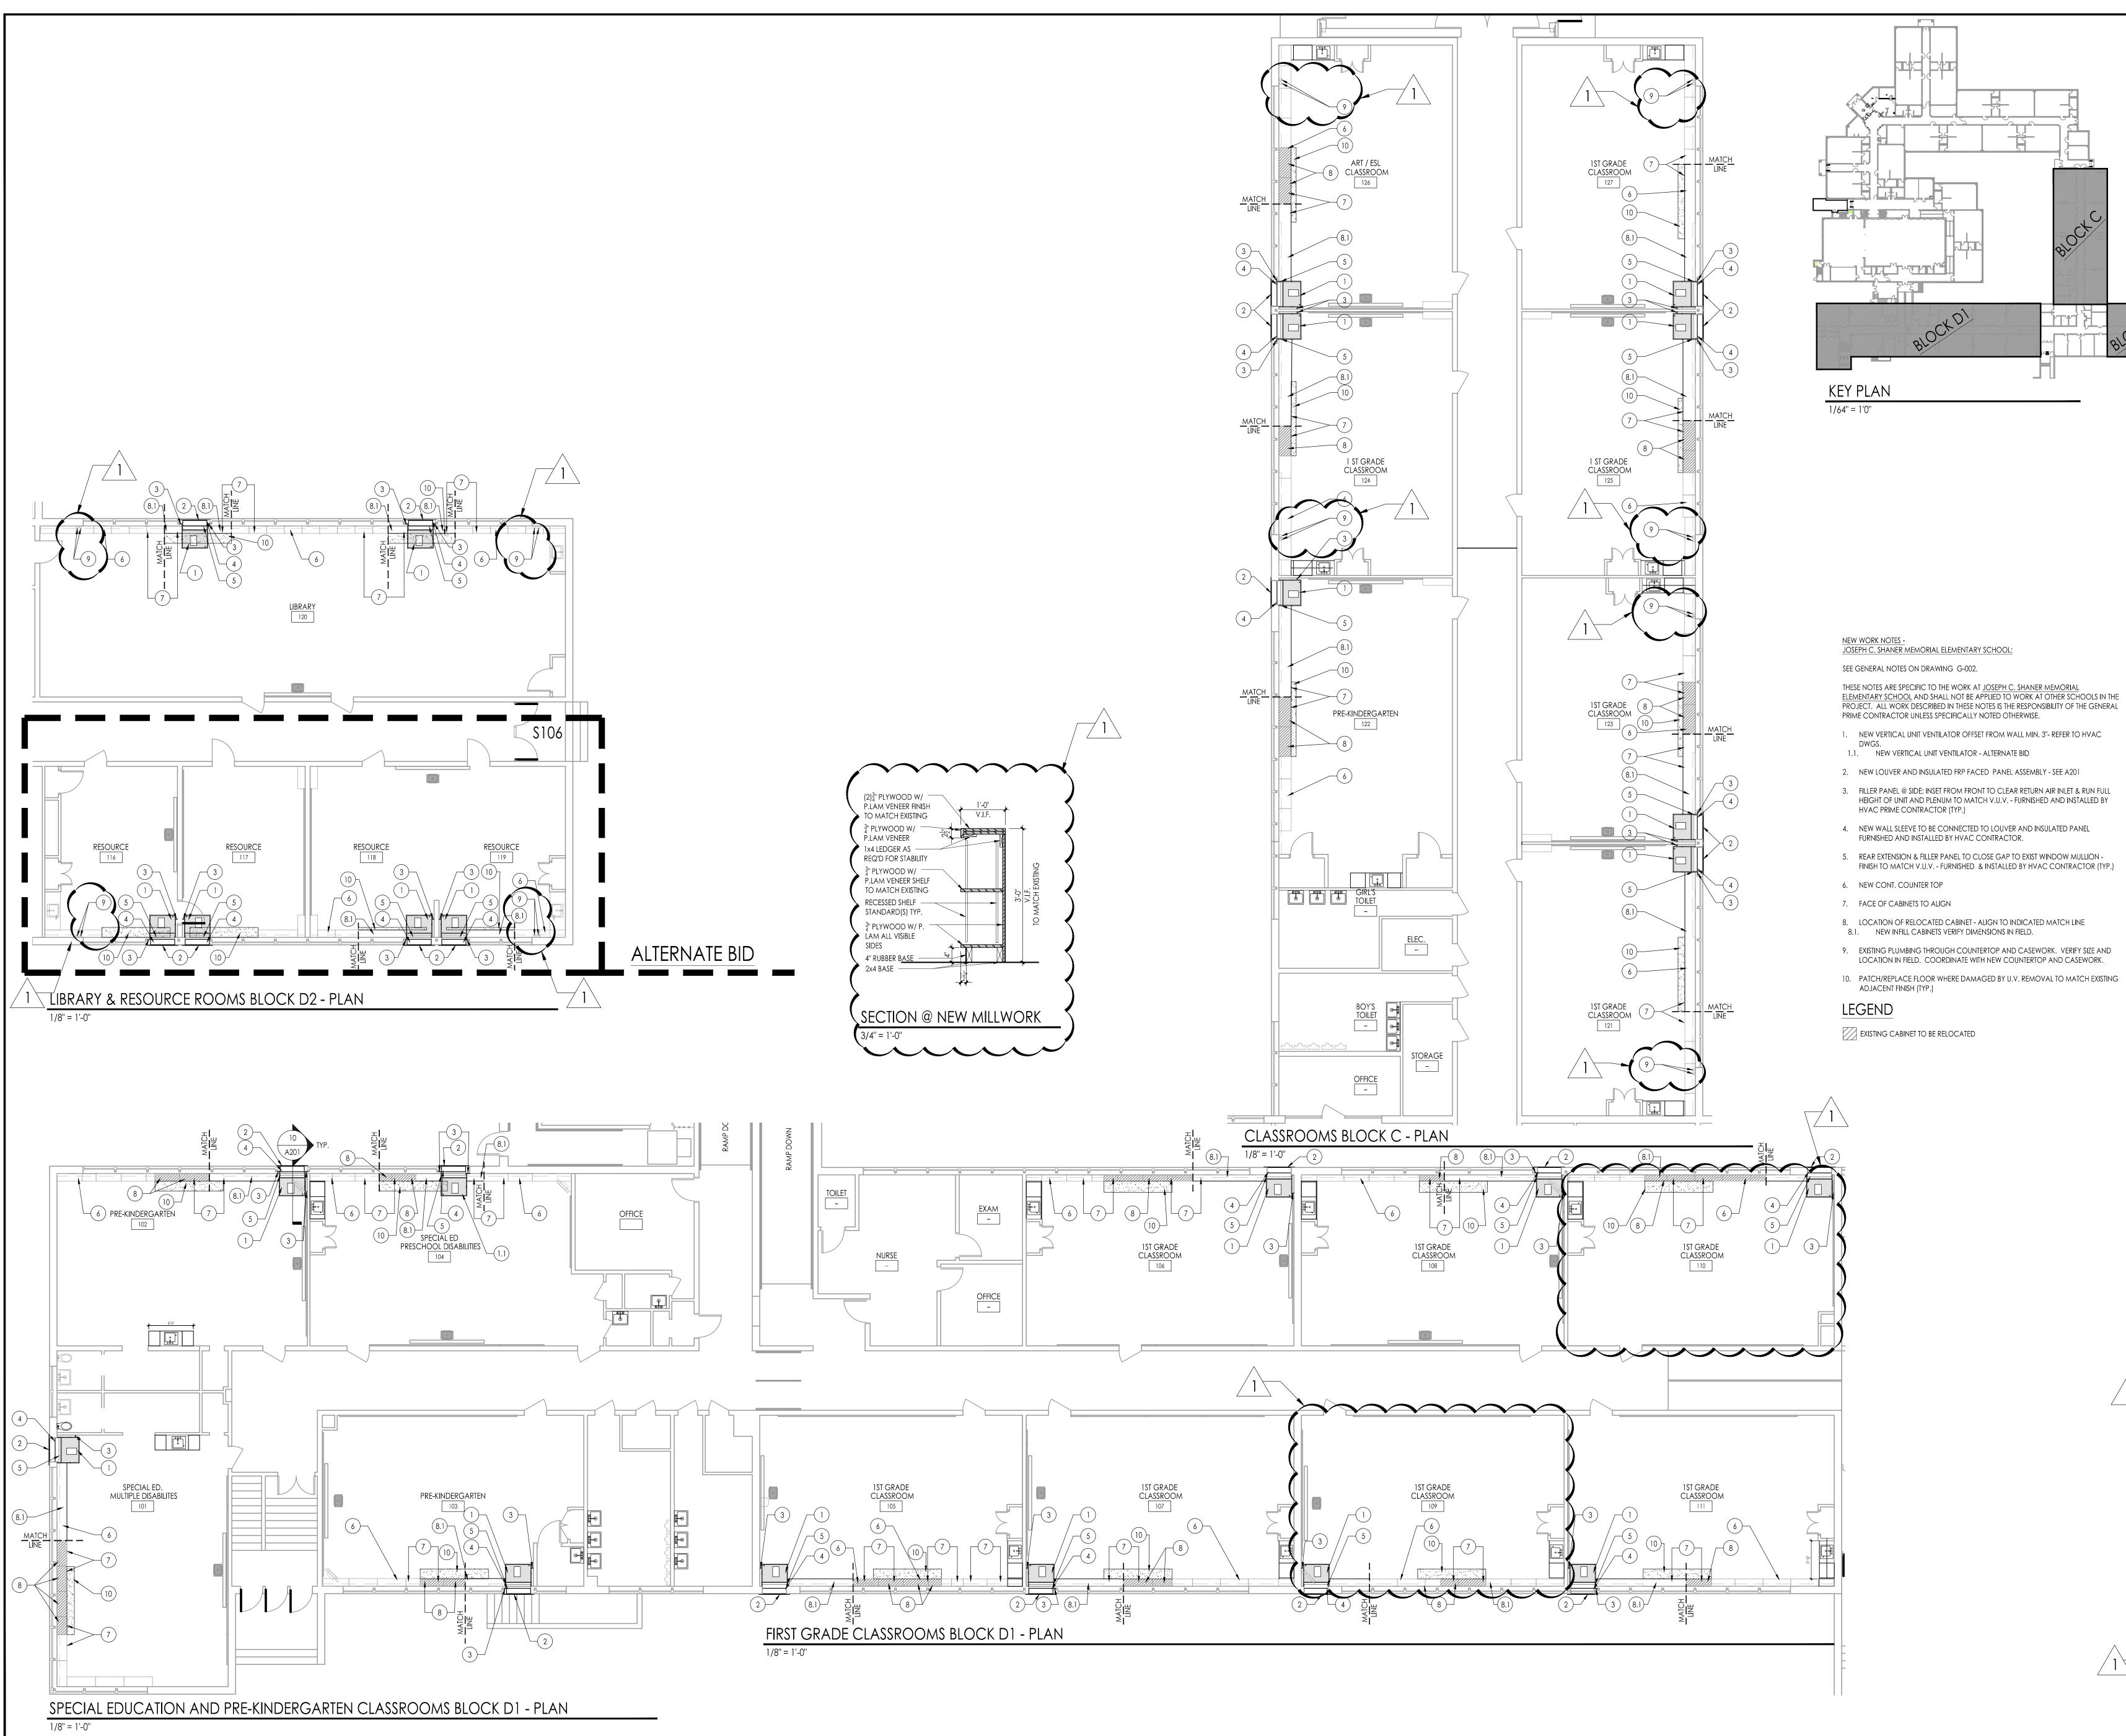




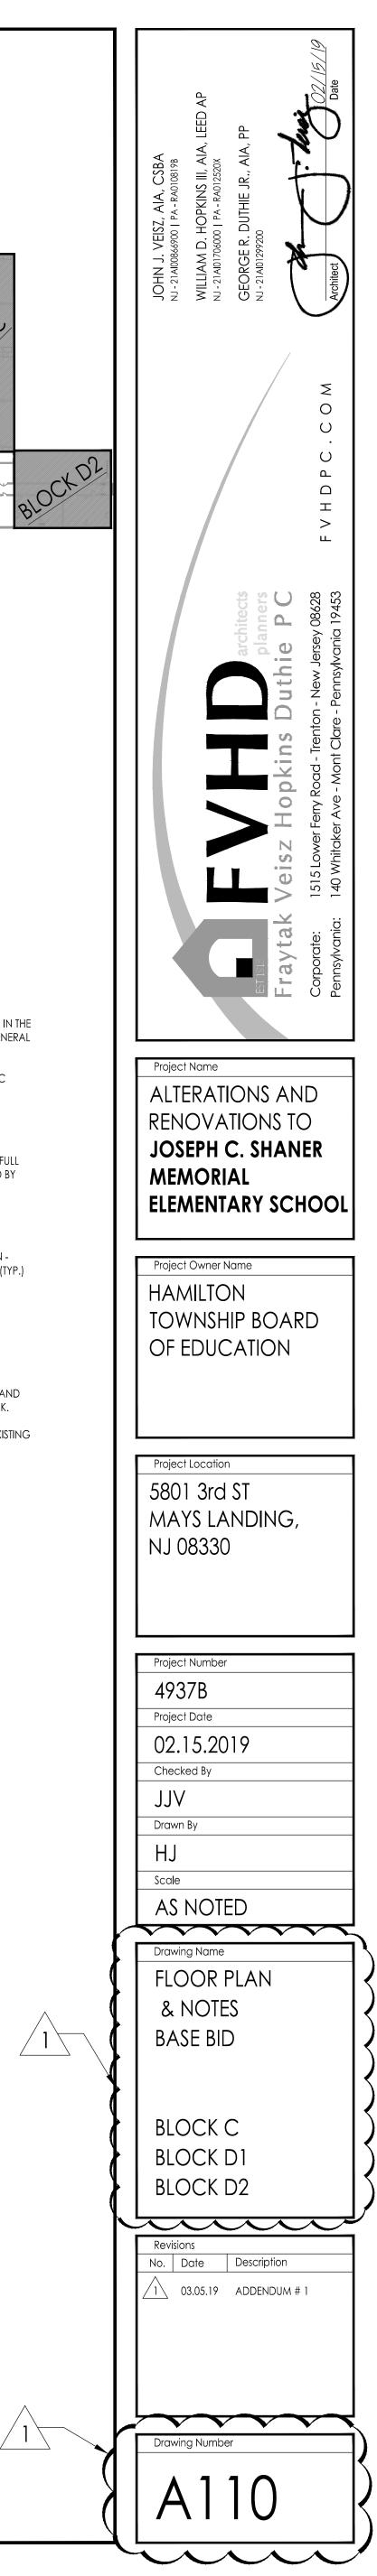


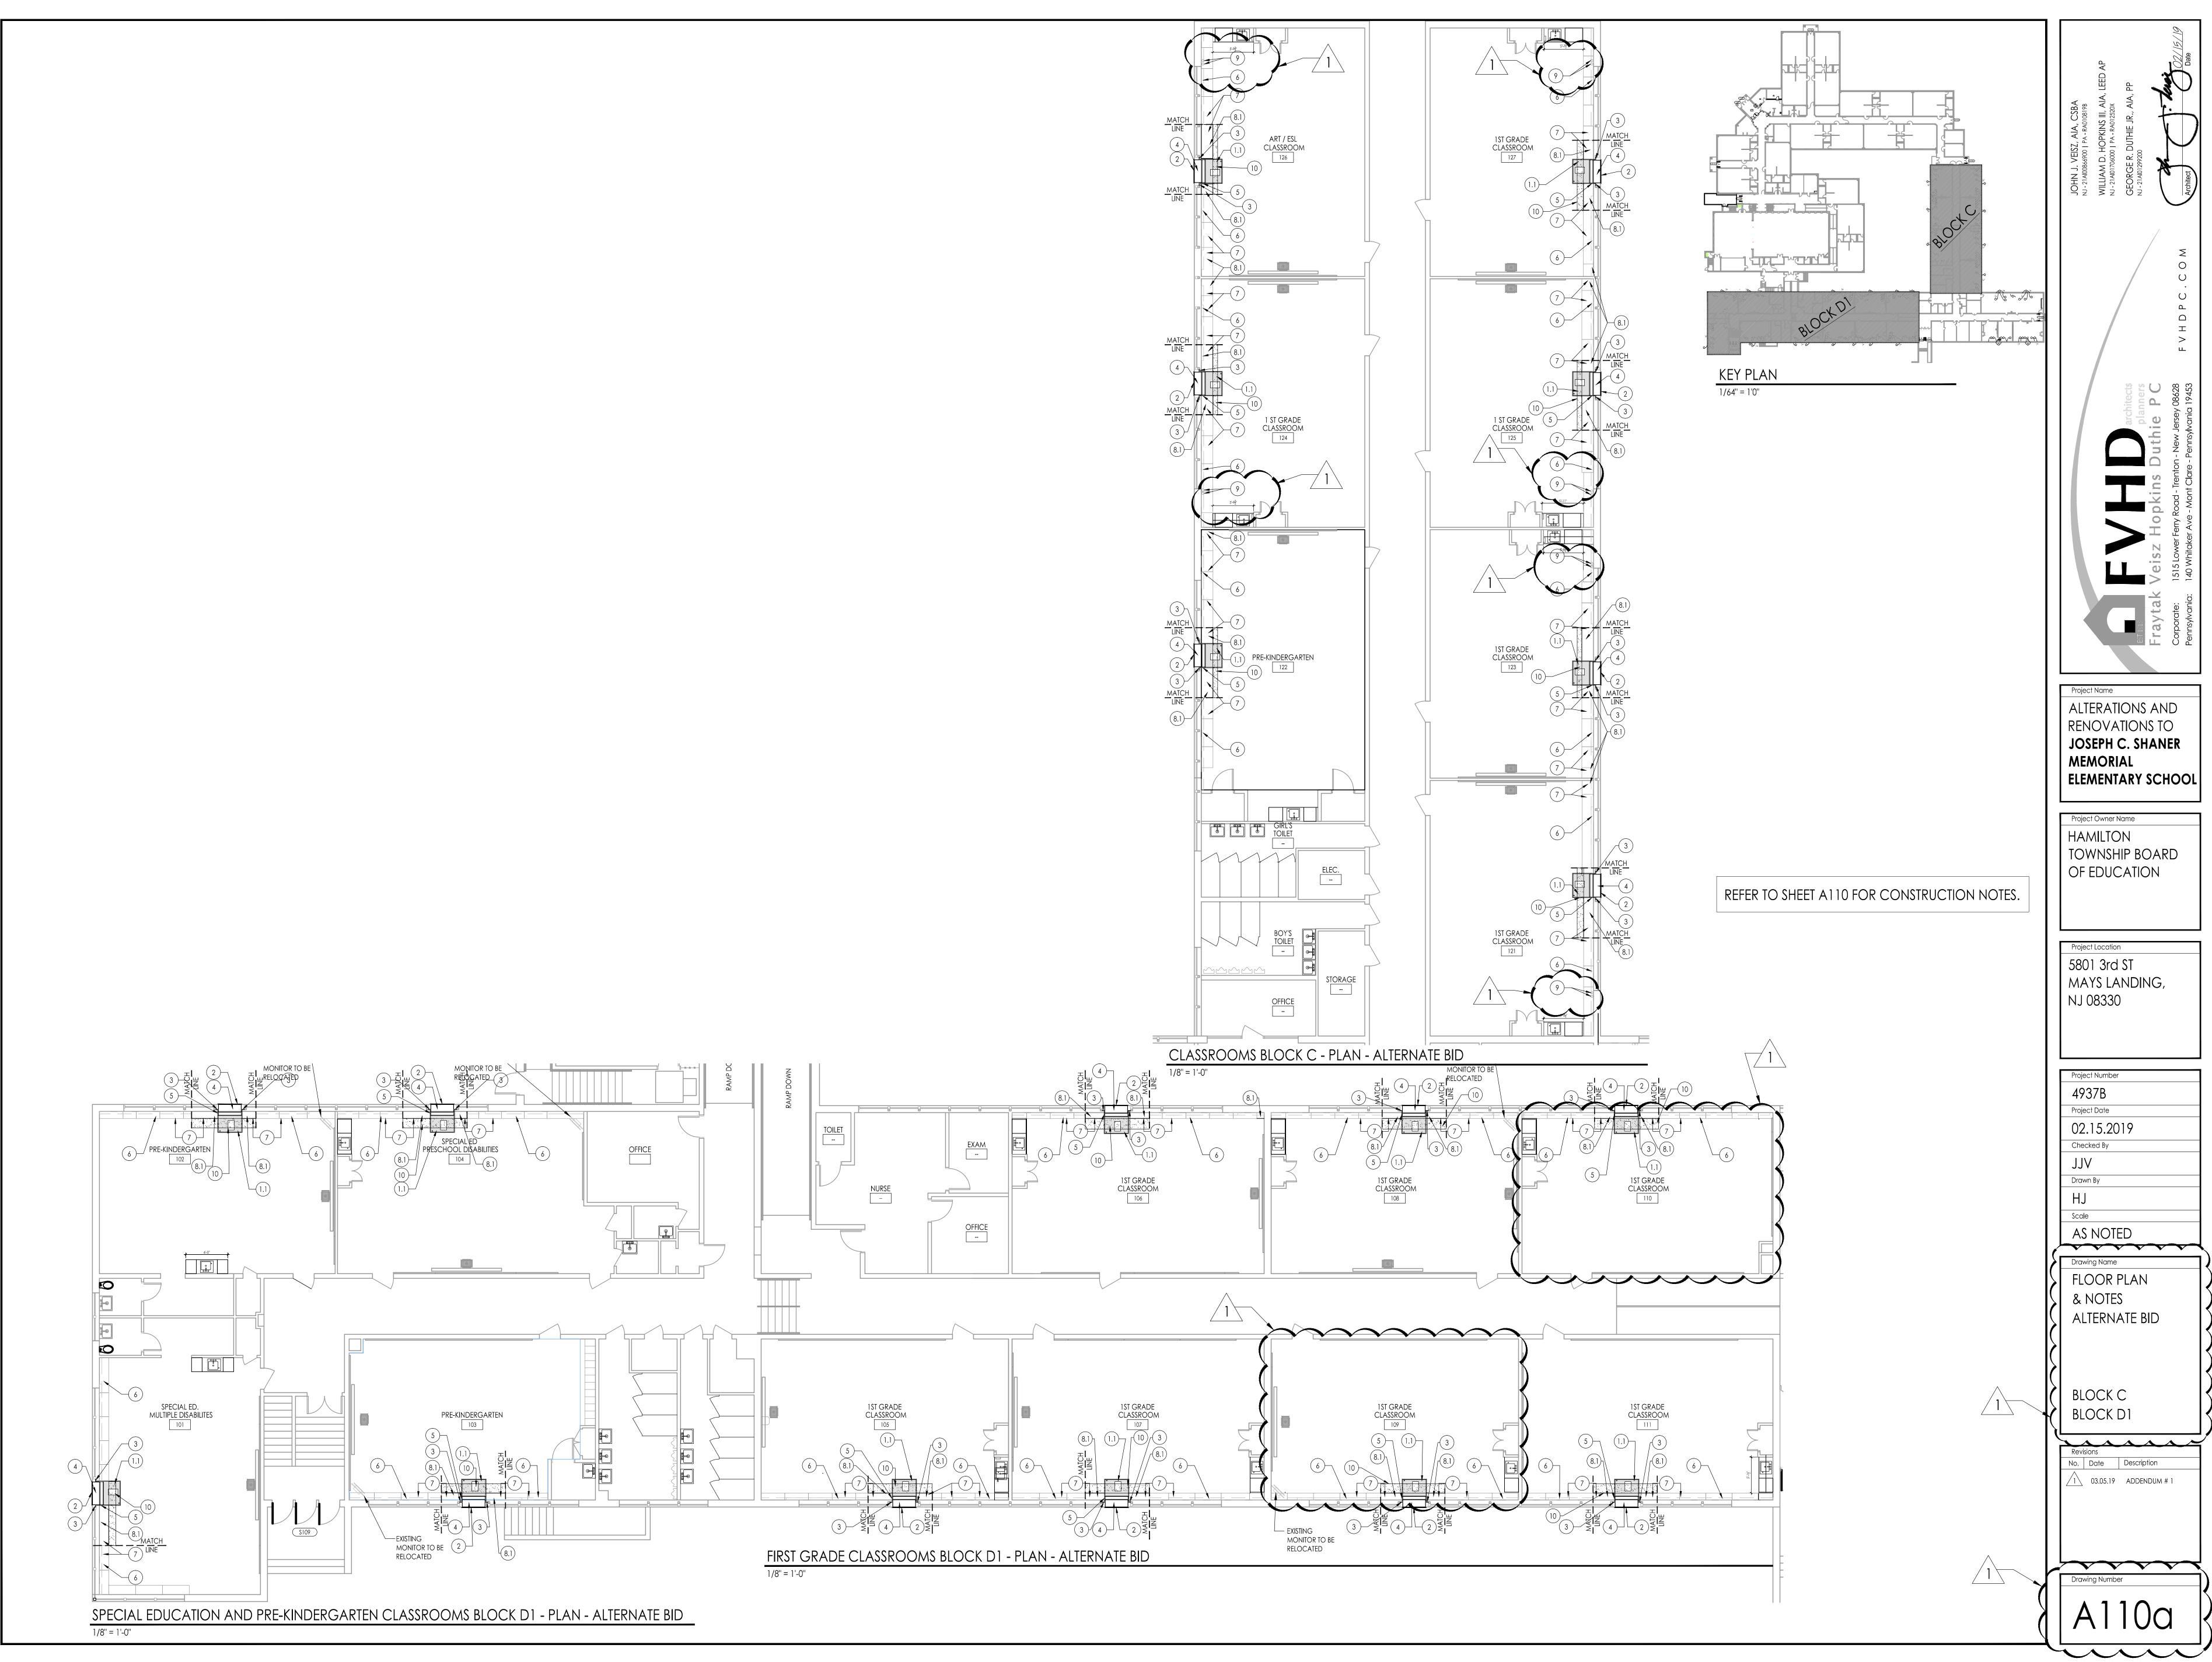


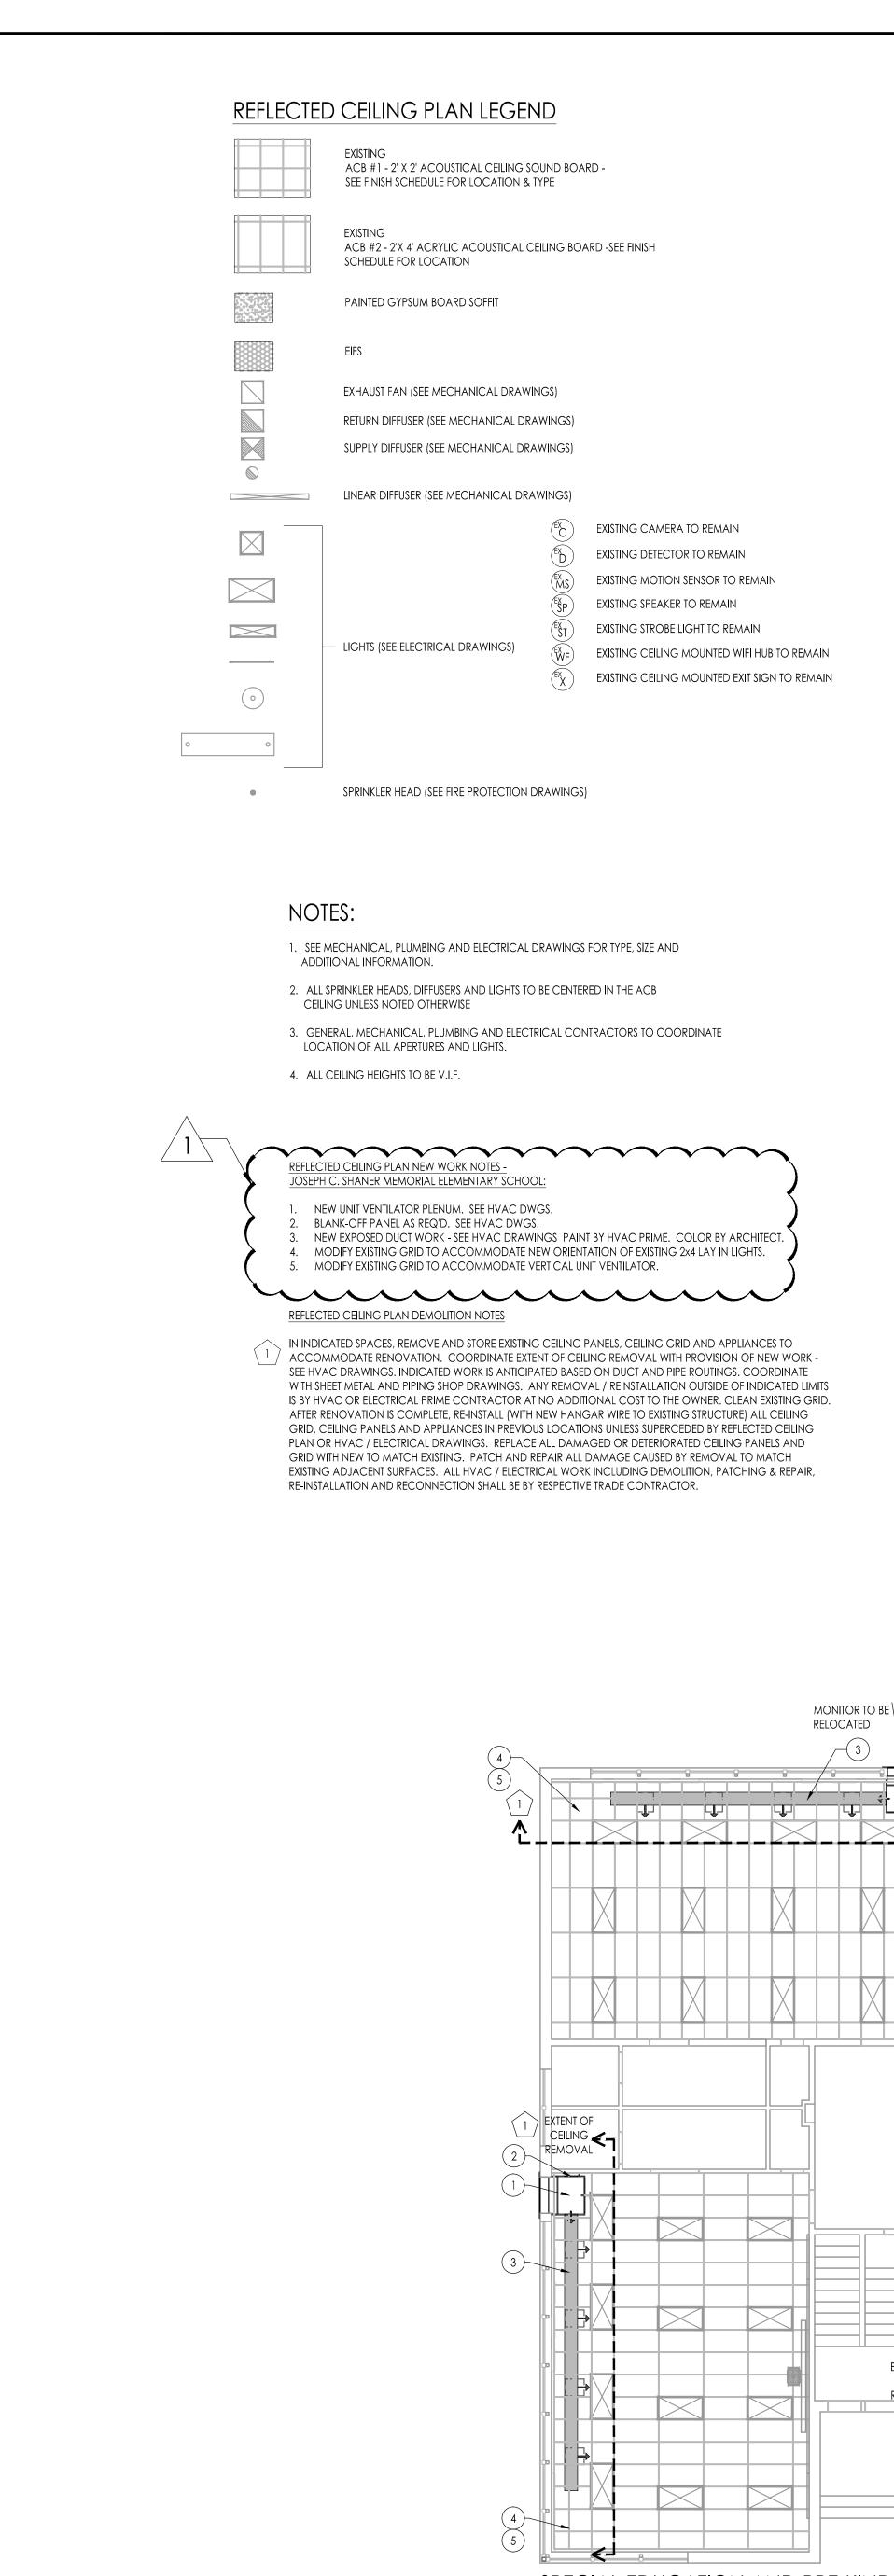




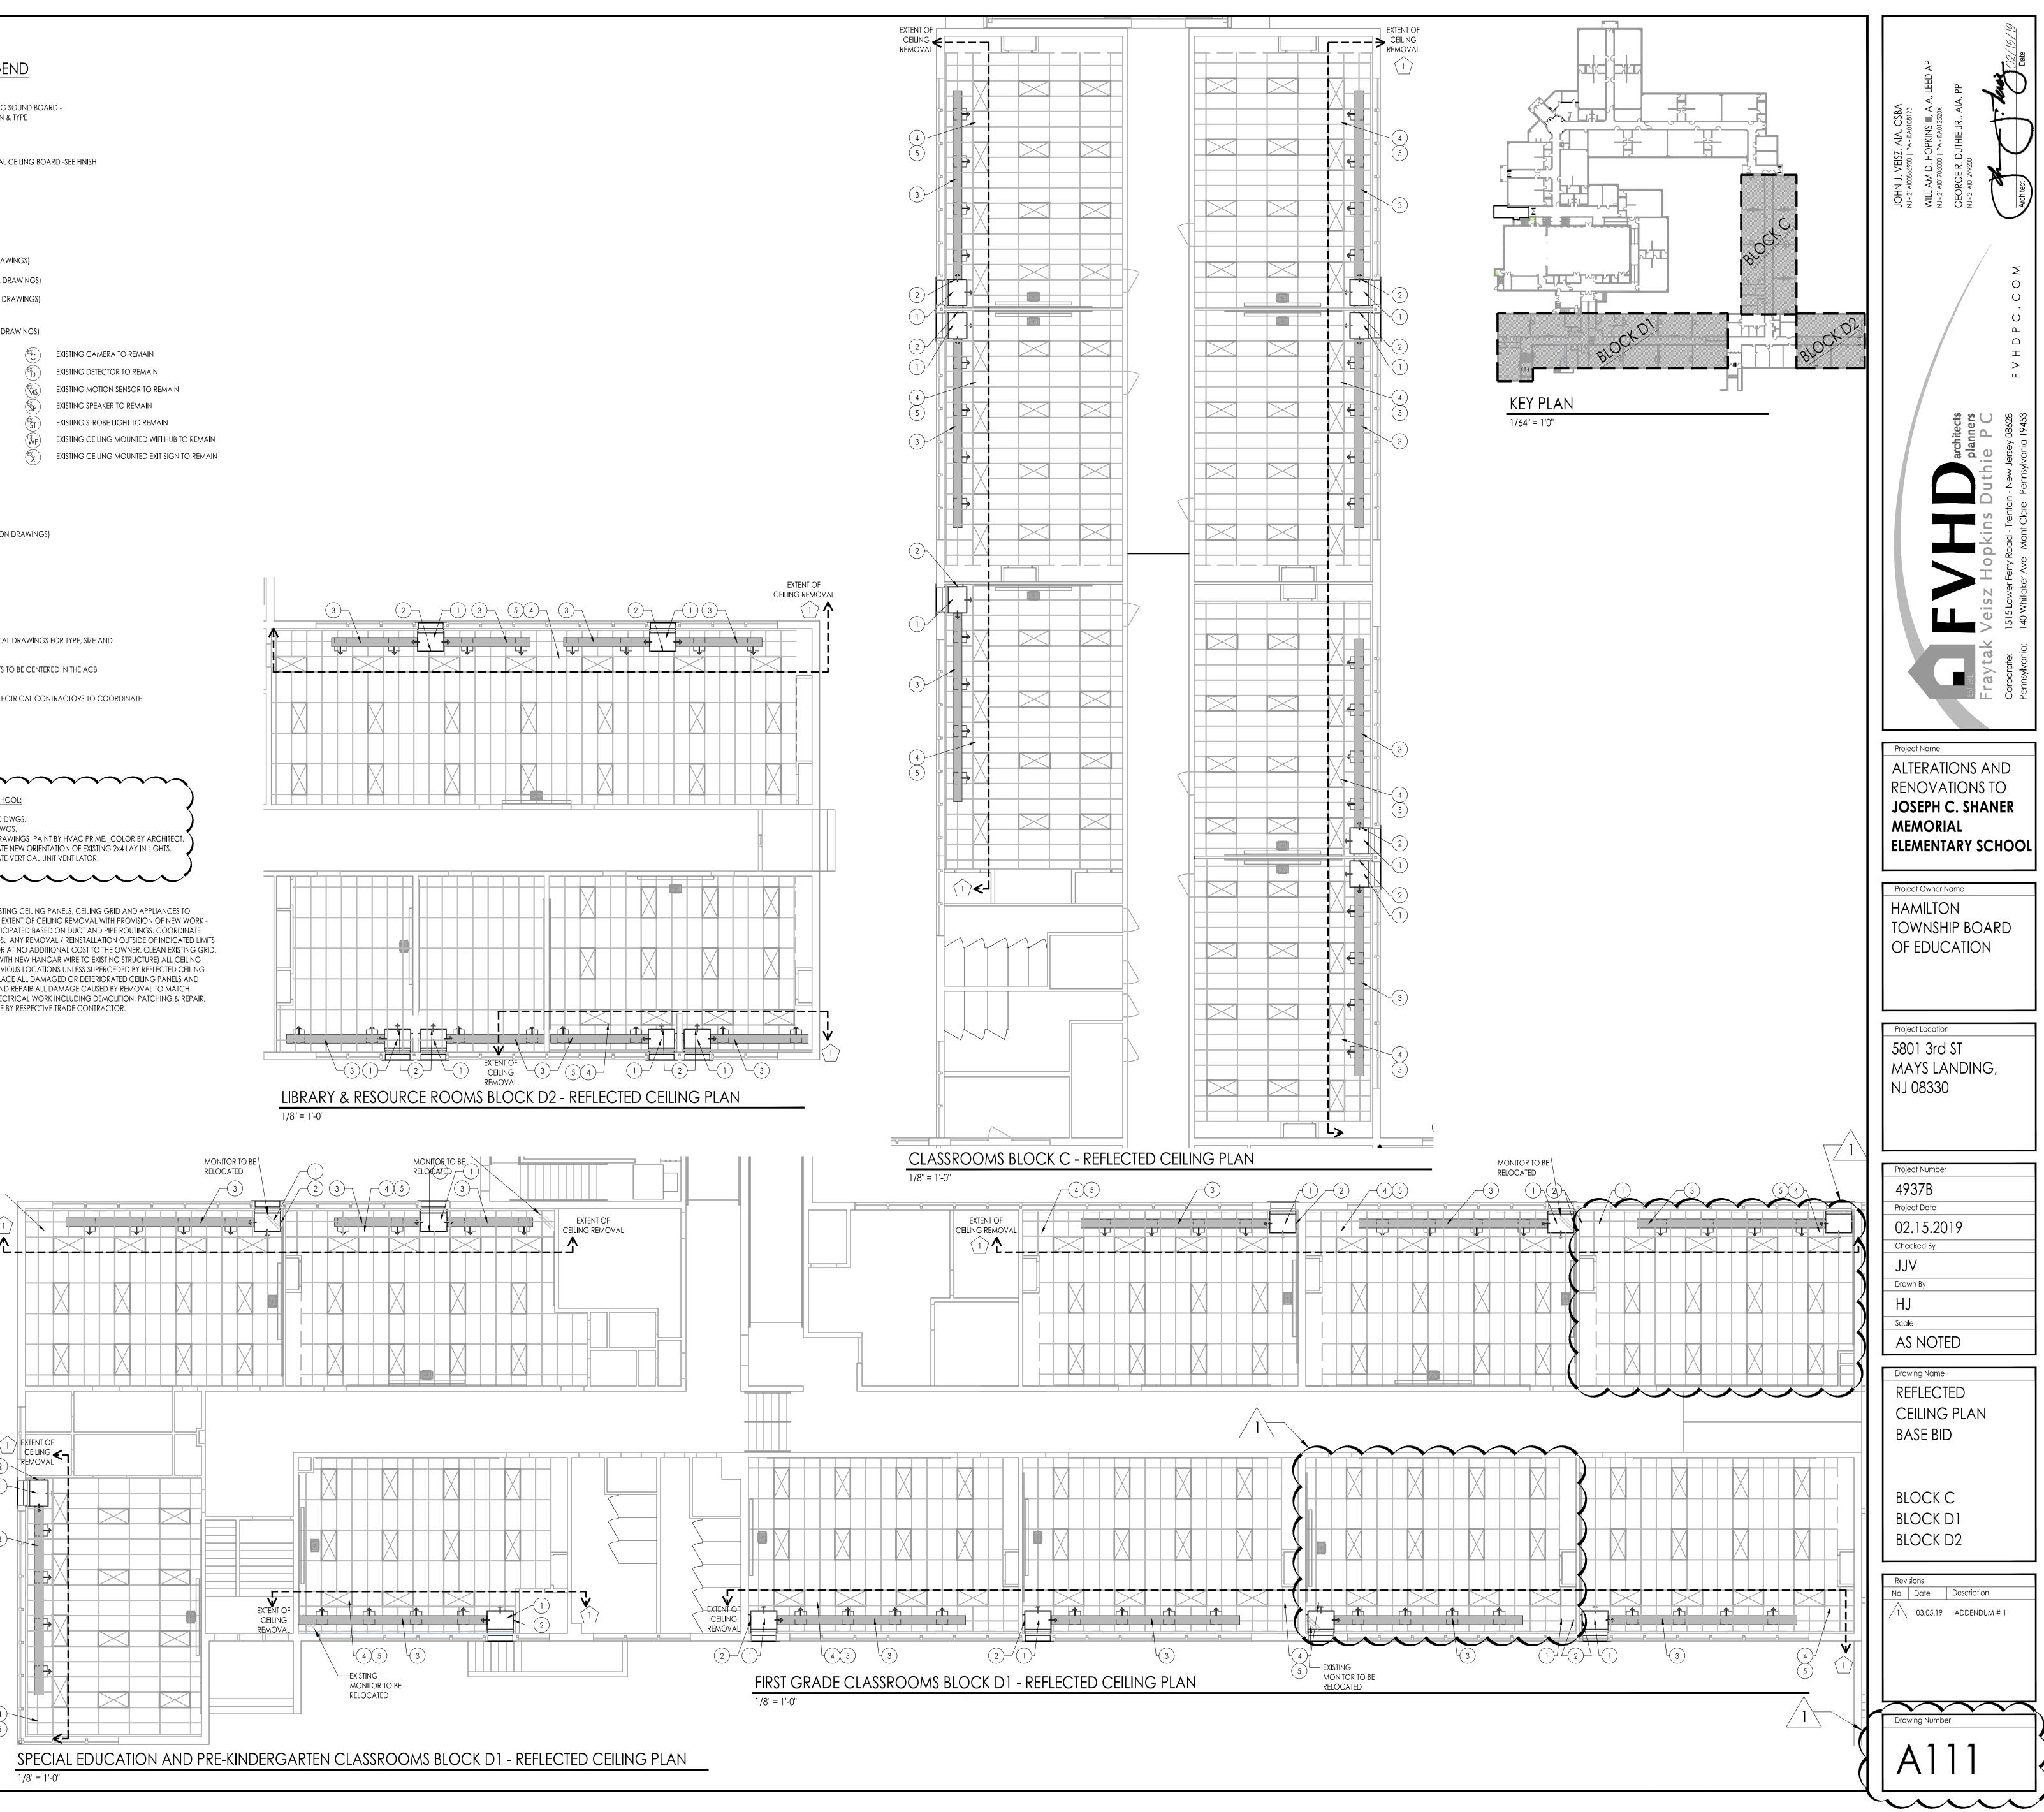
- 9. EXISTING PLUMBING THROUGH COUNTERTOP AND CASEWORK. VERIFY SIZE AND LOCATION IN FIELD. COORDINATE WITH NEW COUNTERTOP AND CASEWORK.



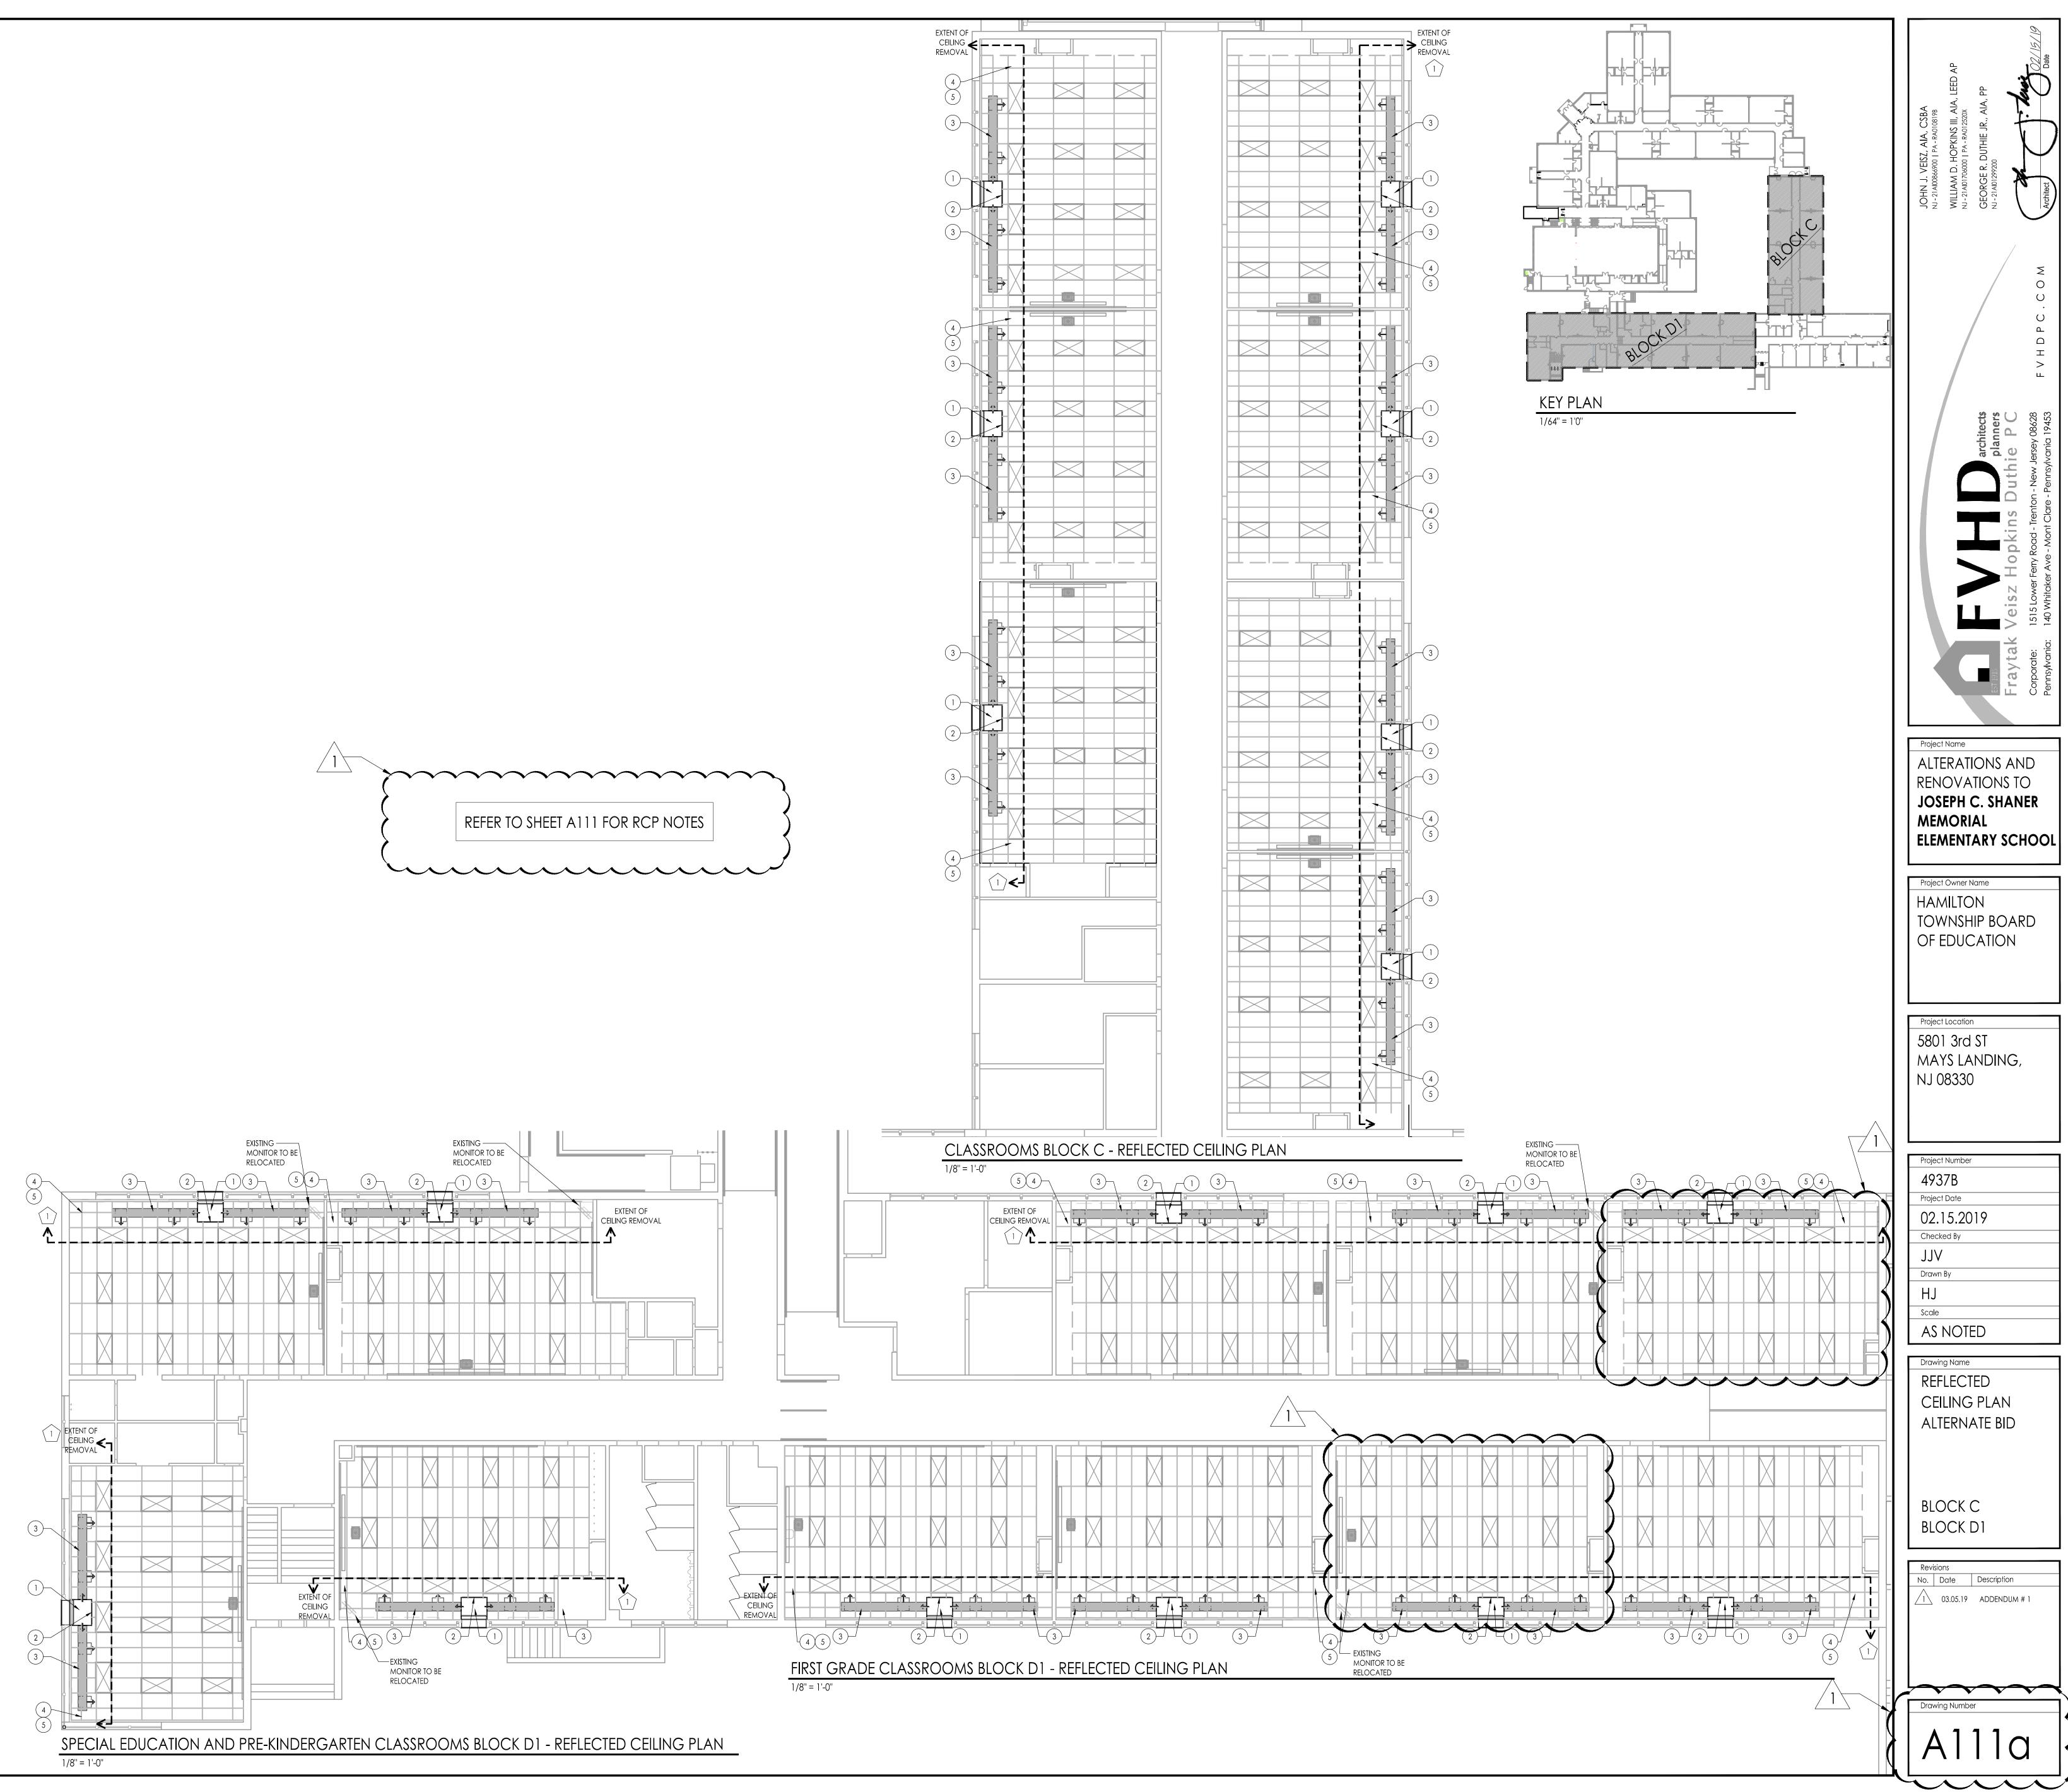


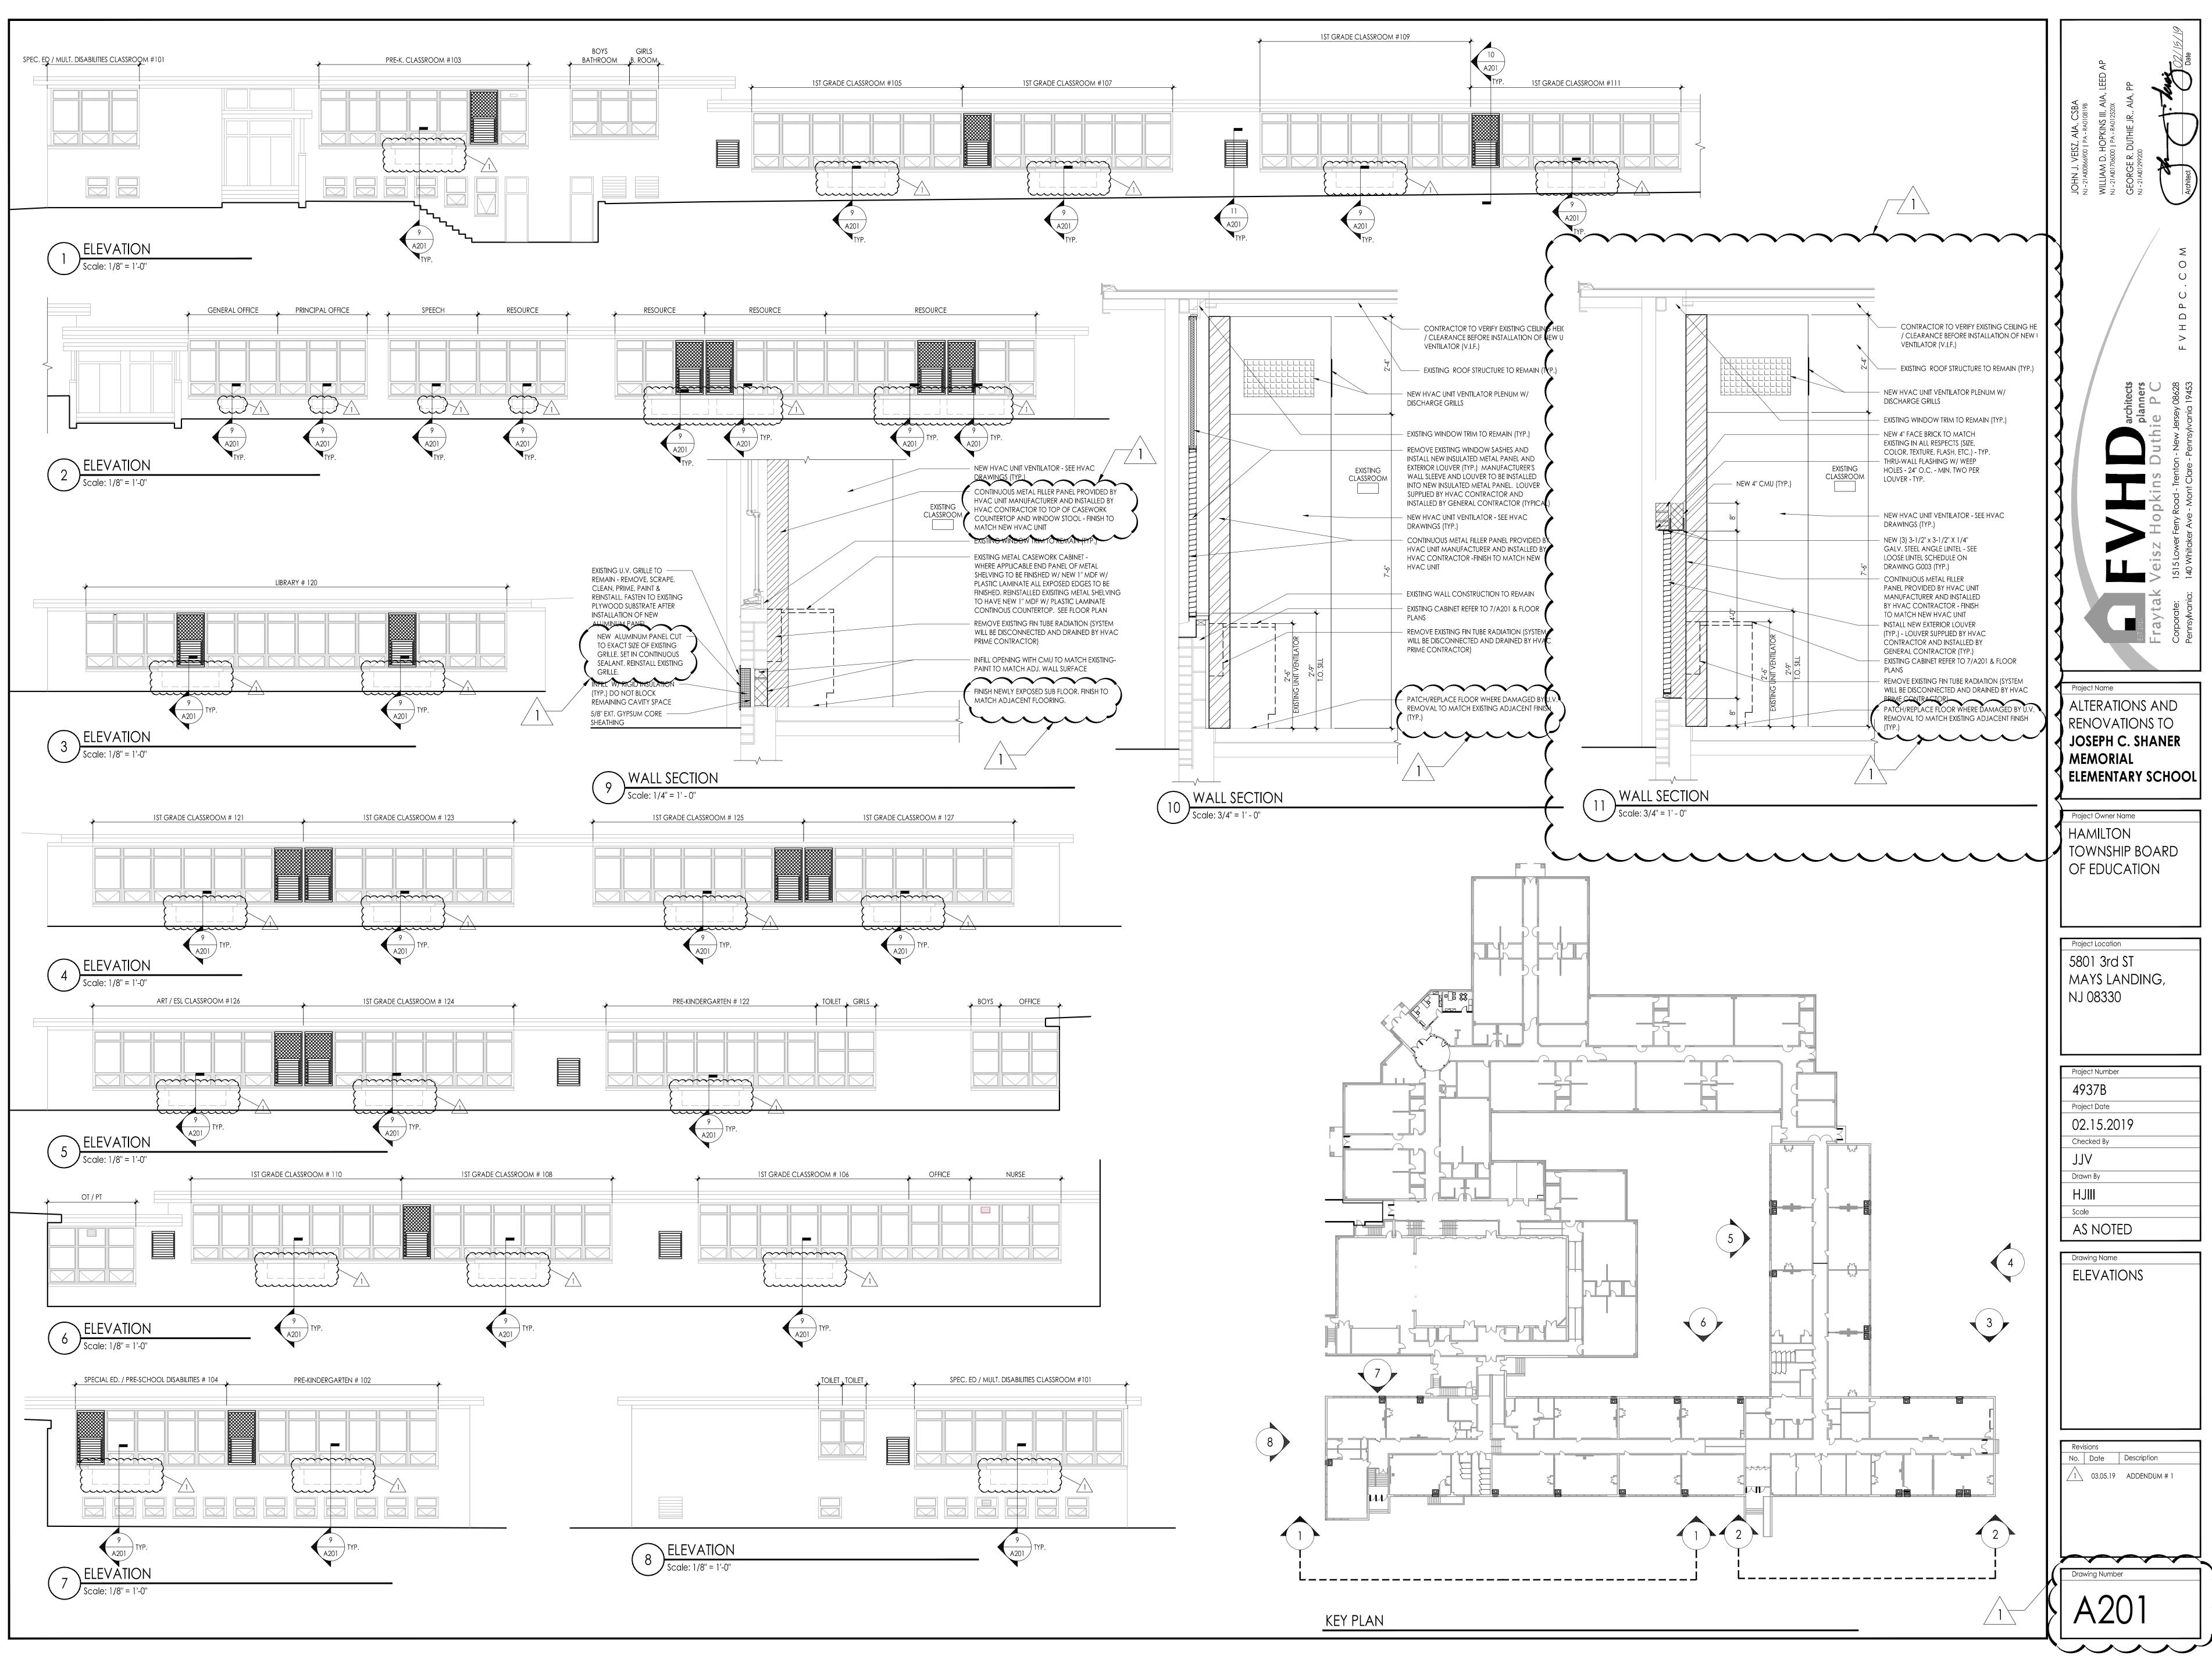


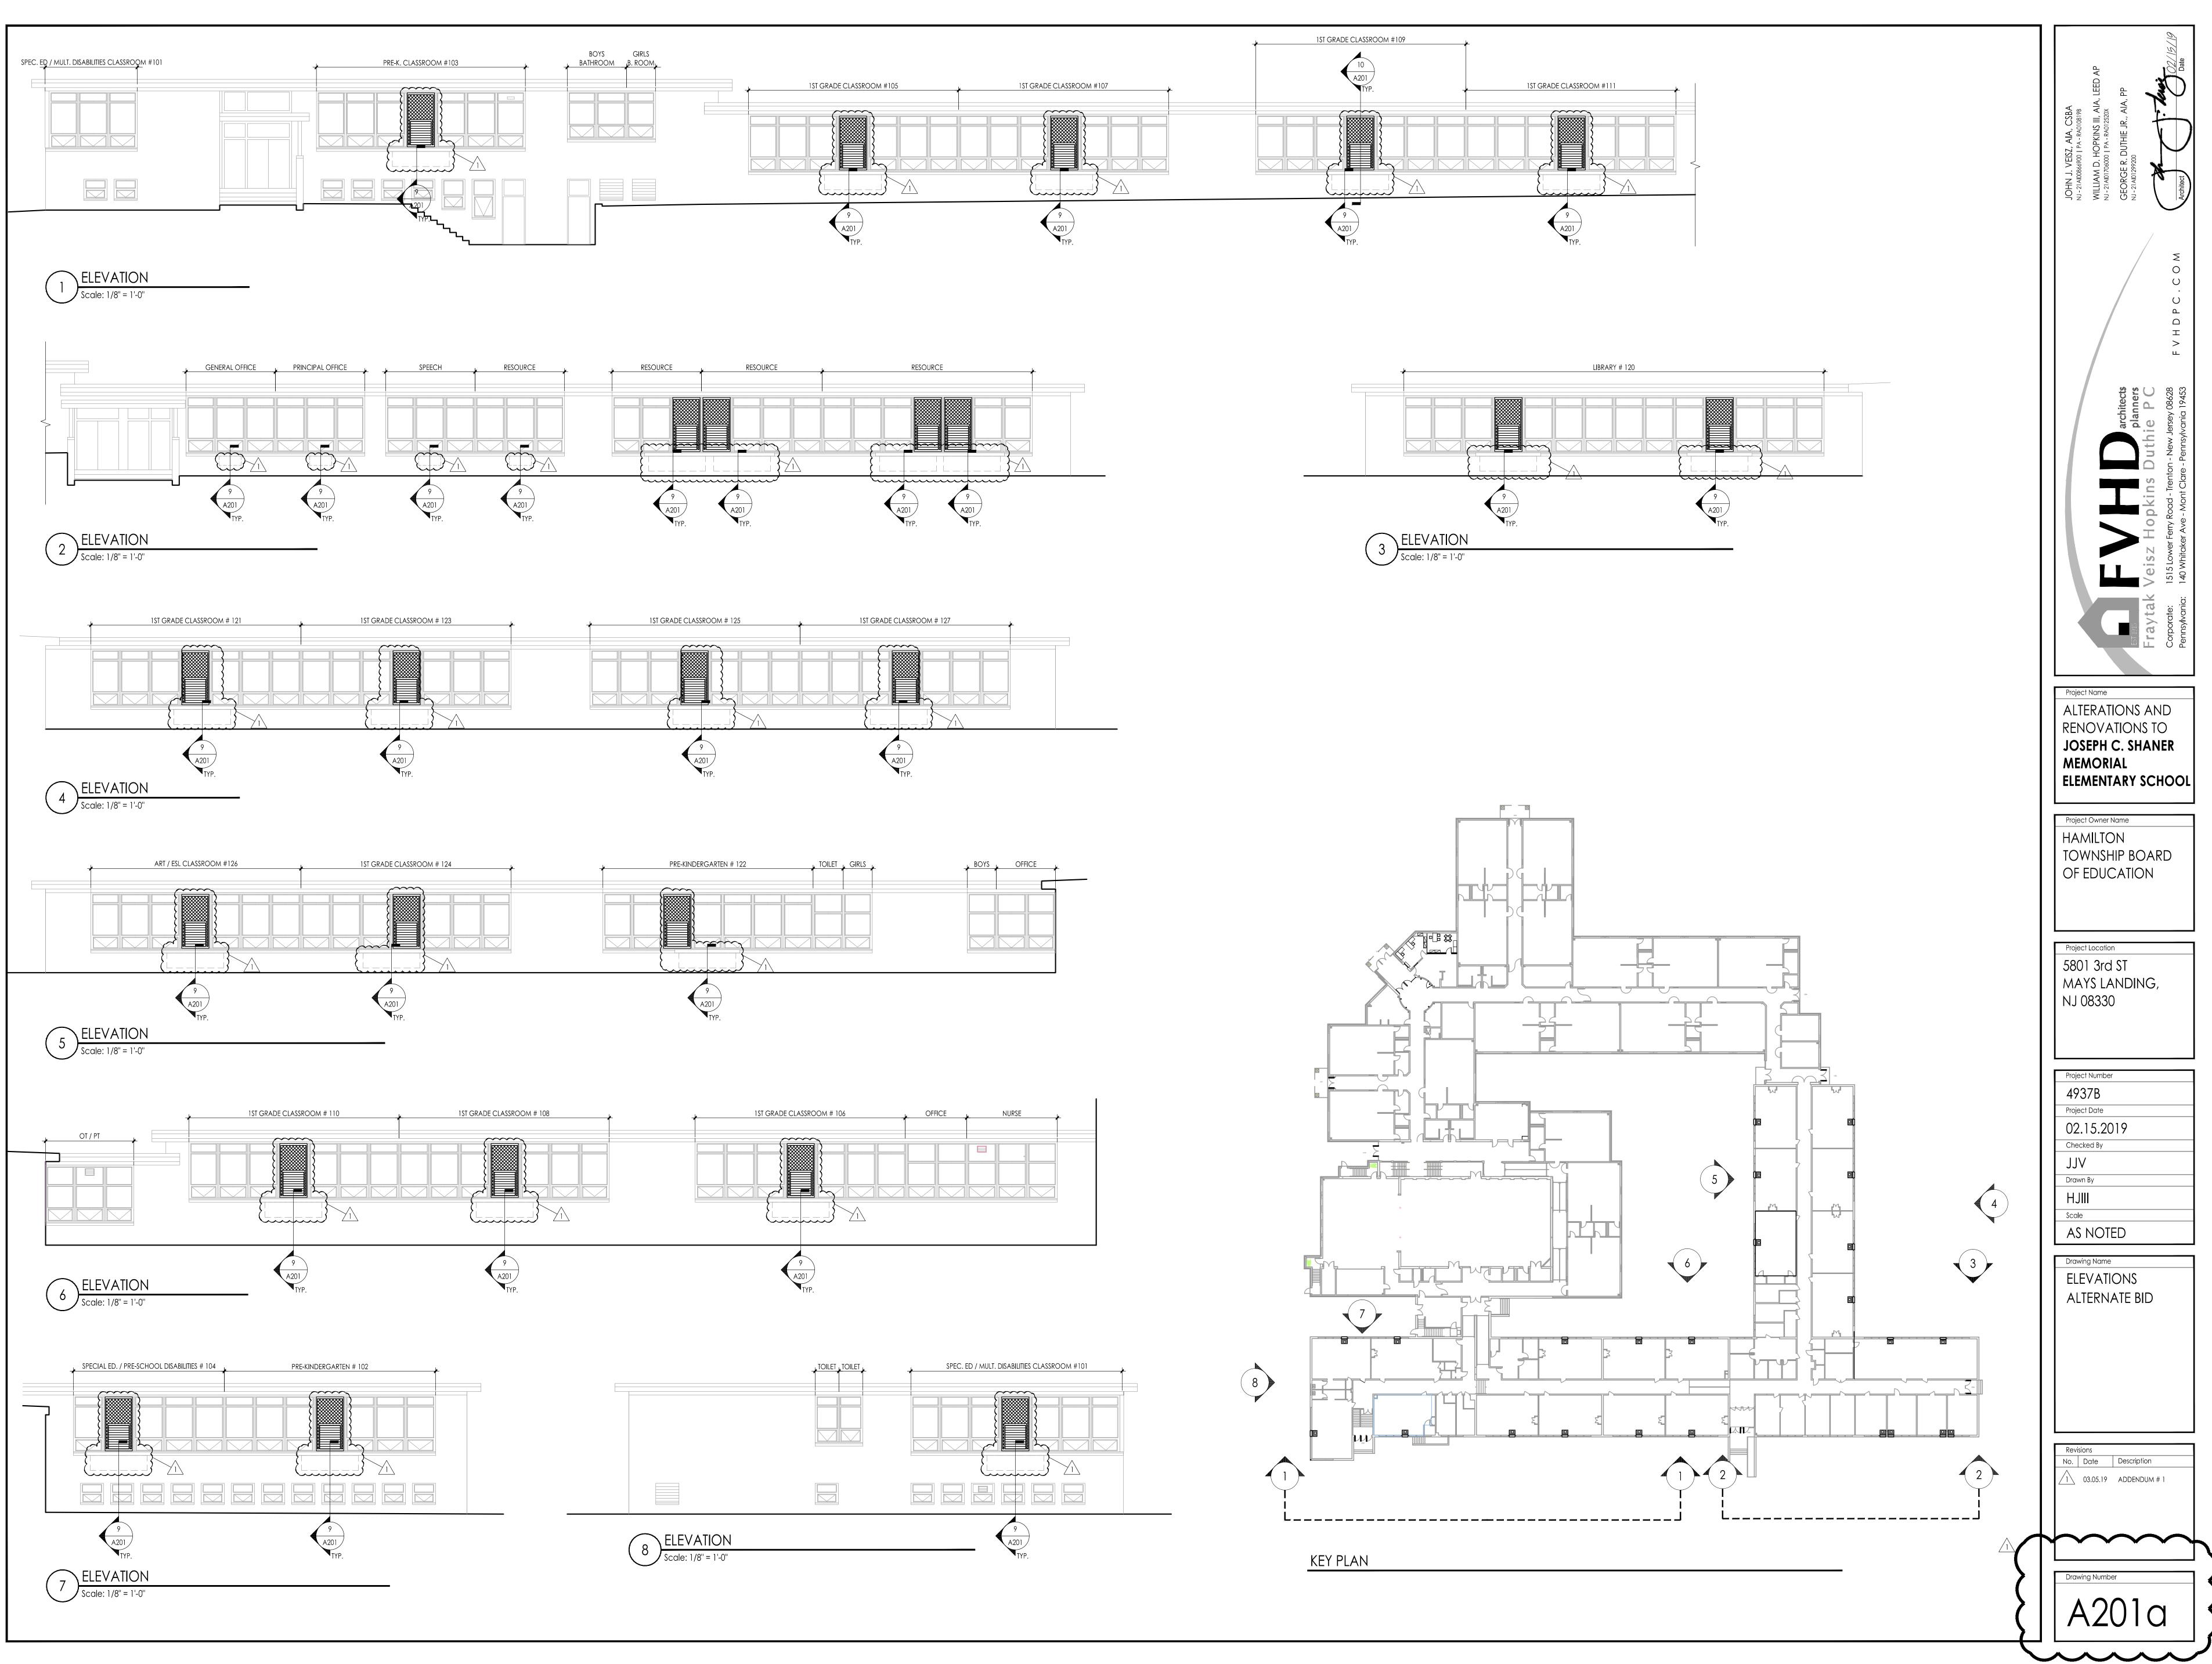
1/8" = 1'-0"



SPECIAL EDUCATION AND PRE-KINDERGARTEN CLASSROOMS BLOCK D1 - REFLECTED CEILING PLAN







	DOOR / WINDOW S	MOC	SCHEDULE	OULE			
	JOSEPH C	SHAN:	NER				
DR	DOOR		DOOR / WINDOW		FRAME	ИЕ	
0 N	LOCATION	SIZE	MAT.	GLASS	ТҮРЕ	MAT.	REMARKS
S101	EXTERIOR ENTRY DOOR @ SECURITY VESTIBULE	V.I.F.	FRP	ETR-F	A	AL	DOOR NOTE # 1,2
S102	EXTERIOR ENTRY DOOR @ SECURITY VESTIBULE	V.I.F	FRP	ETR-F	A	AL	DOOR NOTE # 1,2
S103	EXTERIOR ENTRY DOOR @ K2/K3 CORRIDOR	V.I.F	FRP	ETR-F	В	AL	DOOR NOTE # 1,2
S104	EXTERIOR ENTRY DOOR @ K7-K8 CORRIDOR	V.I.F	FRP	ETR-F	В	AL	DOOR NOTE # 1,2
S105	EXTERIOR ENTRY DOOR @ K9/1ST GRADE	V.I.F	FRP	ETR-F	C	AL	DOOR NOTE # 1,2
S106	EXTERIOR ENTRY DOOR @ LIBARY/RESOURCE	V.I.F	FRP	ETR-F	Е	AL	DOOR NOTE # 1,2
S107	EXTERIOR ENTRY DOOR @ ADMIN/1ST GRADE	V.I.F	FRP	ETR-F	F	AL	DOOR NOTE # 1,2
S108	EXTERIOR ENTRY DOOR @ADMIN/1ST GRADE	V.I.F	FRP	ETR-F	Ŧ	AL	DOOR NOTE # 1,2
S109	EXTERIOR ENTRY DOOR @ SPECIAL ED/1ST GRADE	V.I.F	FRP	ETR-F	G	AL	DOOR NOTE # 1,2
S110	EXTERIOR ENTRY DOOR @ SPECIAL ED/CAFETRIA	V.I.F	FRP	ETR-F	D	AL	DOOR NOTE # 1,2
FRP	EXTERIOR ENTRY DOOR @ SPECIAL ED13/SPECIAL ED15	V.I.F	FRP	ETR-F	В	AL	DOOR NOTE # 1,2
Drawing Number AD1-A01	4937C Project Date O.3.05.2019 Checked By Drawn By KM Scale NOT TO SCALE DOOR SCHEDULE Hamilton Township School District Revisions No Date Description	Project Location 1876 DENNIS FORMAN DR MAYS LANDING, NJ 08330 Project Number	Project Nome ALTERATIONS AND RENOVATIONS TO WILLIAM DAVIES MIDDLE SCHOOL Project Owner Nome HAMILTON TOWNSHIP BOARD OF EDUCATION		Hopkins Duth	architects planners i e P C Jersey 08628 F V H D P C . C O M	JOHN J. VEISZ, AIA, CSBA NJ. 31/4026001 Pra-Sunitaria WILLMD. D. HOPRINSII Pra-JUSZER NJ. 21/401760001 Pra-JUSZER NJ. 21/40176001 Pra-JUSZER NJ. 21/401760001 Pra-JUSZER NJ. 21/4017600000000000000000000000000000000000

GENERAL CASEWORK NOTES:

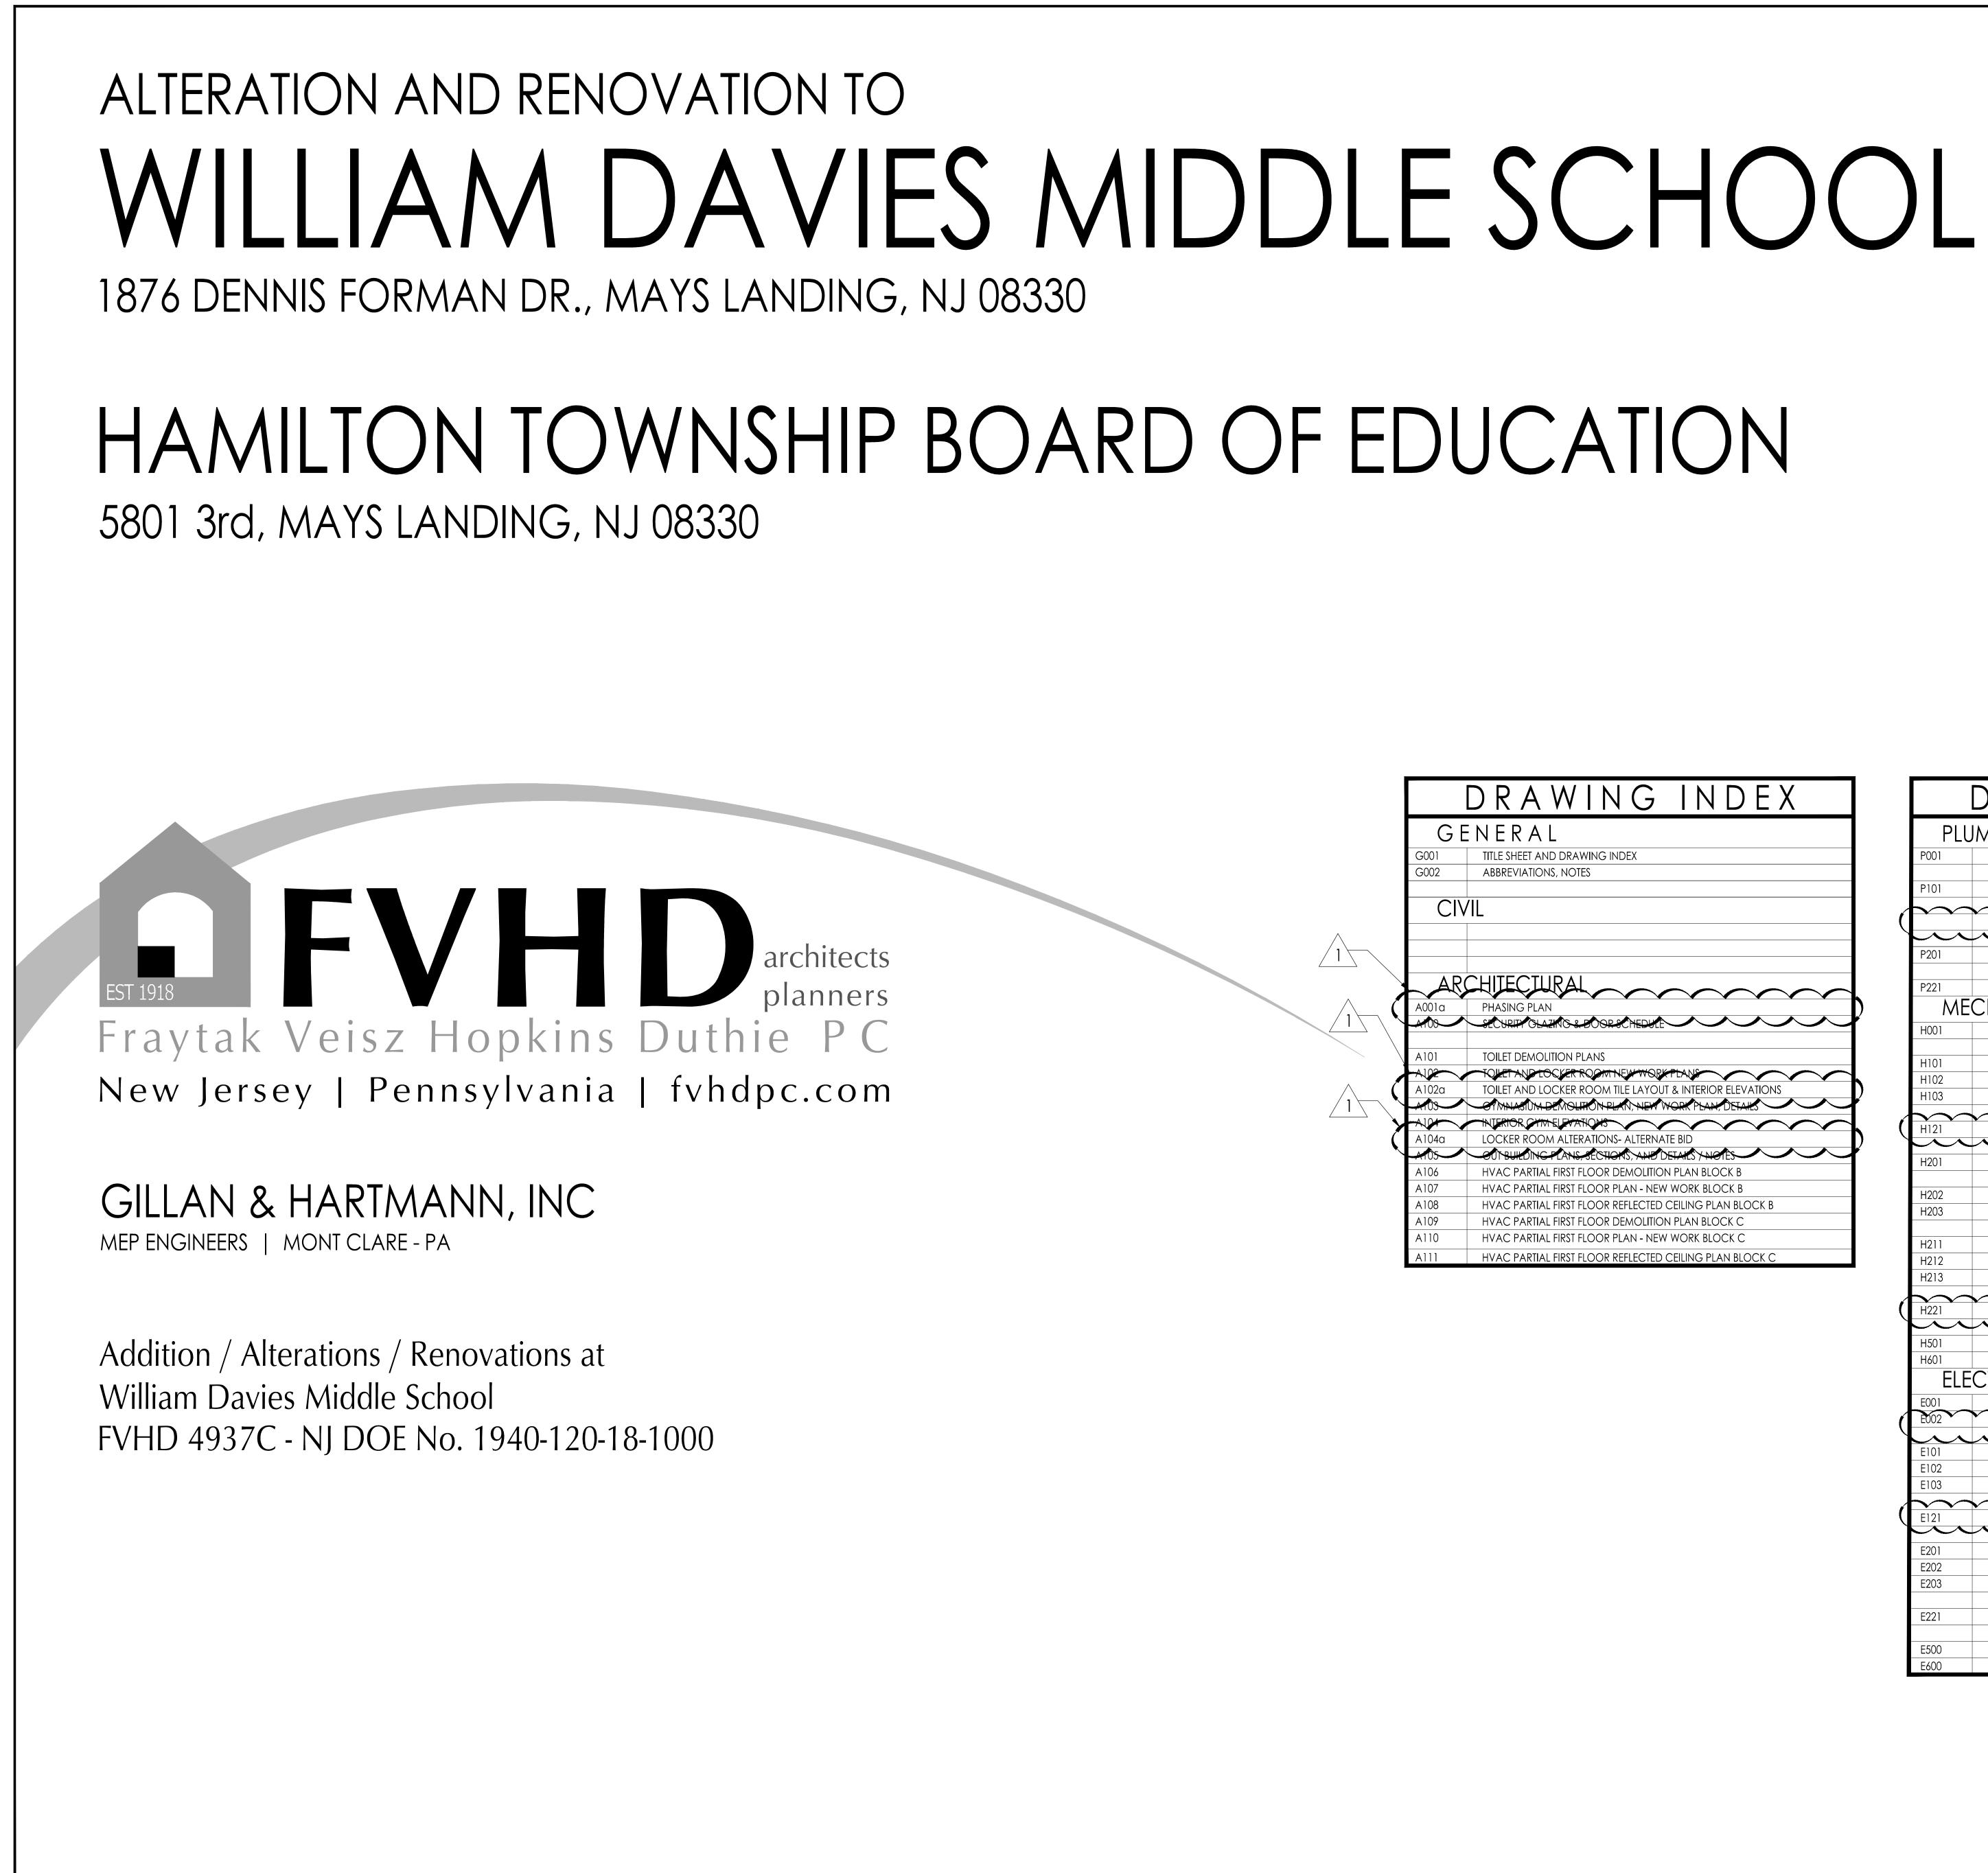
- 1. CATALOG NUMBERS REFER TO <u>MOST CURRENT</u> CAMPBELL RHEA CASEWORK CATALOG UNLESS OTHERWISE NOTED. FOR REFERENCE ONLY.
- 2. NOT USED
- 3. ALL TOPS SHALL BE PLYWOOD, 1" TOTAL THK. WITH PLASTIC LAMINATE COVERING ON ALL EXPOSED SURFACES (UNLESS NOTED OTHERWISE)
- 4. ALL BACKSPLASHES SHALL BE 3/4" PLYWOOD WITH PLASTIC LAMINATE COVERING ON ALL EXPOSED SURFACES (UNLESS NOTED OTHERWISE).
- 5. ALL FURNITURE AND EQUIPMENT SHOWN DOTTED AND/OR INDICATED AS (N.I.C.) IS NOT IN CONTRACT.
- 6. THE CASEWORK & EQUIPMENT SUB-CONTRACTOR(S) SHALL TURN OVER TO THE PLUMBING AND ELECTRICAL PRIME CONTRACTOR(S) IN A PACKAGE, ALL SINKS, FIXTURES, FAUCETS, TAILPIECES, STRAINERS, ETC., AND ELECTRICAL DEVICES, NIPPLES AND LOCKNUTS, ETC., FOR INSTALLATION AND FINAL CONNECTION.
- 7. THE CASEWORK AND EQUIPMENT SUB-CONTRACTOR SHALL PROVIDE AN ITEMIZED LIST AND A DESIGNATED SITE LOCATION FOR THE TRANSFER OF THE MATERIALS REFERENCED IN NOTE 6 TO THE PLUMBING AND ELECTRICAL PRIME CONTRACTORS. THE LIST SHALL HAVE A DESCRIPTION OF THE ITEMS AND QUANTITY ALONG WITH A SIGN-OFF LINE FOR THE PLUMBING AND ELECTRICAL PRIME CONTRACTORS. A COPY OF THE SIGNED LIST IS TO BE SUBMITTED TO THE ARCHITECT / OWNER PRIOR TO BILLING FOR THIS EQUIPMENT.
- 8. EQUIPMENT SUB-CONTRACTOR SHALL MAKE SINK CUT-OUTS.
- 9. ALL DUPLEX OUTLETS SHALL BE G.F.C.I. UNLESS NOTED OTHERWISE.
- 10. SINK CABINETS SHALL BE INSTALLED BEFORE THE INSTALLATION OF ADJACENT CABINETS.
- 11. ALL CONTRACTORS TO FIELD VERIFY ALL EXISTING CONDITIONS PRIOR TO CONSTRUCTION AND NOTIFY ARCHITECT IN WRITTEN FORM OF ANY DISCREPANCIES.
- 12. PROVIDE ALL FILLERS AS REQUIRED. FILLERS AT BASE CABINETS SHALL BE AT FRONT OF CABINET AND COUNTERTOP SHALL BE CONTINUOUS OVER FILLER PANEL. FILLERS AT TALL CABINETS SHALL BE AT FRONT AND TOP OF CABINET. FILLERS AT WALL CASES SHALL BE AT FRONT, TOP AND BOTTOM OF CABINET. FINISH TO MATCH CASEWORK.
- 13. PLUMBING CONTRACTOR TO PROVIDE AND INSTALL CLAY TRAPS ON SINKS IN ART CLASSROOM AND SHALL MAKE FINAL CONNECTIONS TO ALL WASTE/VENTS, WATER LINES ETC. AS REQUIRED TO MAKE SYSTEM FULLY FUNCTIONAL.
- 14. NOT USED
- 15. RUBBER BASE ON ALL CASEWORK BY G.C. (TYPICAL)

SINK NOTE 'x':

CRB-ADA-2022-A-GR JUST STAINLESS STEEL SINK W/ BUBBLER COMBINATION, "THE ACADEMIC GROUP A" SERIES, TYPE 304, LEDGE TYPE, FAUCET LEDGE REAR, BUBBLER LEDGE RIGHT, SINGLE COMPARTMENT, SELF-RIM, 18 GAUGE STAINLESS STEEL, 22" x 20" x 6" DEEP, SINK UNDERCOATED W/ SOUND DEADENING MATERIAL. FURNISH COMPLETE WITH JUST FAUCET (#J-1174-KS) CONCEALED HOT & COLD WATER MIXING FAUCET WITH SWIVEL GOOSENECK SPOUT, AERATOR & WRIST BLADE HANDLES. INCLUDE ONE JUST BUBBLER (#JBB5) W/ SELF-CLOSING LEVER HANDLE. INCLUDE ONE JUST OFFSET DRAIN ASSEMBLY (#J-ADA-35-FS) W/ DRAIN INSULATING KIT (#J-ADA-150), JUST STAINLESS STEEL FLAT STRAINER & 4" LONG STAINLESS STEEL TAILPIECE (#J-35-SSF).

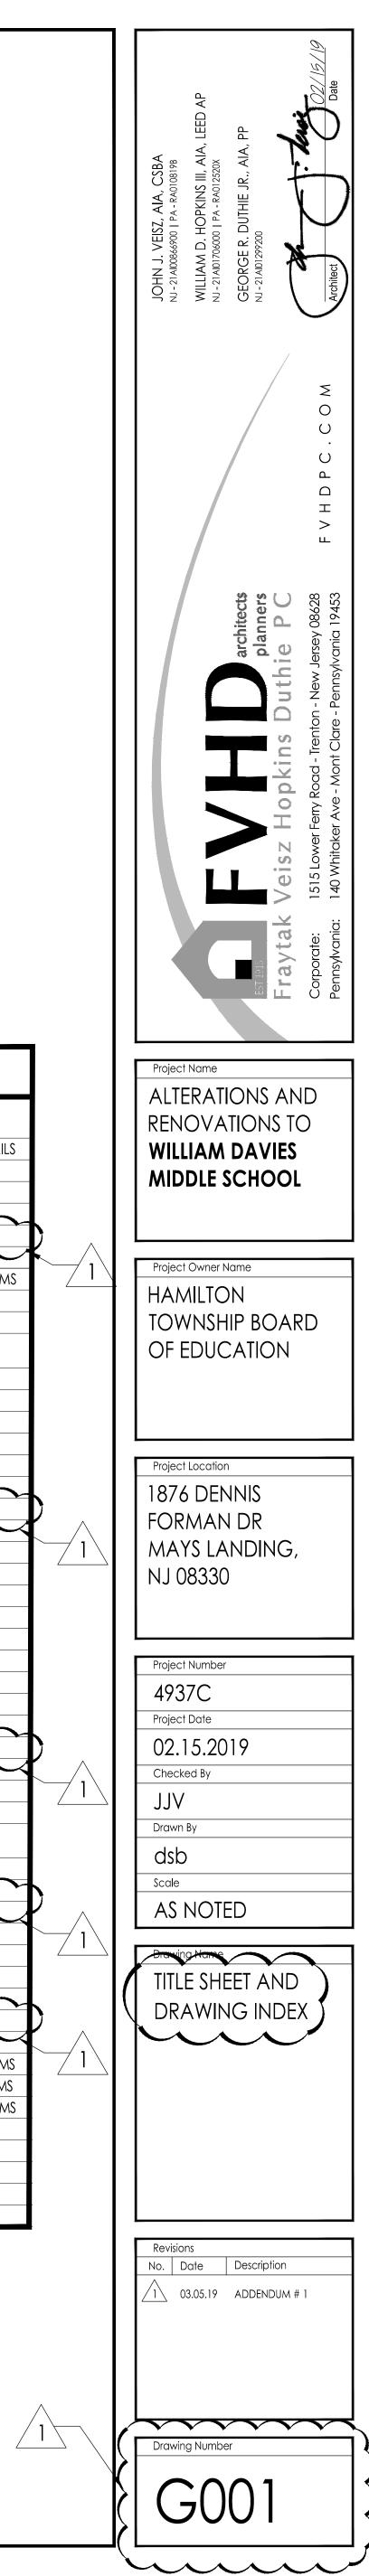
SINK, FAUCET, STRAINER AND TAILPIECE TO BE SUPPLIED BY EQUIPEMENT SUB-CONTRACTOR. THE PLUMBING CONTRACTOR SHALL PROVIDE AND INSTALL ALL TRAPS, VALVES, WASTE LINES, ETC. AS REQUIRED TO MAKE THE SYSTEM FULLY FUNCTIONAL. THE PLUMBING CONTRACTOR SHALL MAKE THE FINAL PLUMBING CONNECTIONS REQUIRED TO MAKE THE SYSTEM FULLY FUNCTIONAL. SEE GENERAL CASEWORK NOTES # 6 & 7.

	_
	JOHN J. VERZ, AIA, CSBA JU-91084680 IA- NOURSII WILLAM D. HOFRNS III. AIA. IEED AP WILLAM D. HOFRNS III. AIA. PP WI-210075620 IA- NAL MA. PP WI-2100157520 DUTHE JR., AIA. PP
	F V H D P C . C O M
	Fraytak Veisz Hopkins Duthie P C coporete: 1515,00005 Franton - New Jersey 08628 Fransylvonds: 140 Wildoke Ave - Mont Clore - Pennsylvonds: 1943
	Project Name ALTERATIONS AND RENOVATIONS TO
	JOSEPH C. SHANER MEMORIAL ELEMENTARY SCHOOL
	Project Owner Name HAMILTON TOWNSHIP BOARD OF EDUCATION
	Project Location 5801 3rd ST MAYS LANDING, NJ 08330
	Project Number
,	4937B Project Date
, 	03.05.2019 Checked By
+	Drawn By
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	NOT TO SCALE
Γ	Drawing Name GENERAL CASEWORK NOTES
	Hamilton Township School District
	Revisions No, Date Description
	Drawing Number
	AD1-A02

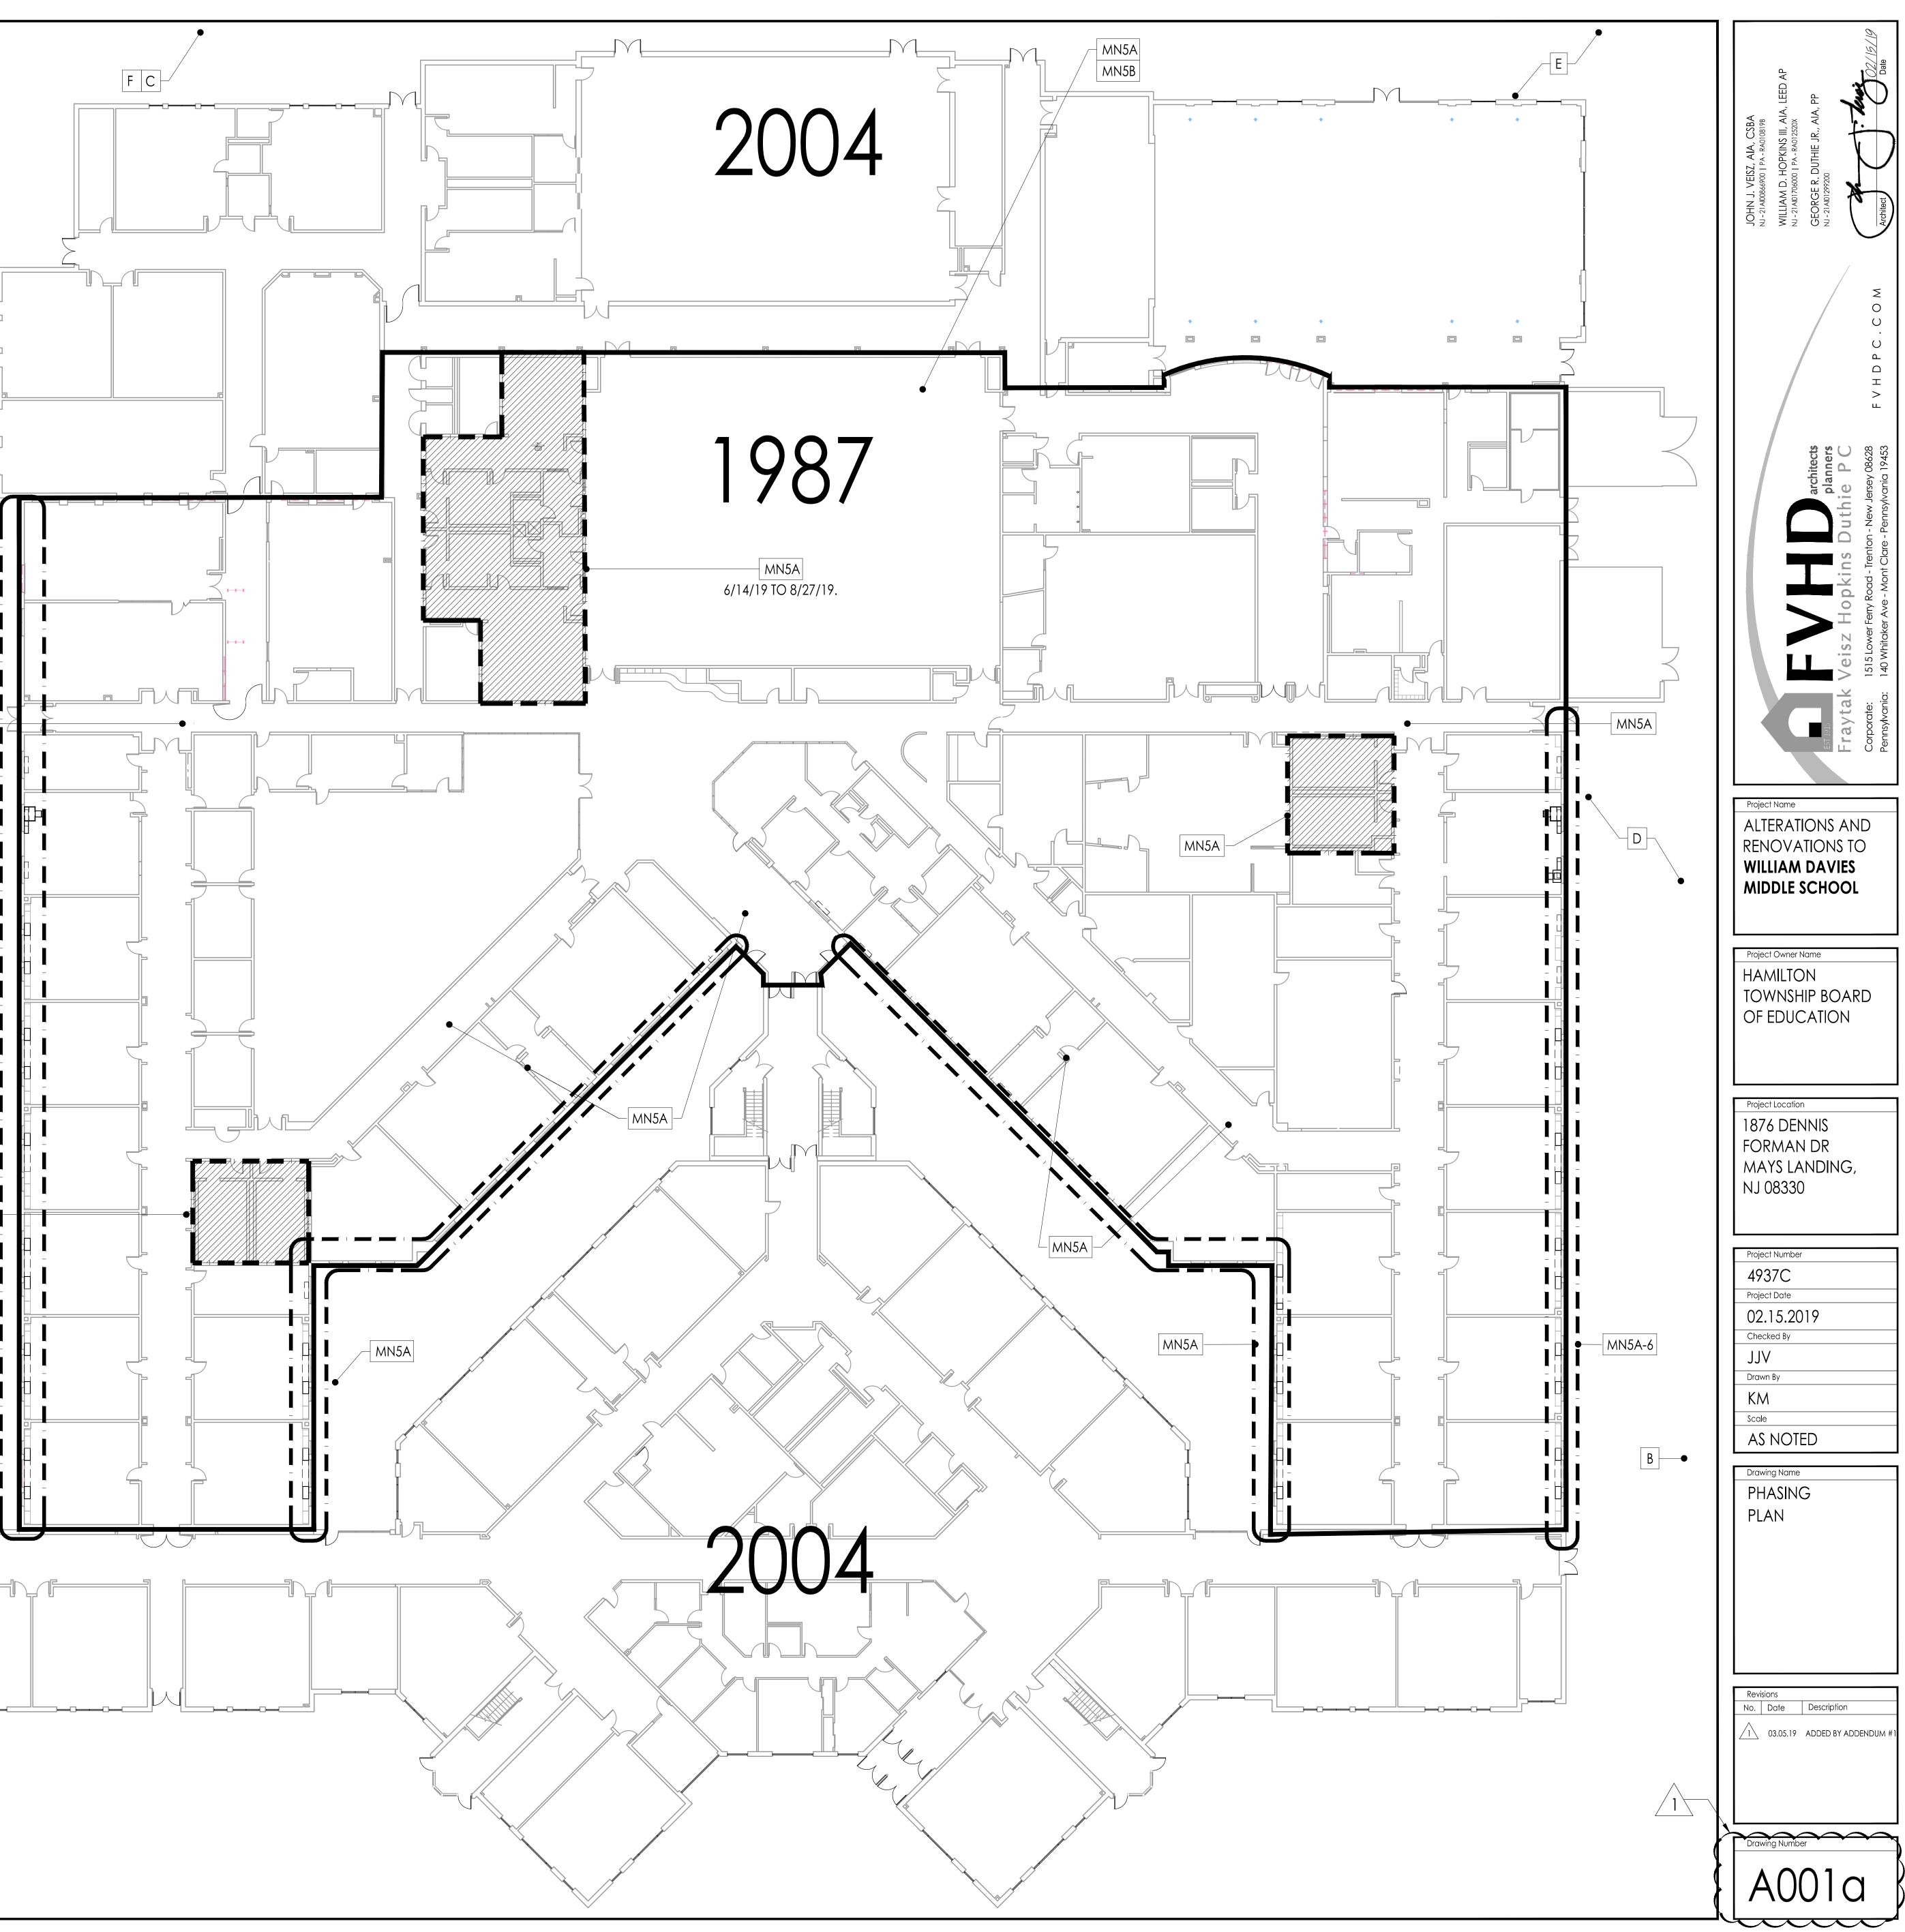


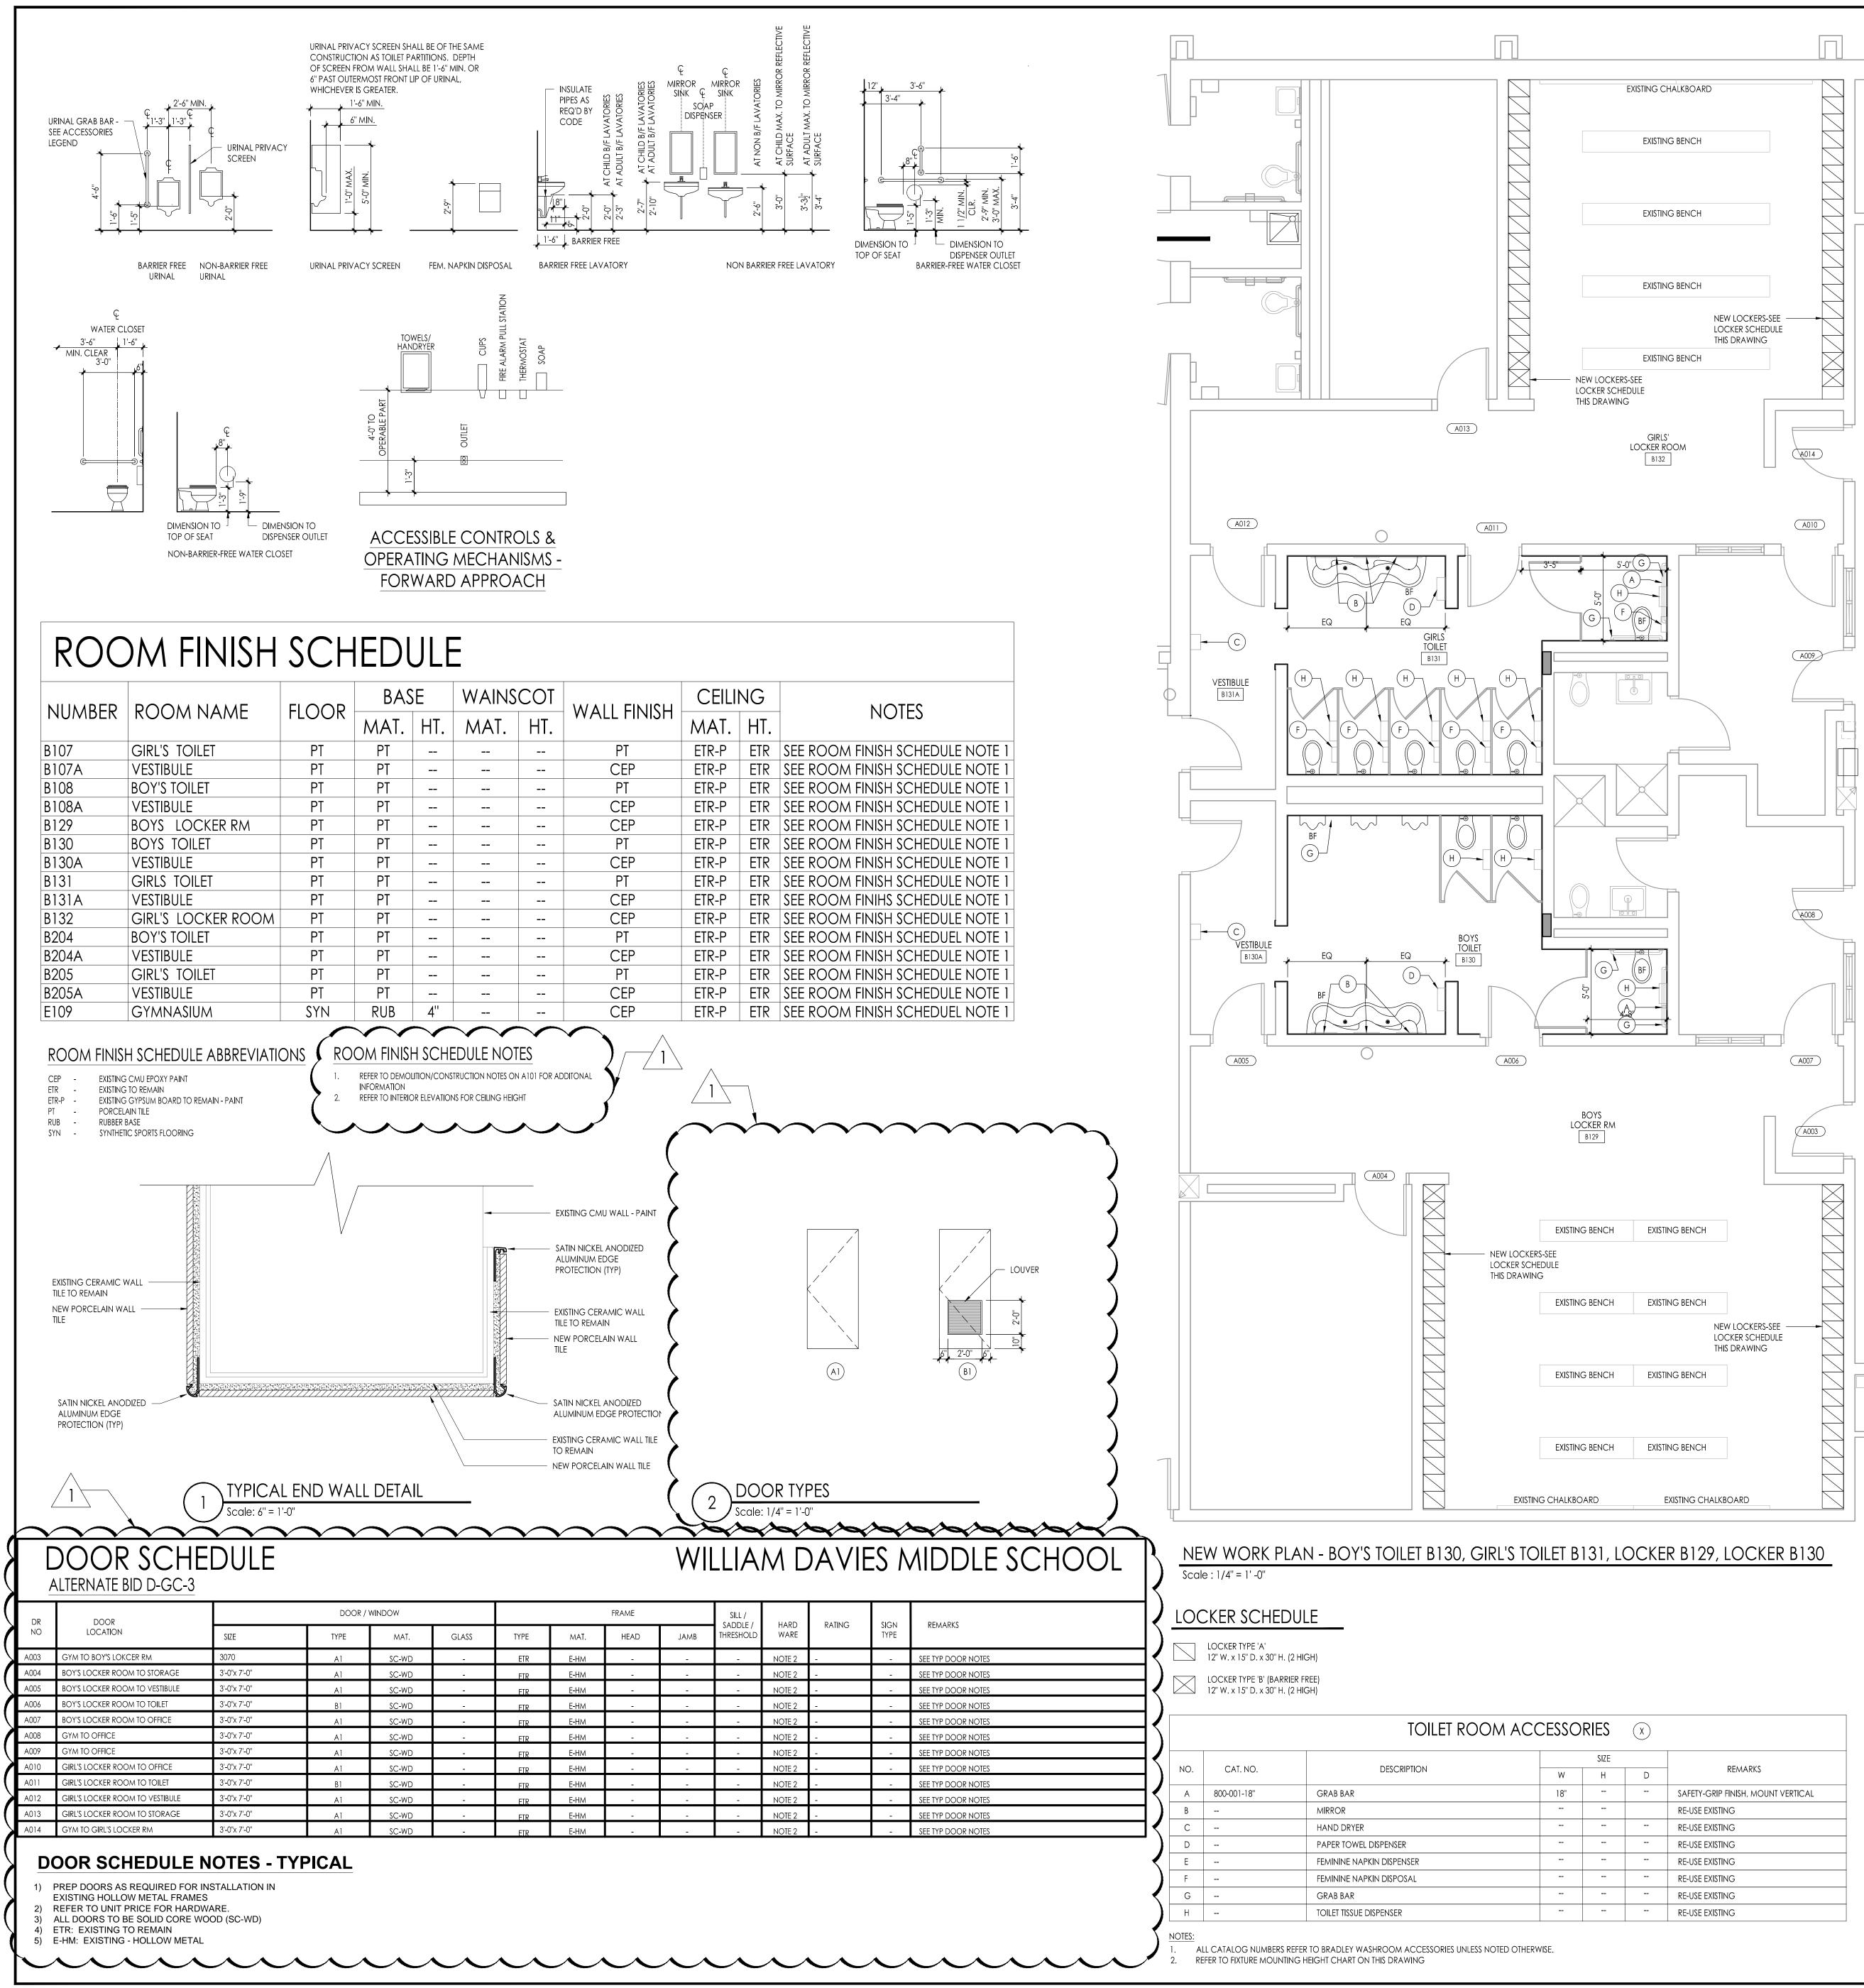
AWING INDEX
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HEET AND DRAWING INDEX
VIATIONS, NOTES
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NG PLAN
DEMOLITION PLANS
AND LOCKER ROOM INEW WORK PLANS
AND LOCKER ROOM TILE LAYOUT & INTERIOR ELEVATIONS
LASIDM-DEMOLITION PLAN, NEW WORK PLAN, DETAILS
OR CHIMELEWATIONS
ER ROOM ALTERATIONS- ALTERNATE BID
UHEDING PLANS, SECTIONS, AND DETAILS Y NOTES
PARTIAL FIRST FLOOR DEMOLITION PLAN BLOCK B
PARTIAL FIRST FLOOR PLAN - NEW WORK BLOCK B
PARTIAL FIRST FLOOR REFLECTED CEILING PLAN BLOCK B
PARTIAL FIRST FLOOR DEMOLITION PLAN BLOCK C
PARTIAL FIRST FLOOR PLAN - NEW WORK BLOCK C
PARTIAL FIRST FLOOR REFLECTED CEILING PLAN BLOCK C

		DRAWING INDEX
	PII	JMBING
	P001	PLUMBING GENERAL NOTES, LEGEND, ABBREVIATIONS, SCHEDULES, & DETAIL
	P101	PARTIAL FLOOR PLAN: PLUMBING REMOVALS
	$\sim\sim$	
	P201	PARTIAL FIRST FLOOR PLAN: PLUMBING NEW WORK- TOILET & LOCKER ROOM
	P221	ROOF PLAN: PLUMBING NEW WORK
	ME	CHANICAL
	H001	HVAC GENERAL NOTES, LEGENDS, & ABBREVIATIONS
	H101	PARTIAL FIRST FLOOR PLAN: HVAC REMOVALS- BLOCK A
	H102	PARTIAL FIRST FLOOR PLAN: HVAC REMOVALS- BLOCK B
	H103	PARTIAL FIRST FLOOR PLAN: HVAC REMOVALS- BLOCK C
	H121	ROOF PLAN: PLUMBING REMOVALS
	H201	PARTIAL FIRST FLOOR PLAN: HVAC NEW WORK- BLOCK A & NEW STORAGE
	11201	BUILDING - DUCTWORK
	H202	PARTIAL FIRST FLOOR PLAN: HVAC NEW WORK- BLOCK B - DUCTWORK
	H203	PARTIAL FIRST FLOOR PLAN: HVAC NEW WORK- BLOCK C - DUCTWORK
	H211	PARTIAL FIRST FLOOR PLAN: HVAC NEW WORK- BLOCK A - PIPING
	H212	PARTIAL FIRST FLOOR PLAN: HVAC NEW WORK- BLOCK B - PIPING
	H213	PARTIAL FIRST FLOOR PLAN: HVAC NEW WORK- BLOCK C - PIPING
	H221	ROOF PLAN: HVAC NEW WORK
	H501	HVAC DETAILS
	H601	HVAC SCHEDULES
	ELE	CTRICAL
	E001	ELECTRICAL GENERAL NOTES, LEGENDS & ABBREVIATIONS
	E002	ELECTRICAL SINGLE LINE DIAGRAM & SITE PLAN
	E101	PARTIAL FIRST FLOOR PLAN: ELECTRICAL REMOVALS- BLOCK A
	E102	PARTIAL FIRST FLOOR PLAN: ELECTRICAL REMOVALS- BLOCK B
	E103	PARTIAL FIRST FLOOR PLAN: ELECTRICAL REMOVALS- BLOCK C
	E121	ROOF PLAN: ELECTRICAL REMOVALS
	\sim	······
	E201	PARTIAL FIRST FLOOR PLAN: ELECTRICAL NEW WORK BLOCK A- POWER AND SYSTEM
	E202 E203	PARTIAL FIRST FLOOR PLAN: ELECTRICAL NEW WORK BLOCK B- POWER AND SYSTEMS PARTIAL FIRST FLOOR PLAN: ELECTRICAL NEW WORK BLOCK C- POWER AND SYSTEM
	2200	
	E221	ROOF PLAN: ELECTRICAL NEW WORK
	E500	ELECTRICAL DETAILS
	E600	ELECTRICAL PANEL SCHEDULES
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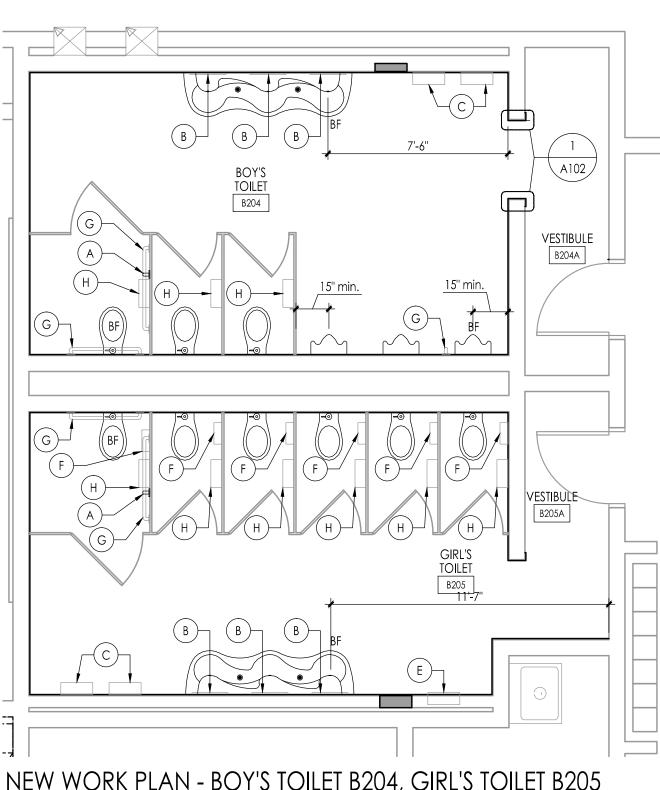


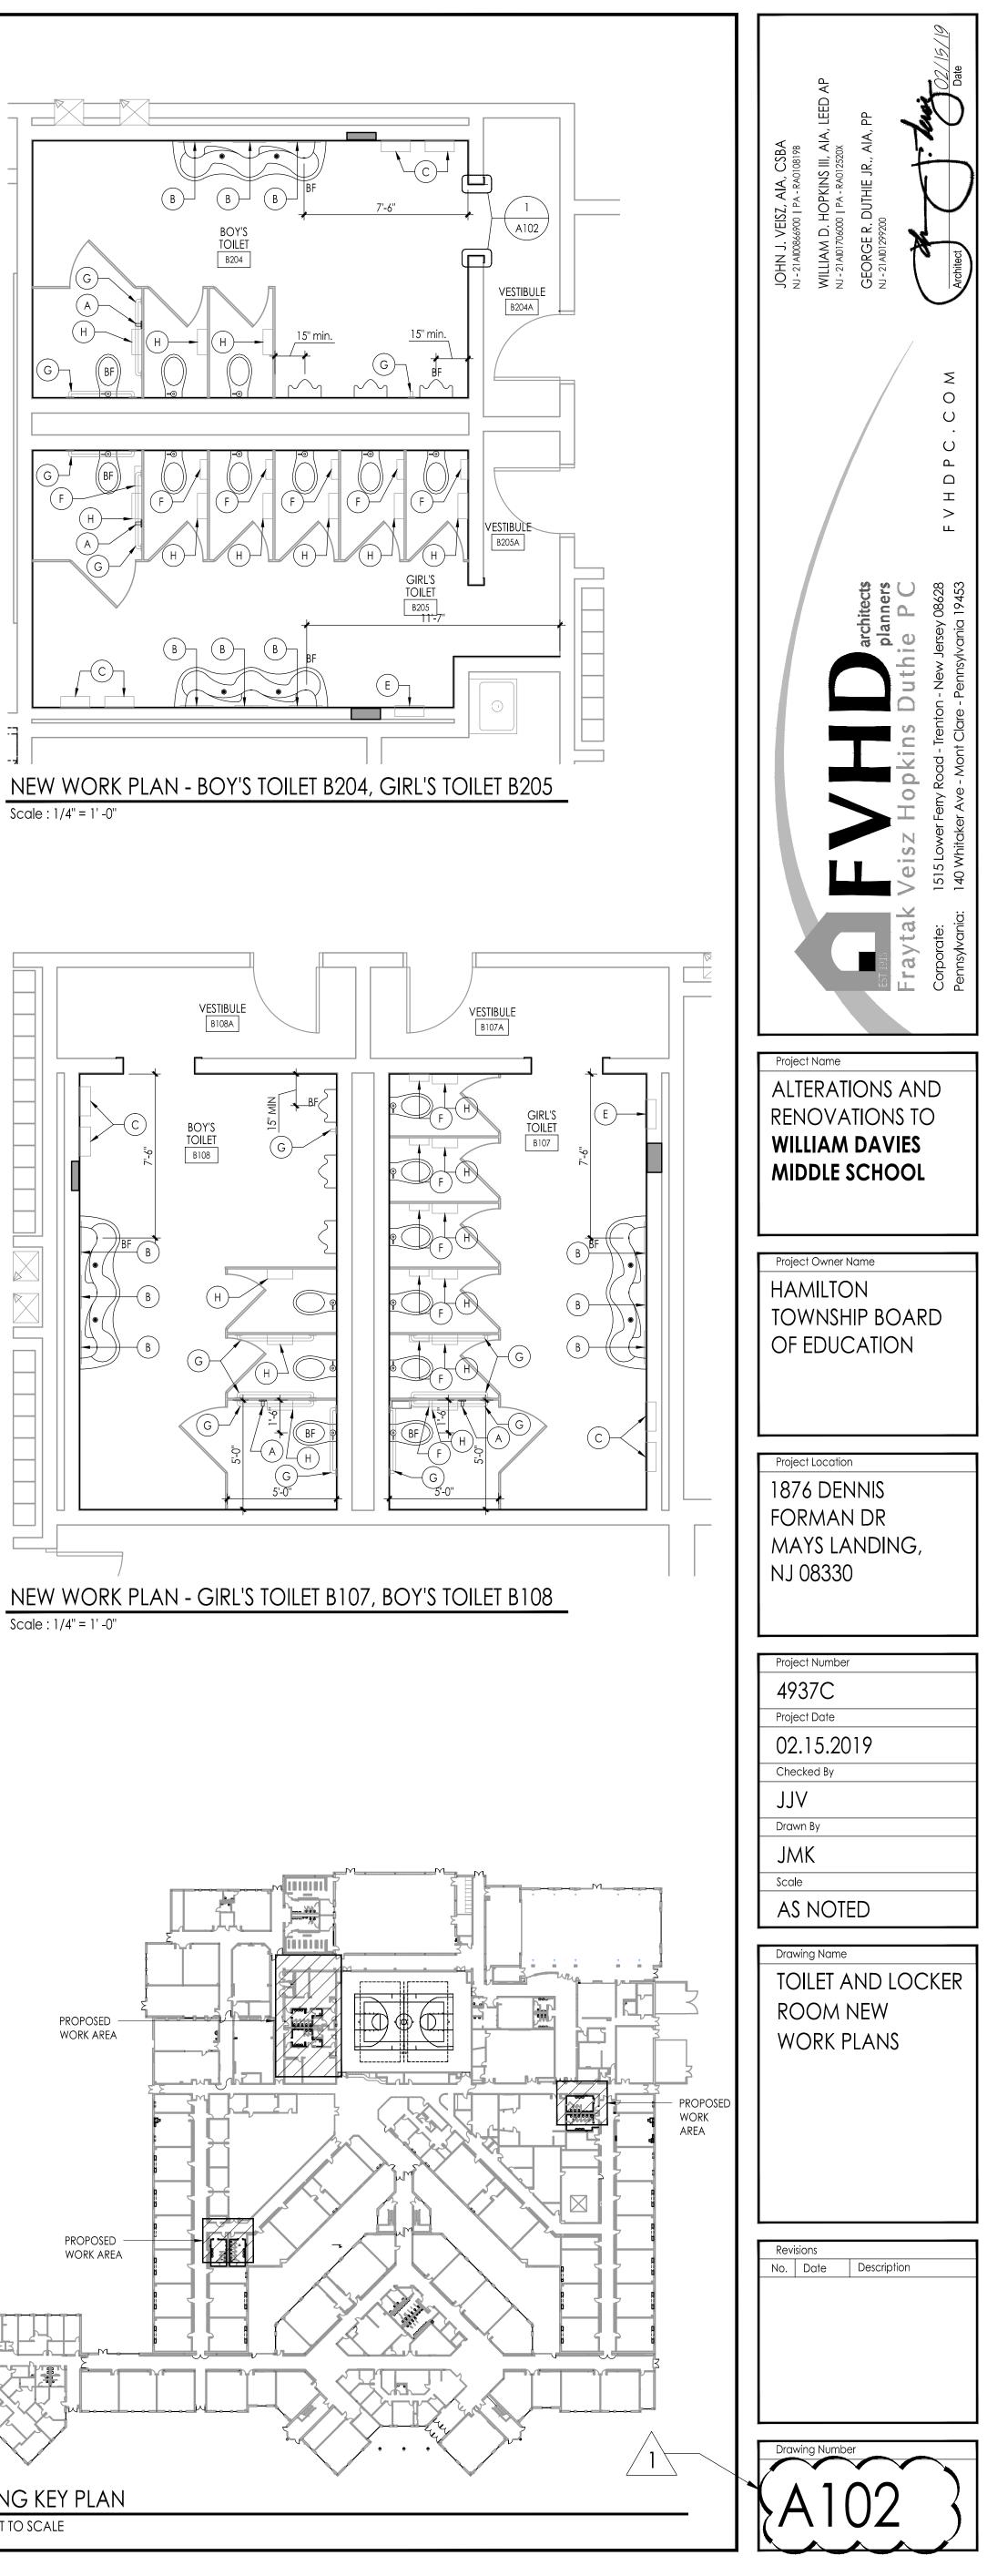
LEGEND		
MILESTONE NUM	BER (MN)	
CONSTRUCTION NO	OTES:	
PARKING AND LAWN AREAS FF C NEW FIELD AND IRRIGATION W D TEMPORARY DUMPSTER LOCA	TAGING, STORAGE, PARKING AND DUMPSTER AREA FROM ROM DAMAGE. VORK BY OTHER. TION WITH 6' HIGH FENCE AND VINYL SCREEN. SECURE PERI ON BASIN WORK BY OTHERS FROM 6/14/19 TO 8/30/19.	
		MN5A -
		D
		MN5A-6
		MN5A -

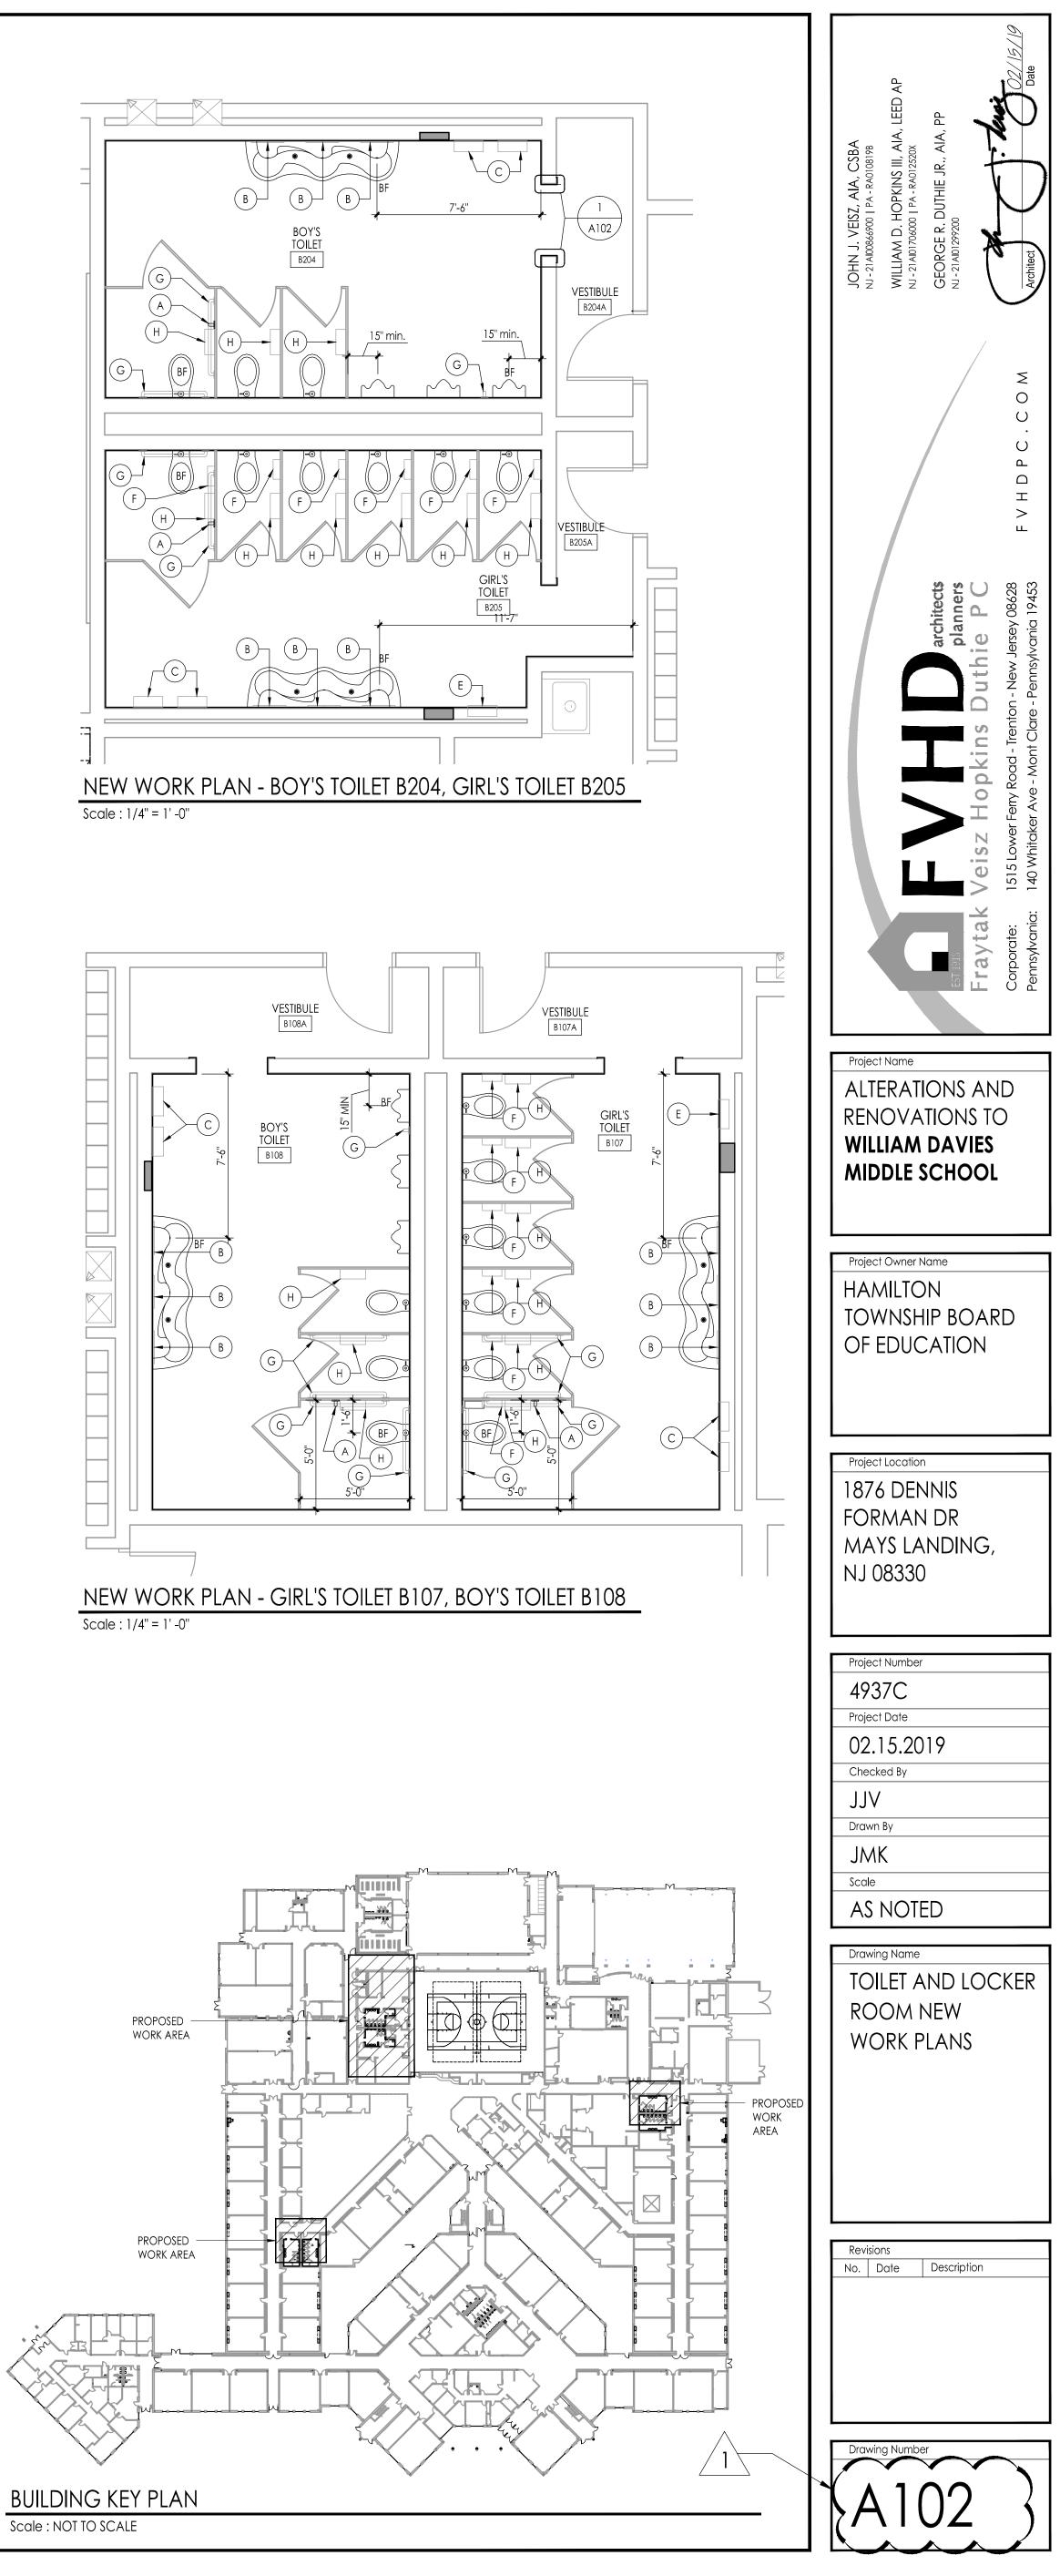


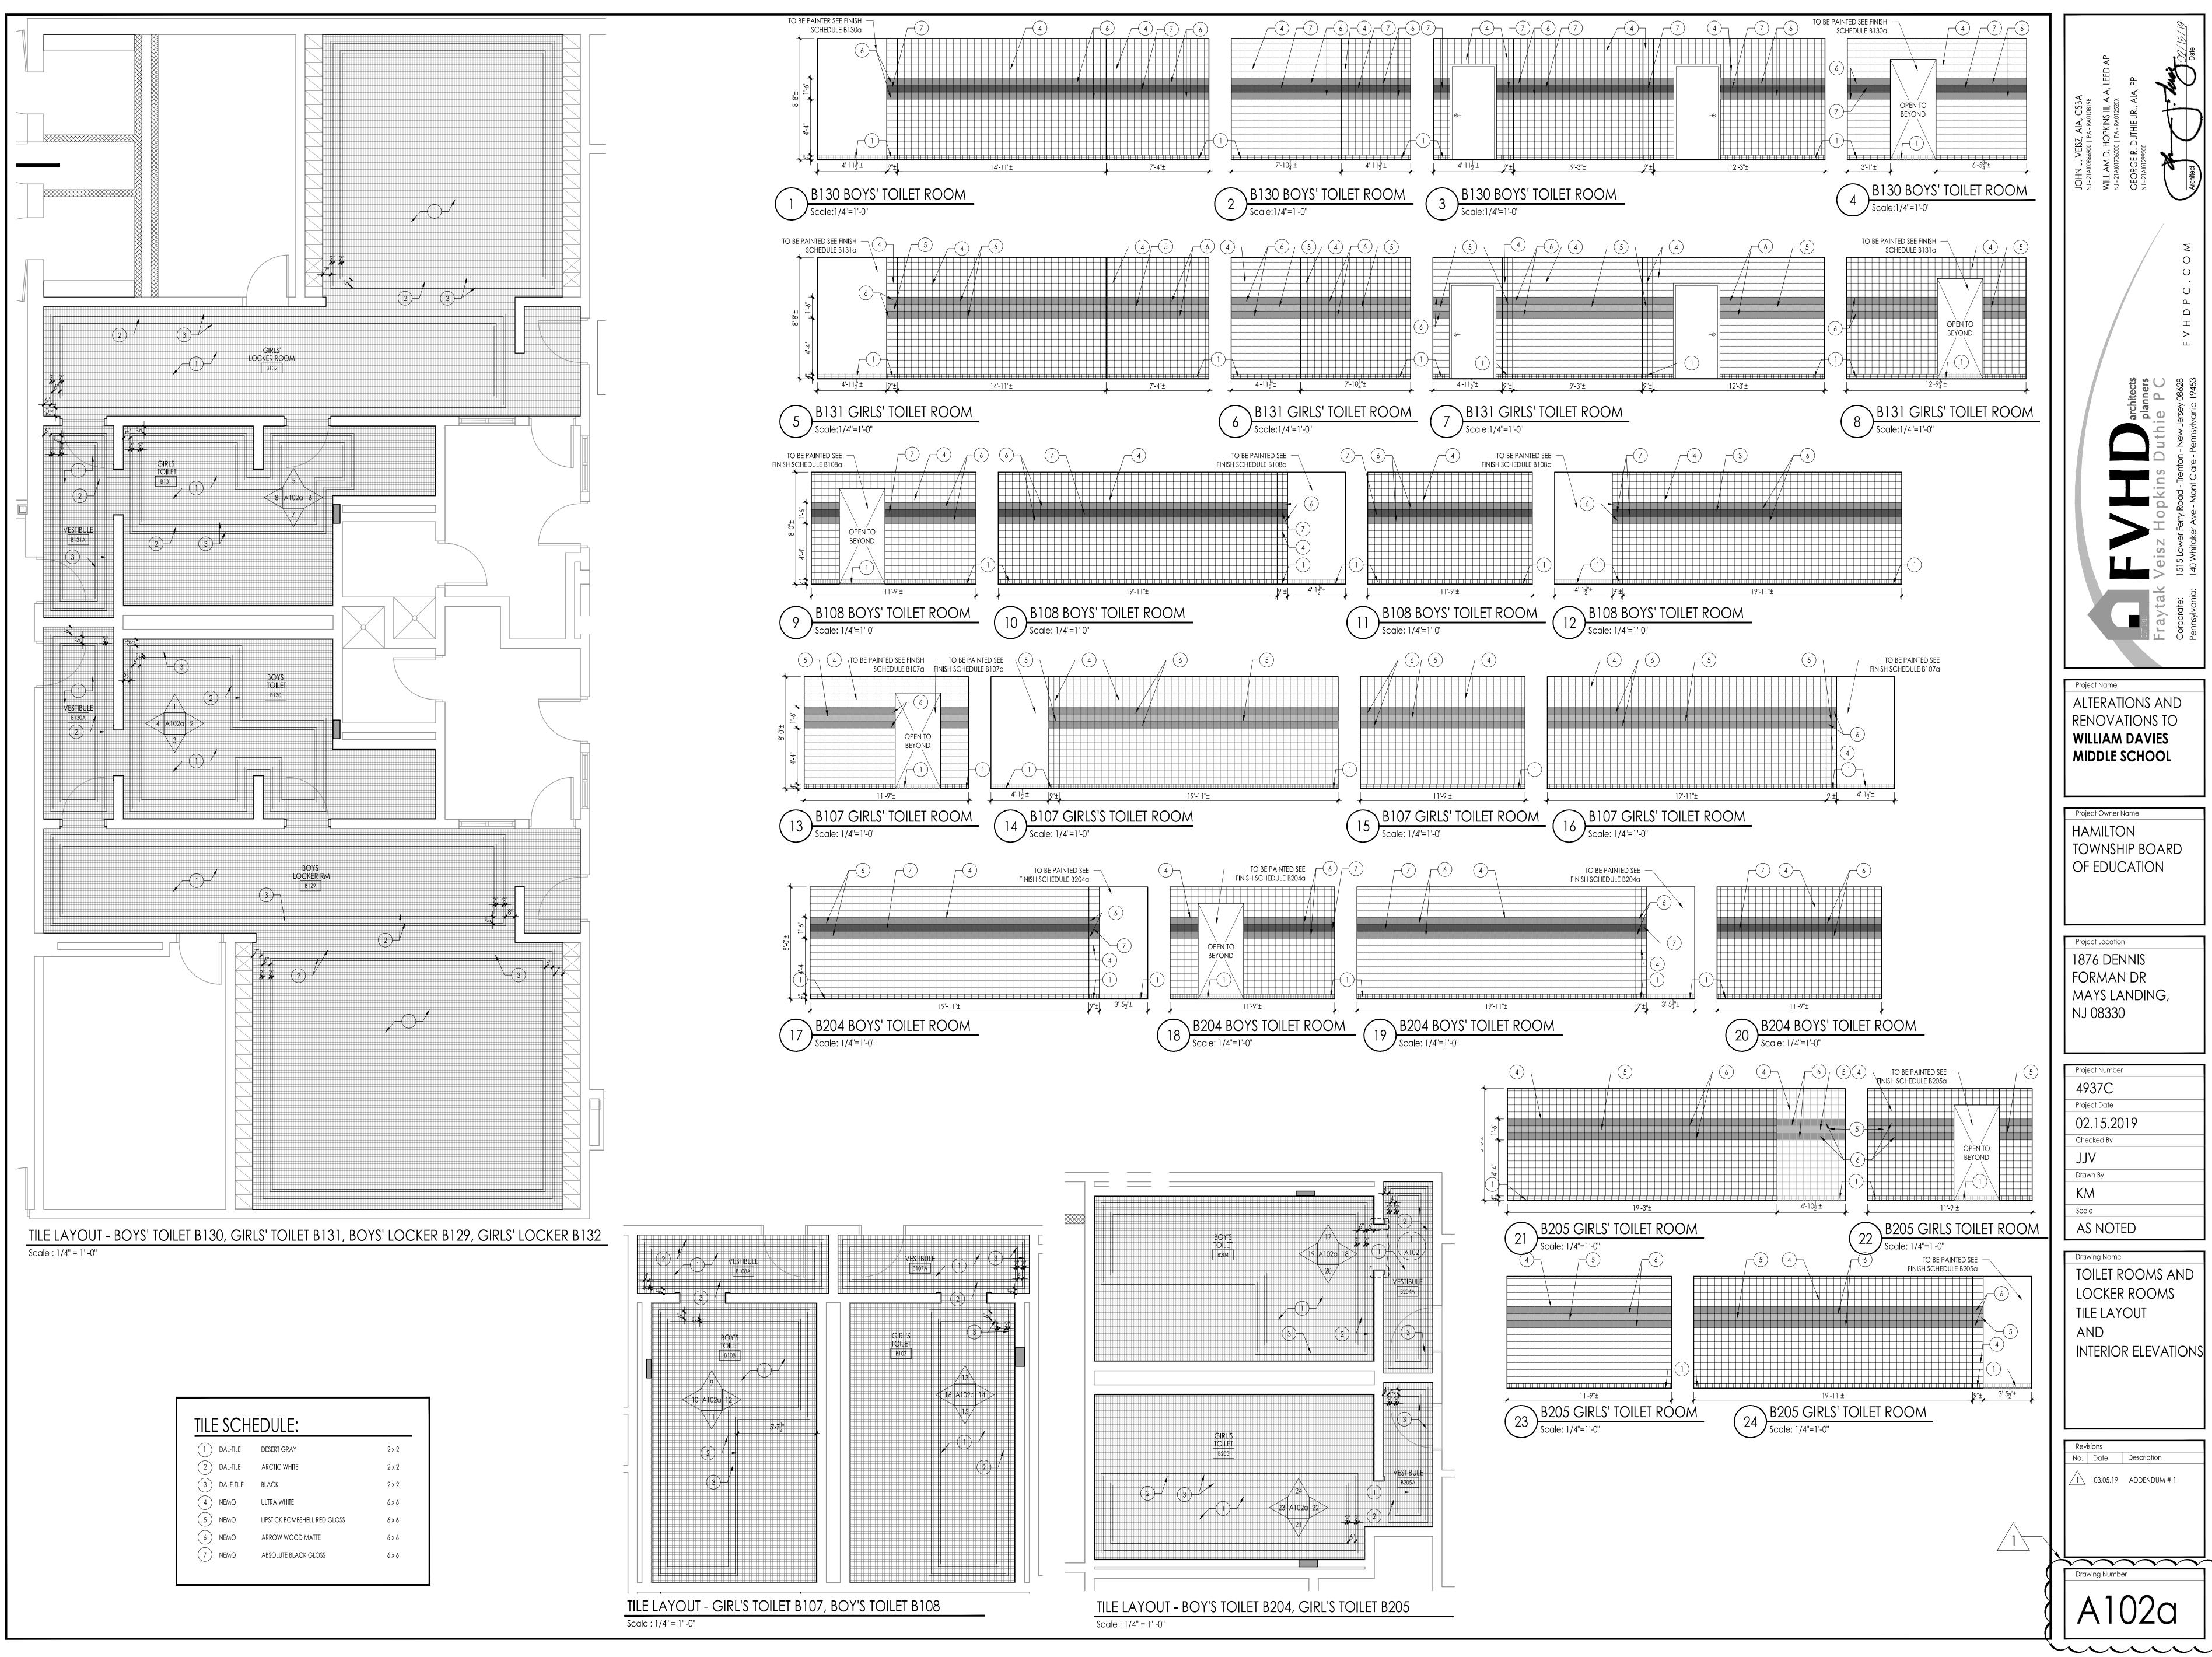


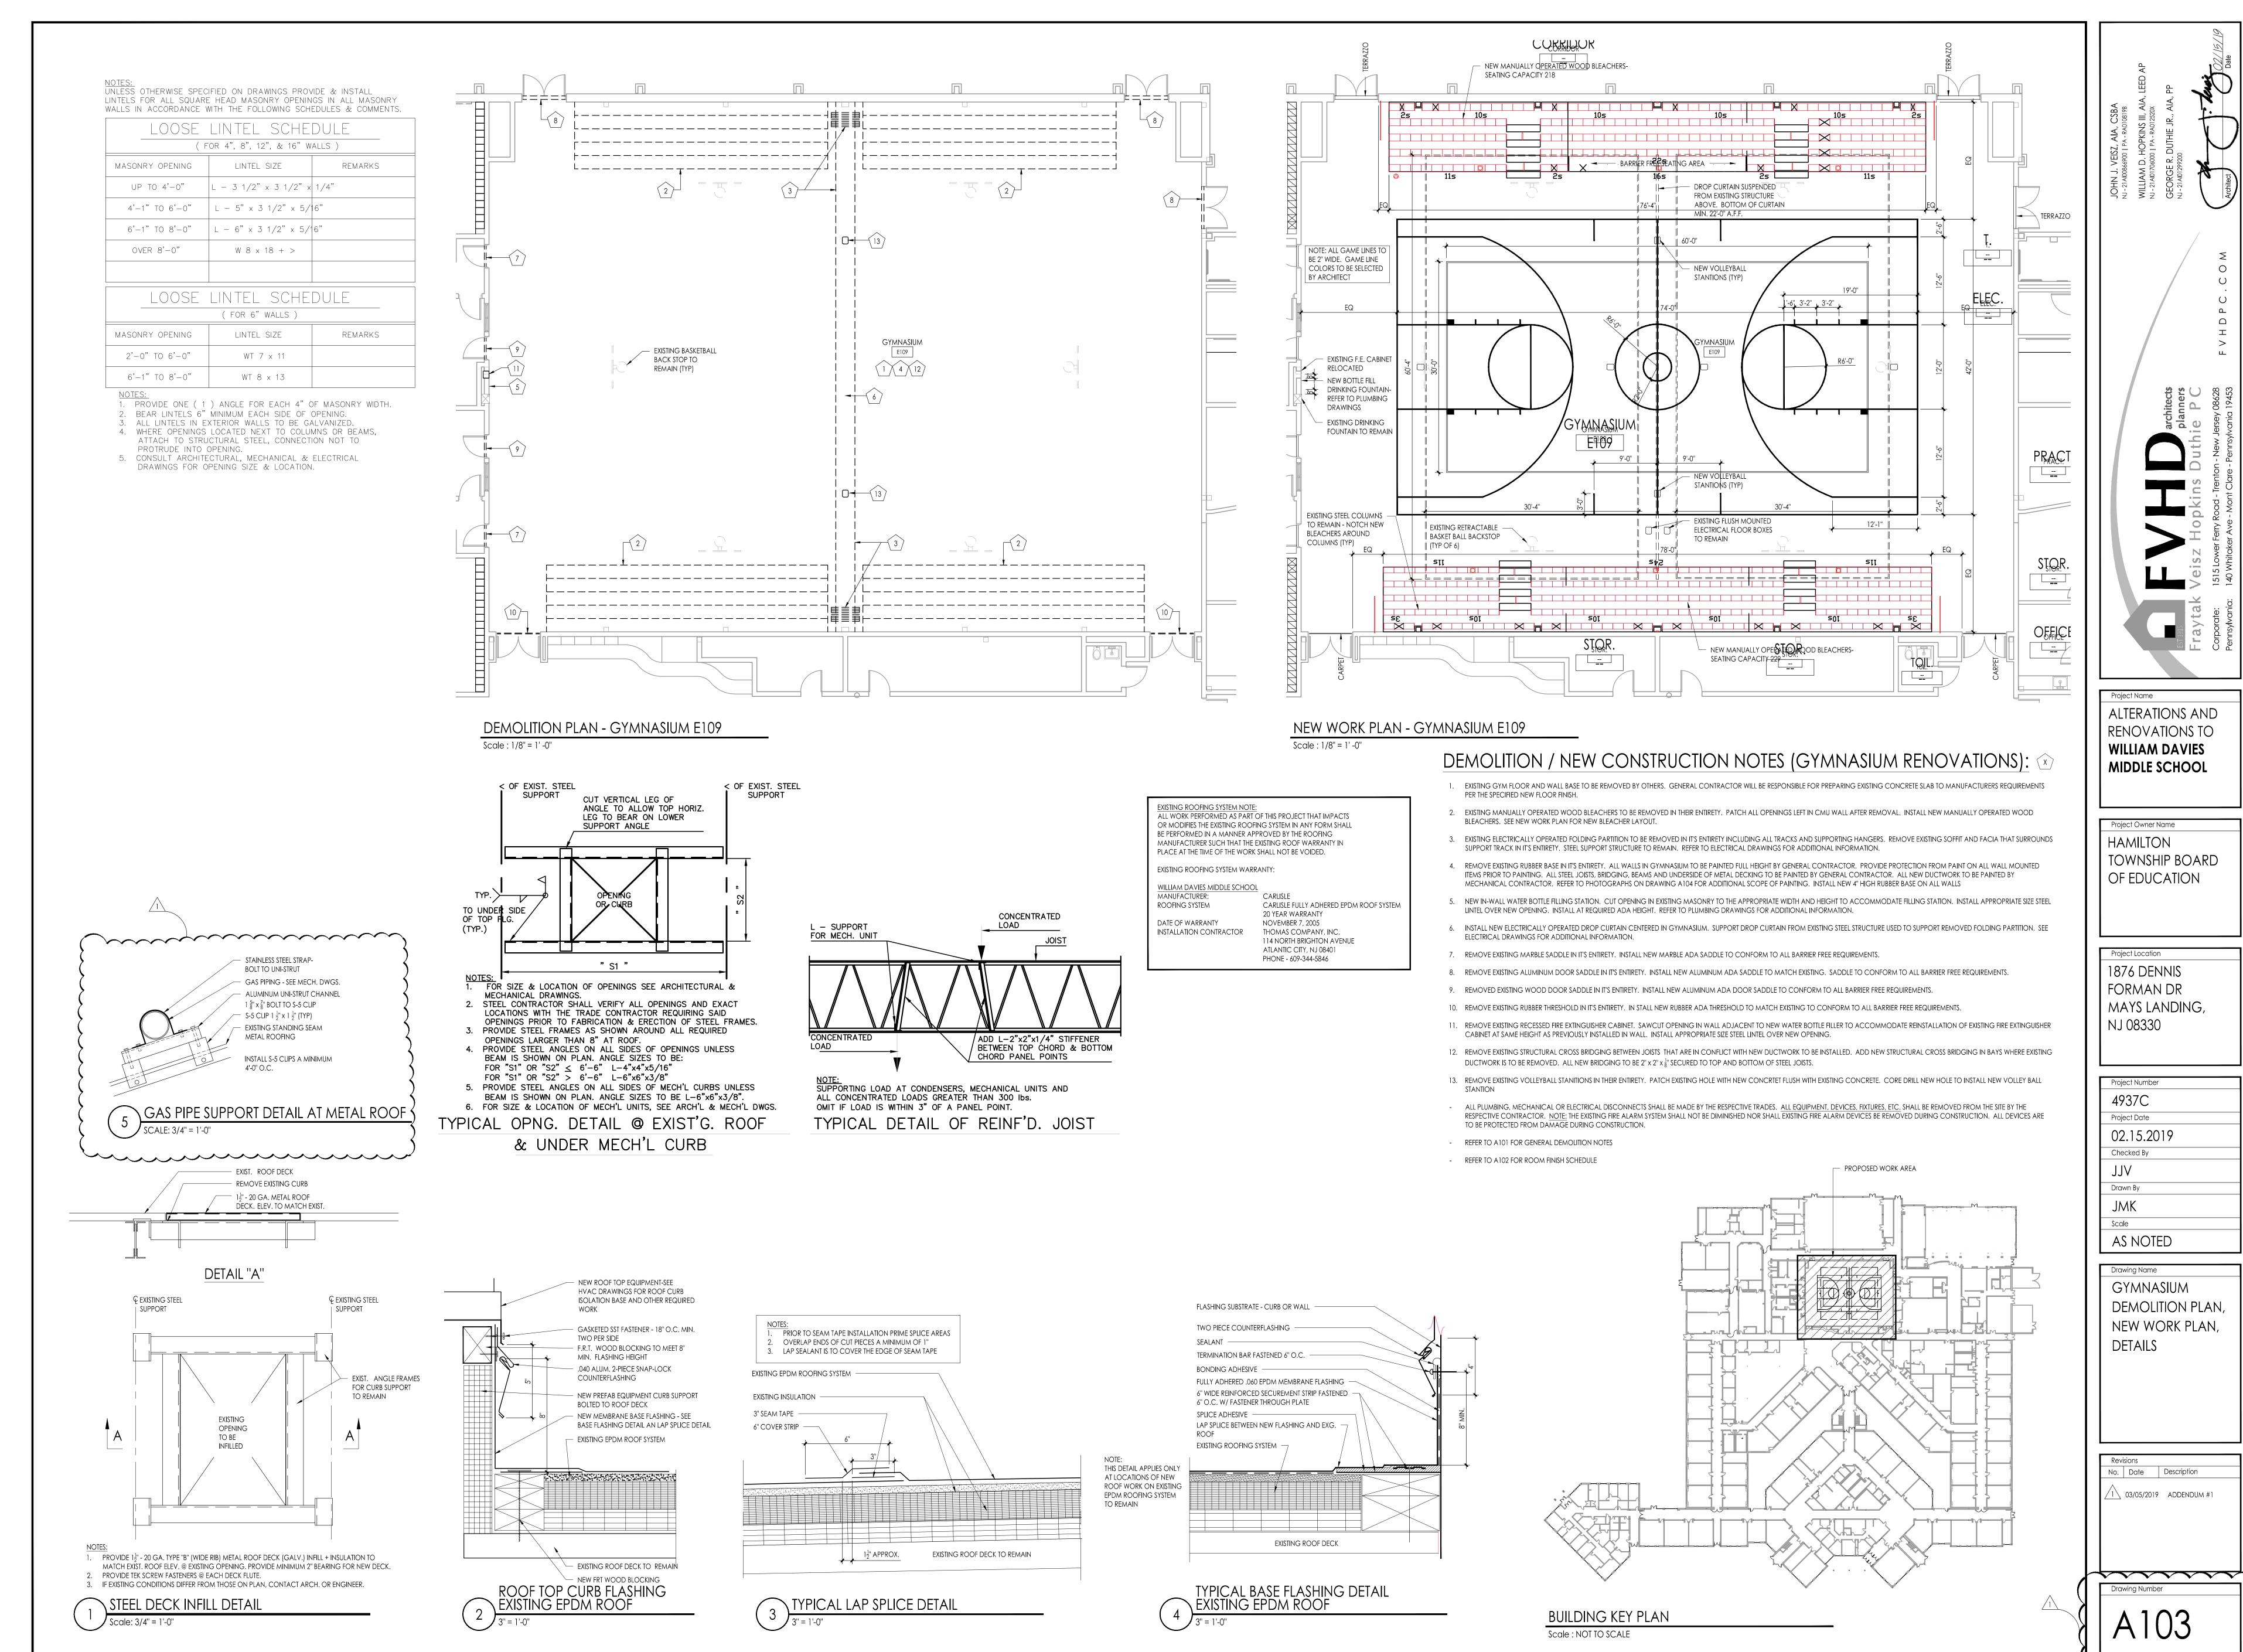
SO	RIES	X	
	SIZE		
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3''			SAFETY-GRIP FINISH, MOUNT VERTICAL
-			RE-USE EXISTING
			RE-USE EXISTING





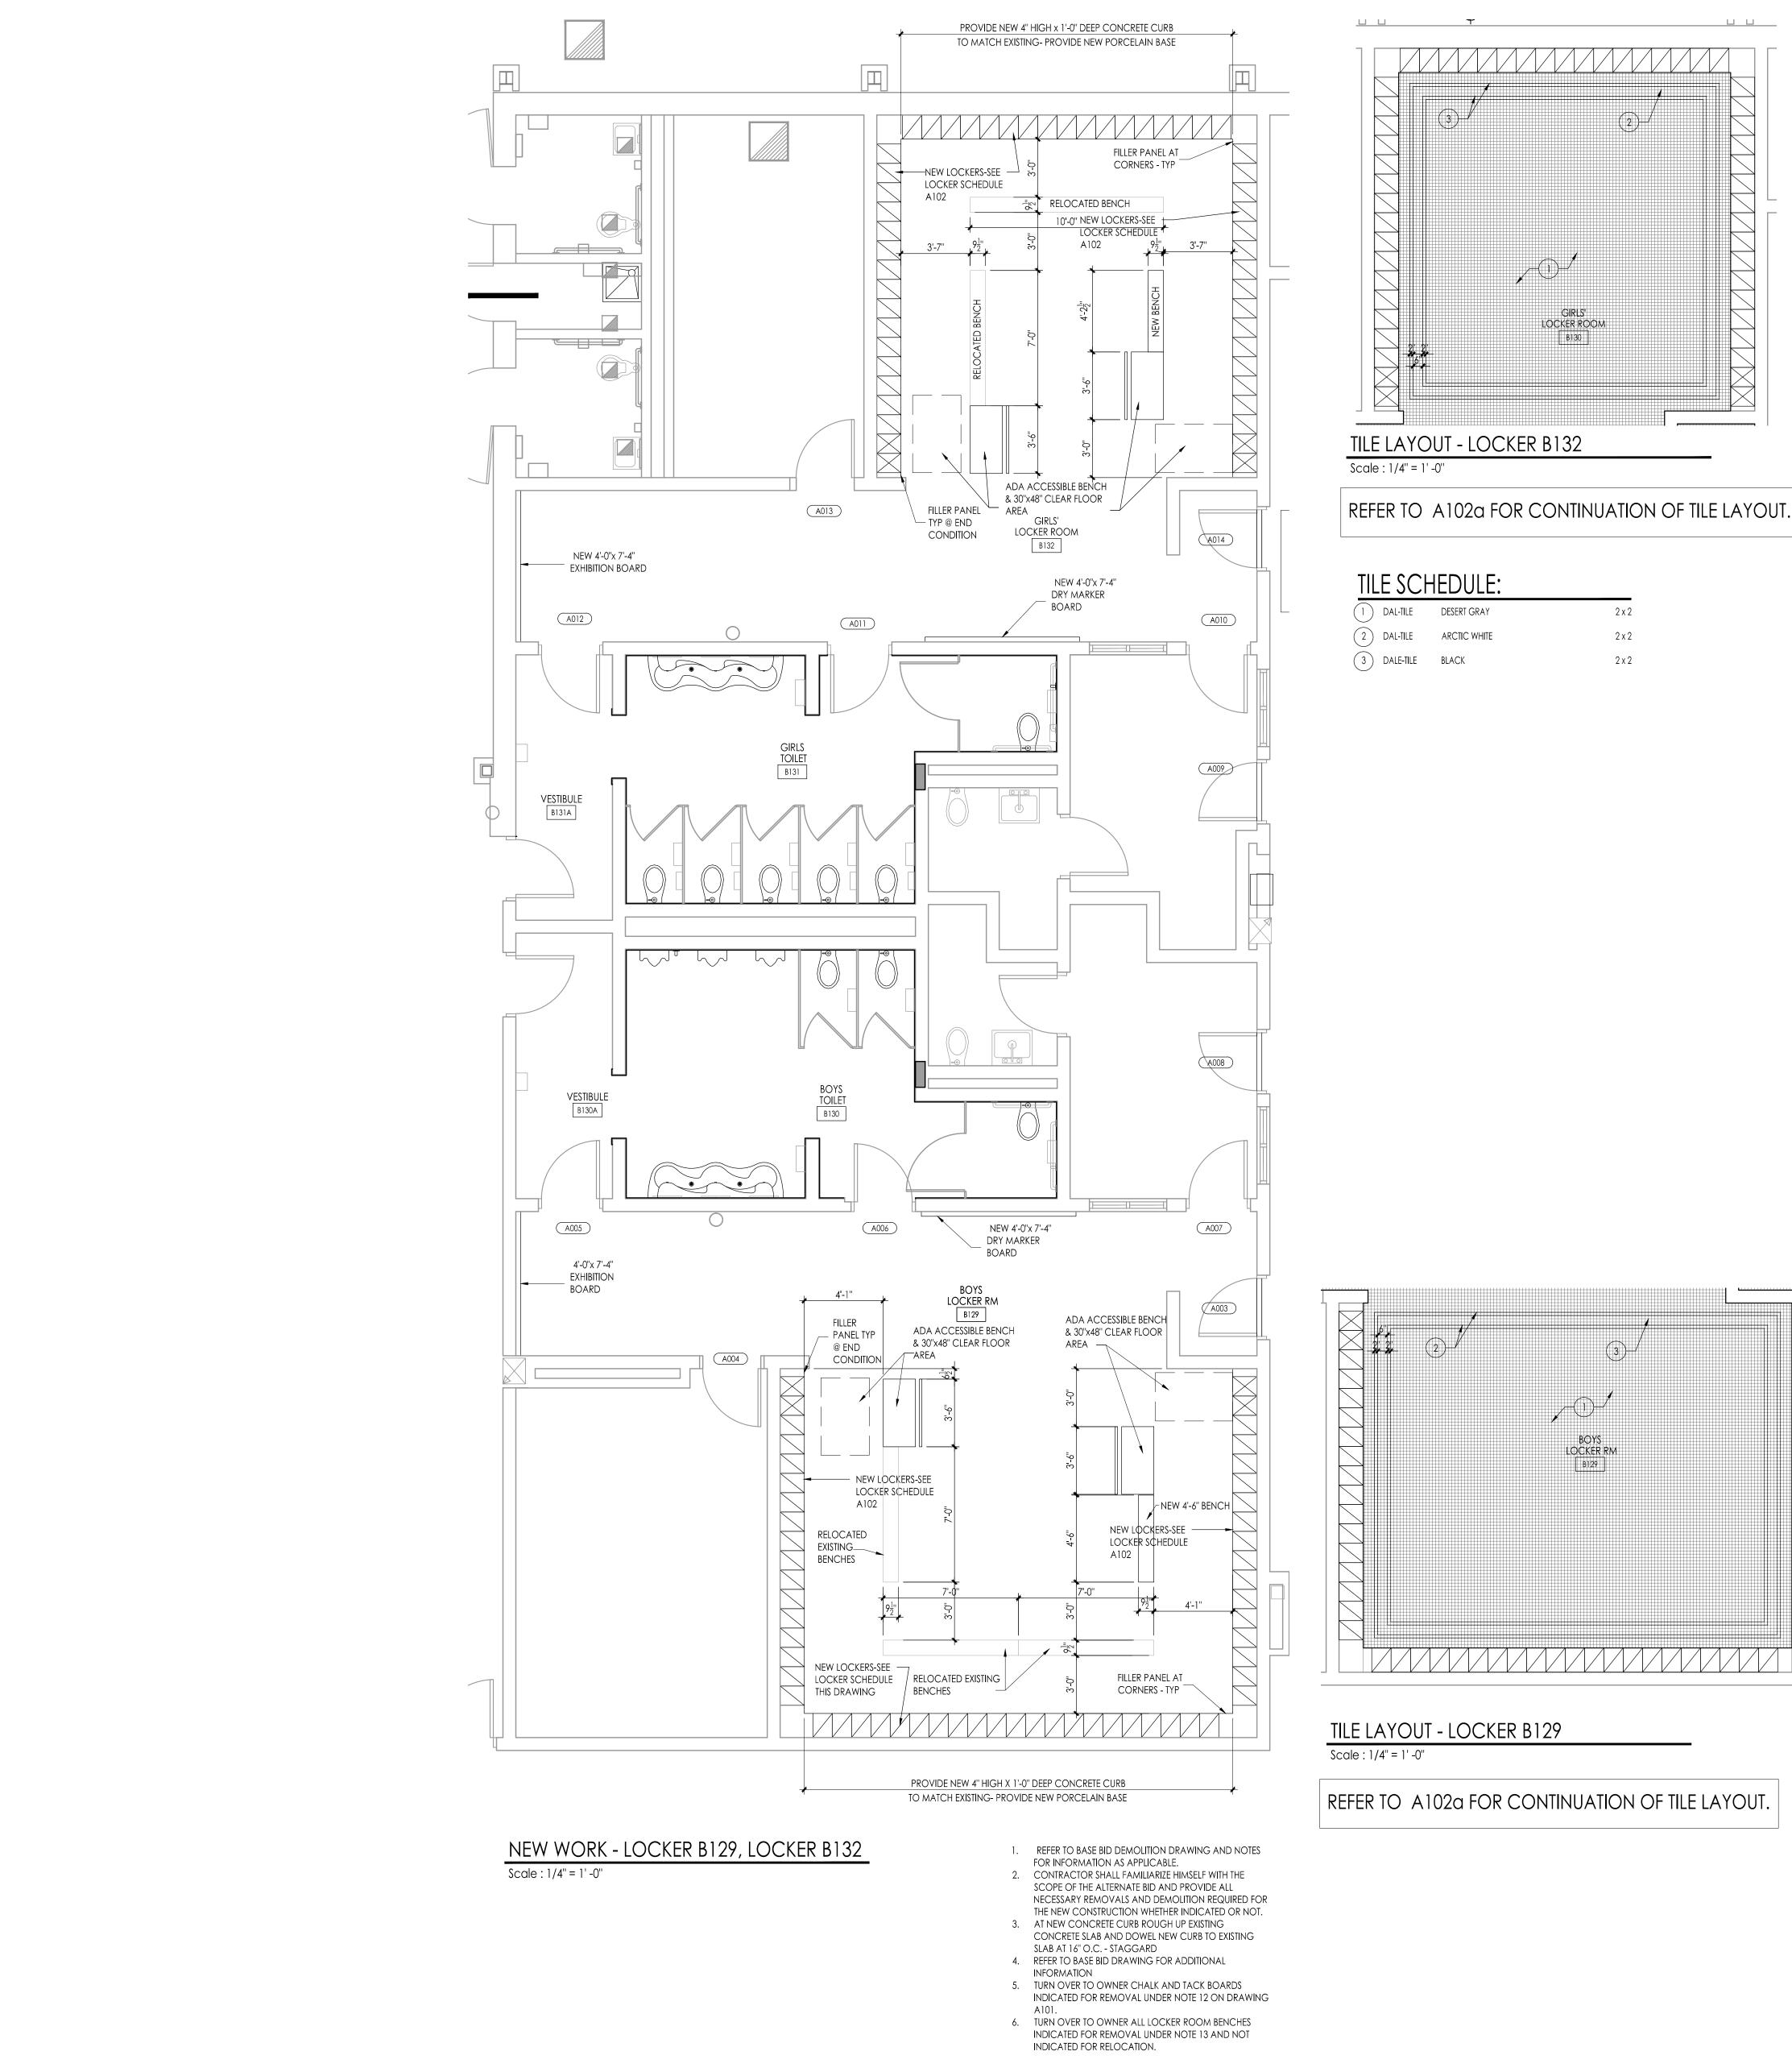


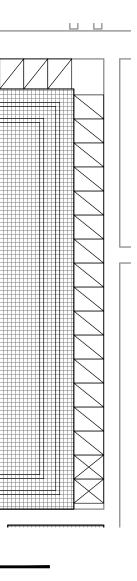


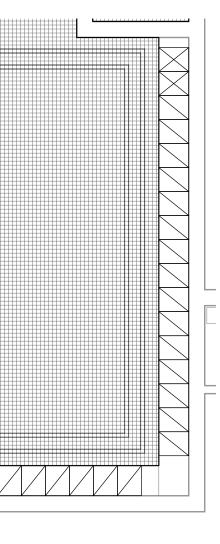


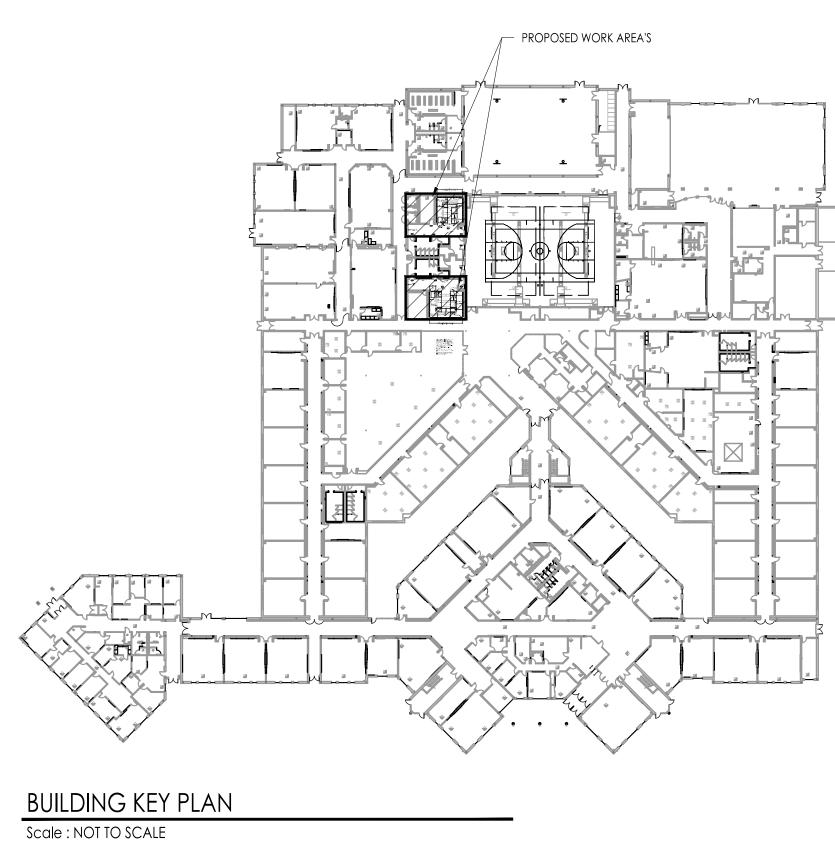
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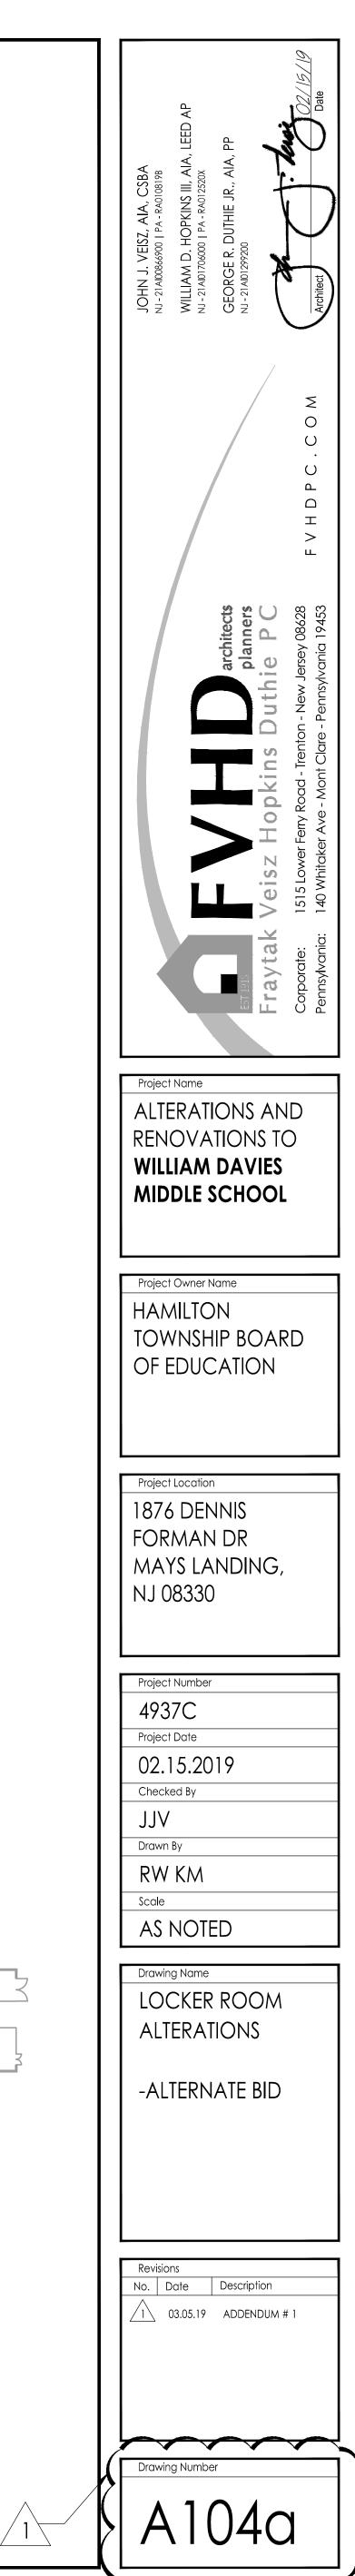
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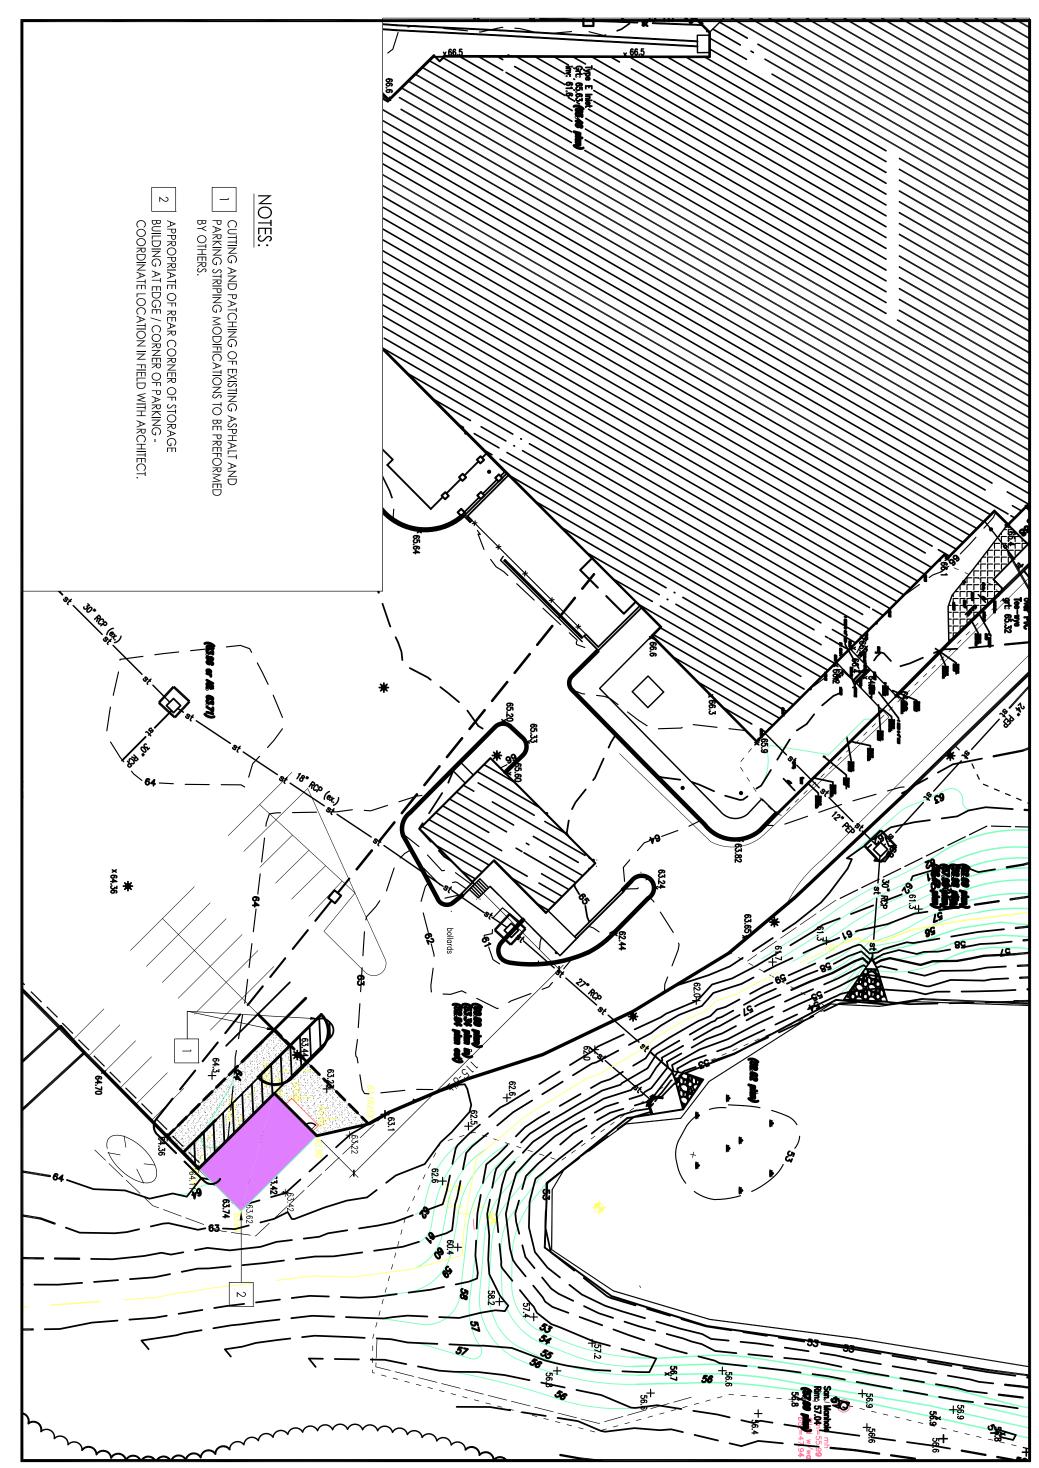














ADDENDUM NO. 1 (MEP portion)

(G&H ADDENDUM NO. 1)

to the

SPECIFICATIONS AND DRAWINGS

for the

ALTERATIONS AND RENOVATIONS TO JOSEPH C. SHANER MEMORIAL ELEMENTARY SCHOOL & ALTERATIONS AND RENOVATIONS TO WILLIAM DAVIES MIDDLE SCHOOL

for the

HAMILTON TOWNSHIP SCHOOL DISTRICT

Located at

JOSEPH C. SHANER MEMORIAL ELEMENTARY SCHOOL: 5801 3RD ST., MAYS LANDING, NJ 08330

DAVIES MIDDLE SCHOOL: 1876 DENNIS FORMAN DR., MAYS LANDING, NJ 08330



- 1. MEP Addendum No. 1 dated March 05, 2019, is issued as part of the Contract Documents, dated February 15, 2019, to inform and/or specify changes, which take precedence over information contained in the original Contract Documents. Unless otherwise specifically noted or specified hereinafter, or shown on drawings or schedules accompanying this Addendum, all work required by this Addendum shall conform to the applicable provisions of the Contract Documents. It shall be the responsibility of the Bidder to include in their bid any cost implications of this Addendum. All Bidders are to indicate on the form of proposal submitted by them, acknowledgment of receipt and compliance with the contents of this change to the Contract Documents.
- 2. Any provision in any of the Contract Documents which may be in conflict or be inconsistent with the contents of this Addendum shall be void to the extent of such conflict or inconsistency.

3. HVAC TRADE

3.1 CLARIFICATIONS:

- 3.1.1. Preconstruction water testing indicated on the Removal Drawings are required to include reports for system water flow in gallons per minute and pressure in feet of head.
- 3.1.2. Supply and return piping to the console style heat pumps are shown with one pipe for clarity purposes.

3.2 ERRATA IN THE SPECIFICATIONS

3.2.1. None.

3.3 ERRATA ON THE DRAWINGS (SHANER ES)

3.3.1. None.

3.4 ERRATA ON THE DRAWINGS (DAVIES MS)

3.4.1. None.

4. ELECTRICAL TRADE

4.1 ERRATA IN THE SPECIFICATIONS

4.1.1. None.

4.2 ERRATA ON THE DRAWINGS (SHANER ES)

- 4.2.1. Drawing E002:
 - 4.2.1.1. Add a 480/277V, three-phase, four-wire, 200 amp rated, 10kAIC, 30 pole, main-lugs-only panelboard "ESHA" to be located in the Basement Boiler Room (Basement Boiler Room shown on Detail 2/E003 where "Boiler Room Panel "MDP" is located). Coordinate with the Owner's Representative and existing field conditions for the exact location of the panel. Provide ten 20-amp single pole circuit breakers in "ESHA" and

spaces in the remaining 20 poles. Refer to Sketch AD1-E01 for additional requirements.

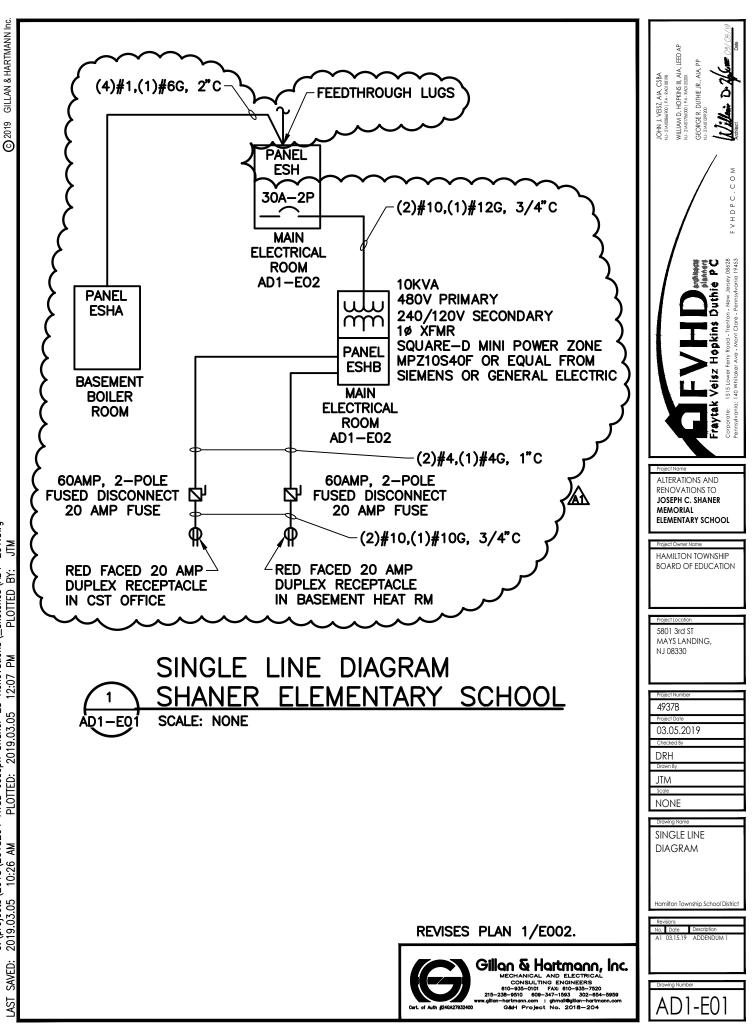
- 4.2.1.2. Add a (4)#1,(1)#6G, 2" Conduit electrical feeder connected to the feedthrough lugs in Panel "ESH" as required in this Addendum. Extend the feeder to the additional panel "ESHA" described in this Addendum. Extend the feeder through the building from the Main Electric Room and through concealed locations above the Corridor dropped ceilings to the 1950 Electrical Room (1950 Electrical Room is the Room where new panels "B" and "C" are shown on Detail 1/E003), and down through the floor (provide all required floor penetrations and fire rated sealing) into the Basement Level, and extend into the Boiler Room. Provide all required fire sealing to fire rated walls and floors.
- 4.2.1.3. Add a 10kVA rated, 480V primary and 120/240V secondary Mini Power Zone Transformer and Panel Substation "ESHB" (Basis of design is a Square-D catalog number MPZ10S40F or equal from Siemens or General Electric that is 12" Wide and 12" Deep to fit the location indicated on Sketch AD1-E02).
- 4.2.2. Drawing E003:
 - 4.2.2.1. Add the requirement for a 120-volt power supply and branch circuit for the Security Vestibule Exit Doors (Located adjacent to the Main Office; refer to the Architectural Drawings). This 20 amp branch circuit shall extend from Panel "ESHB" as indicated on Sketch AD1-E03.
 - 4.2.2.2. Add a requirement for a 20 amp red faced quadraplex receptacle located in the CST Office adjacent to the Data Rack in that Room (CST office is located across from the First Grade Classroom 121) and fed from Panel "ESHB" circuit #2 and fused disconnect as indicated on Sketches AD1-E03 and AD1-E01. Coordinate final receptacle location with the District.
 - 4.2.2.3. Add a requirement for a 20 amp red faced quadraplex receptacle located in the Tech Office adjacent to the Data Rack in that Room (Tech Office is the room where Transfer Switch "TS1" is located) and fed from Panel "ESHB" circuit #3 as indicated on Sketch AD1-E03. Coordinate final receptacle location with the District.
 - 4.2.2.4. Add a requirement for a 20 amp red faced quadraplex receptacle located in the Basement Heater Room adjacent to the Data Rack in that Room. (Basement Heater Room is shown on Detail 2/E003 at the plan upper left corner) and fed from Panel "ESHB" circuit #4 and fused disconnect as indicated on Sketches AD1-E01 and AD1-E03. Coordinate final receptacle location with the District.
 - 4.2.2.5. Add a requirement for a 20 amp branch circuit to the new Main Fire Alarm Control Panel in the Main Electric Room and fed from Panel "ESHB" circuit #5 as indicated on Sketch AD1-E03.
- 4.2.3. Drawing E600:
 - 4.2.3.1. Delete the requirement to feed the Main Fire Alarm Control Panel from ELSH circuit #2.
 - 4.2.3.2. Add the requirement for feed-through lugs to the Panel Schedule "ESH" to feed panel "ESHA." Refer to Sketches AD1-E01 and AD1-E03 for additional requirements.

- 4.2.3.3. Add the panel schedule for "ESHB" to this drawing as indicated on Sketch AD1-E03.
- 4.2.3.4. Add a 30 amp, 480V, 2-pole circuit breaker in Panel "ESH" to feed the substation. Refer to Sketch AD1-E01 for additional requirements.

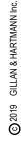
4.3 ERRATA ON THE DRAWINGS (DAVIES MS)

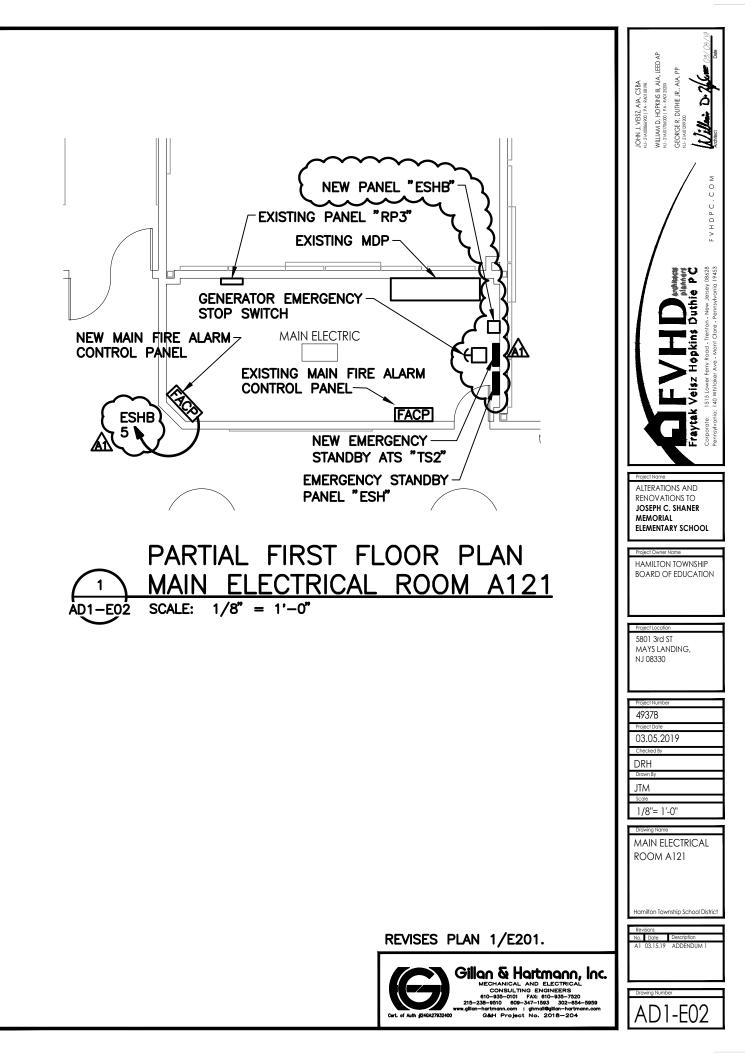
4.3.1. None.

END OF ADDENDUM 1



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Ctristed at C	RENOVATIONS TO JOSEPH C. SHANER MEMORIAL ELEMENTARY SCHOOL Project Owner Name HAMILTON TOWNSHIP BOARD OF EDUCATION
L- SHANER ELEMENTARY LOAD SERVED ON GRD WIRE LOAD SERVED ON GRD NIRE LOAD SERVED A4" #12 #12 2 1.0 SPARE 34" #12 #12 2 1.0 ORKROOM A.(1)#4G in 1"C to a wall mounted 2-pole, 60 amp fused discont on the load side, and wire to receptate indicated.	S801 3rd ST MAYS LANDING, NJ 08330 Project Number 4937B Project Date 03.05.2019 Checked By DRH Drawn By JTM Scole NONE Drawing Name PANEL SCHEDULE Hamilton Township School District Revisions No Date Description
REVISES DRAWING E600.	