

REFLECTED CEILING PLAN

Scale: 1/8" = 1'-0"

PENDANT LIGHT

REFLECTED CEILING PLAN - DEMOLITION

ALL CEILING MOUNTED DEVICES TO REMAIN UNLESS NOTED

REFER TO ARCHITECTURAL RCP / HVAC / ELECTRICAL / PLUMBING

DRAWINGS FOR RELOCATION AND/OR NEW DEVICE(S) LOCATIONS

- 1. SEE HVAC AND ELECTRICAL DRAWINGS FOR TYPE, SIZE AND ADDITIONAL INFORMATION ON CEILING MOUNTED DEVICES.
- 2. ALL NEW DIFFUSERS AND LIGHTS TO BE CENTERED IN THE PANEL UNLESS NOTED OTHERWISE.

3. GENERAL, HVAC AND ELECTRICAL CONTRACTORS / SUBCONTRACTORS TO COORDINATE LOCATION OF DIFFUSERS / LIGHTS AND DEVICES.

REFLECTED CEILING NOTES

FIXTURES

EXISTING RECESSED DOWNLIGHT FIXTURE


REFLECTED CEILING PLAN LEGEND

EXISTING ACOUSTICAL CEILING BOARD TO REMAIN EXISTING CAMERA (C) NEW CAMERA EXISTING DETECTOR NEW DETECTOR EXISTING SPEAKER (SP) NEW SPEAKER EXISTING SPRINKLER NEW SPRINKLER EXISTING EXIT SIGN NEW EXIT SIGN EXISTING MOTION SENSOR (MS) NEW MOTION SENSOR (WF) NEW WIFI HUB 2'x2' EXISTING CEILING - MOUNTED **FIXTURES**

DOWNLIGHT FIXTURE RETURN / EXHAUST DIFFUSER new Supply diffuser

ACB #1 -2' X 4' ACOUSTICAL CEILING BOARD -

SEE FINISH SCHEDULE FOR LOCATION & TYPE

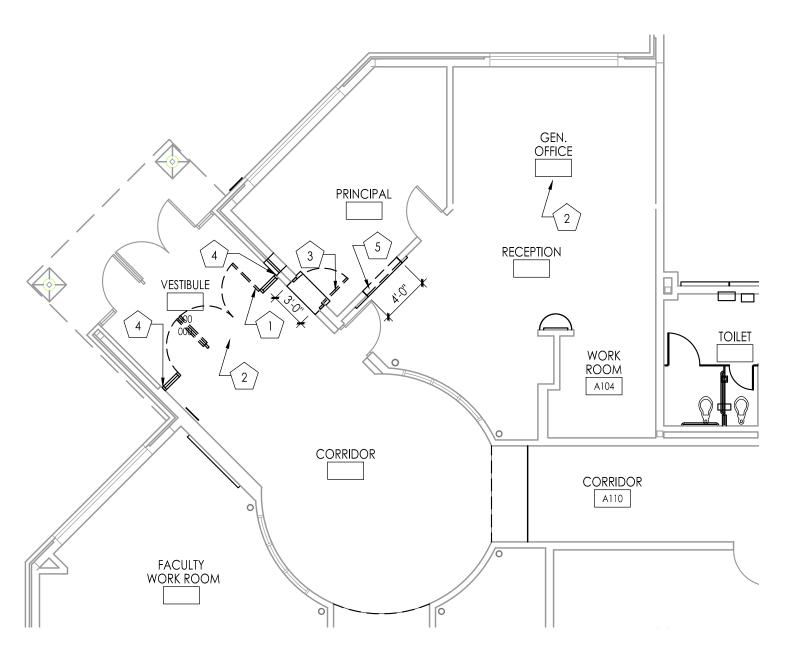

DEMOLITION PLAN

DEMOLITION CONSTRUCTION NOTES

THE OWNER HAS THE RIGHT OF FIRST REFUSAL FOR ALL EQUIPMENT AND FIXTURES (CABINETS, SHELVING, PLUMBING FIXTURES, ETC.) REMOVED UNDER CONTRACT. IF THE OWNER DOES NOT EXERCISE THIS RIGHT FOR AN INDIVIDUAL PIECE OF EQUIPMENT, THE CONTRACTOR SHALL REMOVE SAID EQUIPMENT FROM THE SITE.

IN ALL LOCATIONS OF RENOVATION / CONSTRUCTION, CONTRACTOR SHALL PROTECT ALL ITEMS (INCLUDING MURALS) FROM CONSTRUCTION DUST AND DEBRIS AS WELL AS DAMAGE. ALL ITEMS DAMAGED BY THE RENOVATION SHALL BE REPLACED BY THE CONTRACTOR AT NO ADDITIONAL COST TO THE OWNER.

IN ALL LOCATIONS OF RENOVATION / CONSTRUCTION CAREFULLY REMOVE EXISTING PLAQUES / EXHIBITION BOARDS / PICTURES AND TURN OVER TO OWNER. PATCH AND REPAIR ALL DAMAGE FROM REMOVAL TO MATCH EXISTING WALL AND FINISHES & RESTORE TO SMOOTH, FLUSH SURFACE.

WHERE APPLICABLE BRACE AND SHORE UP ANY EXISTING CONSTRUCTION TO REMAIN. REMOVE EXISTING CONSTRUCTION TO LIMITS OF WORK DESCRIBED BY ARCHITECTURAL PLANS & ASSOCIATED HVAC / ELECTRICAL / PLUMBING PLANS. PREPARE FOR POSITIVE CONNECTION OF ALL NEW CONSTRUCTION TO EXISTING CONDITIONS.

- REMOVE EXISTING INDICATED STOREFRONT DOORS & FRAMES, SIDELIGHTS, TRANSOMS, SADDLES & HARDWARE (CLOSERS, STOPS, BUMPERS ETC.) IN THEIR ENTIRETY. CONTRACTORS SHALL TAKE ALL NECESSARY STEPS TO ENSURE BUILDING SECURITY. CONTRACTOR IS TO PROTECT ALL FINISHES ADJACENT TO DEMOLITION WORK. PATCH AND REPAIR ALL DAMAGE CAUSED BY DEMOLITION TO MATCH EXISTING ADJACENT FINISHES, INCLUDING TERRAZZO, BRICK, TILE, BASE, PAINT ETC.
- AT INDICATED AREA, REMOVE AND STORE EXISTING CEILING PANELS, SUSPENSION GRID AND APPLIANCES TO ACCOMMODATE RENOVATION. AFTER RENOVATION IS COMPLETE, MODIFY EXISTING SUSPENSION GRID TO FIT NEW LENGTHS. RE-INSTALL (WITH NEW HANGAR WIRE TO EXISTING STRUCTURE) ALL PANELS, GRID AND APPLIANCES IN DESIGNATED SEE REFLECTED CEILING PLAN AND/OR PLUMBING / HVAC / ELECTRICAL DRAWINGS. REPLACE ALL DAMAGED OR DETERIORATED CEILING PANELS AND SUSPENSION GRID WITH NEW TO MATCH EXISTING. SEE PLUMBING / HVAC / ELECTRICAL DRAWINGS FOR ADDITIONAL WORK REQUIRED. ALL PLUMBING HVAC / ELECTRICAL WORK, INCLUDING DEMOLITION, PATCHING AND REPAIR, BY RESPECTIVE
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 ight)$ remove existing door and frame assembly in it's entirety existing lintels to remain. INFILL OPENING TO EXTENT SHOWN IN DETAIL AND AS REQUIRED FOR NEW INSTALLATIONS AND
- (4) AT LOCATIONS WHERE NEW DOOR FRAME MEETS EXISTING WALL OR FLOOR, CAREFULLY AND NEATLY REMOVE THE EXISTING WALL BASE AND FLOOR FINISH TO ALLOW FOR POSITIVE CONNECTION OF DOOR FRAME CONSTRUCTION DIRECTLY TO THE EXISTING FLOOR AND WALL SUBSTRATES (TILE / TERRAZZO / CONCRETE / BRICK / CMU / ETC.). CLEAN AND PREPARE EXPOSED EXISTING CONSTRUCTION CAUSED BY RENOVATION TO MATCH EXISTING ADJACENT FINISH. FINISH ALL NEWLY EXPOSED SURFACES TO MATCH EXISTING ADJACENT CONDITIONS.
- BRACE AND SHORE UP EXISTING ADJACENT WALL CONSTRUCTION TO REMAIN. SAWCUT AND REMOVE EXISTING WALL TO WIDTH INDICATED ON DEMOLITION PLAN AND TO HEIGHT INDICATED ON ELEVATIONS ABOVE EXISTING FLOOR. SEE FLOOR PLAN. PATCH AND REPAIR ALL DAMAGE CAUSED BY REMOVAL TO MATCH EXG. ADJACENT FINISH. INFILL OPENING WITH NEW FRAME, MASONRY CONSTRUCTION AND LINTEL OF THICKNESS TO MATCH EXISTING WALL.

KEY PLAN

JOSEPH C. SHANER ELEMENTARY SCHOOL ROOM FINISH SCHEDULE BASE WAINSCOT WALL FINISH ROOM NAME FLOOR REMARKS

GENERAL FINISH NOTES ROOM FINISH SCHEDULE NOTES ROOM FINISH ABBREVIATIONS

n/a

A. SEE SPECIFICATIONS FOR ADDITIONAL INFORMATION ON MATERIALS / MANUFACTURER /

ETR

ETR / RUB

ETR / RUB

PERFORMANCE AND WARRANTY INFORMATION. B. WITHIN THE EXISTING BUILDINGS, AT ALL AREAS OF NEW CONSTRUCTION ADJACENT TO EXISTING, NEW CONSTRUCTION SHALL BE FINISHED TO MATCH EXISTING ADJACENT

SECURE VESTIBULE

PRINCIPAL'S OFFICE

SCHEDULE BUT ARE STILL REQUIRED IN THE ROOM.

CONSTRUCTION NOTES:

NEW JOINT COVER

1. AT LOCATION OF ALUMINUM FRAME REMOVAL CLEAN PATCH AND REPAIR ANY AREAS OF DAMAGED MASONRY TO MATCH

2. ELECTRICAL CONTRACTOR TO PROVIDE (2) JUNCTION BOXES

ABOVE CEILING AT RELOCATED FRAME.

EXISTING. PREPARE MASONRY JOINT AS REQUIRED TO RECEIVE

CONSTRUCTION, INCLUDING BRICK, TILE, PLASTER, BASE, ETC. C. AT ALL AREAS OF EXISTING SURFACES BEING PAINTED, THE GENERAL CONSTRUCTION WORK CONTRACTOR SHALL REMOVE PRIOR TO PAINTING AND RE-INSTALL AFTER PAINTING ALL ELECTRICAL DEVICE (SWITCHES, OUTLETS, ETC.) COVER PLATES.

D. MATERIALS LISTED ON THE FINISH SCHEDULE REFER TO THE MAJORITY OF WALLS, FLOOR

AND CEILING OF ROOMS SCHEDULED, REFER TO PLANS, DETAILS, INTERIOR ELEVATIONS,

SECTIONS, CEILING PLANS, AND NOTES FOR THOSE MATERIALS NOT INDICATED ON THE

1. REMOVE, MODIFY AND REINSTALL EXISTING ACOUSTIC TILE CEILING AS REQUIRED FOR

NORTH SOUTH FAST

ETR

- ACB -ACOUSTICAL CEILING BOARD
- CEM -CARPET ENTRY MAT CMU -CONCRETE MASONRY UNIT
- EP -EPOXY PAINTED etr -existing to remain
- GYP -GYPSUM BOARD PNT -PAINTED

FINISH SCHEDULE NOTE #

FINISH SCHEDULE NOTE # 1

ETR

ETR

- RUB -RUBBER BASE
- VCT -VINYL COMPOSITION TILE n/a -NOT APPLICABLE

ALTERATIONS AND RENOVATIONS TO JOSEPH C. SHANER **MEMORIAL ELEMENTARY SCHOOL**

Project Owner Name HAMILTON TOWNSHIP BOARD OF EDUCATION


Project Location 5801 3rd ST MAYS LANDING, NJ 08330


Project Number 4937B Project Date 02.15.2019 Checked By Drawn By dsb

SECURITY VESTIBULE

1/4" = 1' - 0"

No. Date Description

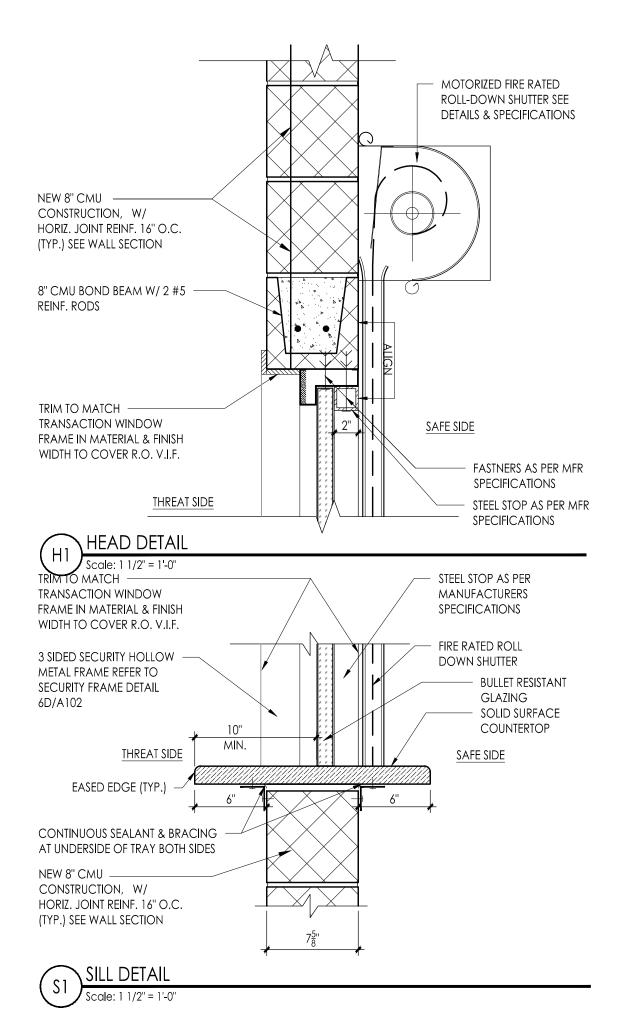

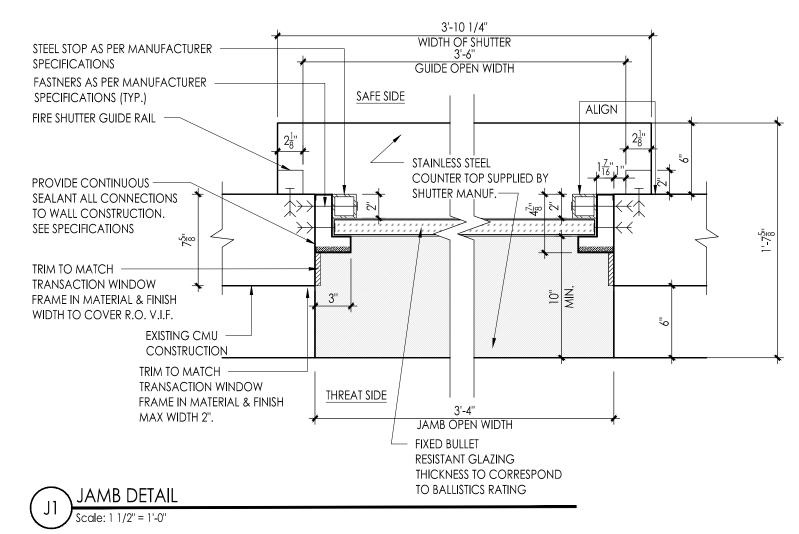

DOOR / WINDOW SCHEDULE JOSEPH C. SHANER ELEMENTARY SCHOOL DOOR / WINDOW SILL / SADDLE / RATING HARD WARE SIGN REMARKS LOCATION HRESHOLD TYPE HEAD JAMB GLASS SECURITY ENTRY DOOR @ VESTIBULE (2) 3'-0" x 6'-8" DOOR / WINDOW NOTE # 2, 3 SECURITY ENTRY DOOR @ VESTIBULE (1) 3'-0" x 6'-8" DOOR / WINDOW NOTE # 1, 4 FRP SECURITY TRANSATION WINDOW @ VES (1) 3'-4" x 3'-10" DOOR / WINDOW NOTE # BORROWED LITE @ RECEPTION (1) 3'-0" x 7'-0" DOOR / WINDOW NOTE # PRINCIPAL'S OFFICE (1) 3'-0" x 7'-0" DOOR / WINDOW NOTE # PACKAGE PASSER @ SECURE VESTIBULE (1) 18" x 16" x 19" DOOR / WINDOW NOTE

GENERAL DOOR / WINDOW NOTES

- 1. SEE DOOR ELEVATION TYPES, HEAD / JAMB / MULLION / SILL / SADDLE DETAILS AND
- SIGNAGE TYPES / DETAILS ON DRAWING A001. 2. SEE FRAME ELEVATION TYPES ON THIS DRAWING. 3. ALL DOORS ARE 1 [" THICK UNLESS OTHERWISE NOTED.


DOOR / WINDOW SCHEDULE NOTES


NEW DOOR TO MATCH EXISTING

- ELECTRONIC LOCK WITH REMOTE LATCH RELEASE ON LHR LEAF SEE SPECIFICATIONS PROXIMITY READER BY OWNER
- AL -ALUMINUM BR - BALLISTIC RATED EXISTING DOORS TO BE RELOCATED PROVIDE NEW LOCKABLE PANIC HARDWARE BRG - BALLISTIC RATED GLAZING
 - ETR EXISTING TO REMAIN ETR-F - EXISTING TO REMAIN / W/ APPLIED SECURITY FILM
 - ETR-VIF- EXISTING TO REMAIN / VERIFY IN FIELD FRP - FIBERGLASS RIENFORCED POLYESTER
 - HM HOLLOW METAL MTL -METAL
 - PTD -PAINTED SHM - SECURITY HOLLOW METAL
 - SC -SOLID CORE TPG-F - TEMPERED PLATE GLASS W/ SECURITY WINDOW FILM


DOOR / WINDOW ABBREVIATIONS

WD -WOOD n/a -NOT APPLICABLE

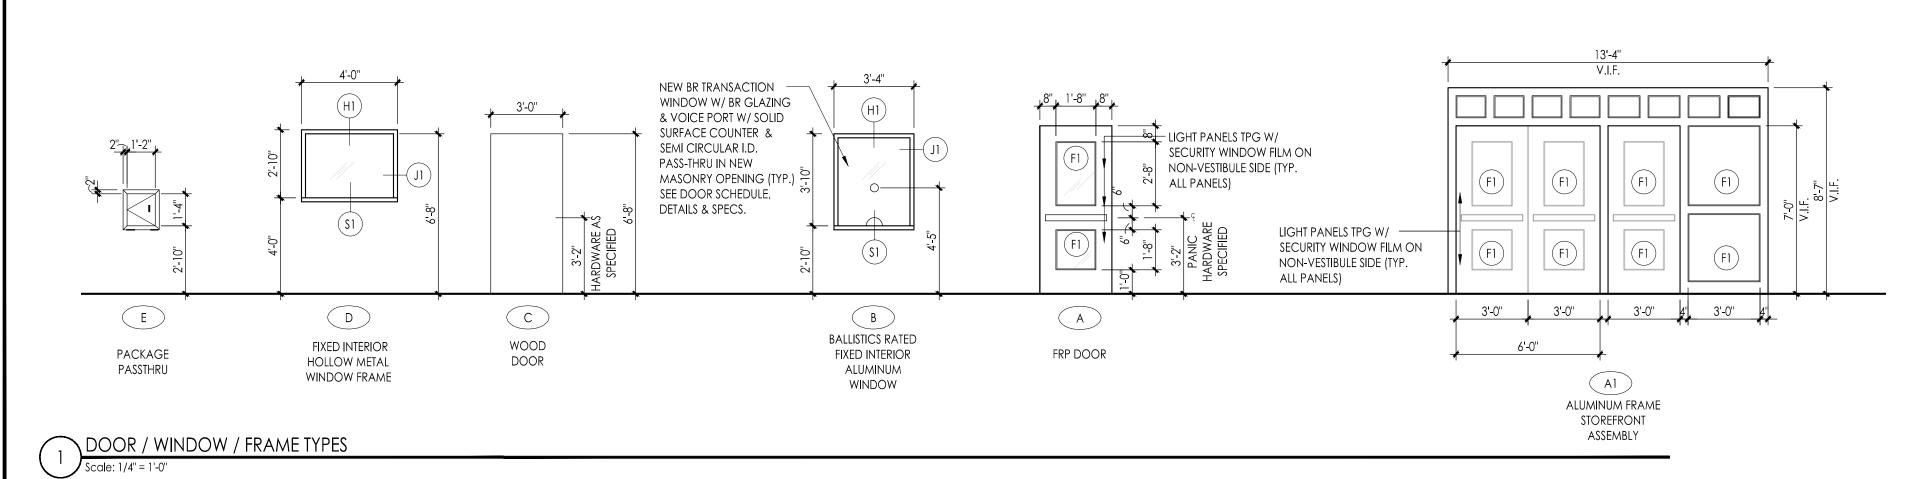

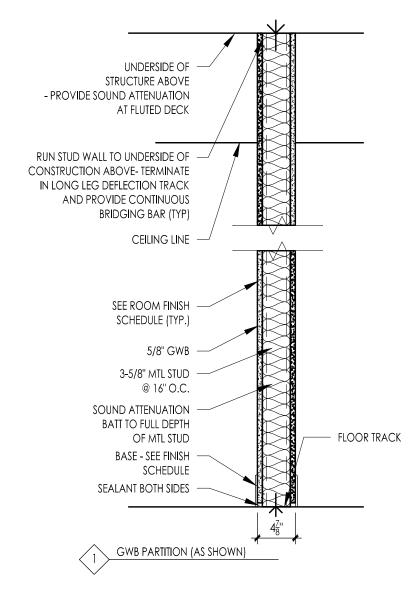




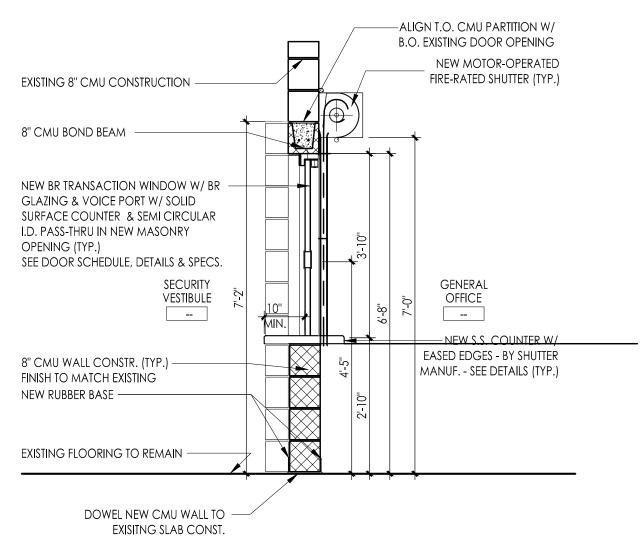

WALL SECTION AT TRANSACTION WINDOW

Scale: 1/2" = 1'-0"

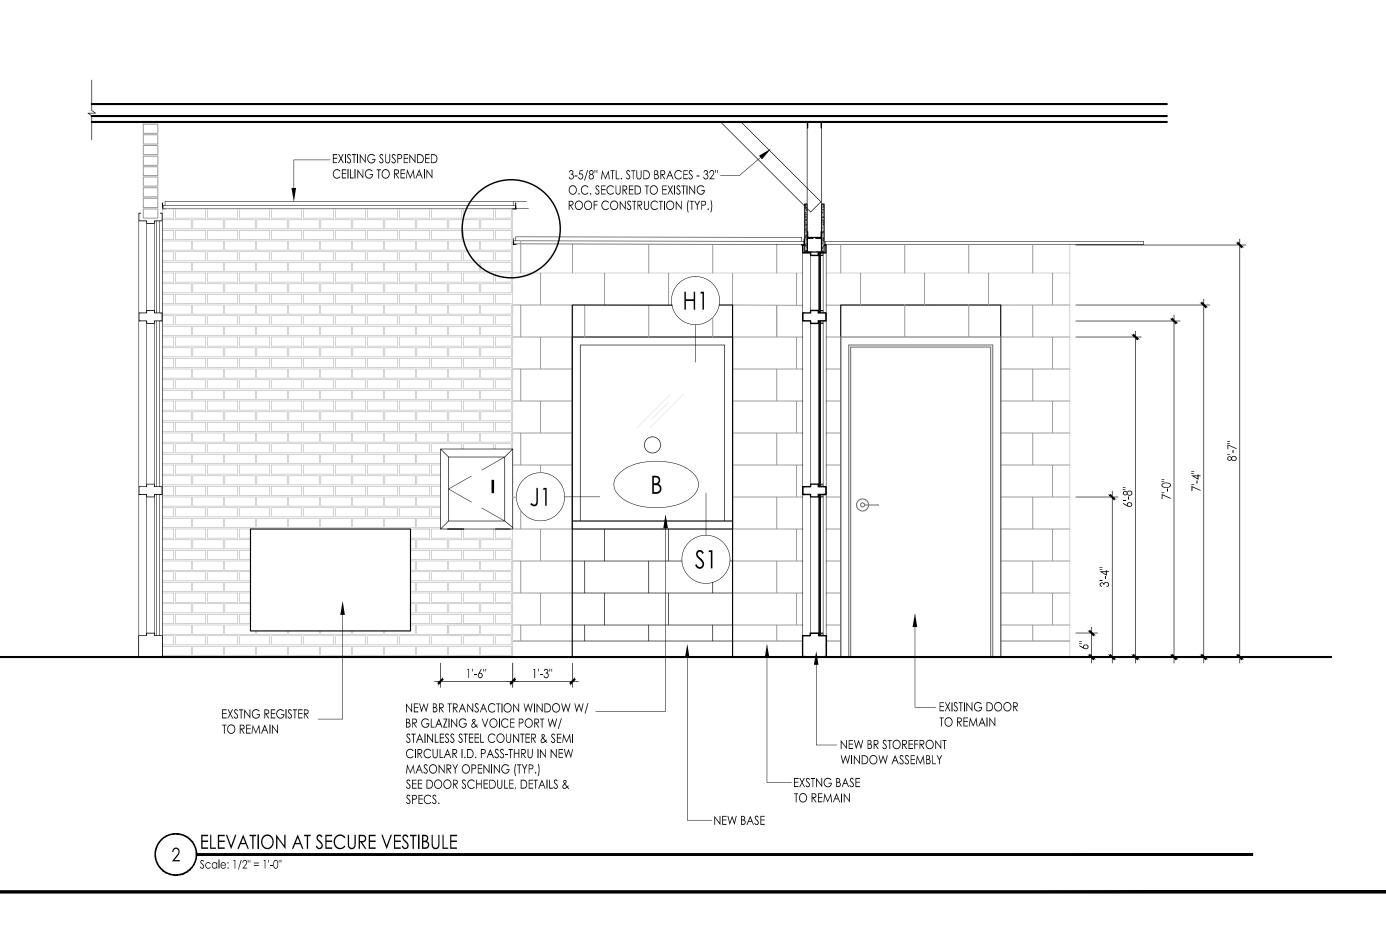

ALTERATIONS AND RENOVATIONS TO JOSEPH C. SHANER **MEMORIAL ELEMENTARY SCHOOL**

Project Owner Name HAMILTON TOWNSHIP BOARD OF EDUCATION

Project Location 5801 3rd ST MAYS LANDING, NJ 08330

Project Number Project Date 02.15.2019 Checked By Drawn By dsb

SECURITY VESTIBULE

1/4" = 1' - 0"

No. Date Description


GENERAL DEMOLITION NOTES:

- A. ALL CONTRACTORS ARE ADVISED TO VISIT THE SITE AND VERIFY ALL AREAS AND CONDITIONS PRIOR TO SUBMITTING THEIR BIDS. THE CONTRACTOR MUST NOTIFY THE ARCHITECT OF ANY DISCREPANCIES AND/OR OMISSIONS IN WRITING AT LEAST SEVEN DAYS PRIOR TO THE RECEIPT OF BIDS. FAILURE TO SO NOTIFY THE ARCHITECT INDICATES THAT ANY ADDITIONAL COSTS ASSOCIATED WITH THE DISCREPANCIES AND / OR OMISSIONS ARE INCLUDED IN THE CONTRACTOR'S BID AND THAT NO CHANGE TO THE CONTRACT AMOUNT WILL BE MADE AFTER THE RECEIPT OF BIDS OR THE AWARD OF CONTRACTS.
- B. ALL PLUMBING, MECHANICAL OR ELECTRICAL DISCONNECTS SHALL BE MADE BY THE RESPECTIVE TRADES. <u>ALL EQUIPMENT, DEVICES, FIXTURES, ETC.</u> SHALL BE REMOVED FROM THE SITE BY THE RESPECTIVE CONTRACTOR. <u>NOTE:</u> THE EXISTING FIRE ALARM SYSTEM SHALL NOT BE DIMINISHED NOR SHALL EXISTING FIRE ALARM DEVICES BE REMOVED.
- C. UNLESS NOTED OTHERWISE ALL DEMOLITION MATERIAL SHALL BE REMOVED OFF SITE BY THE CONTRACTOR AT NO ADDITIONAL COST TO THE OWNER.
- D. THERE ARE SOME SPECIFIC ITEMS DESIGNATED BY THE ARCHITECT FOR SALVAGE. THESE ITEMS ARE INTENDED FOR REUSE IN THE NEW WORK. THE CONTRACTOR MUST TAKE CARE IN THE REMOVAL AND STORAGE OF THESE ITEMS UNTIL THEY ARE NEEDED IN THE NEW CONSTRUCTION.
- E. THE CONTRACTOR SHALL MAKE EVERY EFFORT TO PROTECT PORTIONS OF THE EXISTING CONSTRUCTION WHICH ARE ADJACENT TO AREAS TO BE DEMOLISHED. MAKE ALL CUTS AS NEATLY AS POSSIBLE. REFER TO FLOOR PLAN DRAWINGS FOR FINISHING OF THESE AREAS.
- F. IF NOT OTHERWISE NOTED OR DETAILED, ALL SURFACES LEFT ROUGH OR UNFINISHED BY DEMOLITION AND WHICH ARE EXPOSED TO VIEW, SHALL BE PATCHED TO MATCH ADJACENT SURFACES AND FINISHED TO PROVIDE A UNIFORM APPEARANCE WITH REGARD TO SIZE, SHAPE, COLOR, TEXTURE AND MATERIAL.
- G. THE CONTRACTOR SHALL PROVIDE A PHYSICAL BARRIER TO CONTAIN DUST AND DIRT AROUND THE DEMOLITION AREA AND SHALL MAKE EVERY EFFORT TO KEEP THE DEMOLITION SITE AND SURROUNDING AREAS AS CLEAN AS POSSIBLE. ALL TEMPORARY PARTITIONS SHALL BE 1 HOUR RATED CONSTRUCTION AND INCLUDE A DOOR.
- H. NO DEMOLITION SHALL BEGIN UNTIL PROPER PROTECTION IS IN PLACE AND APPROVED BY ARCHITECT & OWNER TO ENSURE THE SAFETY OF THE PUBLIC, THE BUILDING OCCUPANTS, CONSTRUCTION WORKERS AND TO CONTAIN DUST AND DIRT WITHIN THE AREA OF DEMOLITION.
- I. THE CONTRACTOR SHALL COMPLY WITH ALL FEDERAL, STATE AND LOCAL LAWS REGARDING THE REMOVAL AND DISPOSAL OF ALL MATERIALS & EQUIPMENT.
- J. THE CONTRACTORS SHALL TAKE INTO ACCOUNT THEIR METHODS OF CONSTRUCTION FOR THE NEW WORK AND INCLUDE IN THEIR BID THE COST OF ADDITIONAL DEMOLITION WORK NECESSARY TO FACILITATE THE CONSTRUCTION.
- K. THE DEMOLITION WORK SHOWN ON THIS PLAN IS INTENDED TO BE A GENERAL OVERVIEW OF MAJOR DEMOLITION WORK REQUIRED. IT IS NOT A COMPLETE AND EXCLUSIVE REPRESENTATION OF ALL DEMOLITION WORK NEEDED FOR EXECUTION OF THE PROJECT. WHEN PREPARING THEIR BIDS, CONTRACTORS MUST REFER TO THE FULL SET OF CONSTRUCTION DOCUMENTS FOR VARIOUS MISCELLANEOUS ITEMS WHICH MUST BE REMOVED AND/OR RELOCATED AS PART OF THE WORK.
- L. ALL PRIME CONTRACTORS ARE RESPONSIBLE FOR THEIR OWN CUTTING AND PATCHING SEE SPECIFICATION.

DEMOLITION / CONSTRTUCTION NOTES (TOILET RENOVATIONS):

- 1. EXISTING CERAMIC TILE FLOOR FINISH TO REMAIN. INSTALL NEW TILE FLOOR FINISH OVER EXISTING TILE. PREPARE EXISTING FLOOR TILE PER NEW TILE MANUFACTURE RECOMMENDATION FOR INSTALLATION OVER EXISTING TILE.
- 2. EXISTING CERAMIC WALL TILE TO REMAIN ON ALL WALLS EXCEPT THOSE NOTED TO HAVE EXISTING TILE REMOVED. INSTALL NEW TILE WALL FINISH OVER EXISTING TILE. PREPARE EXISTING WALL TILE PER NEW TILE MANUFACTURE RECOMMENDATION FOR INSTALLATION OVER EXISTING TILE.
- 3. EXISTING CERAMIC WALL TILE TO BE REMOVED IN IT'S ENTIRETY. PREPARE EXISTING WALL TO ACCEPT NEW TILE WALL FINISH. INSTALL NEW TILE WALL FINISH FULL LENGTH AND HEIGHT OF WALL.
- 4. PAINT EXISTING GYPSUM BOARD CEILING IN IT'S ENTIRETY. PRIOR TO PAINTING, PROTECT ANY CEILING MOUNTED DEVICES AND REPAIR ANY CRACKS, GOUGES, HOLES, ETC. TO A FLUSH CONDITION. ALL EXISTING LIGHTING FIXTURES TO REMAIN. PAINT ALL CEILING MOUNTED SUPPLY, RETURN AND EXHAUST AIR DIFFUSERS IN THEIR ENTIRETY.
- 5. REMOVE ALL EXISTING TOILET PARTITIONS, MOUNTING BRACKETS ETC. IN THIER ENTIRETY. INVENTORY AND RECORD WHERE ALL PIECES WERE REMOVED FOR FUTURE INSTALLATION. SAFELY STORE ALL PARTITIONS AND RELATED MOUNTING BRACKETS. ALL TOILET PARTITIOINS ARE TO BE RE-INSTALLED IN SAME LOCATIONS THEY WERE REMOVED. ALL GRAB BARS, TOILET TISSUE, NAPKIN DISPENSERS ETC. THAT ARE ATTACHED TO PARTITIONS ARE TO BE RE-INSTALLED BACK ONTO PARTITION IN SAME LOCATION IF REMOVED DURING DEMOLITION.
- 6. REMOVE ALL WALL MOUNTED MIRRORS IN THEIR ENTIRETY. SAFEFLY STORE DURING CONSTRUCTION. DOCUMENT HEIGHT ABOVE FINISHED FLOOR ALL MIRRORS WERE MOUNTED. RE-INSTALL MIRRORS OVER SINKS AT SAME HEIGHTS AS PREVIOUSLY INSTALLED. ALL MIRRORS TO BE CENTERED OVER NEW SINKS.
- 7. REFER TO PLUMBING DRAWINGS FOR DEMOLITION AND NEW WORK NOTES.
- 8. ALL WALL MOUNTED TOILET ACCESSORIES INCLUDING BUT NOT LIMITED TO, SOAP DISPENSERS, ELECTRIC HAND DRYERS, PAPER TOWEL DISPENSERS, NAPKIN DISPENSERS AND GRAB BARS ARE TO BE REMOVED AND SAFELY STORED DURING CONSTRUCTION. RE-INSTALL IN SAME LOCATIONS AND HEIGHTS AS PREVIOUSLY INSTALLED. SOAP DISPENSERS WILL NOT BE RE-USED.
- 9. EXISTING CMU WALL FINISH TO REMAIN PAINT.
- 10. REMOVE EXISTING 4" HIGH CERAMIC TILE WALL BASE IN IT'S ENTIRETY. PATCH AND PREPARE EXISTING CMU WALL AS NECCESSARY FOR INSTALLATION ON NEW TILE BASE.
- 11. REMOVE EXISTING VERTICALLY MOUNTED GRAB BAR AND HAND OVER TO OWNER.
- 12. REMOVE EXISTING CHALK BOARDS IN THEIR ENTIRETY. DOCUMENT EXISTING MOUNTING HEIGHT PRIOR TO REMOVAL. RE-INSTALL BOARDS IN SAME LOCATION AND HEIGHT ON WALL AFTER NEW TILE IS INSTALLED.
- 13. REMOVE EXISTING BENCHES AND SAFETLY STORE. PRIOR TO REMOVAL DOCUMENT LOCATION OF EACH BENCH AND RE-INSTALL AFTER FLOOR TILE INSTALLATION IN SAME LOCATION. PRIOR TO INSTALLATION PAINT METAL SUPPORT BASES OF EACH BENCH.
- 14. REMOVE EXISTING METAL LOCKERS IN THEIR ENTIRETY. CONCRETE BASE TO REMAIN. INSTALL NEW METAL LOCKERS WITH SLOPED TOPS IN SAME LOCATION AS LOCKERS REMOVED. REFER TO LOCKER SCHEDULE AND SPECIFICATIONS FOR TYPES.
- 15. REMOVE EXISTING RECESSED PAPER TOWEL DISPENSER/DISPOSAL. INFILL OPENING WITH \$" MOISTURE/MOLD RESISTANT GYP. BD OVER 3 \$" METAL STUDS. ALIGN FACE OF GYP. BD. WITH FACE OF EXISTING CERAMIC TILE.

ALL PLUMBING, MECHANICAL OR ELECTRICAL DISCONNECTS SHALL BE MADE BY THE RESPECTIVE TRADES. <u>ALL EQUIPMENT, DEVICES, FIXTURES, ETC.</u> SHALL BE REMOVED FROM THE SITE BY THE RESPECTIVE CONTRACTOR. <u>NOTE:</u> THE EXISTING FIRE ALARM SYSTEM SHALL NOT BE DIMINISHED NOR SHALL EXISTING FIRE ALARM DEVICES BE REMOVED DURING CONSTRUCTION. ALL DEVICES ARE TO BE PROTECTED FROM DAMAGE DURING CONSTRUCTION.

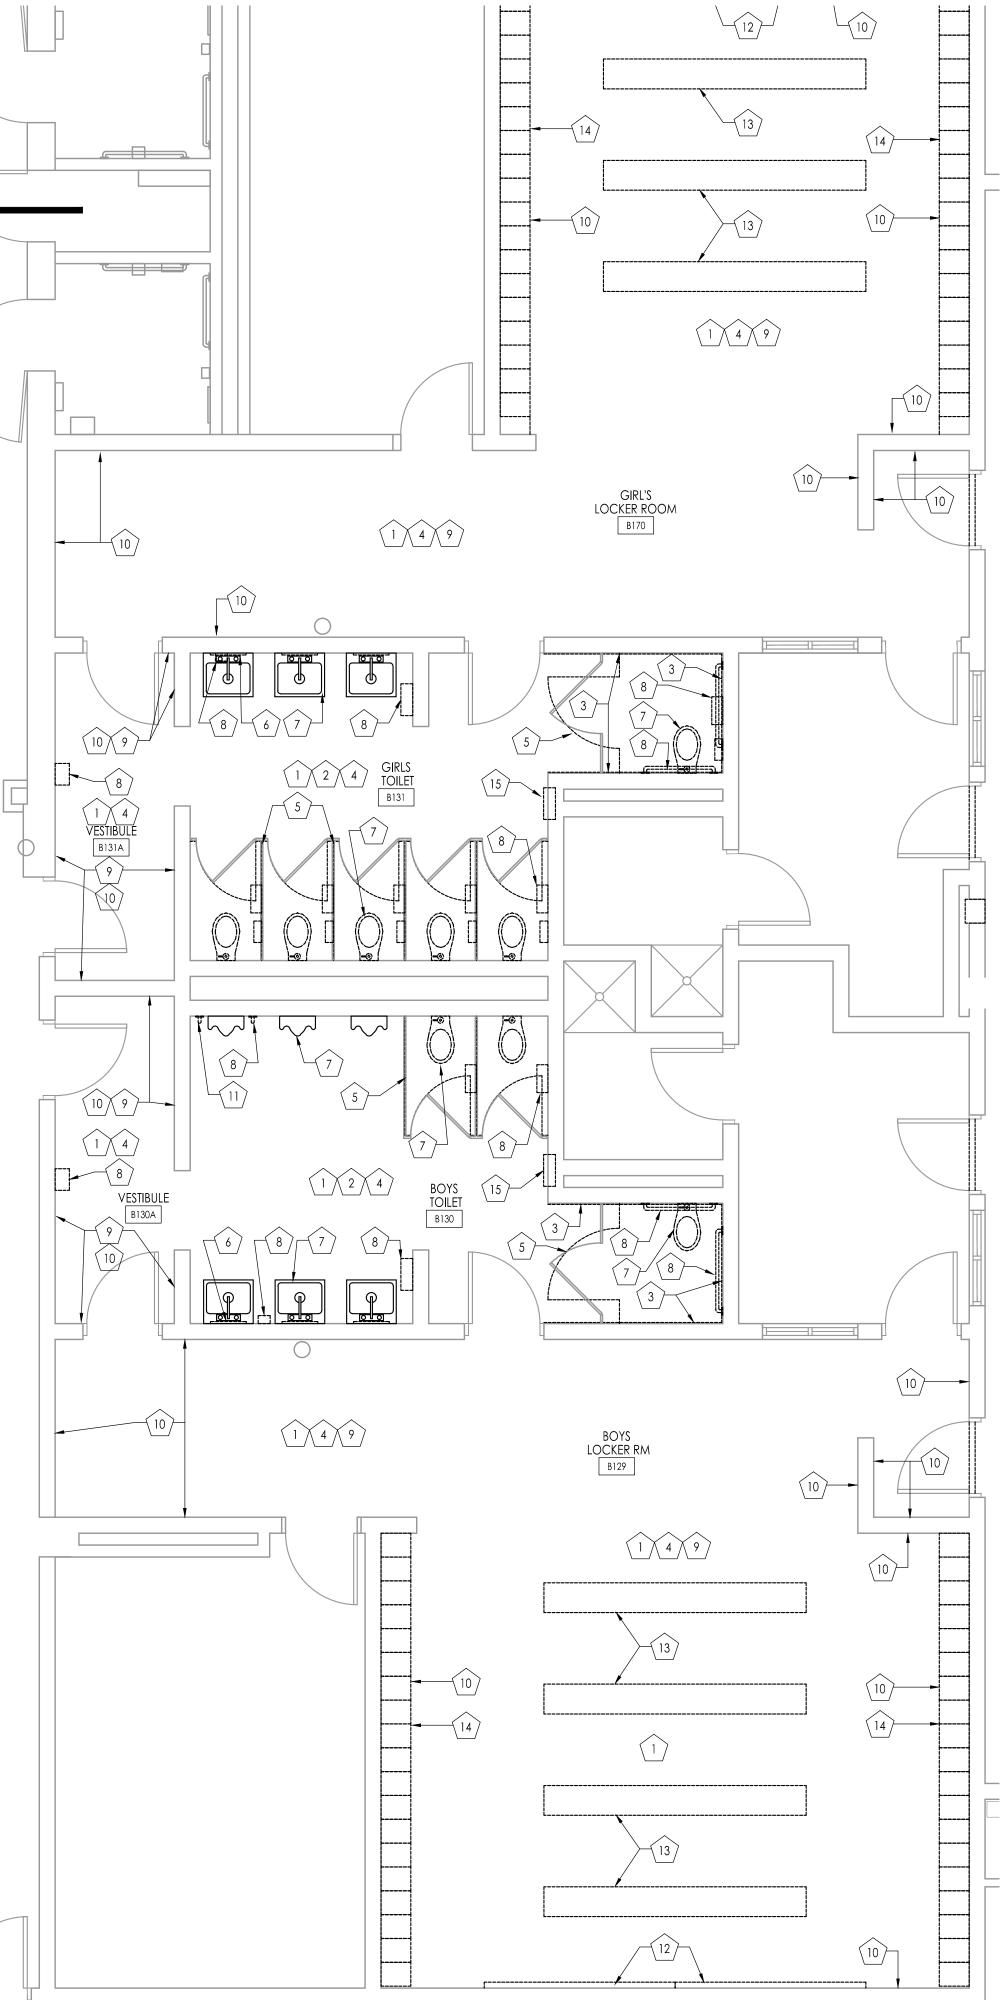

DEMOLITION PLAN - BOY'S TOILET B130, GIRL'S TOILET B131, TOILET 133, TOILET 134 Scale: 1/4" = 1'-0"


CONSTRUCTION KEY LEGEND


RENOVATION
RENOVATION ARE DESIGNED UNDER THE NEW JERSEY

REHABILITATION SUB-CODE.

APPLICABLE CODES:
THIS PROJECT WAS DESIGNED UNDER THE FOLLOWING CODES:

CONSTRUCTION CODE (RENOVATION) BUILDING SUBCODE BARRIER-FREE SUBCODE PLUMBING SUBCODE MECHANICAL SUBCODE ELECTRICAL SUBCODE FUEL GAS SUBCODE ENERGY CONSERVATION SUBCODE
BUILDING CODE 2015 - NJ EDITION
N.J.A.C. 5:23-7 AND ICC-ANSI A117.1-2009
NATIONAL STANDARD PLUMBING SUBCODE 2015
INTERNATIONAL MECHANICAL CODE 2015
NATIONAL ELECTRICAL CODE 2014
INTERNATIONAL FUEL GAS CODE 2015
ASHRAE 90.1 2013

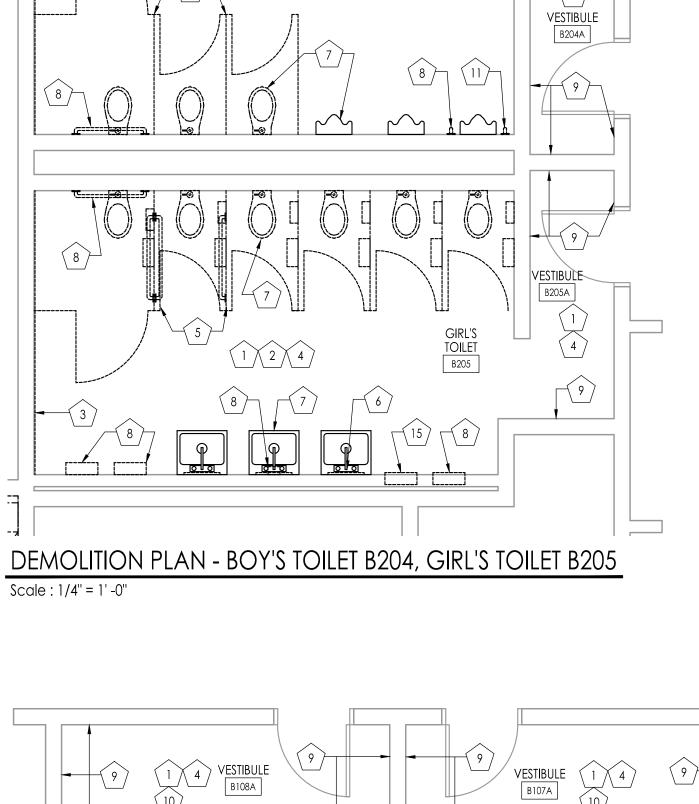


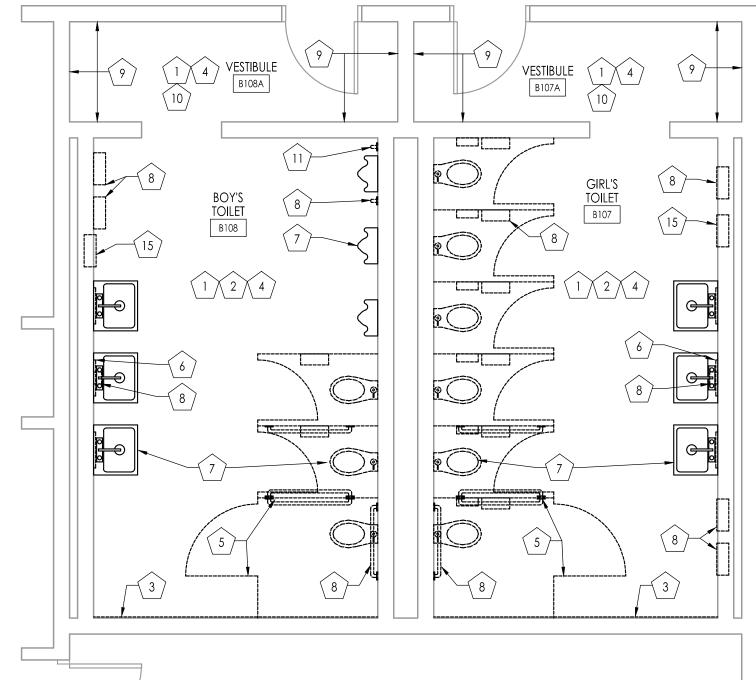

DEMOLITION PLAN - GIRL'S TOILET B107, BOY'S TOILET B108

Scale: 1/4" = 1'-0"

Scale: NOT TO SCALE

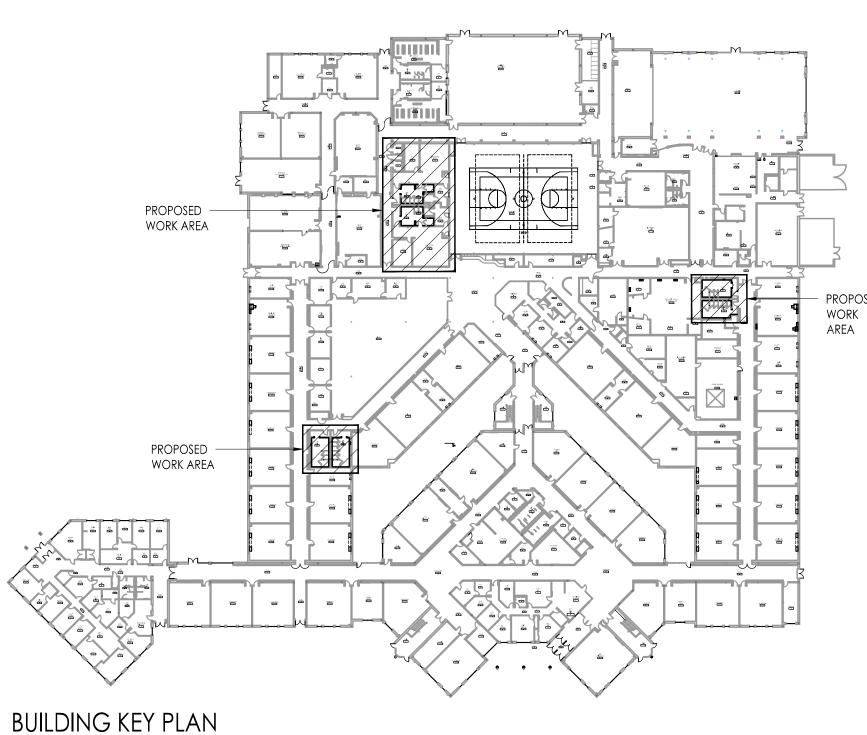

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Project Name

ALTERATIONS AND
RENOVATIONS TO
WILLIAM DAVIES
MIDDLE SCHOOL

Project Owner Name

HAMILTON

TOWNSHIP BOARD

OF EDUCATION

Project Location

1876 DENNIS
FORMAN DR
MAYS LANDING,
NJ 08330

Project Number

4937C

Project Date

02.15.2019

Checked By

JJV

Drawn By

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Scale


TOILET DEMOLITION
PLANS

AS NOTED

Revisions
No. Date Description

Drawing Number

A 1 0 1

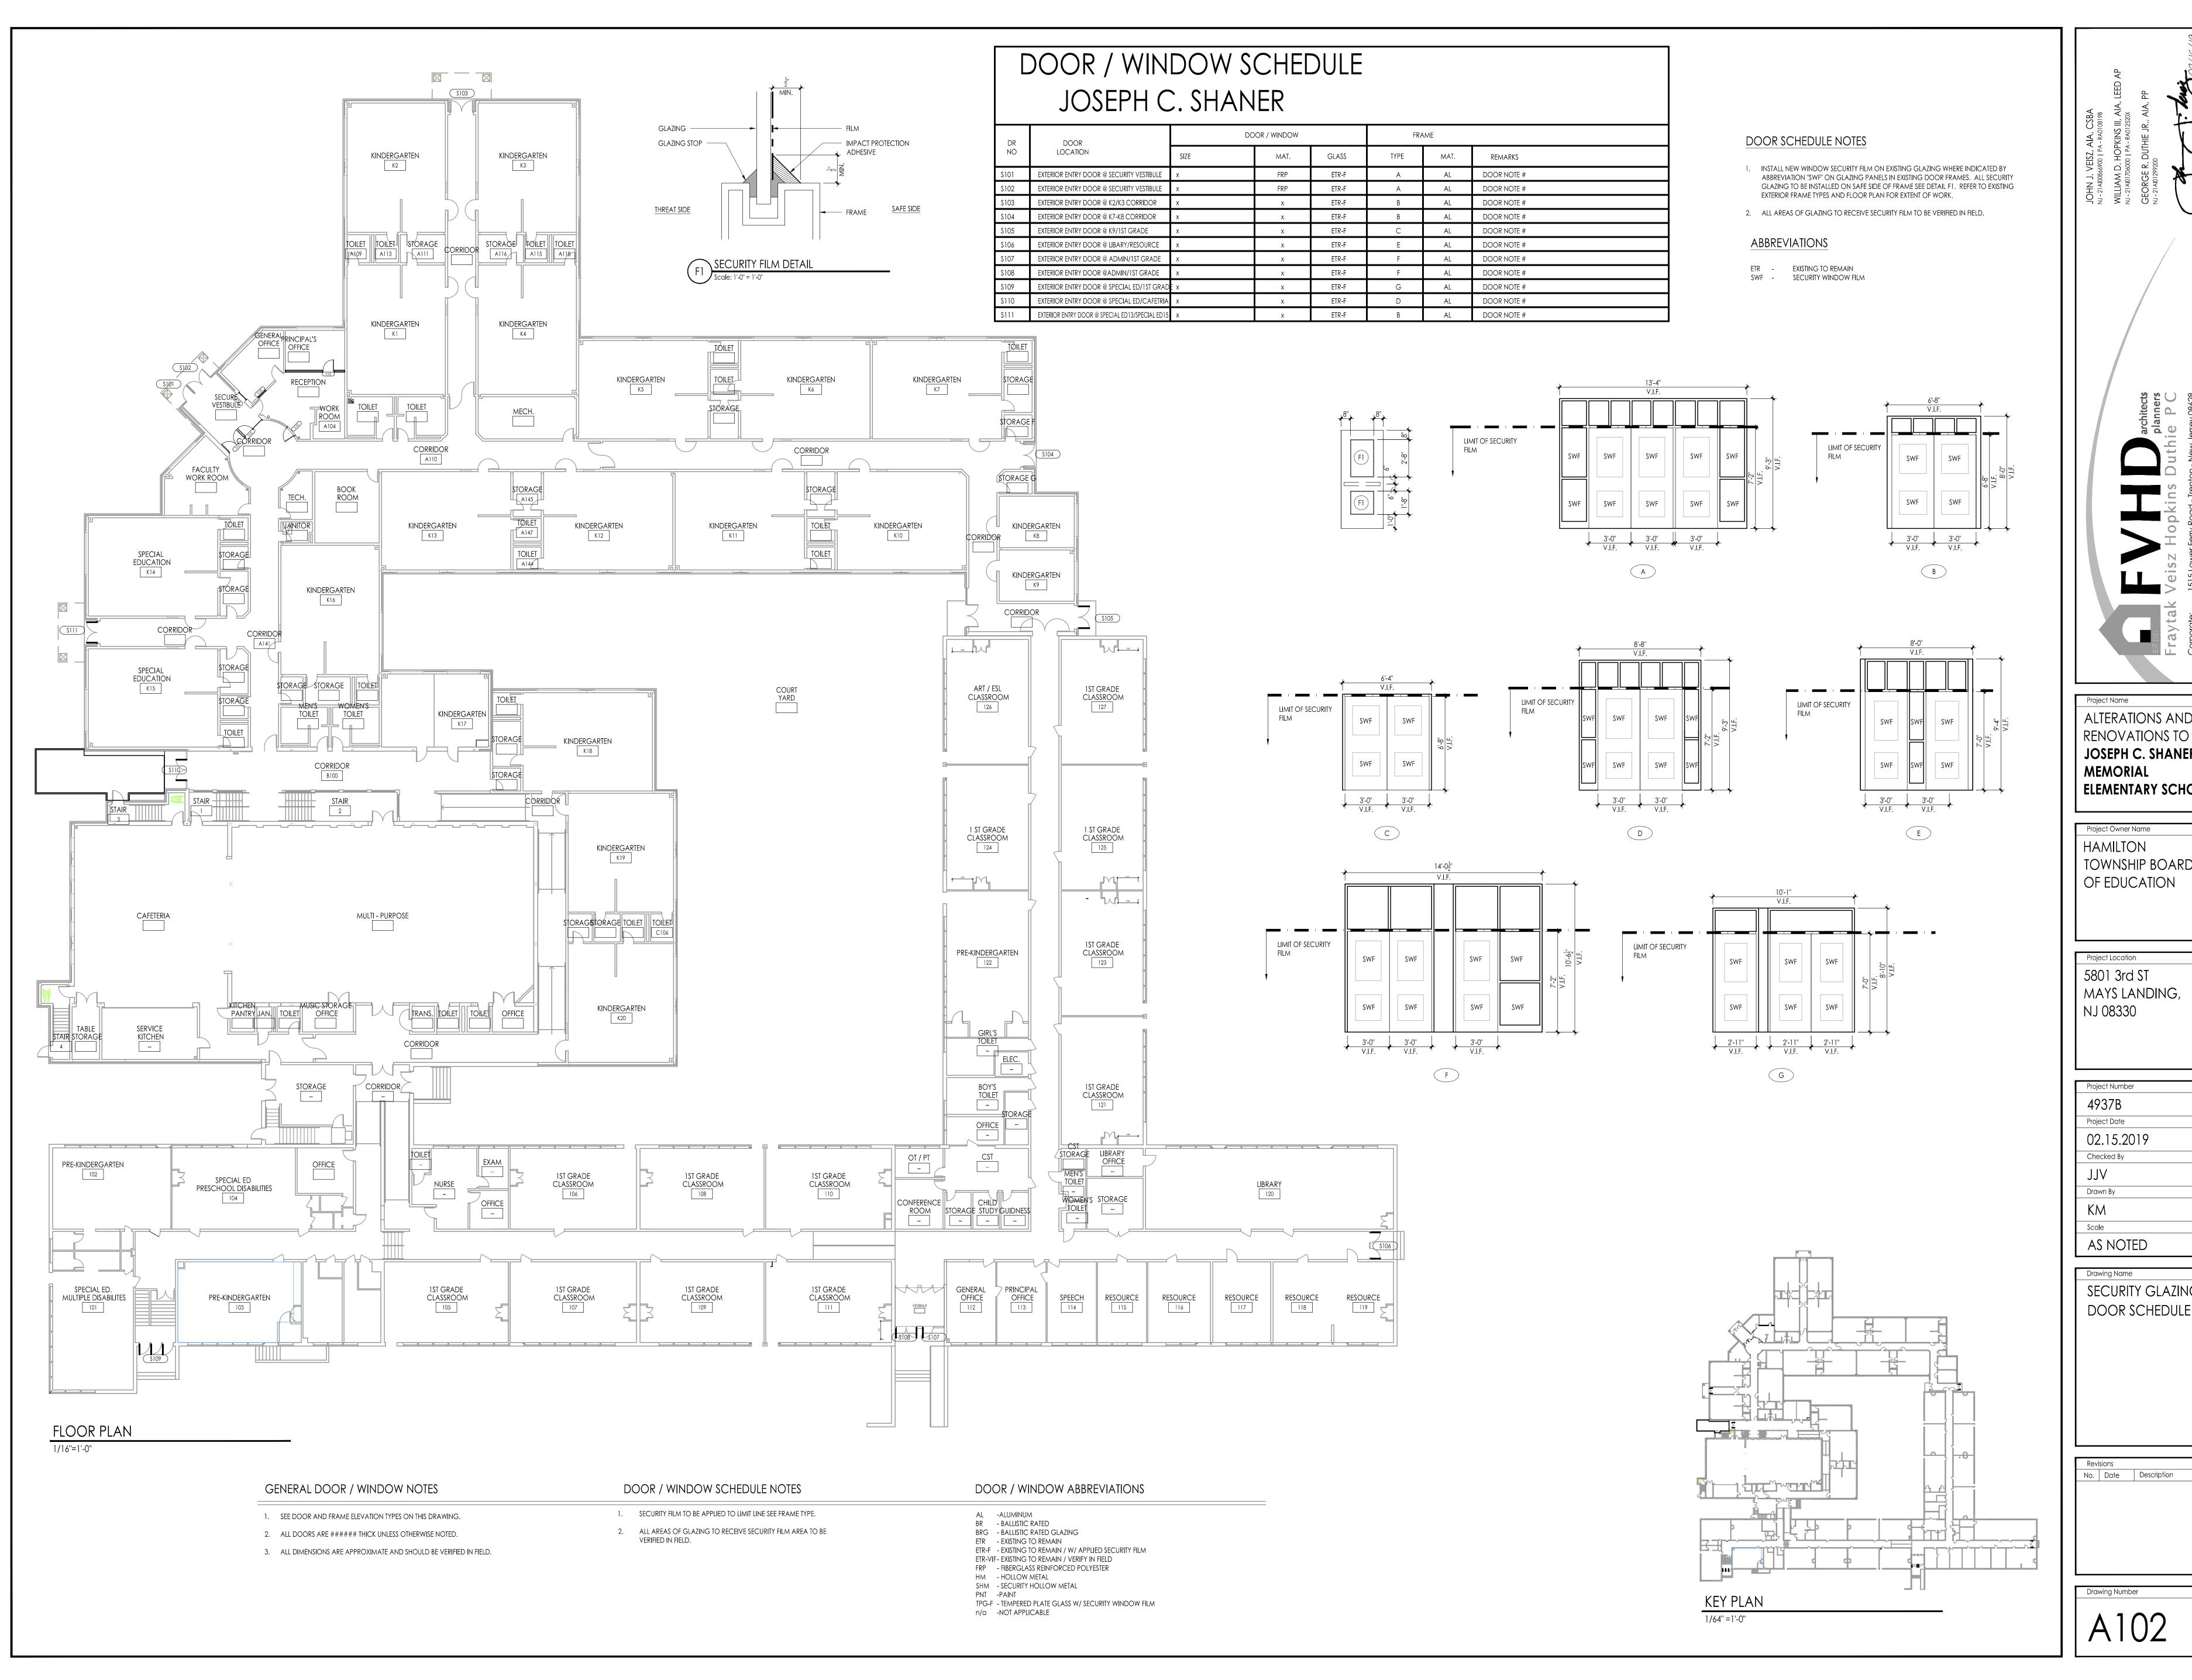

JOSEPH C. SHANER **MEMORIAL ELEMENTARY SCHOOL** Project Owner Name HAMILTON

ALTERATIONS AND


TOWNSHIP BOARD OF EDUCATION

Project Location 5801 3rd ST MAYS LANDING, NJ 08330

02.15.2019 Checked By Drawn By ΚM

AS NOTED SECURITY GLAZING DOOR SCHEDULE

No. Date Description

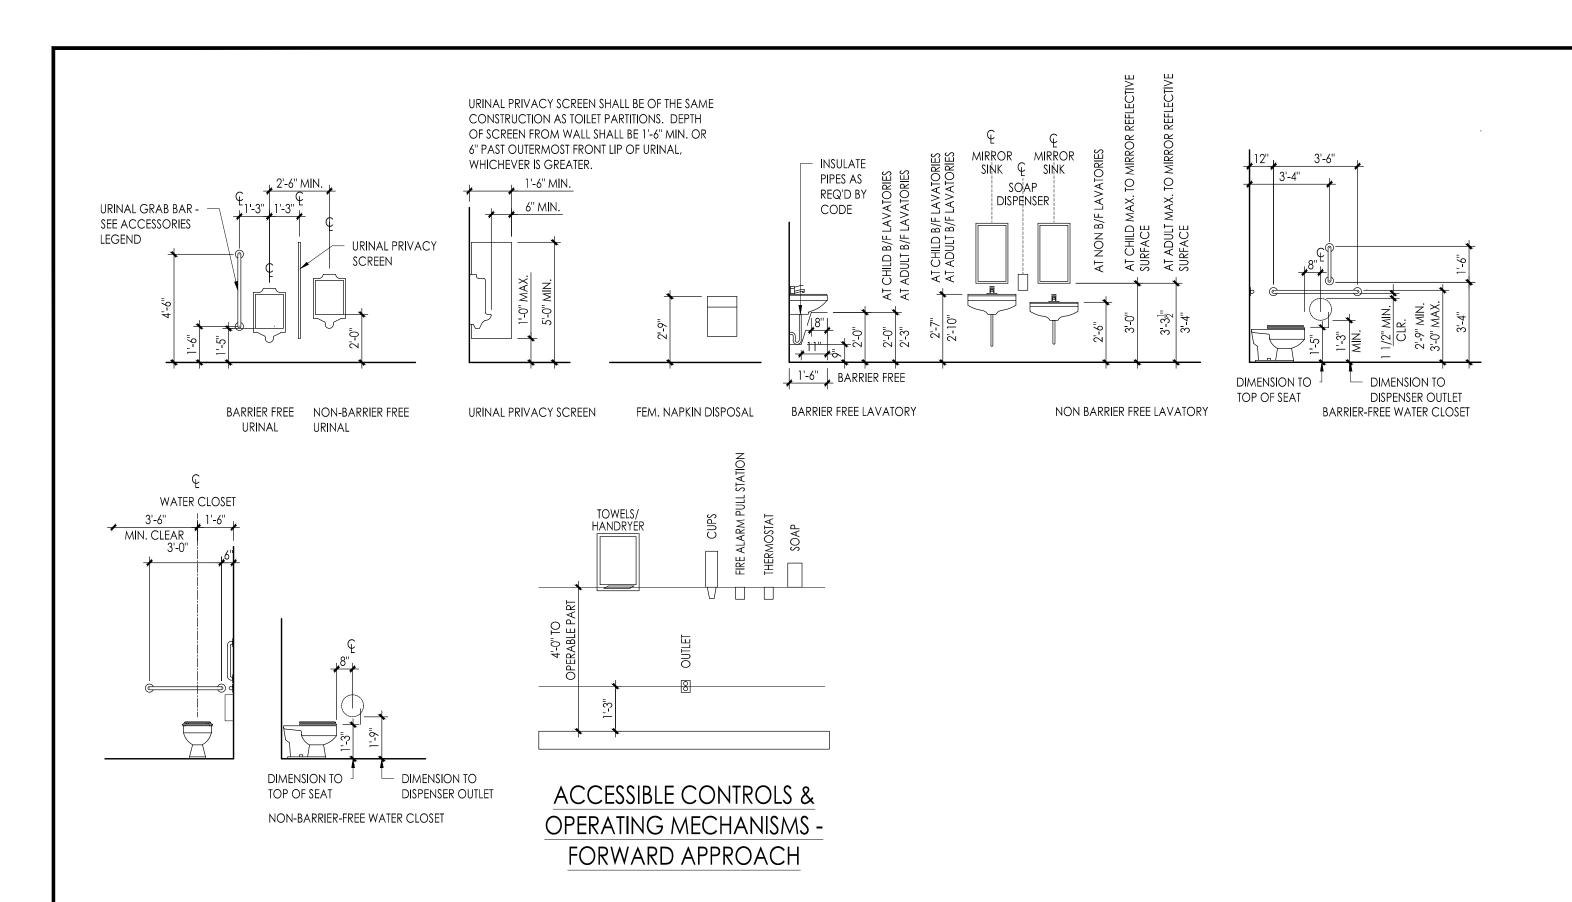

ROOM FINISH SCHEDULE										
NUMBER	ROOM NAME	FLOOR	BASE		WAINSCOT		VV/VII LIVIICII	CEILING		NOTEC
			MAT.	HT.	MAT.	HT.	WALL FINISH	MAT.	HT.	NOTES
B107	GIRL'S TOILET	PT	PT				PT	ETR-P	ETR	SEE ROOM FINISH SCHEDULE NOTE 1
B107A	VESTIBULE	PT	PT				CEP	ETR-P	ETR	SEE ROOM FINISH SCHEDULE NOTE 1
B108	BOY'S TOILET	PT	PT				PT	ETR-P	ETR	SEE ROOM FINISH SCHEDULE NOTE 1
B108A	VESTIBULE	PT	PT				CEP	ETR-P	ETR	SEE ROOM FINISH SCHEDULE NOTE 1
B129	BOYS LOCKER RM	PT	PT				CEP	ETR-P	ETR	SEE ROOM FINISH SCHEDULE NOTE 1
B130	BOYS TOILET	PT	PT				PT	ETR-P	ETR	SEE ROOM FINISH SCHEDULE NOTE 1
B130A	VESTIBULE	PT	PT				CEP	ETR-P	ETR	SEE ROOM FINISH SCHEDULE NOTE 1
B131	GIRLS TOILET	PT	PT				PT	ETR-P	ETR	SEE ROOM FINISH SCHEDULE NOTE 1
B131A	VESTIBULE	PT	PT				CEP	ETR-P	ETR	SEE ROOM FINIHS SCHEDULE NOTE 1
B170	GIRL'S LOCKER ROOM	PT	PT				CEP	ETR-P	ETR	SEE ROOM FINISH SCHEDULE NOTE 1
B204	BOY'S TOILET	PT	PT				PT	ETR-P	ETR	SEE ROOM FINISH SCHEDUEL NOTE 1
B204A	VESTIBULE	PT	PT				CEP	ETR-P	ETR	SEE ROOM FINISH SCHEDULE NOTE 1
B205	GIRL'S TOILET	PT	PT				PT	ETR-P	ETR	SEE ROOM FINISH SCHEDULE NOTE 1
B205A	VESTIBULE	PT	PT				CEP	ETR-P	ETR	SEE ROOM FINISH SCHEDULE NOTE 1
E109	GYMNASIUM	SYN	RUB	4"			CEP	ETR-P	ETR	SEE ROOM FINISH SCHEDUEL NOTE 1

ROOM FINISH SCHEDULE NOTES


1. REFER TO DEMOLITION/CONSTRUCTION NOTES ON A 101 FOR ADDITONAL INFORMATION


ROOM FINISH SCHEDULE ABBREVIATIONS

CEP - EXISTING CMU EPOXY PAINT

ETR - EXISTING TO REMAIN ETR-P - EXISTING GYPSUM BOARD TO REMAIN - PAINT
PT - PORCELAIN TILE
RUB - RUBBER BASE

SYN - SYNTHETIC SPORTS FLOORING

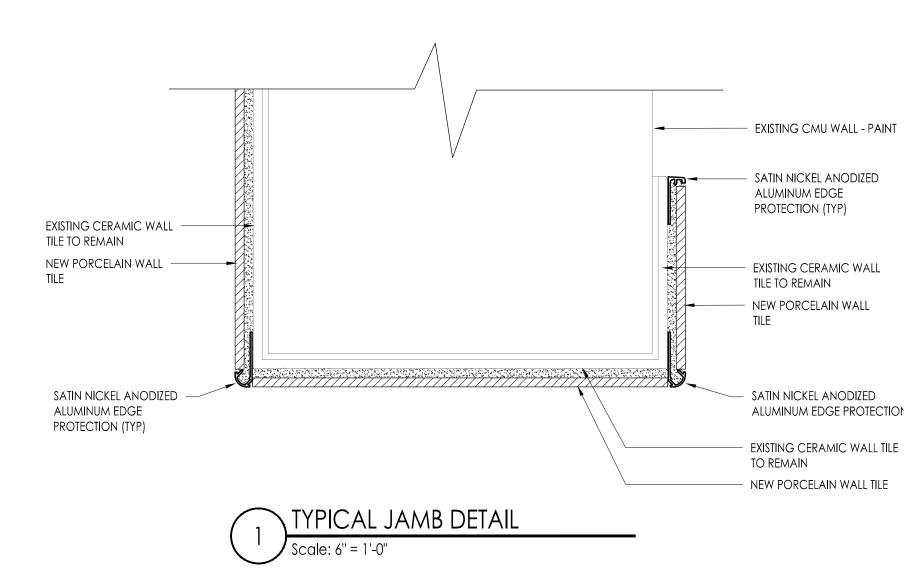

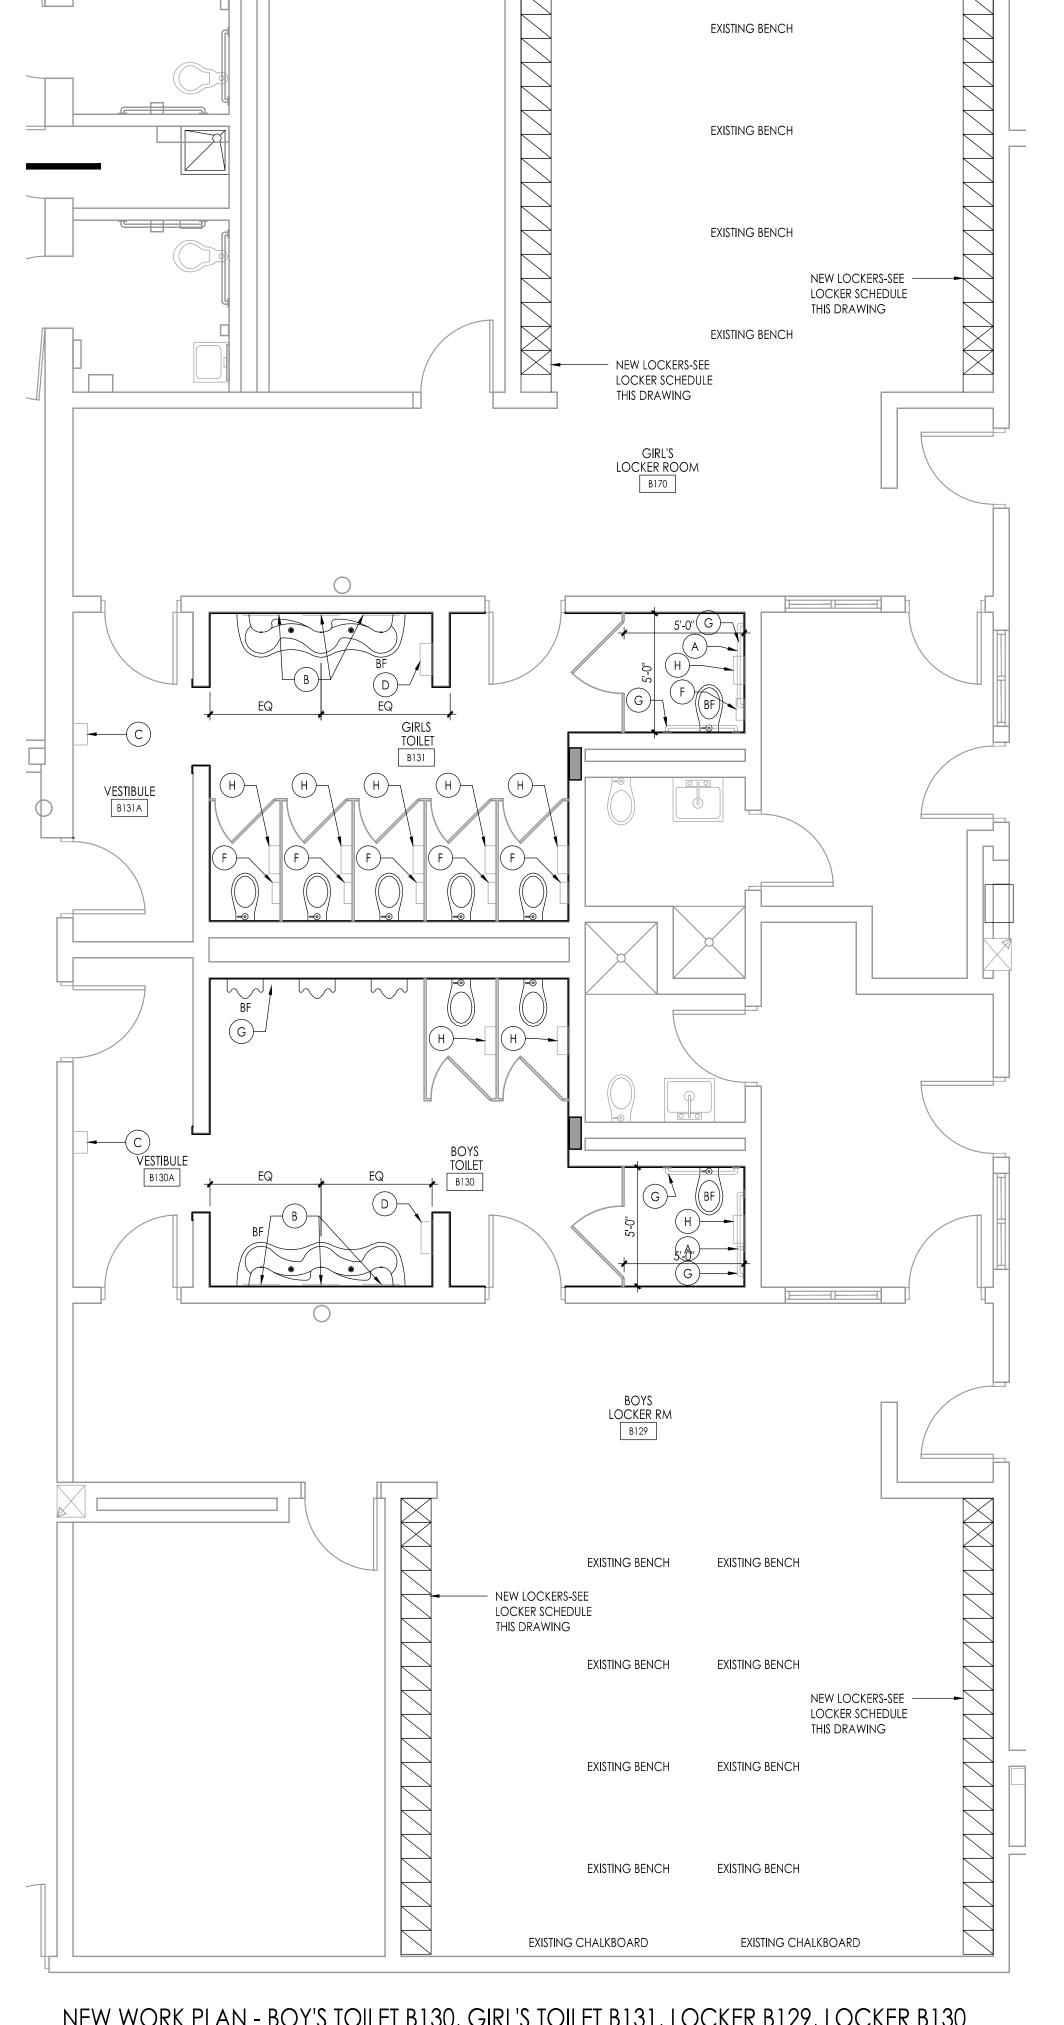

EXISTING CHALKBOARD




LOCKER SCHEDULE


LOCKER TYPE 'A'
12" W. x 15" D. x 30" H. (2 HIGH)


LOCKER TYPE 'B' (BARRIER FREE)
12" W. x 15" D. x 30" H. (2 HIGH)

		TOILET ROO	m accesso	RIES	X	
				SIZE		
NO.	NO. CAT. NO.	DESCRIPTION	W	Н	D	REMARKS
Α	800-001-18"	GRAB BAR	18"			SAFETY-GRIP FINISH, MOUNT VERTICAL
В		MIRROR				RE-USE EXISTING
С		HAND DRYER				RE-USE EXISTING
D		PAPER TOWEL DISPENSER				RE-USE EXISTING
Е		FEMININE NAPKIN DISPENSER				RE-USE EXISTING
F		FEMININE NAPKIN DISPOSAL				RE-USE EXISTING
G		GRAB BAR				RE-USE EXISTING
Н		TOILET TISSUE DISPENSER	-			RE-USE EXISTING

ALL CATALOG NUMBERS REFER TO BRADLEY WASHROOM ACCESSORIES UNLESS NOTED OTHERWISE. REFER TO FIXTURE MOUNTING HEIGHT CHART ON THIS DRAWING

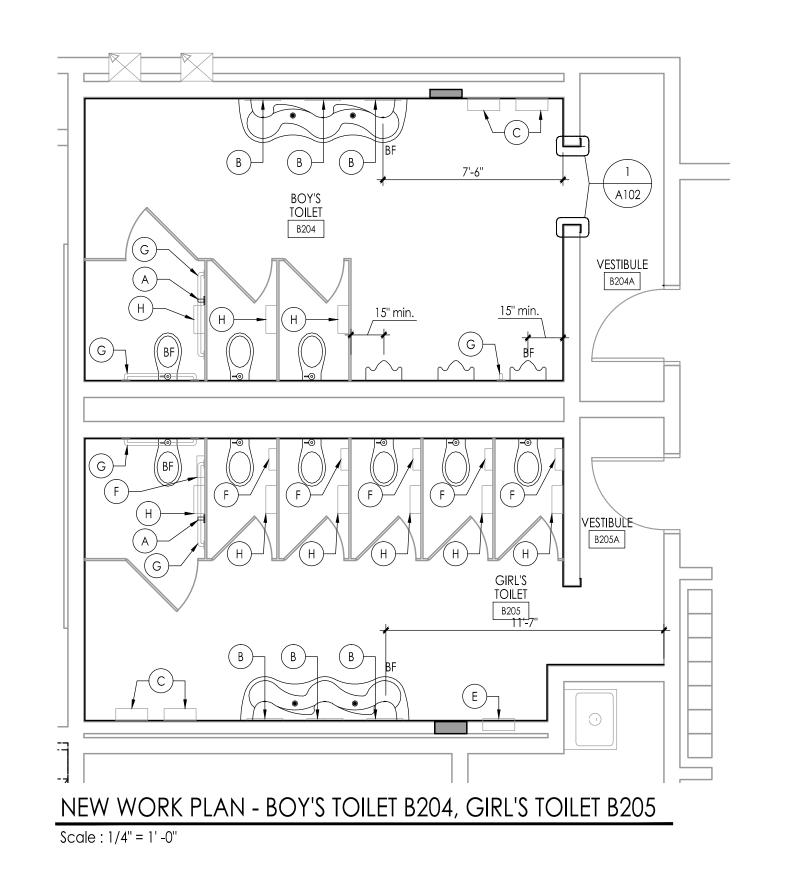

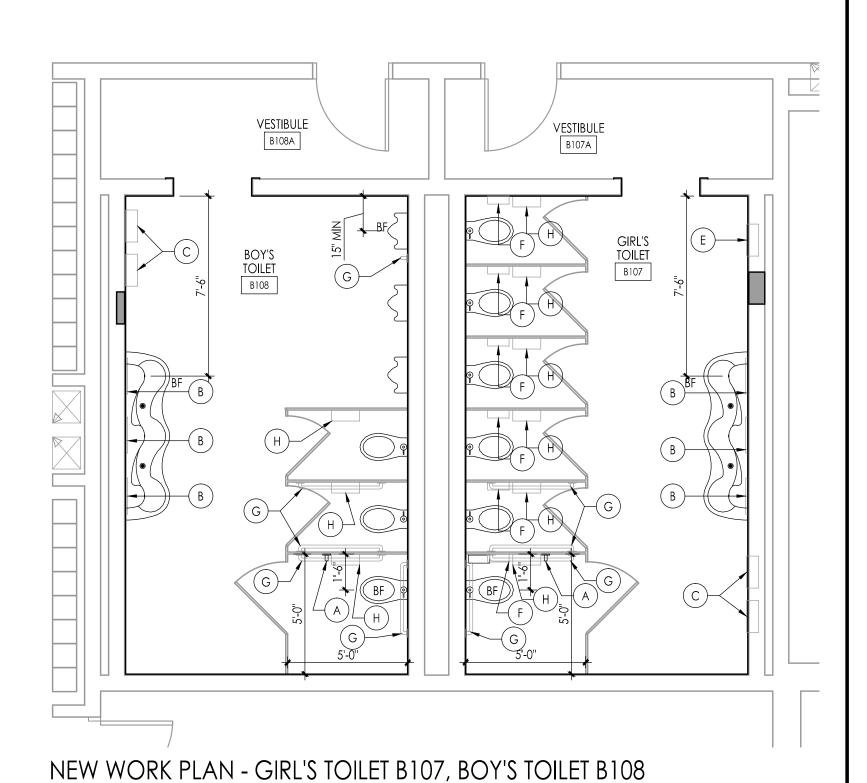

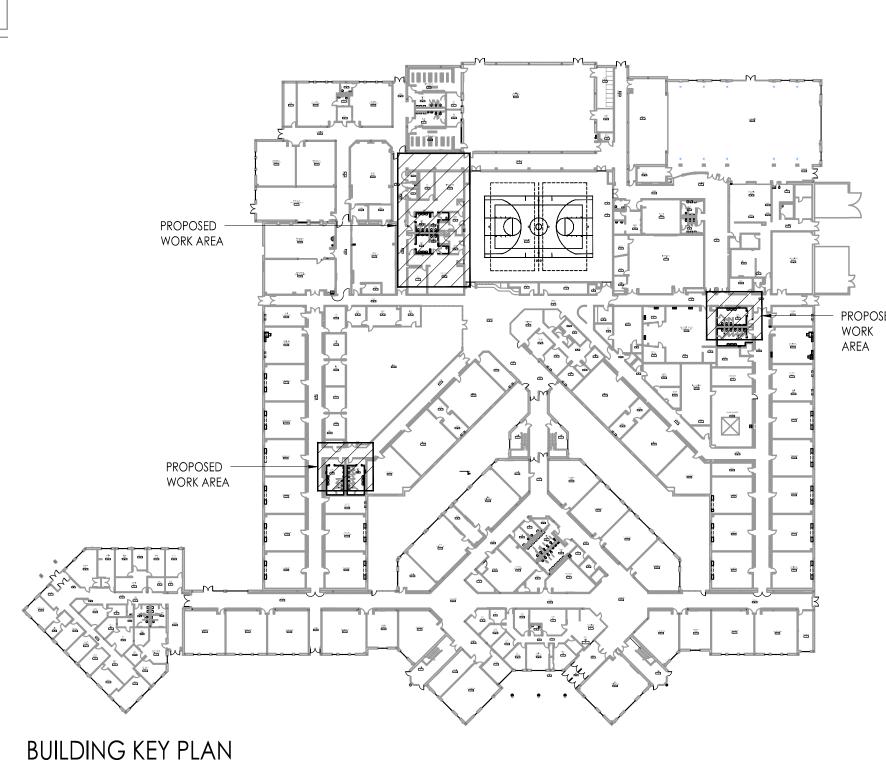

Scale: 1/4" = 1'-0"

Scale: NOT TO SCALE

ALTERATIONS AND RENOVATIONS TO WILLIAM DAVIES MIDDLE SCHOOL

Project Owner Name HAMILTON TOWNSHIP BOARD OF EDUCATION


Project Location 1876 DENNIS FORMAN DR MAYS LANDING, NJ 08330

Project Number 4937C Project Date 02.15.2019 Checked By Drawn By JMK Scale

Drawing Name TOILET AND LOCKER **ROOM NEW WORK PLANS**

AS NOTED

No. Date Description

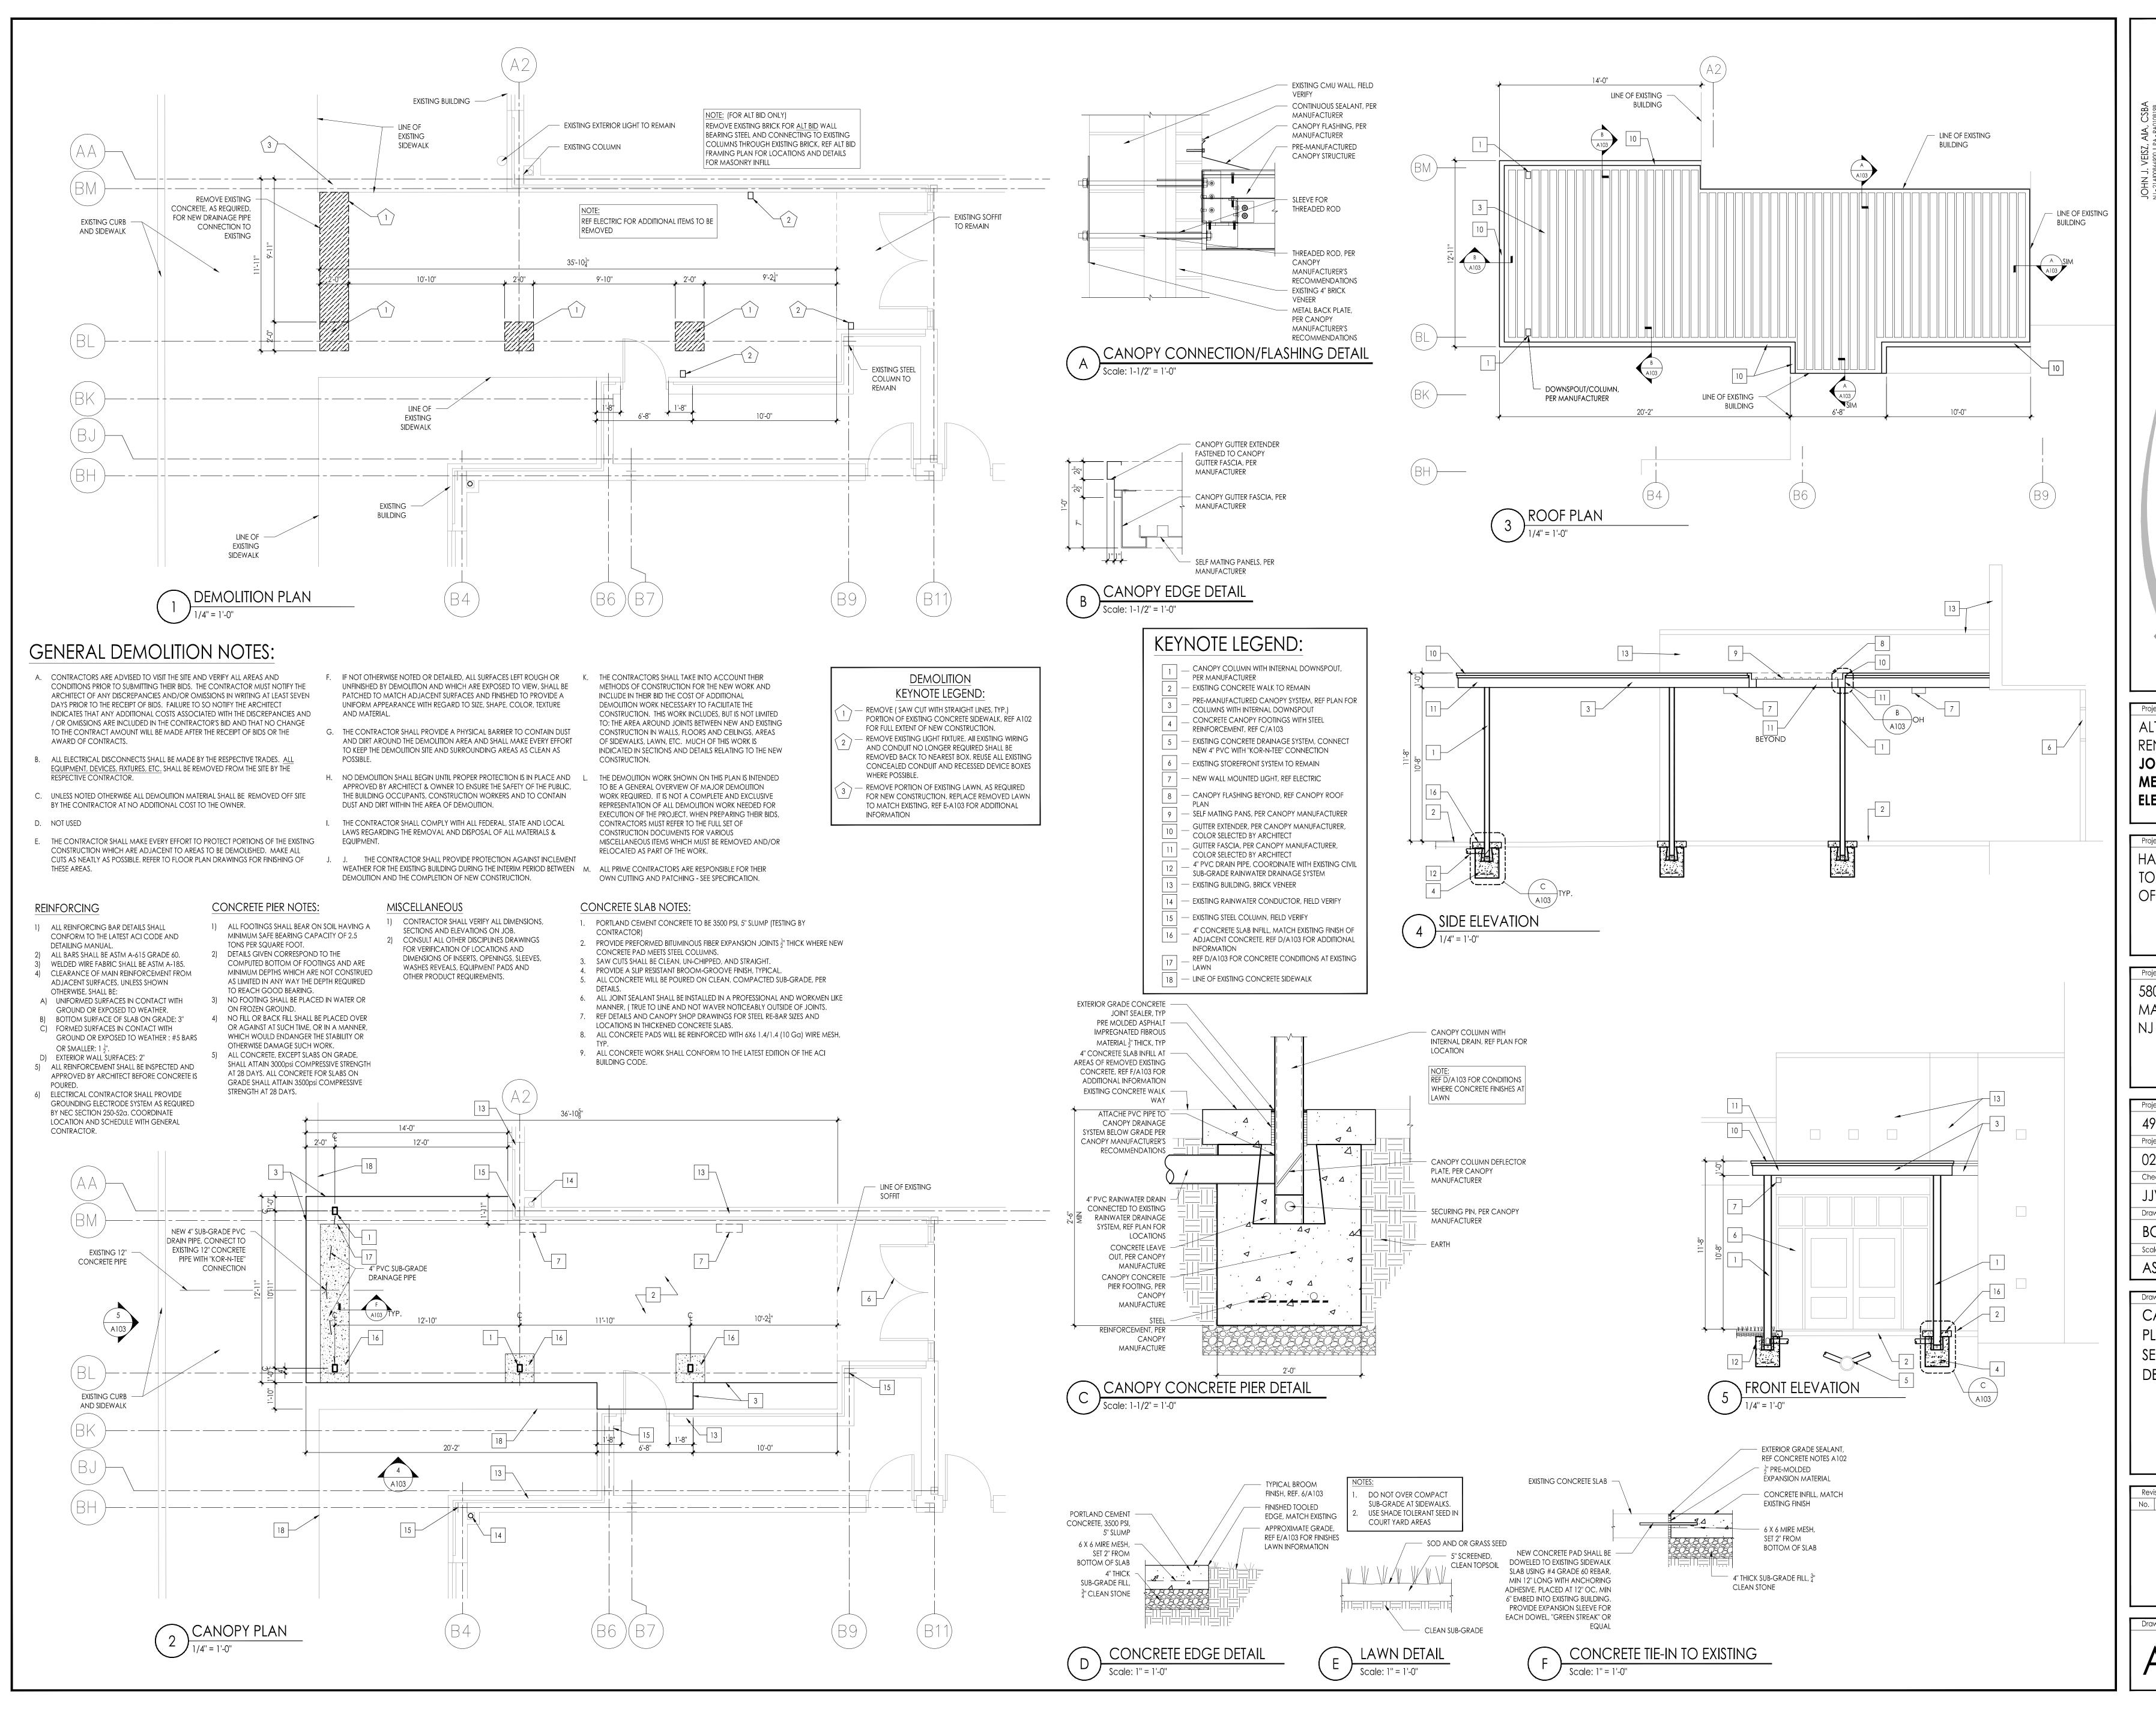

Project Owner Name HAMILTON TOWNSHIP BOARD OF EDUCATION


Project Location 5801 3rd ST MAYS LANDING,

NJ 08330

Project Number 4937B Project Date 02.15.2019 Checked By Drawn By Scale AS NOTED

Drawing Name CANOPY PLANS SECTIONS AND **DETAILS**

No. Date Description

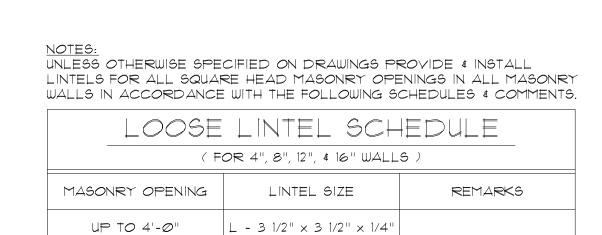

L - 5" × 3 1/2" × 5/16"

L - 6" × 3 1/2" × 5/16"

W 8 x 18 + ₱


4'-1" TO 6'-0"

6'-1" TO 8'-0"

0∨ER 8'-Ø"

LOOSE LINTEL SCHEDULE						
(FOR 6" WALLS)						
MASONRY OPENING	LINTEL SIZE	REMARKS				
2'-0" TO 6'-0"	WT 7 × 11					
6'-1" TO 8'-0"	WT 8 x 13					

- PROVIDE ONE (1) ANGLE FOR EACH 4" OF MASONRY WIDTH. . BEAR LINTELS 6" MINIMUM EACH SIDE OF OPENING.
- 3. ALL LINTELS IN EXTERIOR WALLS TO BE GALVANIZED. 4. WHERE OPENINGS LOCATED NEXT TO COLUMNS OR BEAMS, ATTACH TO STRUCTURAL STEEL, CONNECTION NOT TO
- PROTRUDE INTO OPENING. 5. CONSULT ARCHITECTURAL, MECHANICAL & ELECTRICAL DRAWINGS FOR OPENING SIZE & LOCATION.

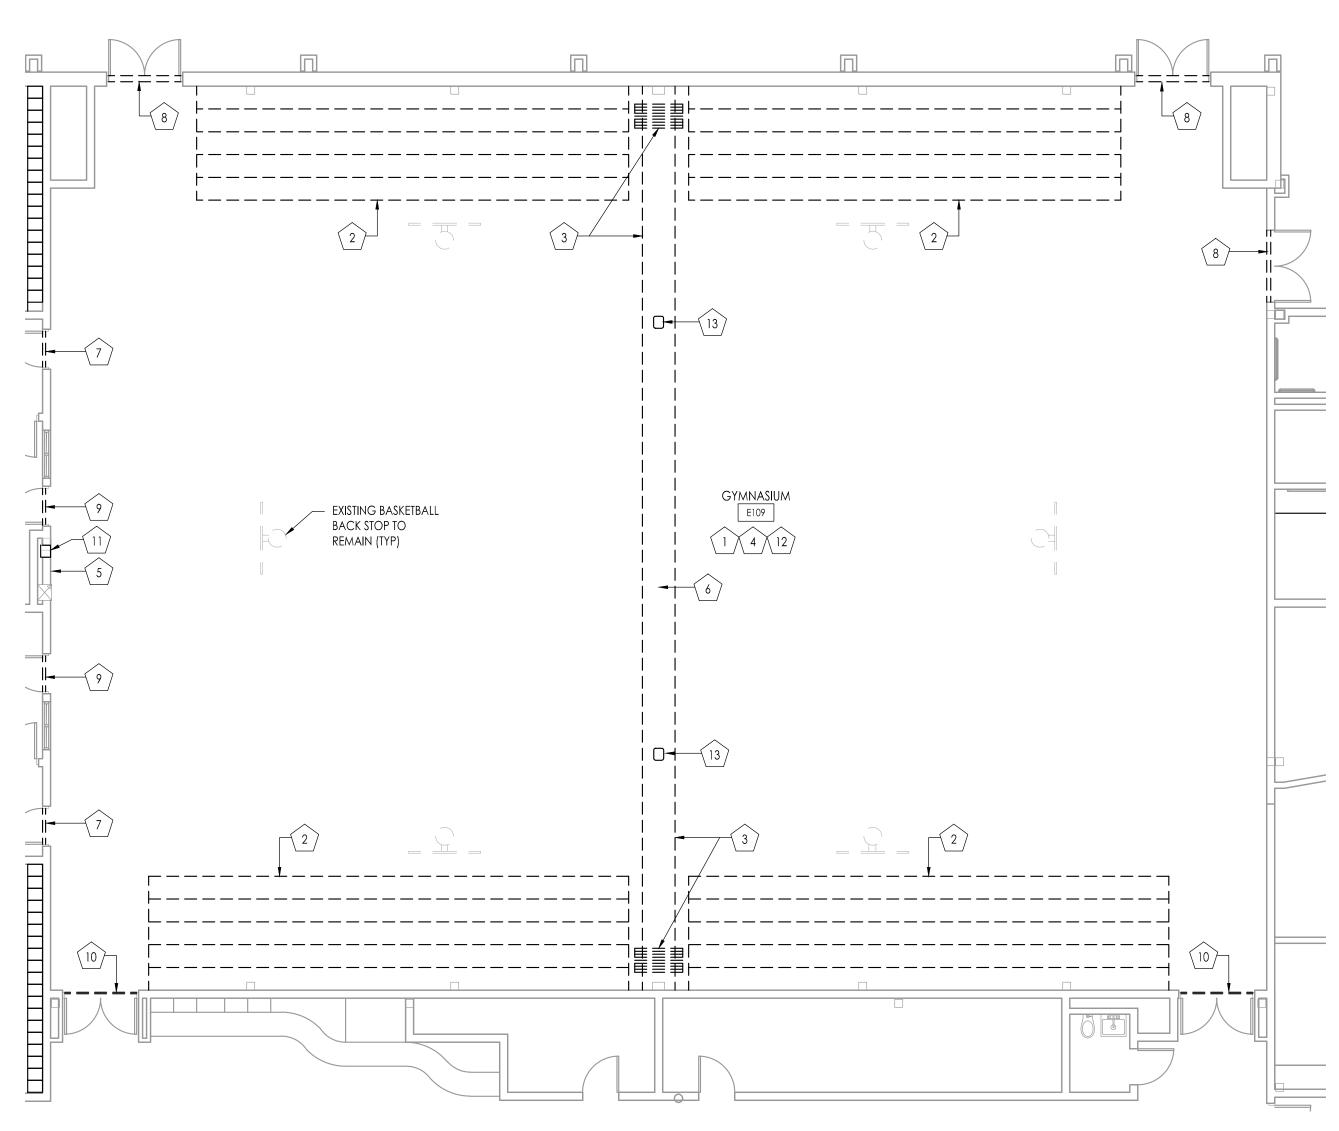

NEW WORK PLAN - GYMNASIUM E109

| EXISTING RETRACTABLE

BASKET BALL BACKSTOP

NOTE: ALL GAME LINES TO

EXISTING F.E. CABINE

- EXISTING DRINKING

FOUNTAIN TO REMAIN

RELOCATED

DRAWINGS

EXISTING STEEL COLUMNS -TO REMAIN - NOTCH NEW

BLEACHERS AROUND

COLUMNS (TYP)

Scale: 1/8" = 1'-0"

CARLISLE FULLY ADHERED EPDM ROOF SYSTEM

20 YEAR WARRANTY

NOVEMBER 7, 2005

THOMAS COMPANY, INC.

PHONE - 609-344-5846

114 NORTH BRIGHTON AVENUE ATLANTIC CITY, NJ 08401

EXISTING ROOFING SYSTEM NOTE:

EXISTING ROOFING SYSTEM WARRANTY:

WILLIAM DAVIES MIDDLE SCHOOL

MANUFACTURER:

ROOFING SYSTEM

DATE OF WARRANTY

INSTALLATION CONTRACTOR

ALL WORK PERFORMED AS PART OF THIS PROJECT THAT IMPACTS

OR MODIFIES THE EXISTING ROOFING SYSTEM IN ANY FORM SHALL

MANUFACTURER SUCH THAT THE EXISTING ROOF WARRANTY IN

BE PERFORMED IN A MANNER APPROVED BY THE ROOFING

PLACE AT THE TIME OF THE WORK SHALL NOT BE VOIDED.

NEW BOTTLE FILL DRINKING FOUNTAIN-REFER TO PLUMBING

BE 2" WIDE. GAME LINE COLORS TO BE SELECTED

BY ARCHITECT

DEMOLITION / NEW CONSTRUCTION NOTES (GYMNASIUM RENOVATIONS): 🖄

FROM EXISTING STRUCTURE ABOVE. BOTTOM OF CURTAIN

STANTIONS (TYP)

STANTIONS (TYP)

ELECTRICAL FLOOR BOXES

MIN. 22'-0" A.F.F.

1. EXISTING GYM FLOOR AND WALL BASE TO BE REMOVED BY OTHERS. GENERAL CONTRACTOR WILL BE RESPONSIBLE FOR PREPARING EXISTING CONCRETE SLAB TO MANUFACTURERS REQUIREMENTS PER THE SPECIFIED NEW FLOOR FINISH.

SEATING CAPACITY 229


NEW MANUALLY OPERATED WOOD BLEACHERS-


- 2. EXISTING MANUALLY OPERATED WOOD BLEACHERS TO BE REMOVED IN THEIR ENTIRETY. PATCH ALL OPENINGS LEFT IN CMU WALL AFTER REMOVAL. INSTALL NEW MANUALLY OPERATED WOOD BLEACHERS. SEE NEW WORK PLAN FOR NEW BLEACHER LAYOUT.
- 3. EXISTING ELECTRICALLY OPERATED FOLDING PARTITION TO BE REMOVED IN IT'S ENTIRETY INCLUDING ALL TRACKS AND SUPPORTING HANGERS. REMOVE EXISTING SOFFIT AND FACIA THAT SURROUNDS Support track in it's entirety. Steel Support Structure to remain, refer to electrical drawings for additional information.
- 4. REMOVE EXISTING RUBBER BASE IN IT'S ENTIRETY. ALL WALLS IN GYMNASIUM TO BE PAINTED FULL HEIGHT BY GENERAL CONTRACTOR. PROVIDE PROTECTION FROM PAINT ON ALL WALL MOUNTED ITEMS PRIOR TO PAINTING. ALL STEEL JOISTS, BRIDGING, BEAMS AND UNDERSIDE OF METAL DECKING TO BE PAINTED BY GENERAL CONTRACTOR. ALL NEW DUCTWORK TO BE PAINTED BY MECHANICAL CONTRACTOR. REFER TO PHOTOGRAPHS ON DRAWING A 104 FOR ADDITIONAL SCOPE OF PAINTING. INSTALL NEW 4" HIGH RUBBER BASE ON ALL WALLS
- 5. NEW IN-WALL WATER BOTTLE FILLING STATION. CUT OPENING IN EXISTING MASONRY TO THE APPROPRIATE WIDTH AND HEIGHT TO ACCOMMODATE FILLING STATION. INSTALL APPROPRIATE SIZE STEEL LINTEL OVER NEW OPENING. INSTALL AT REQUIRED ADA HEIGHT. REFER TO PLUMBING DRAWINGS FOR ADDITIONAL INFORMATION.
- 6. INSTALL NEW ELECTRICALLY OPERATED DROP CURTAIN CENTERED IN GYMNASIUM. SUPPORT DROP CURTAIN FROM EXISTING STEEL STRUCTURE USED TO SUPPORT REMOVED FOLDING PARTITION. SEE
- ELECTRICAL DRAWINGS FOR ADDITIONAL INFORMATION.
- 7. REMOVE EXISTING MARBLE SADDLE IN IT'S ENTIRETY. INSTALL NEW MARBLE ADA SADDLE TO CONFORM TO ALL BARRIER FREE REQUIREMENTS.
- 8. REMOVE EXISTING ALUMINUM DOOR SADDLE IN IT'S ENTIRETY. INSTALL NEW ALUMINUM ADA SADDLE TO MATCH EXISTING. SADDLE TO CONFORM TO ALL BARRIER FREE REQUIREMENTS.
- 9. REMOVED EXISTING WOOD DOOR SADDLE IN IT'S ENTIRETY. INSTALL NEW ALUMINUM ADA DOOR SADDLE TO CONFORM TO ALL BARRIER FREE REQUIREMENTS.
- 10. REMOVE EXISTING RUBBER THRESHOLD IN IT'S ENTIRETY. IN STALL NEW RUBBER ADA THRESHOLD TO MATCH EXISTING TO CONFORM TO ALL BARRIER FREE REQUIREMENTS.
- 11. REMOVE EXISTING RECESSED FIRE EXTINGUISHER CABINET. SAWCUT OPENING IN WALL ADJACENT TO NEW WATER BOTTLE FILLER TO ACCOMMODATE REINSTALLATION OF EXISTING FIRE EXTINGUISHER CABINET AT SAME HEIGHT AS PREVIOUSLY INSTALLED IN WALL. INSTALL APPROPRIATE SIZE STEEL LINTEL OVER NEW OPENING.
- 12. REMOVE EXISTING STRUCTURAL CROSS BRIDGING BETWEEN JOISTS THAT ARE IN CONFLICT WITH NEW DUCTWORK TO BE INSTALLED. ADD NEW STRUCTURAL CROSS BRIDGING IN BAYS WHERE EXISTING DUCTWORK IS TO BE REMOVED. ALL NEW BRIDGING TO BE 2" x 2" x $\frac{1}{8}$ " SECURED TO TOP AND BOTTOM OF STEEL JOISTS.
- 13. REMOVE EXISTING VOLLEYBALL STANITIONS IN THEIR ENTIRETY. PATCH EXISTING HOLE WITH NEW CONCRTET FLUSH WITH EXISTING CONCRETE. CORE DRILL NEW HOLE TO INSTALL NEW VOLLEY BALL
- ALL PLUMBING, MECHANICAL OR ELECTRICAL DISCONNECTS SHALL BE MADE BY THE RESPECTIVE TRADES. ALL EQUIPMENT, DEVICES, FIXTURES, ETC. SHALL BE REMOVED FROM THE SITE BY THE RESPECTIVE CONTRACTOR. NOTE: THE EXISTING FIRE ALARM SYSTEM SHALL NOT BE DIMINISHED NOR SHALL EXISTING FIRE ALARM DEVICES BE REMOVED DURING CONSTRUCTION. ALL DEVICES ARE TO BE PROTECTED FROM DAMAGE DURING CONSTRUCTION.

REFER TO A 101 FOR GENERAL DEMOLITION NOTES

NEW MANUALLY OPERATED WOOD BLEACHERS-


SEATING CAPACITY 218

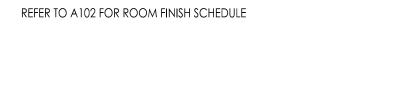

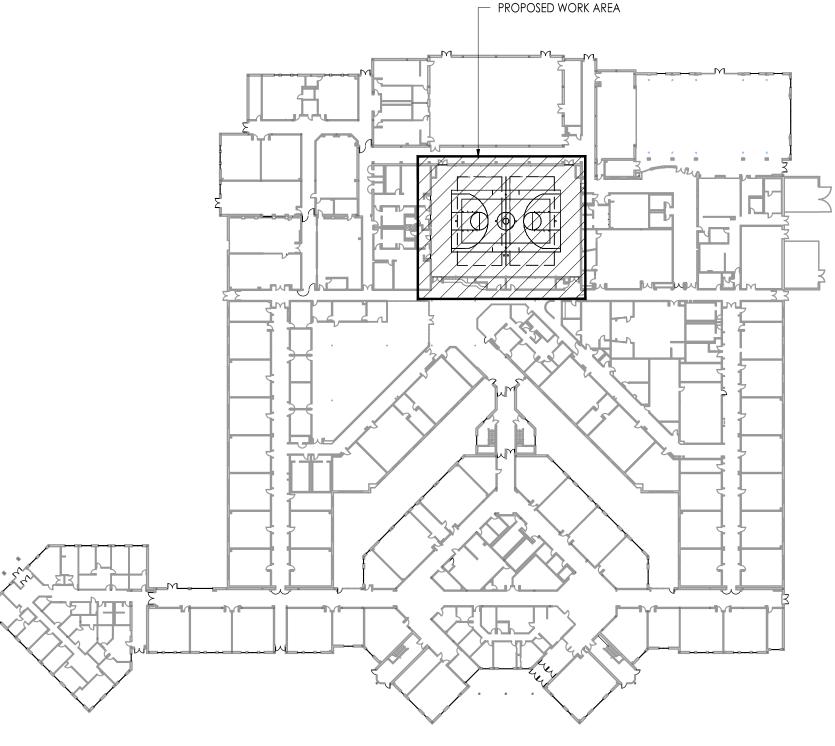

Scale: NOT TO SCALE

DEMOLITION PLAN - GYMNASIUM E109

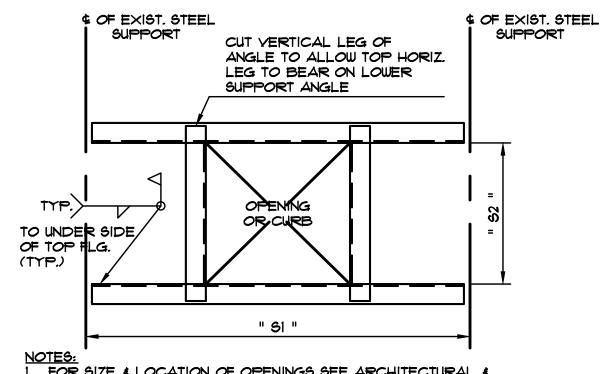


NOTES:

1. FOR SIZE & LOCATION OF OPENINGS SEE ARCHITECTURAL &

- MECHANICAL DRAWINGS. 2. STEEL CONTRACTOR SHALL VERIFY ALL OPENINGS AND EXACT LOCATIONS WITH THE TRADE CONTRACTOR REQUIRING SAID
- OPENINGS PRIOR TO FABRICATION & ERECTION OF STEEL FRAMES. 3. PROVIDE STEEL FRAMES AS SHOWN AROUND ALL REQUIRED OPENINGS LARGER THAN 8" AT ROOF.
- 4. PROVIDE STEEL ANGLES ON ALL SIDES OF OPENINGS UNLESS BEAM IS SHOWN ON PLAN. ANGLE SIZES TO BE:
- FOR "61" OR "62" \leq 6'-6" L-4"×4"×5/16" FOR "61" OR "62" > 6'-6" L-6"x6"x3/8" 5. PROVIDE STEEL ANGLES ON ALL SIDES OF MECH'L CURBS UNLESS
- BEAM IS SHOWN ON PLAN. ANGLE SIZES TO BE L-6"x6"x3/8". 6. FOR SIZE & LOCATION OF MECH'L UNITS, SEE ARCH'L & MECH'L DWGS.


TYPICAL OPNG. DETAIL @ EXIST'G. ROOF # UNDER MECH'L CURB

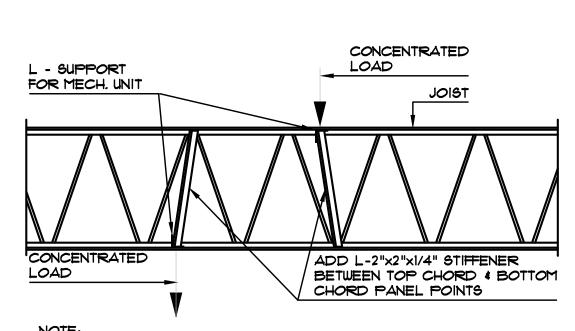

NOTE: SUPPORTING LOAD AT CONDENSERS, MECHANICAL UNITS AND ALL CONCENTRATED LOADS GREATER THAN 300 lbs.


OMIT IF LOAD IS WITHIN 3" OF A PANEL POINT. TYPICAL DETAIL OF REINF'D. JOIST

EXIST. ROOF DECK REMOVE EXISTING CURB $\frac{1}{2}$ " - 20 GA. METAL ROOF DECK. ELEV. TO MATCH EXIST

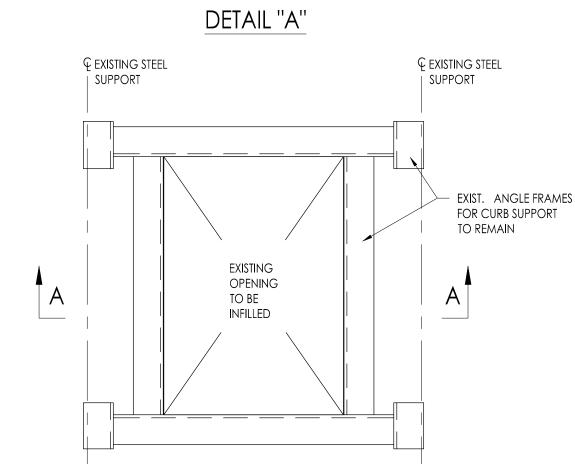


1. PROVIDE $1\frac{1}{2}$ - 20 Ga. Type "B" (WIDE RIB) METAL ROOF DECK (GALV.) INFILL + INSULATION TO MATCH EXIST. ROOF ELEV. @ EXISTING OPENING. PROVIDE MINIMUM 2" BEARING FOR NEW DECK. 2. PROVIDE TEK SCREW FASTENERS @ EACH DECK FLUTE. 3. IF EXISTING CONDITIONS DIFFER FROM THOSE ON PLAN, CONTACT ARCH. OR ENGINEER.

STEEL DECK INFILL DETAIL

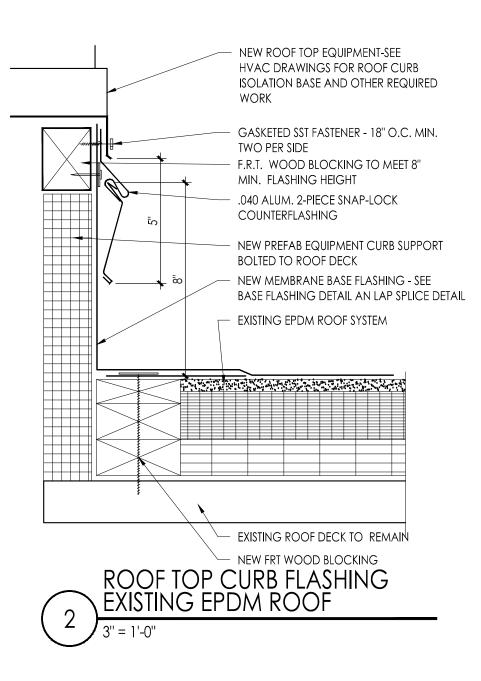

PRIOR TO SEAM TAPE INSTALLATION PRIME SPLICE AREAS 2. OVERLAP ENDS OF CUT PIECES A MINIMUM OF 1" 3. LAP SEALANT IS TO COVER THE EDGE OF SEAM TAPE EXISTING EPDM ROOFING SYSTEM EXISTING INSULATION -3" SEAM TAPE 6" COVER STRIP - $1\frac{1}{2}$ " APPROX. EXISTING ROOF DECK TO REMAIN

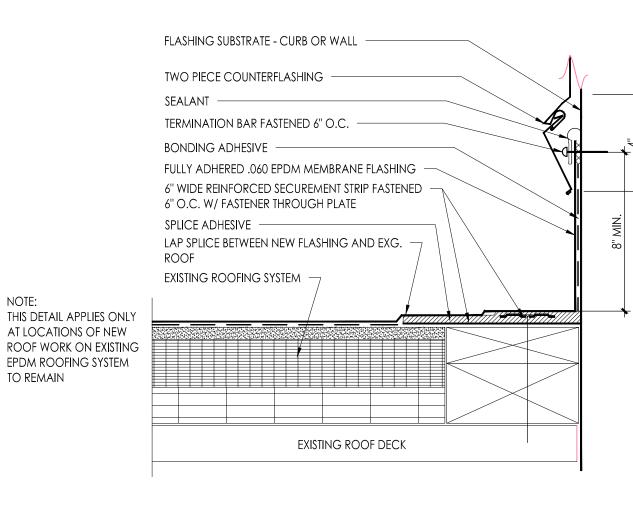

BUILDING KEY PLAN

ALTERATIONS AND RENOVATIONS TO WILLIAM DAVIES MIDDLE SCHOOL

Project Owner Name HAMILTON TOWNSHIP BOARD OF EDUCATION

Project Location 1876 DENNIS FORMAN DR MAYS LANDING, NJ 08330


Project Number 4937C Project Date 02.15.2019 Checked By Drawn By

Scale

AS NOTED

Drawing Name GYMNASIUM DEMOLITION PLAN, NEW WORK PLAN, DETAILS

No. Date Description

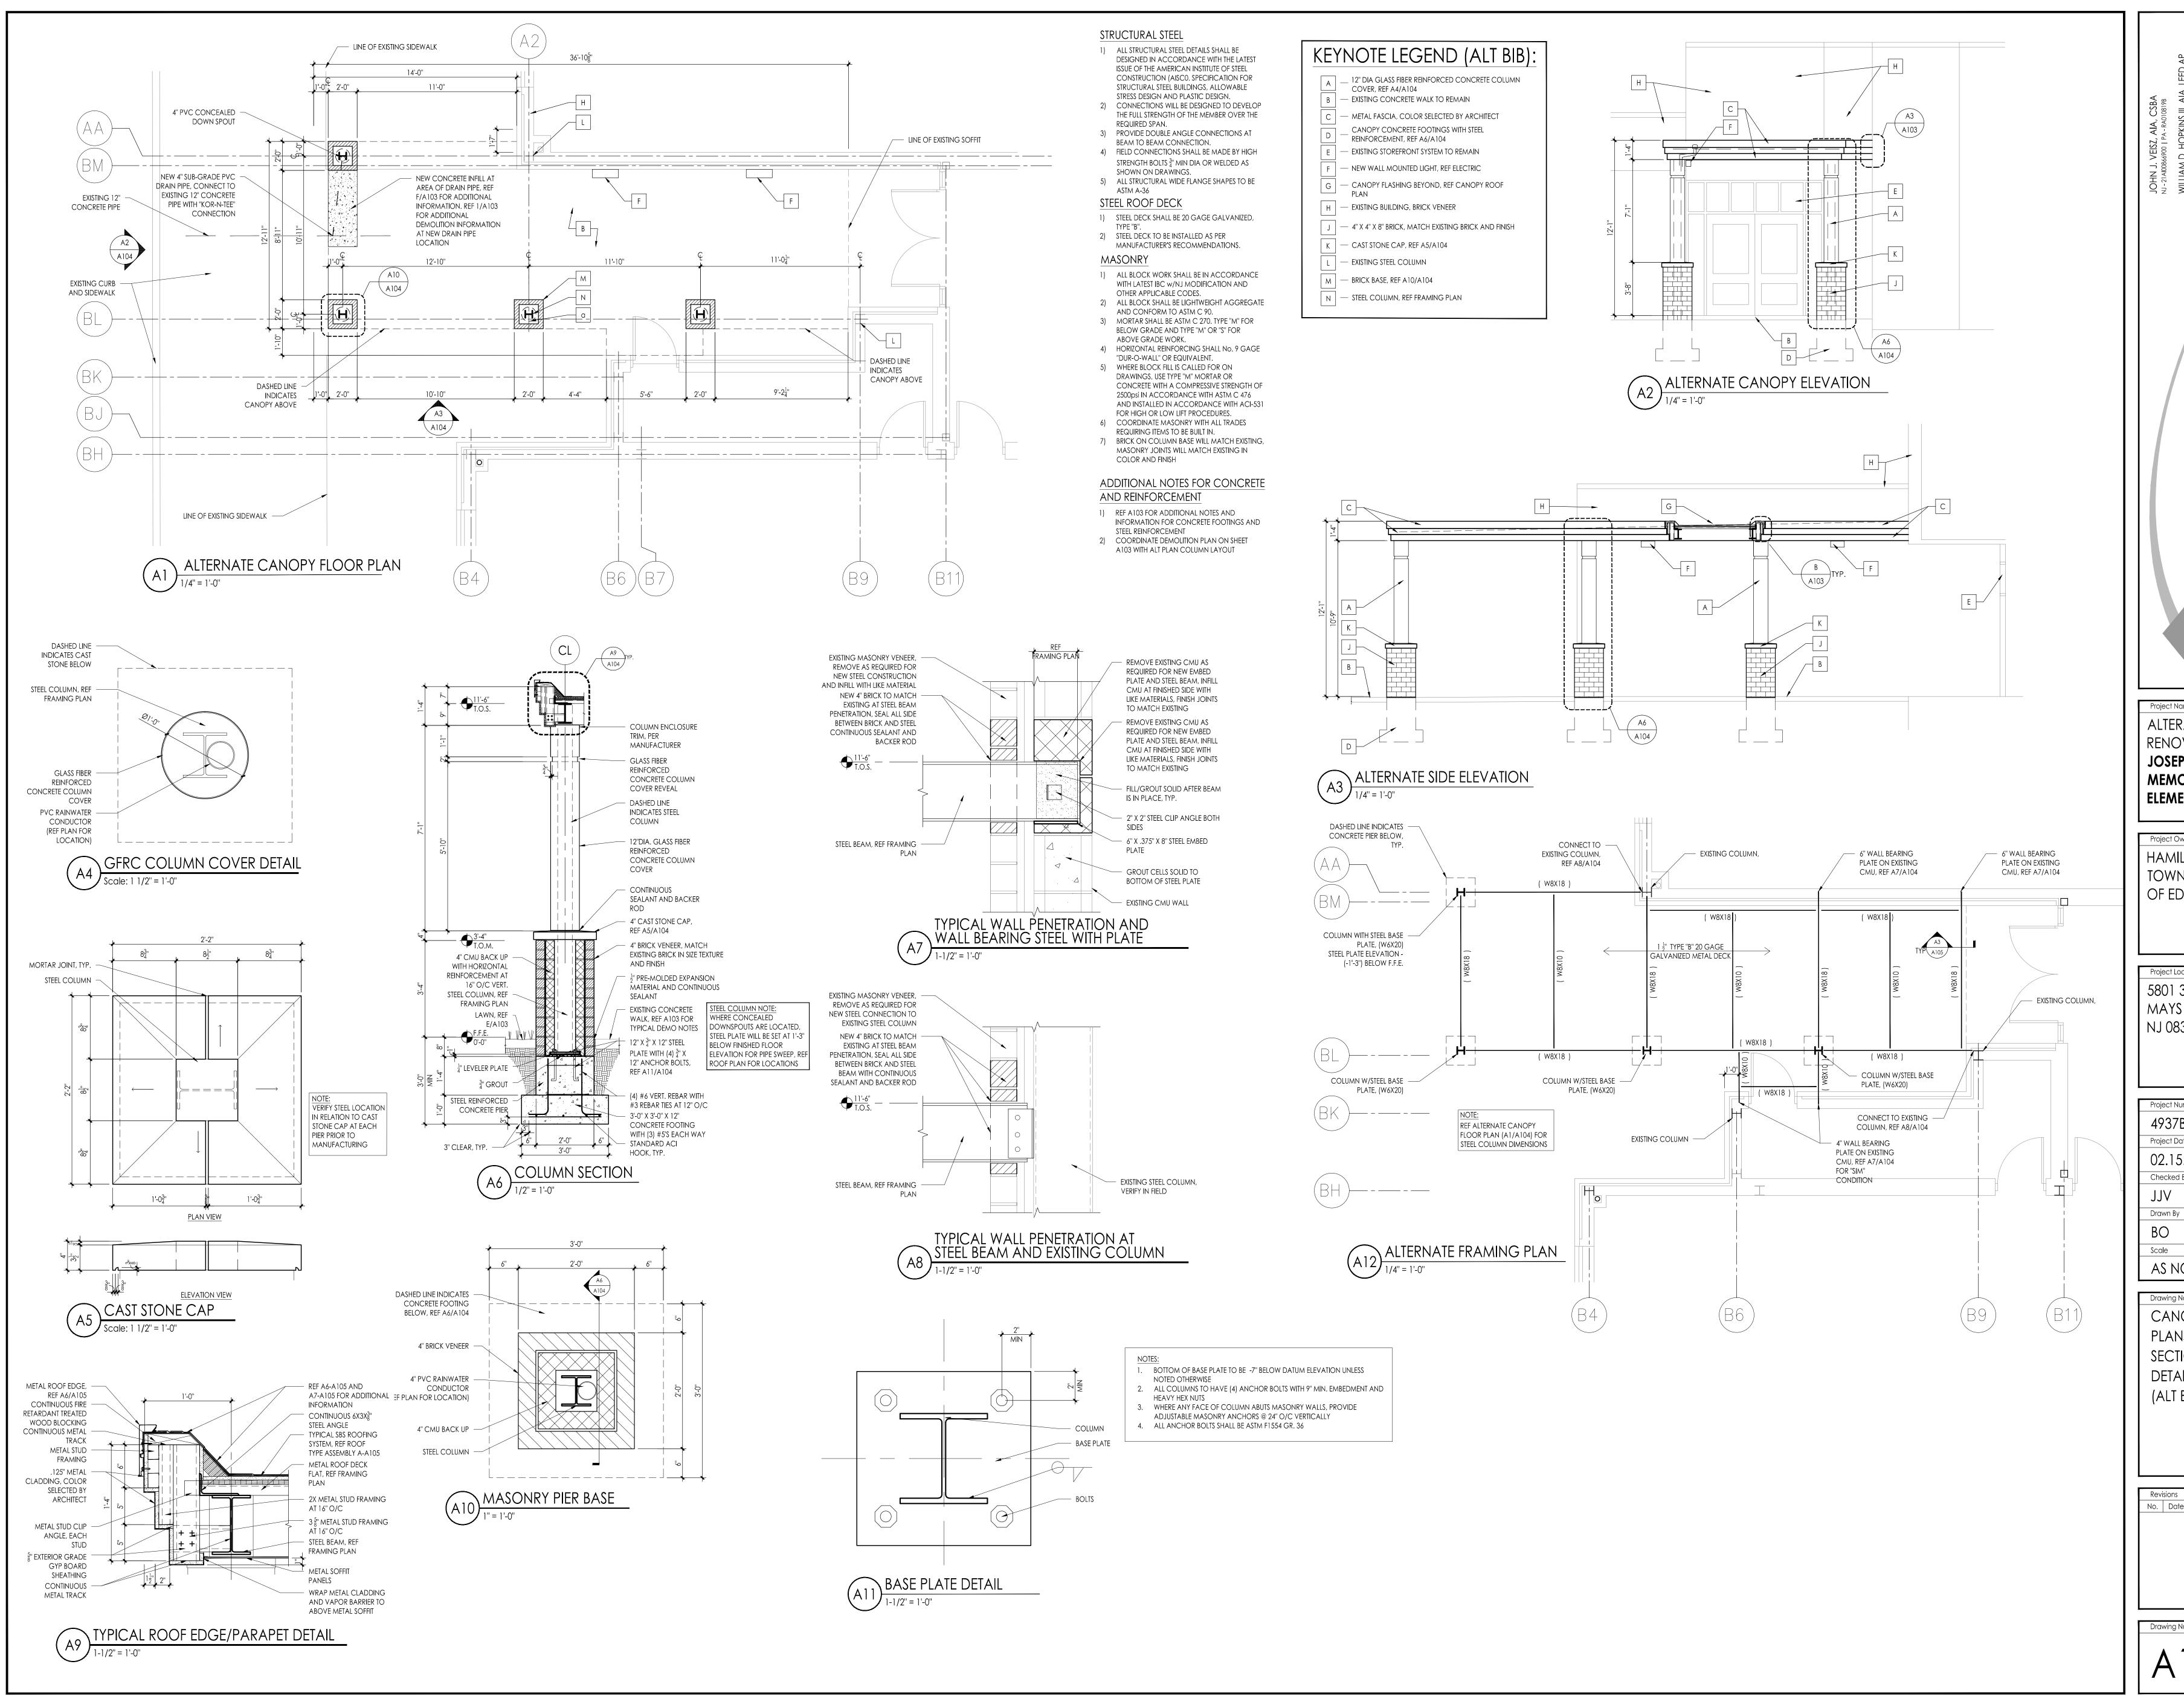

Project Owner Name HAMILTON TOWNSHIP BOARD OF EDUCATION

Project Location


5801 3rd ST MAYS LANDING, NJ 08330

Project Number 4937B Project Date 02.15.2019 Checked By

Scale AS NOTED


Drawing Name CANOPY PLANS SECTIONS AND DETAILS (ALT BID)

No. Date Description

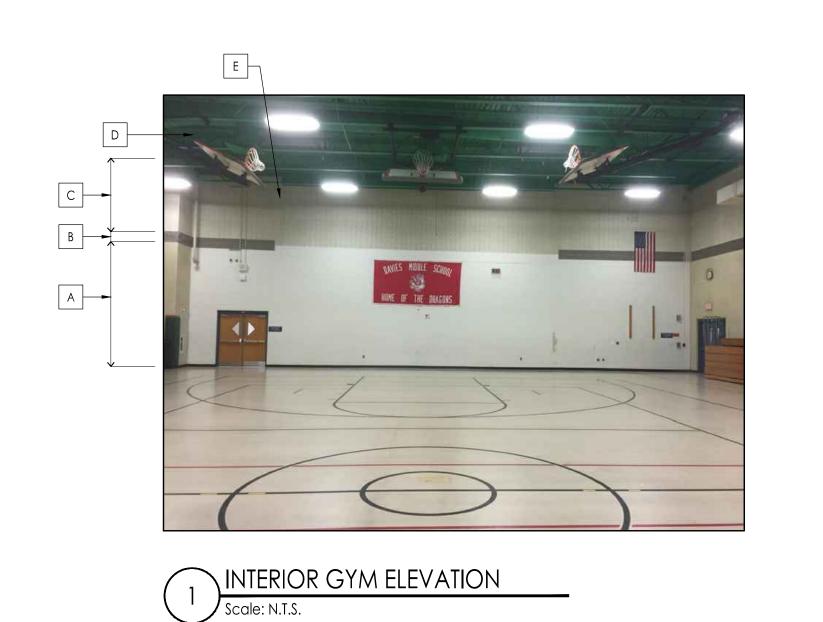





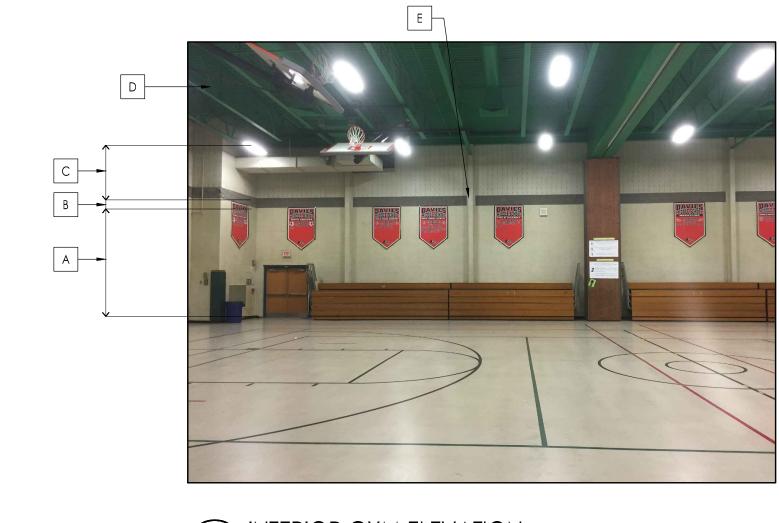

A COLOR #1 - EXISTING CMU WALL

E COLOR #5 - COLUMN COVERS OR FACE OF STEEL COLUMNS NOTE: ALL NEW DUCTWORK TO BE PAINTED BY MECHANICAL CONTRACTOR - COLOR DETERMINED BY ARCHITECT

PAINTING SCHEDULE:

B COLOR #2 - EXISING ARCHITECTURAL CMU - PAINT C COLOR #3 - EXISTING SOUND BLOCK

D COLOR #4 - EXISTING METAL DECK, BEAMS, AND JOISTS

ALTERATIONS AND RENOVATIONS TO WILLIAM DAVIES MIDDLE SCHOOL

Project Owner Name HAMILTON TOWNSHIP BOARD OF EDUCATION

Project Location 1876 DENNIS FORMAN DR MAYS LANDING, NJ 08330

Project Number

4937C Project Date 02.15.2019

Checked By Drawn By JMK

AS NOTED

Drawing Name INTERIOR GYM ELEVATONS


Revisions
No. Date Description










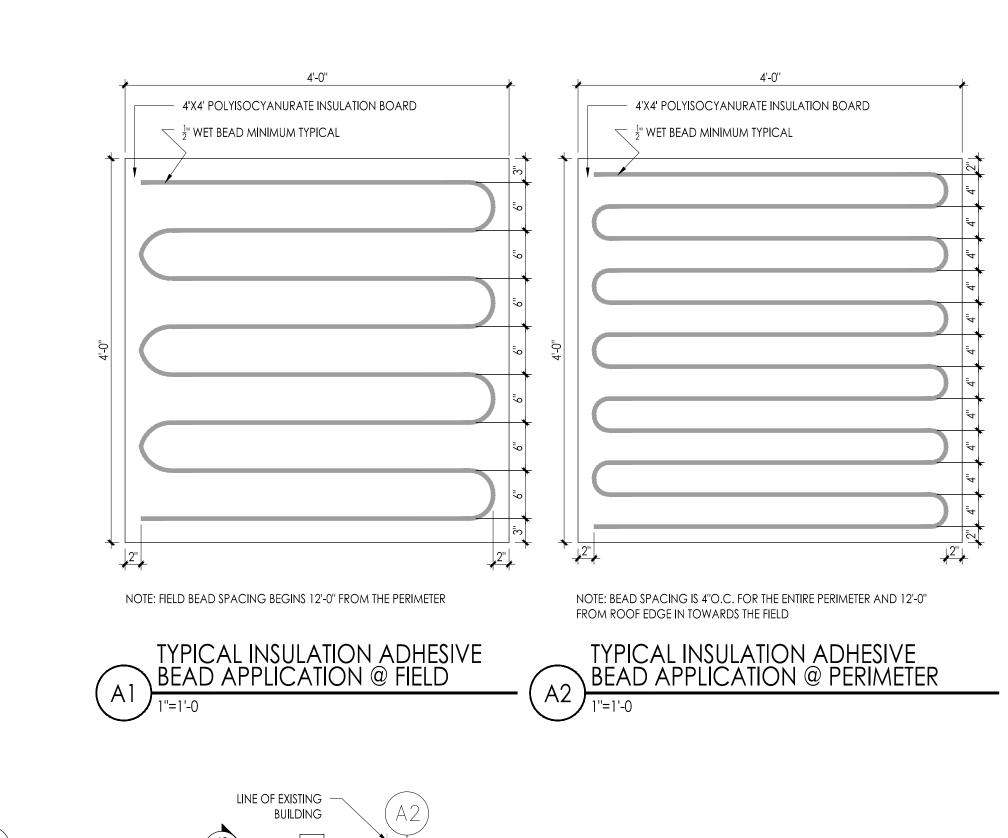

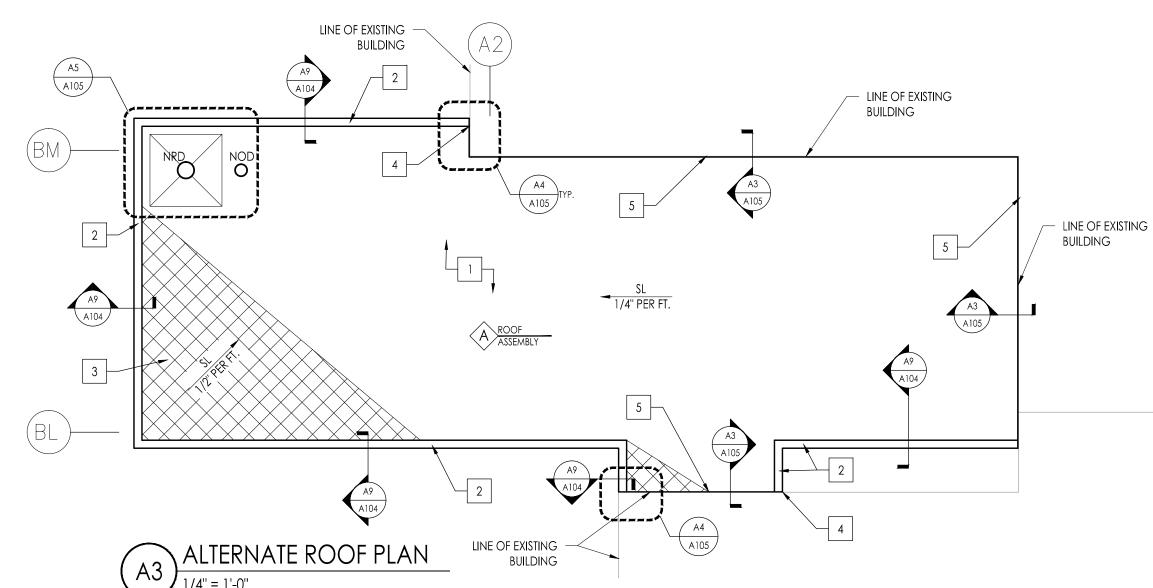

SBS GRANULE SURFACED 2 PLY MEMBRANE ROOFING SYSTEM SET IN SBS ADHESIVE AS PER MANUFACTURERS RECOMMENDATIONS ½"x4'x4' THERMAL BARRIER BOARD ADHERED IN INSULATION ADHESIVE MEETING FACTORY MUTUAL REQUIREMENTS FOR A MINIMUM OF I-90. OFFSET JOINTS FROM PRECEDING INSULATION LAYER A MIN. OF 6" 4'x4' TAPERED HIGH-THERMAL POLYISOCYANURATE INSULATION $\frac{1}{4}$ " PER FOOT SLOPE ADHERED IN INSULATION ADHESIVE MEETING FACTORY MUTUAL REQUIREMENTS FOR A MINIMUM OF I-90. OFFSET JOINTS FROM PRECEDING INSULATION LAYER A MIN. OF 6" - 2.5"x4'x4' HIGH-THERMAL FLAT POLYISOCYANURATE INSULATION MECHANICALLY FASTENED TO ROOF DECK. FASTENING AND INSULATION PATTERN MUST MEET OR EXCEED FACTORY MUTUAL REQUIREMENTS FOR A MIN. OF I-90 STAGGER ALL JOINTS A MINIMUM OF 6" STEEL ROOF DECK FLAT, REF STEEL DECK NOTES

CANOPY ROOF

GENERAL CONSTRUCTION AND DEMOLITION NOTES:

A. PROVIDE ROOFING MATERIALS THAT COMPLY WITH A CLASS "A" SYSTEM.

F. DO NOT SCALE THE DRAWINGS.

O. NOT USED

- B. ALL WORK PERTAINING TO THESE DRAWINGS SHALL BE PERFORMED IN ACCORDANCE WITH ALL APPLICABLE STATE AND LOCAL CODES AND WITH ALL AGENCIES HAVING JURISDICTION. C. INSTALL WATER DIVERTING CRICKETS AS SHOWN ON PLAN.
- D. FRT WOOD BLOCKING SHOWN ON DRAWINGS IS DIAGRAMMATIC. PROVIDE FIRE RETARDANT TREATED WOOD BLOCKING CONSTRUCTION IN THICKNESS AND HEIGHT TO MATCH THICKNESS OF INSULATION AND/OR TAPERED INSTALLATION AS RECOMMENDED BY ROOFING MANUFACTURER AND TO MAINTAIN A CONSTANT ROOF EDGE ELEVATION IN A HORIZONTAL PLANE UNLESS NOTED OTHERWISE. E. ALL CONDITIONS MEETING THE ROOF SURFACE PERPENDICULAR MUST HAVE A MINIMUM 8" FLASHING HEIGHT.
- G. ALL LOW SLOPED ROOF AREAS ARE $\frac{1}{4}$ " PER FOOT IN THE FIELD AND $\frac{1}{2}$ " PER FOOT AT THE CRICKETS. SLOPE OF CRICKET IS PERPENDICULAR TO CRICKET VALLEY LINE. H. THE ROOFING CONTRACTOR IS RESPONSIBLE FOR FOLLOWING ALL GOOD ROOFING PRACTICES INCLUDING THOSE
- SET FORTH BY THE ROOFING MATERIALS' MANUFACTURER, THE SMACNA SHEET METAL MANUAL, FACTORY MUTUAL, UNDERWRITERS LABORATORIES, AND THE NRCA'S ROOFING AND WATERPROOFING MANUAL. NOT USED
- 2. INSTALL ENVELOPE EDGES TO ELIMINATE THE POTENTIAL FOR BITUMEN AND ADHESIVE DRIPPAGE INTO THE BUILDING 3. ALL WOOD BLOCKING TO BE FRT, (FIRE RETARDANT LUMBER). K. CONTRACTOR SHALL AT ALL TIMES HAVE A FULL SET OF DRAWINGS AND SPECIFICATIONS ON ROOF TOP WHILE
- L. CONTRACTOR RESPONSIBLE TO RECTIFY ANY PONDING WATER ON FINISHED ROOF SURFACE THAT REMAINS AFTER
- 48 HOURS AT NO ADDITIONAL COST .
- M. DETAILS NOTED TYPICAL "TYP" IMPLY ALL SUCH CONDITIONS BE TREATED SIMILARLY.

J. 1. PRIME ALL SURFACES WHICH ARE TO RECEIVE BITUMINOUS ROOFING.

- P. UNDER NO CIRCUMSTANCES SHALL TORCH BASE FLASHING BE DIRECTLY APPLIED TO A COMBUSTIBLE SURFACE. PROVIDE A THERMAL BARRIER BOARD, OR SBS BASE PLY AS A BASE FOR ALL TORCH APPLICATIONS TYPICAL. Q. THE ROOFING CONTRACTOR SHALL BE RESPONSIBLE TO PERFORM HIS DEMOLITION CAREFULLY CAUSING NO DAMAGE TO EXISTING MATERIALS. ANY EXISTING FINISHES OR CONSTRUCTION DAMAGED BY THE ROOFING CONTRACTOR WILL BE HIS RESPONSIBILITY TO REPAIR TO THE SATISFACTION OF THE ARCHITECT AT NO ADDITIONAL COST TO OWNER. PRIOR TO THE COMMENCEMENT OF WORK, ARCHITECT & ROOFING CONTRACTOR WILL INSPECT PROJECT AND NOTE EXISTING DAMAGES TO FINISHES OR CONSTRUCTION.
- R. NOT USED S. THE ROOFING CONTRACTOR SHALL COORDINATE ALL DUMPSTER STAGING AND TRUCK ROUTES WITH THE GC. THE ROOFING CONTRACTOR SHALL PROTECT ALL EXISTING PAVED AND PLANTED AREAS. THE GC SHALL REPAIR ANY PAVED OR PLANTED AREAS TO THE SATISFACTION OF THE OWNER. THE REPAIRS ARE TO INCLUDE, BUT ARE NOT LIMITED TO, REPAVING OF ASPHALT DRIVEWAYS AND PARKING LOTS, REGRADING AND SEEDING OF LAWN AND PLAYGROUND AREAS AND REPLACING DAMAGED PLANTS, SHRUBS, ETC. ALL REPAIRS AND RESTORATIONS SHALL BE DONE AT NO ADDITIONAL COST IN THE CONTRACT PRICE.

T. ALL TAGGED DETAILS ARE TYPICAL FOR THE ITEM OR SYSTEM INDICATED. THE SCOPE OF WORK INDICATED AS PART OF THE


- TAG OR DETAIL MARK SHALL APPLY TO ALL OTHER SIMILAR SYMBOLS OR ITEMS. U. THE EXG BUILDING IS OCCUPIED. THE ROOFING CONTRACTOR IS SOLELY RESPONSIBLE FOR ALL MEANS
- AND METHODS OF CONSTRUCTION AND FOR THE SAFETY OF ALL PERSONS AT THE PROJECT SITE. V. FOR PURPOSES OF THIS PROJECT, REMOVE SHALL MEAN REMOVE AND DISPOSE OF SAME OFF SITE IN AN APPROVED AND LEGAL MANNER.
- W. THE TERM 'TYP' FOLLOWING A NOTE, TAG, OR DETAIL FLAG INDICATED THAT ALL LIKE, SIMILAR, OR INDICATED ITEMS SHALL BE PROVIDED WITH THE SPECIFIED DETAIL, NOTE, OR SPECIFICATION.
- X. REFERENCE DETAILS A1/A105 AND A2/A105 FOR TYPICAL ADHESIVE BEAD DETAILS FOR THE FIELD AND EDGE OF ROOF


ROOF SYMBOLS FLASHING DETAIL AND DRAWING CONSTRUCTION NOTE FOR SBS DIRECTION OF ROOF SLOPE 1" PER FOOT SLOPED TAPERED **INSULATION CRICKETS**

ROOF ASSEMBLY TYPE


CONSTRUCTION/DEMOLITION NOTES - SBS

- INSTALL ROOF PER ASSEMBLY NOTED ON PLAN AND SPECIFICATIONS. INSTALL WATER DIVERTING SADDLES/CRICKETS WHERE SHOWN ON PLANS WITH TAPERED INSULATION MINIMUM 1\2" PER FOOT SLOPE - SLOPE IS PERPENDICULAR TO SADDLE/CRICKET VALLEY LINE. DO NOT WALK OR RUN EQUIPMENT UPON NEWLY APPLIED ROOFING PLIES UNTIL THE ADHESIVE HAS SET UP TO ELIMINATE THE POTENTIAL FOR VOIDS.
- INSTALL METAL EDGE SYSTEM, COLOR SELECTED BY ARCHITECT. INSTALL NEW WOOD BLOCKING, AS INDICATED IN ROOF EDGE DETAIL. EXTEND SMOOTH BASE PLY OF ROOF SYSTEM DOWN THE FACE OF WOOD AND OVER TOP OF FASCIA BOARD METAL. INSTALL WATER CANT DAM AND STRIP WITH SMOOTH BASE PLY. INSTALL BASE FLASHING SYSTEM FROM THE ROOF UP AND OVER WATER CANT DAM. INSTALL METAL FASCIA AND EXTENDER SO THAT THE OUTSIDE VERTICAL LEG OF THE PERIMETER METAL FLASHINGS EXTEND DOWN PAST THE TOP EDGE OF THE TOP OF METAL CLADDING BY 1". METAL EDGE SYSTEM MUST BE INCLUDED IN MANUFACTURER'S WARRANTY.
- 3 2 PER FOOT SLOPED TAPERED INSULATION CRICKET
- TERMINATION OF METAL COPING AT RISING WALL, REF A4/A105 FOR "SIM" CONDITION
- 5 EXISTING RISING WALL

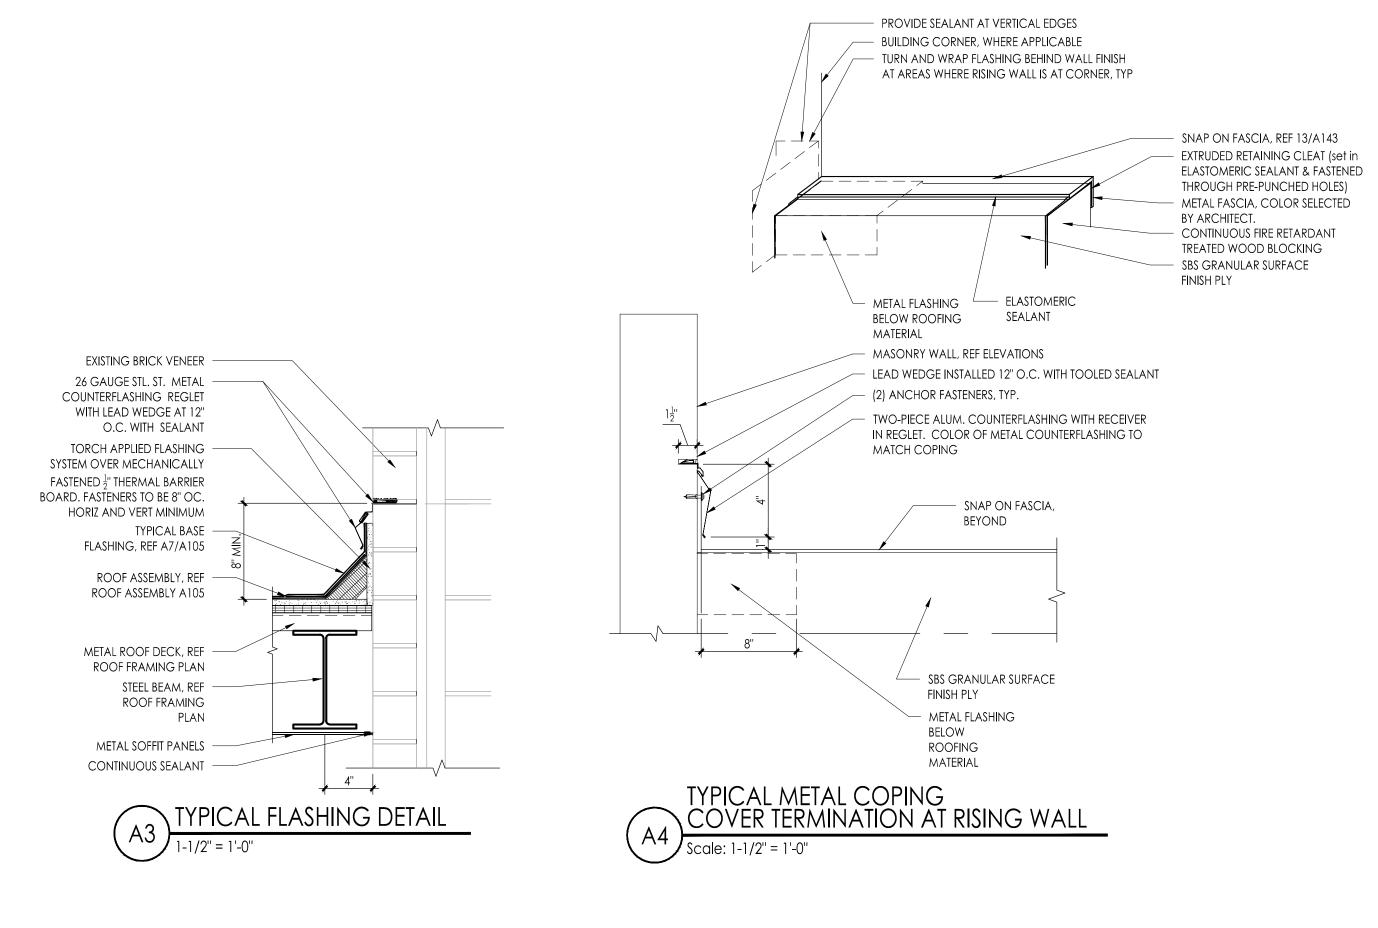

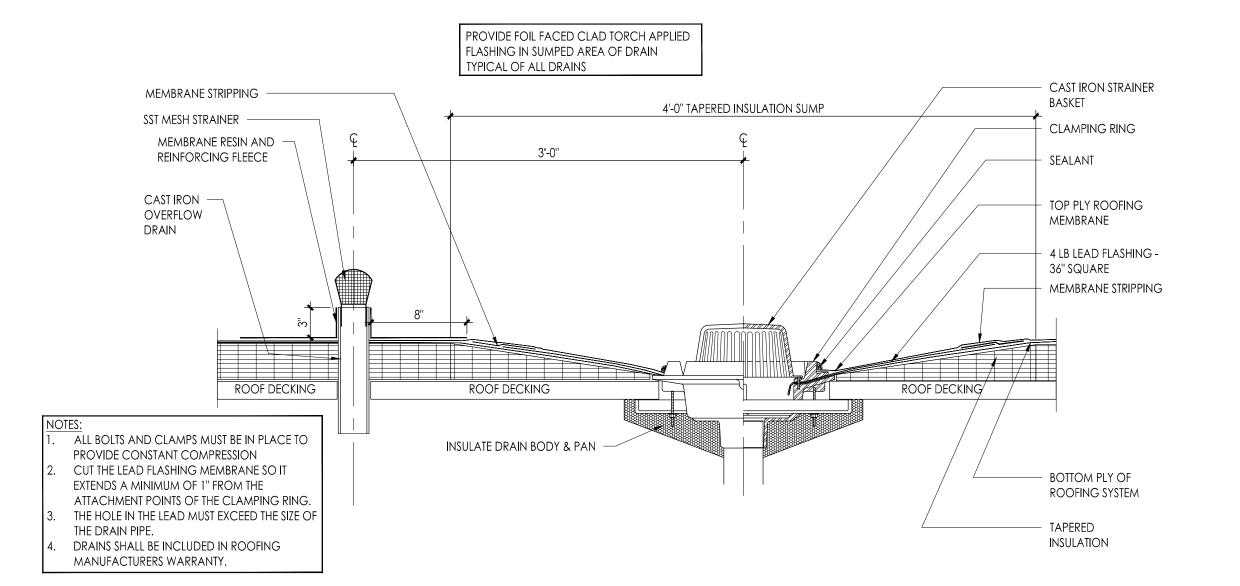



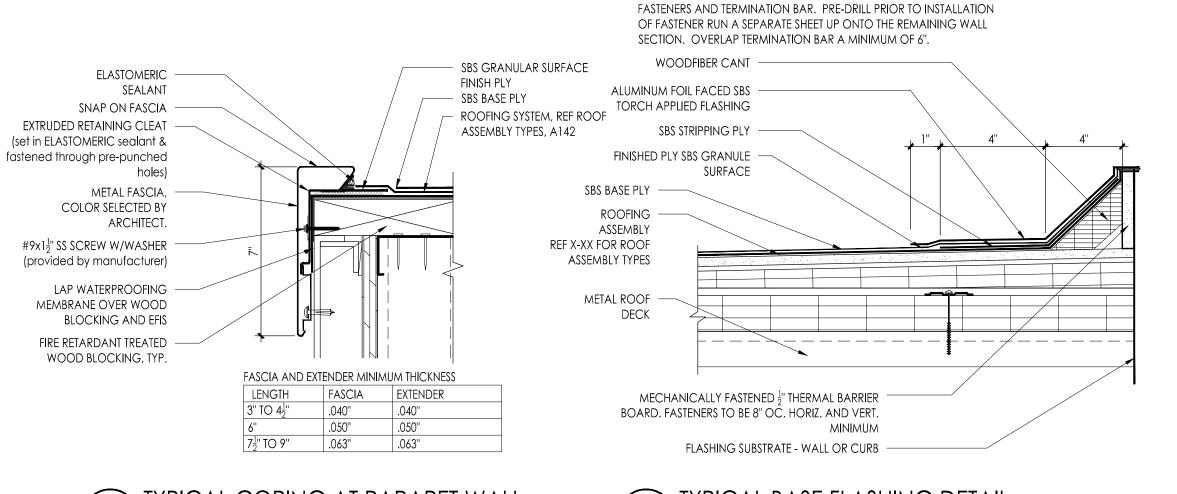





WHERE BASE FLASHING IS HIGHER THAN 24", TERMINATE SHEET WITH

RENOVATIONS TO **JOSEPH C. SHANER MEMORIAL ELEMENTARY SCHOOL** Project Owner Name HAMILTON TOWNSHIP BOARD

ALTERATIONS AND


Project Location 5801 3rd ST MAYS LANDING,


NJ 08330


OF EDUCATION

Project Number 4937B Project Date 02.15.2019 Checked By Drawn By Scale AS NOTED

> Drawing Name ALTERNATE CANOPY **ROOF PLAN** NOTES AND DETAILS

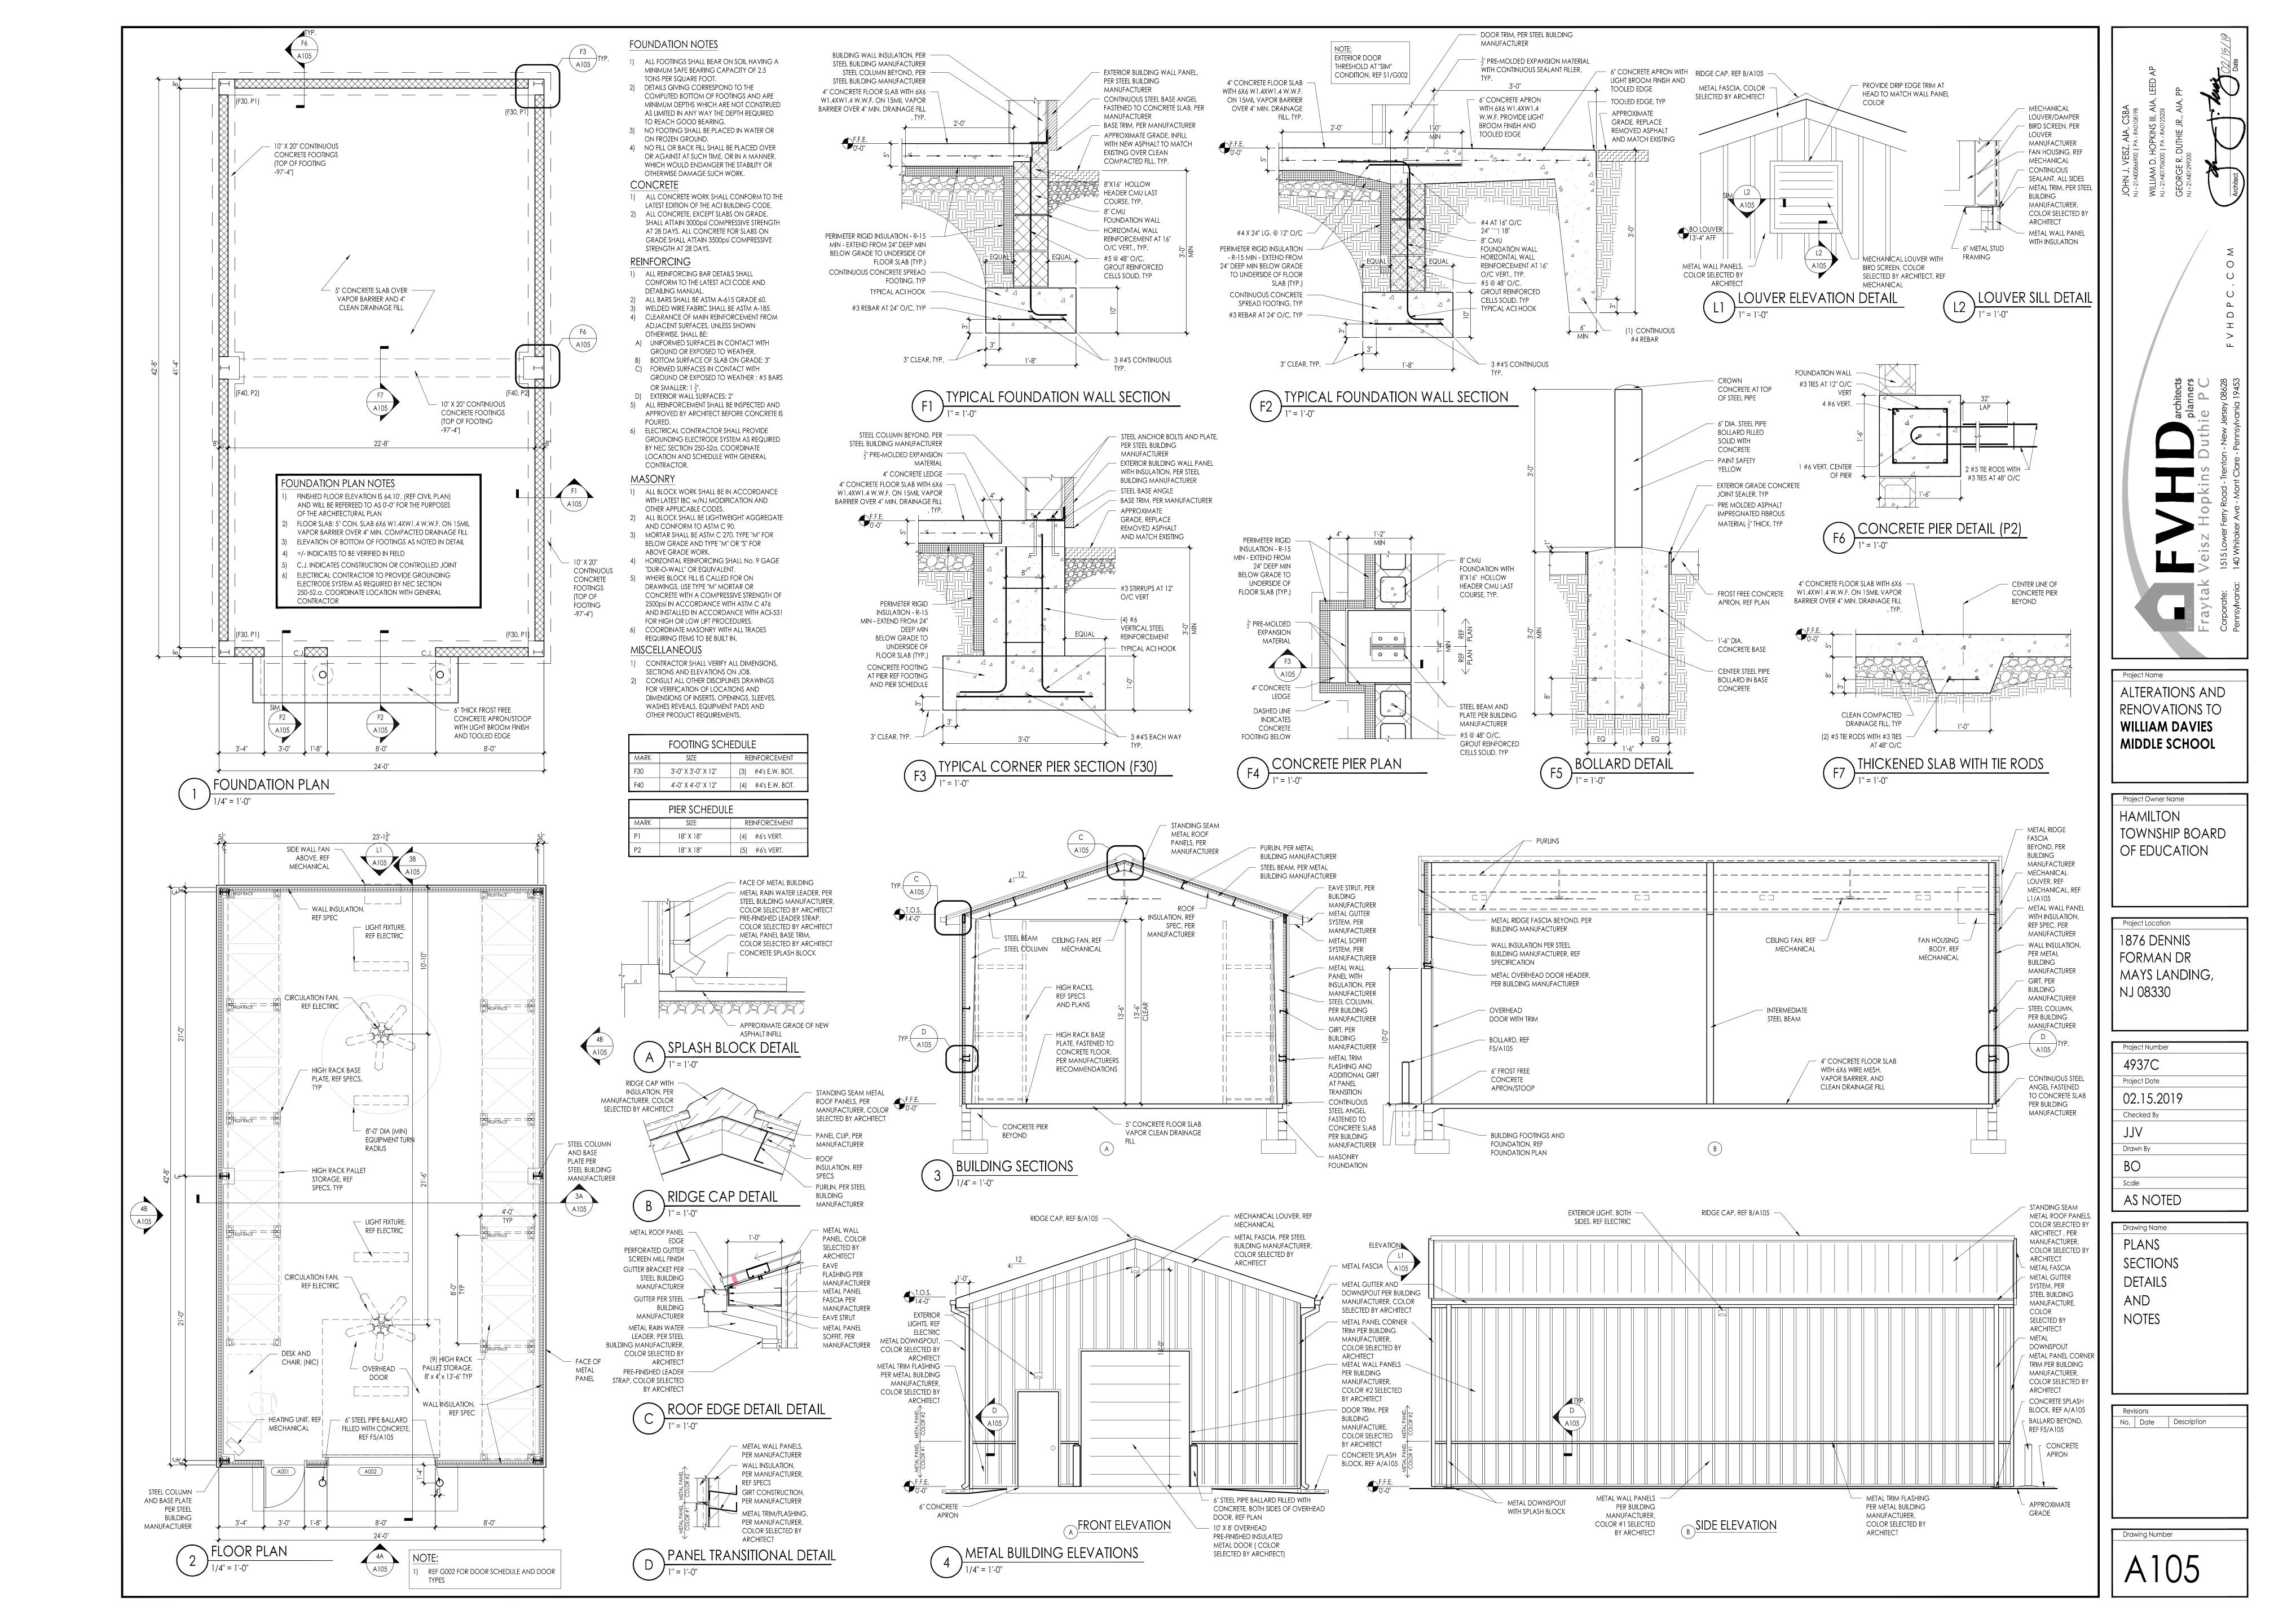

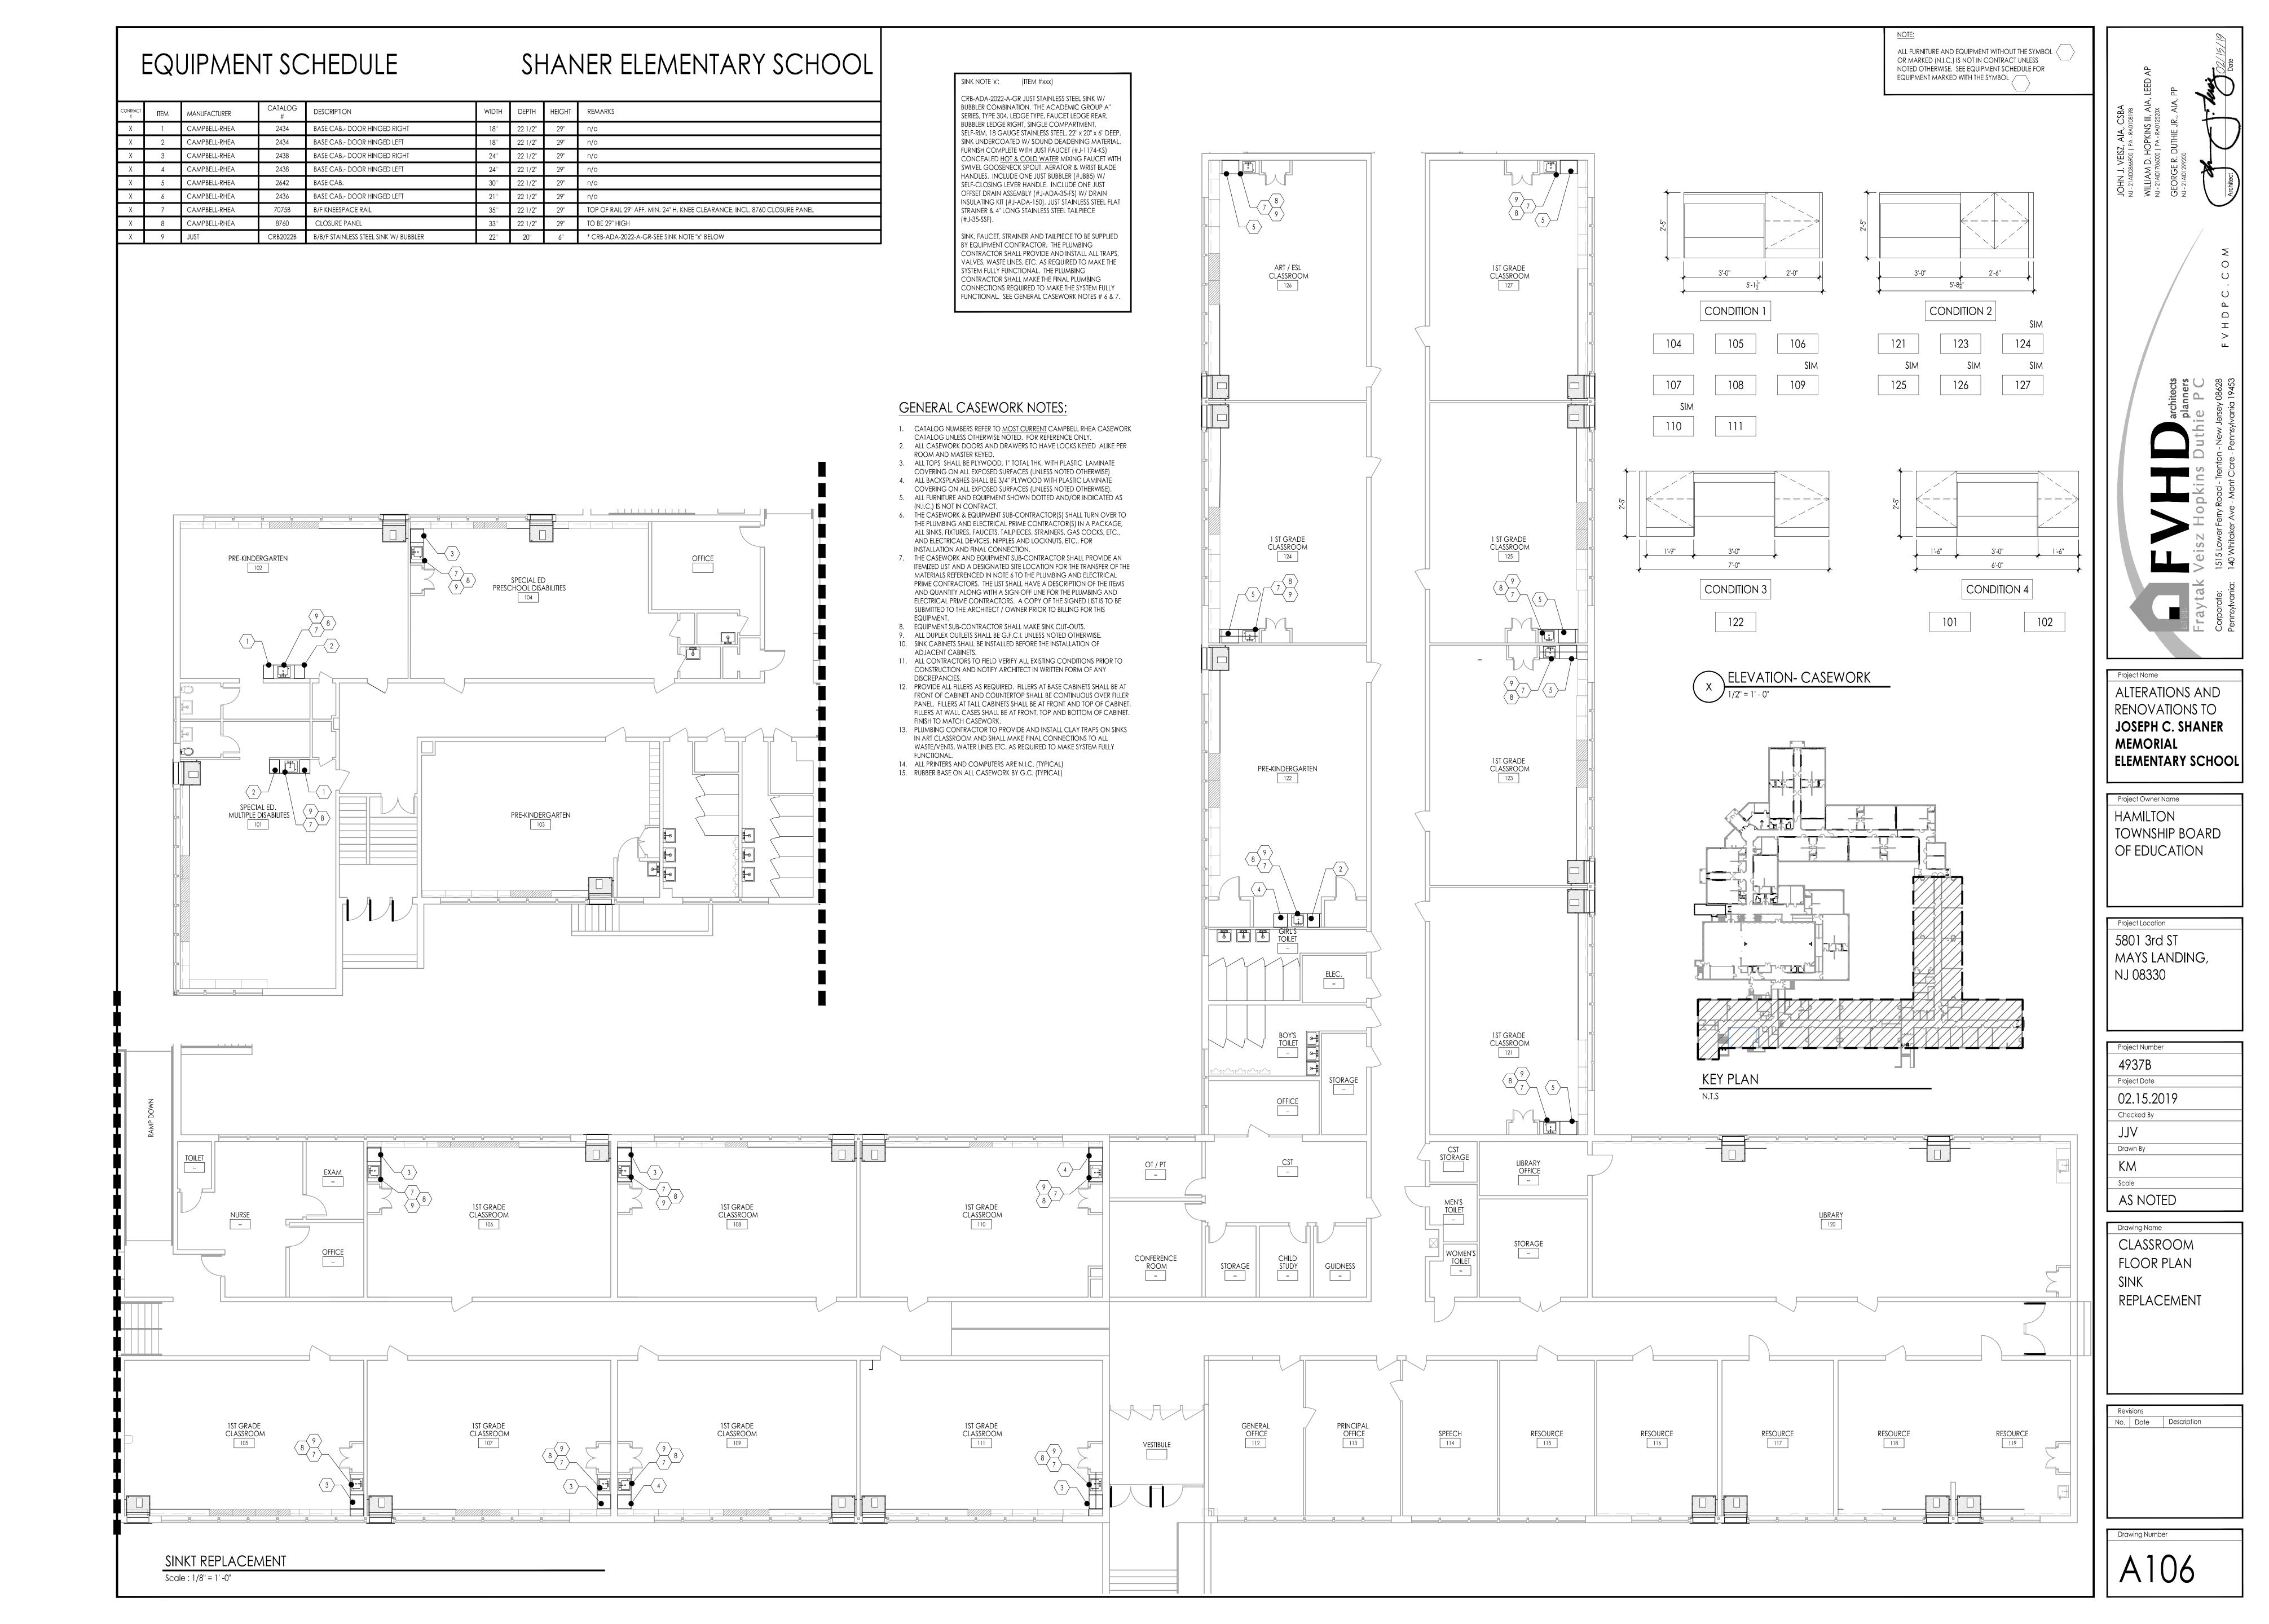

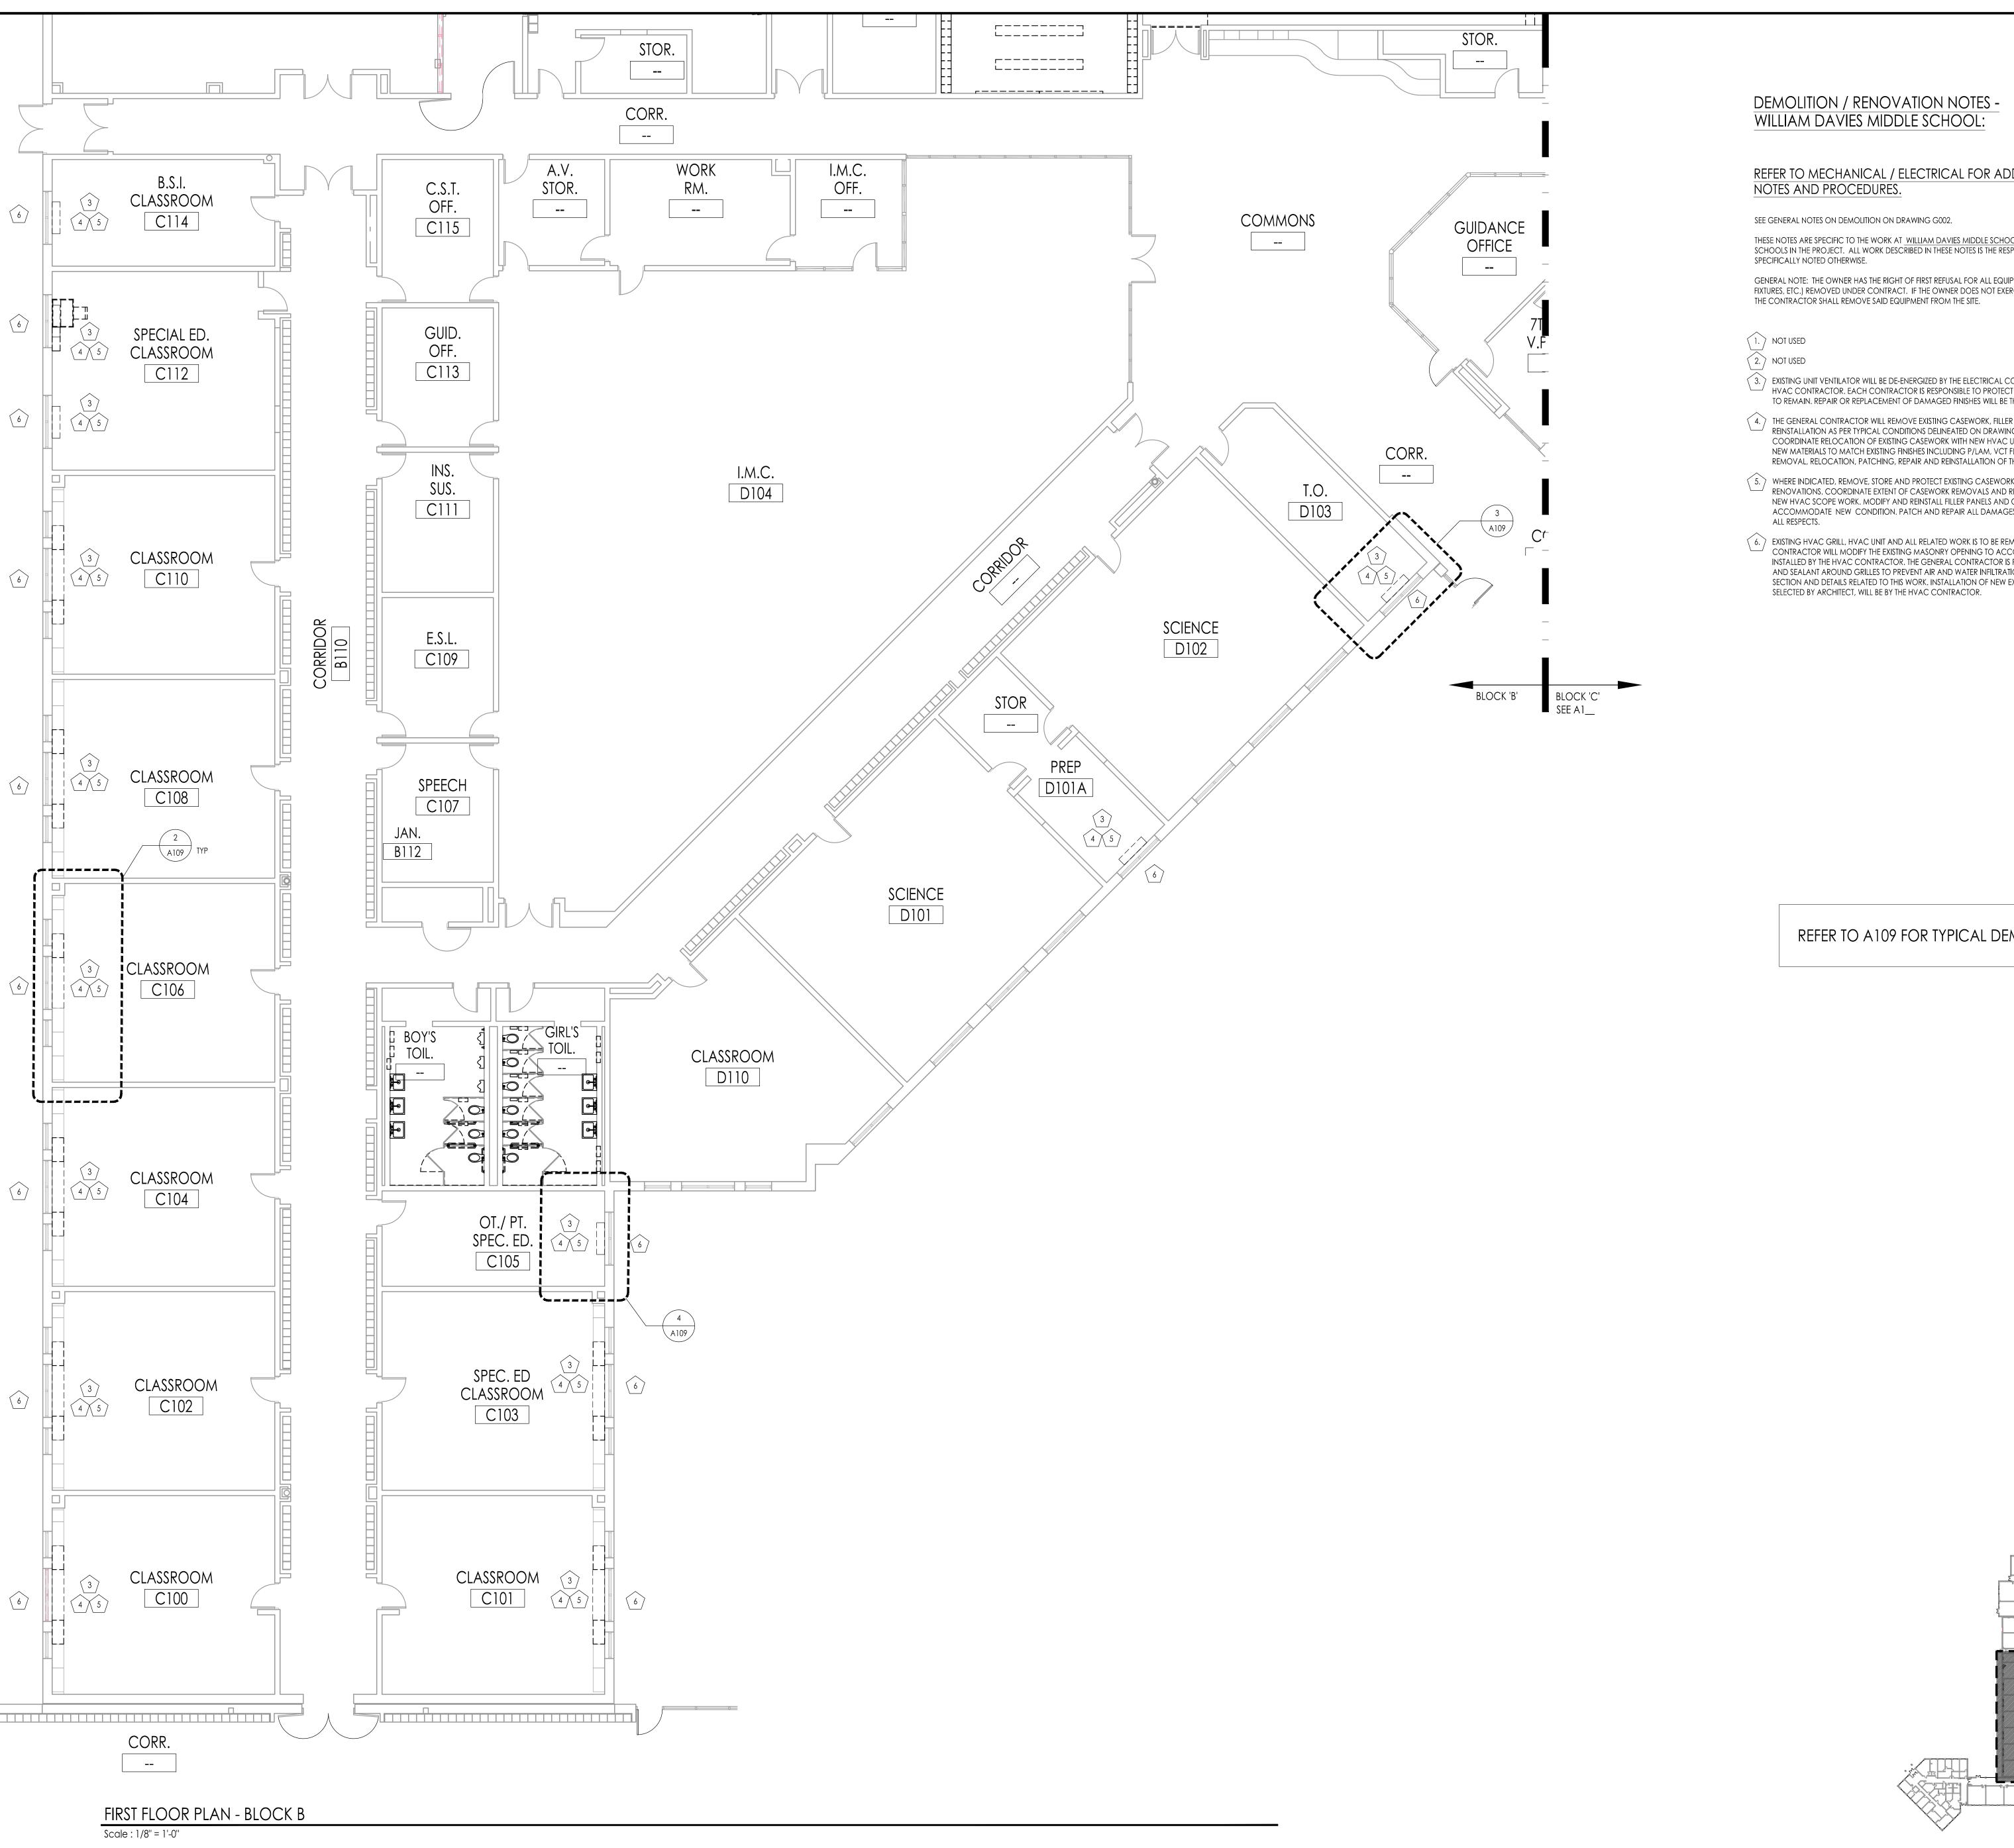

REFER TO MECHANICAL / ELECTRICAL FOR ADDITIONAL DEMO / CONSTRUCTION NOTES AND PROCEDURES.

THESE NOTES ARE SPECIFIC TO THE WORK AT WILLIAM DAVIES MIDDLE SCHOOL AND SHALL NOT BE APPLIED TO WORK AT OTHER SCHOOLS IN THE PROJECT. ALL WORK DESCRIBED IN THESE NOTES IS THE RESPONSIBILITY OF THE GENERAL PRIME CONTRACTOR UNLESS

GENERAL NOTE: THE OWNER HAS THE RIGHT OF FIRST REFUSAL FOR ALL EQUIPMENT AND FIXTURES (CABINETS, SHELVING, PLUMBING FIXTURES, ETC.) REMOVED UNDER CONTRACT. IF THE OWNER DOES NOT EXERCISE THIS RIGHT FOR AN INDIVIDUAL PIECE OF EQUIPMENT,

- (3.) EXISTING UNIT VENTILATOR WILL BE DE-ENERGIZED BY THE ELECTRICAL CONTRACTOR, DISCONNECTED AND REMOVED BY THE HVAC CONTRACTOR. EACH CONTRACTOR IS RESPONSIBLE TO PROTECT ALL EXISTING ADJACENT CONSTRUCTION AND FINISHES TO REMAIN. REPAIR OR REPLACEMENT OF DAMAGED FINISHES WILL BE THE RESPONSIBILITY OF THE RESPECTIVE CONTRACTOR.
- THE GENERAL CONTRACTOR WILL REMOVE EXISTING CASEWORK, FILLER PANELS AND COMPONENTS, STORE AND PROTECT FOR REINSTALLATION AS PER TYPICAL CONDITIONS DELINEATED ON DRAWINGS TO ACCOMMODATE HVAC EQUIPMENT RENOVATIONS. COORDINATE RELOCATION OF EXISTING CASEWORK WITH NEW HVAC UNIT; ALL EXPOSED SURFACES ARE TO BE FINISHED WITH NEW MATERIALS TO MATCH EXISTING FINISHES INCLUDING P/LAM, VCT FLOOR AND PAINT. ALL WORK INCLUDING SELECTIVE REMOVAL, RELOCATION, PATCHING, REPAIR AND REINSTALLATION OF THE CASEWORK IS BY THE GENERAL CONTRACTOR.
- (5.) Where Indicated, remove, store and protect existing casework top , casework and fillers to accommodate RENOVATIONS. COORDINATE EXTENT OF CASEWORK REMOVALS AND RELOCATIONS / REINSTALLATIONS WITH REQUIREMENTS OF NEW HVAC SCOPE WORK, MODIFY AND REINSTALL FILLER PANELS AND COUNTER TOPS FILLER INCLUDING NEW END PANELS TO ACCOMMODATE NEW CONDITION. PATCH AND REPAIR ALL DAMAGES BY REMOVAL AND INSTALLATION TO MATCH EXISTING IN
- 6. EXISTING HVAC GRILL, HVAC UNIT AND ALL RELATED WORK IS TO BE REMOVED BY THE HVAC CONTRACTOR. THE GENERAL CONTRACTOR WILL MODIFY THE EXISTING MASONRY OPENING TO ACCOMMODATE THE NEW LINTELS AND GRILL THAT IS TO BE INSTALLED BY THE HVAC CONTRACTOR. THE GENERAL CONTRACTOR IS RESPONSIBLE TO PROVIDE INSULATION, BACKER RODS AND SEALANT AROUND GRILLES TO PREVENT AIR AND WATER INFILTRATION-TYPICAL.REFER TO DRAWING A 107 FOR TYPICAL SECTION AND DETAILS RELATED TO THIS WORK. INSTALLATION OF NEW EXTERIOR GRILL AND PERIMETER SEALANT IN COLOR

REFER TO A 109 FOR TYPICAL DEMOLITION FLOOR PLANS

ALTERATIONS AND RENOVATIONS TO WILLIAM DAVIES MIDDLE SCHOOL

Project Owner Name HAMILTON TOWNSHIP BOARD OF EDUCATION

Project Location 1876 DENNIS FORMAN DR MAYS LANDING, NJ 08330

> Project Number 4937C 02.15.2019 Checked By


AS NOTED

Drawn By

PARTIAL FIRST FLOOR HVAC DEMOLITION PLAN

BLOCK B

No. Date Description

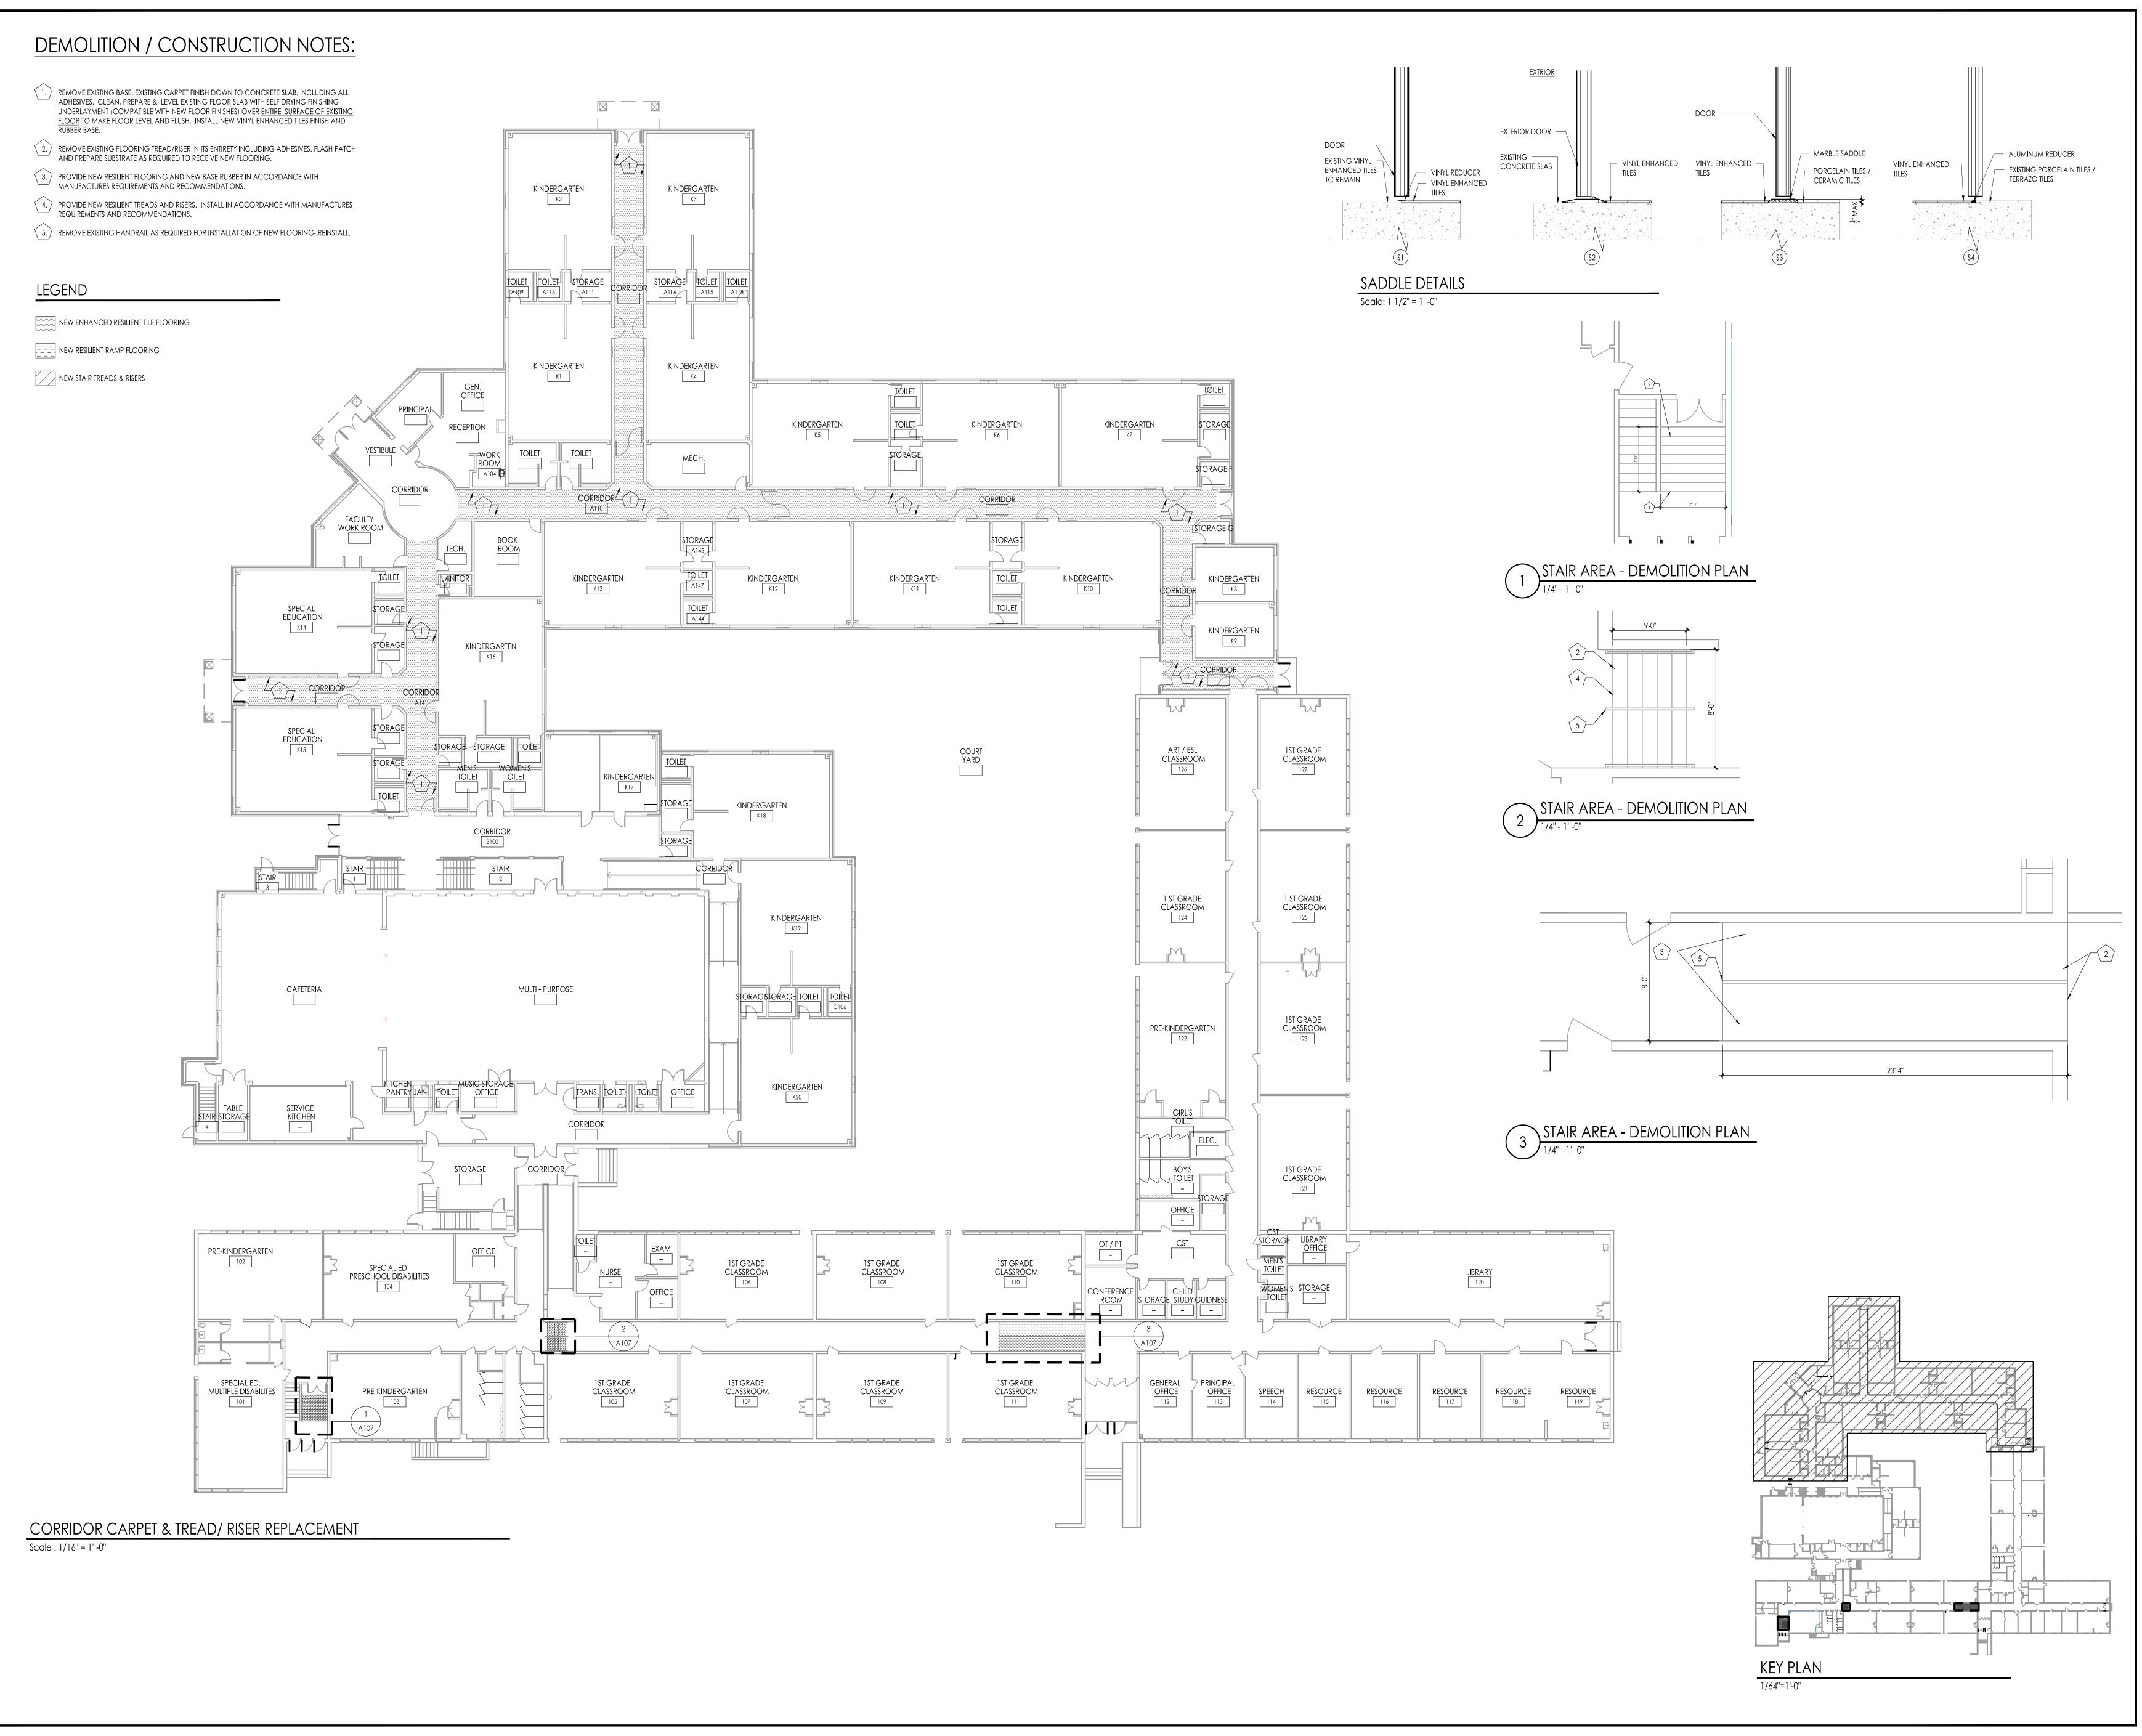

JOSEPH C. SHANER MEMORIAL ELEMENTARY SCHOOL

ALTERATIONS AND

RENOVATIONS TO


Project Owner Name HAMILTON TOWNSHIP BOARD OF EDUCATION

5801 3rd ST MAYS LANDING, NJ 08330

Project Number 4937B 02.15.2019

Drawn By AS NOTED

CORRIDOR CARPET & TREAD / RISER REPLACEMNT

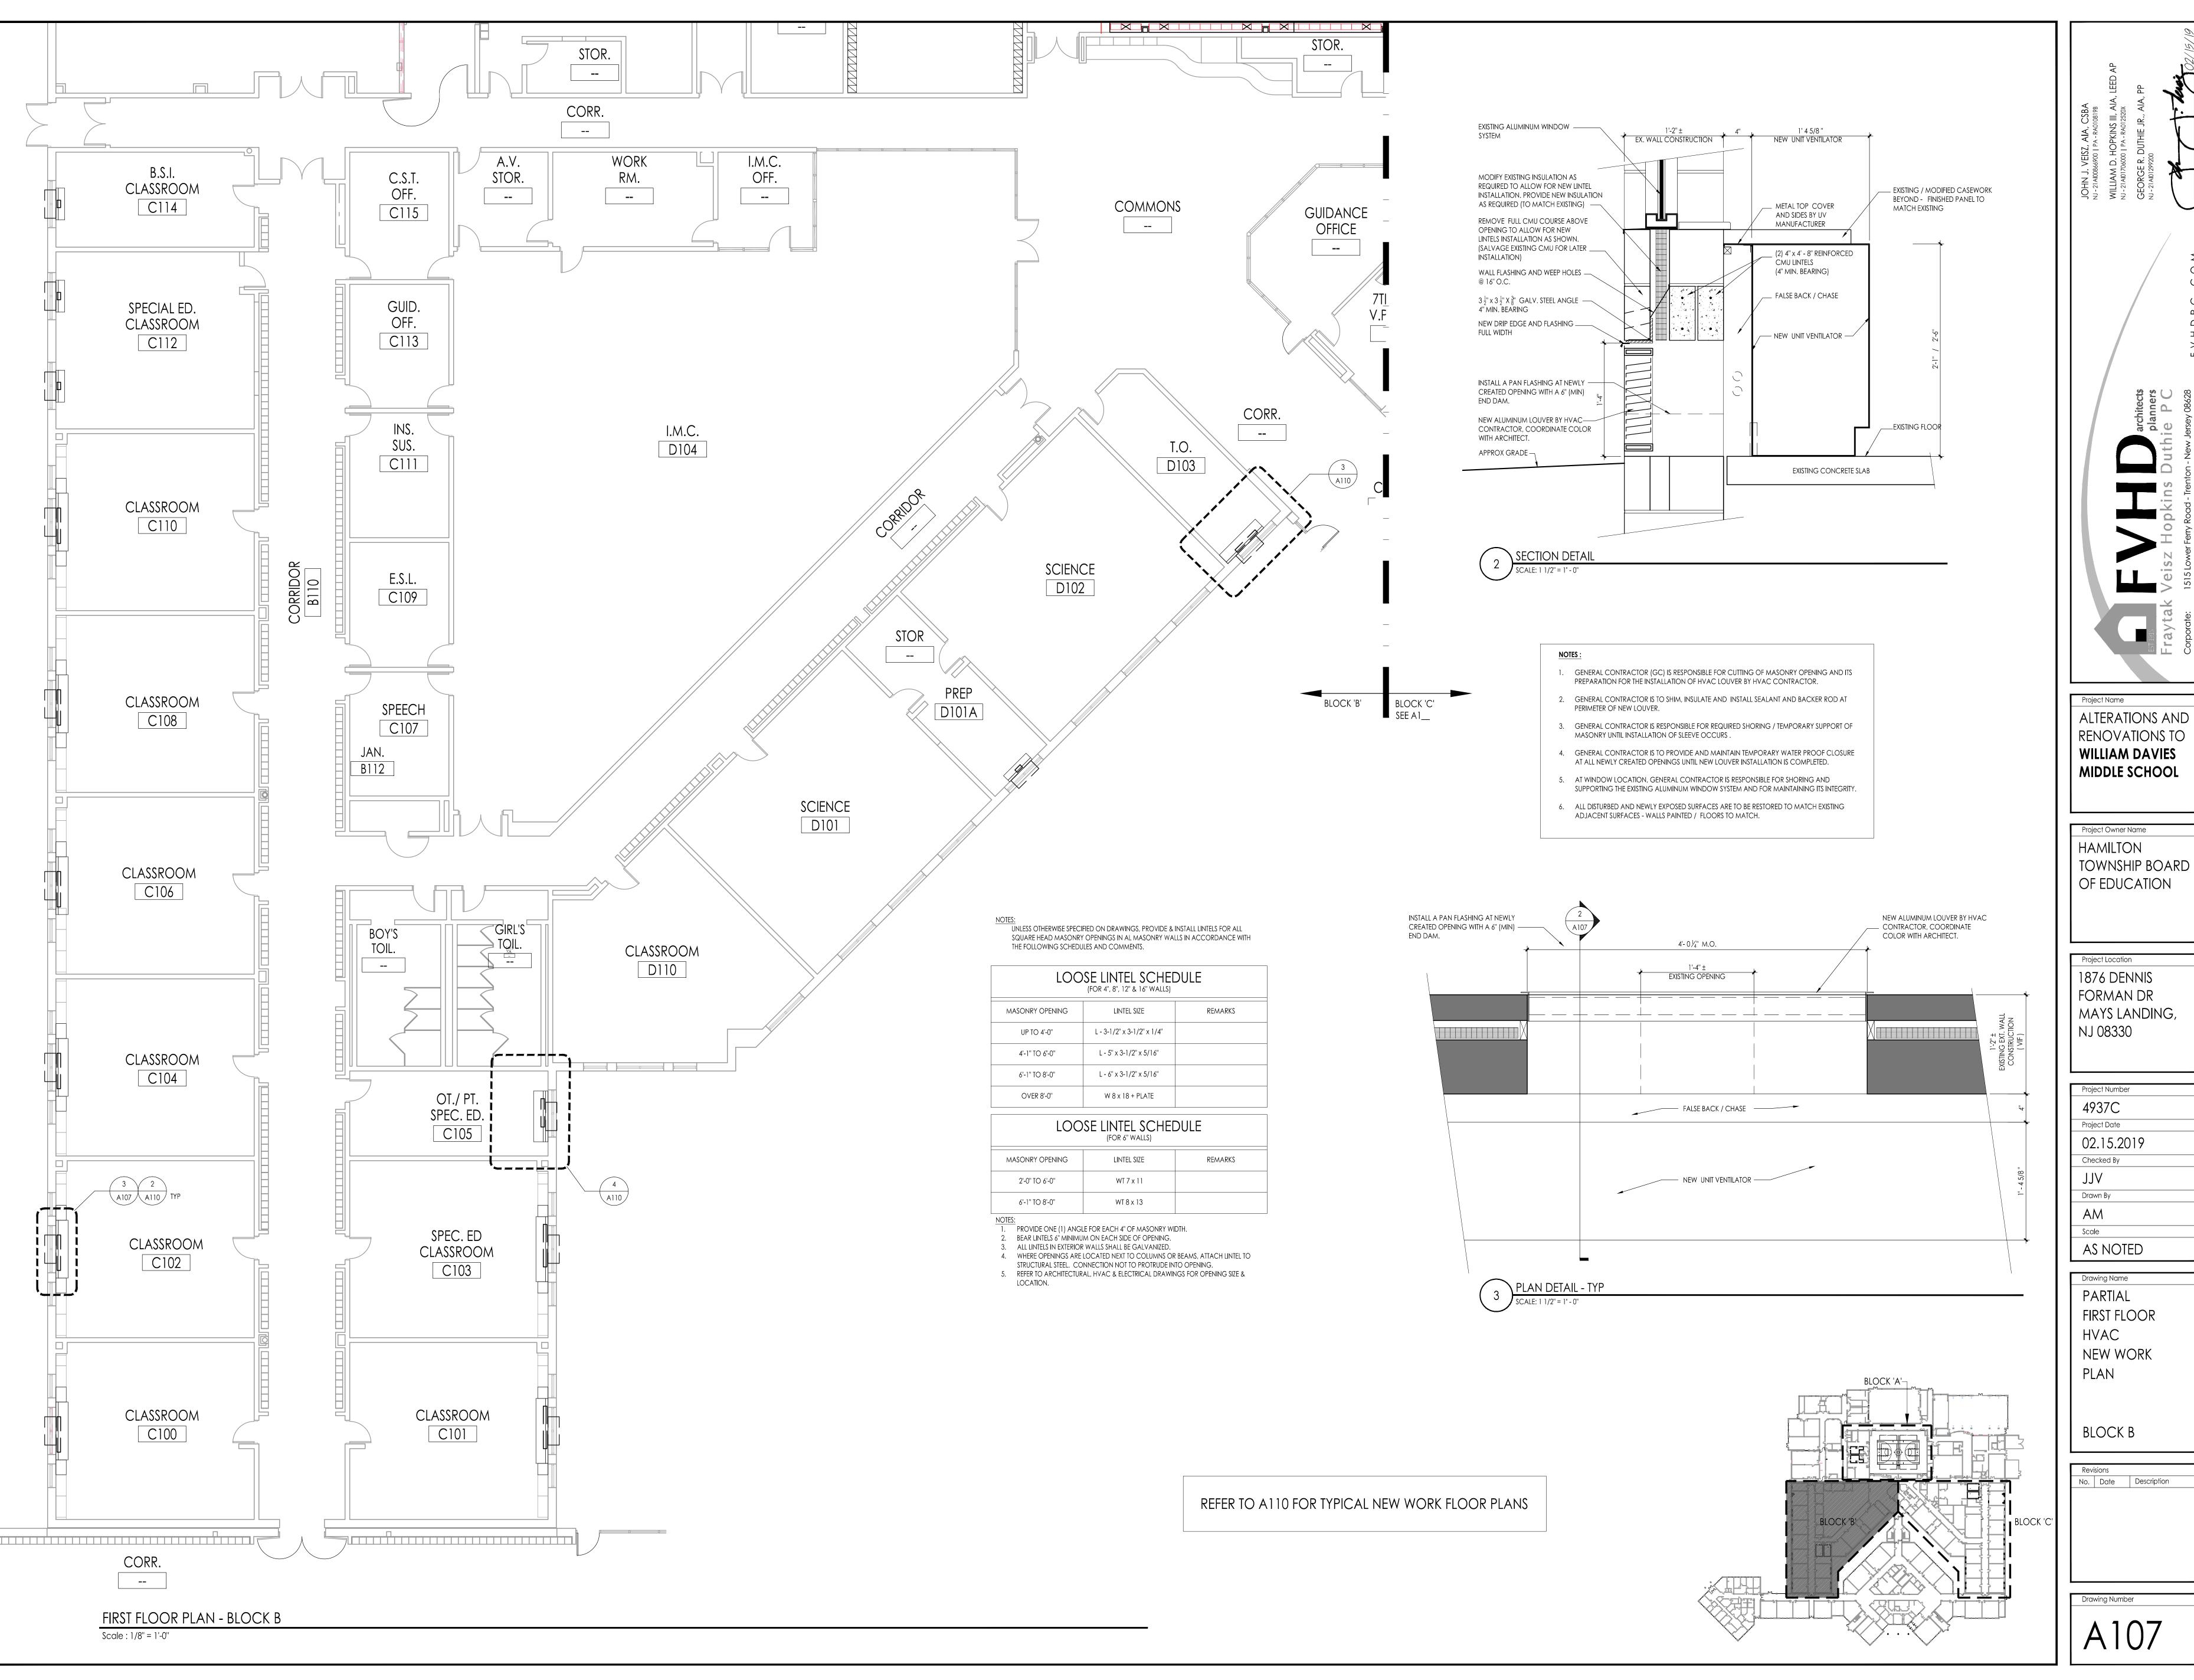

Project Owner Name HAMILTON TOWNSHIP BOARD OF EDUCATION


Project Location 1876 DENNIS FORMAN DR MAYS LANDING, NJ 08330

Project Number 4937C Project Date 02.15.2019 Checked By Drawn By


Drawing Name PARTIAL FIRST FLOOR HVAC NEW WORK

BLOCK B

No. Date Description

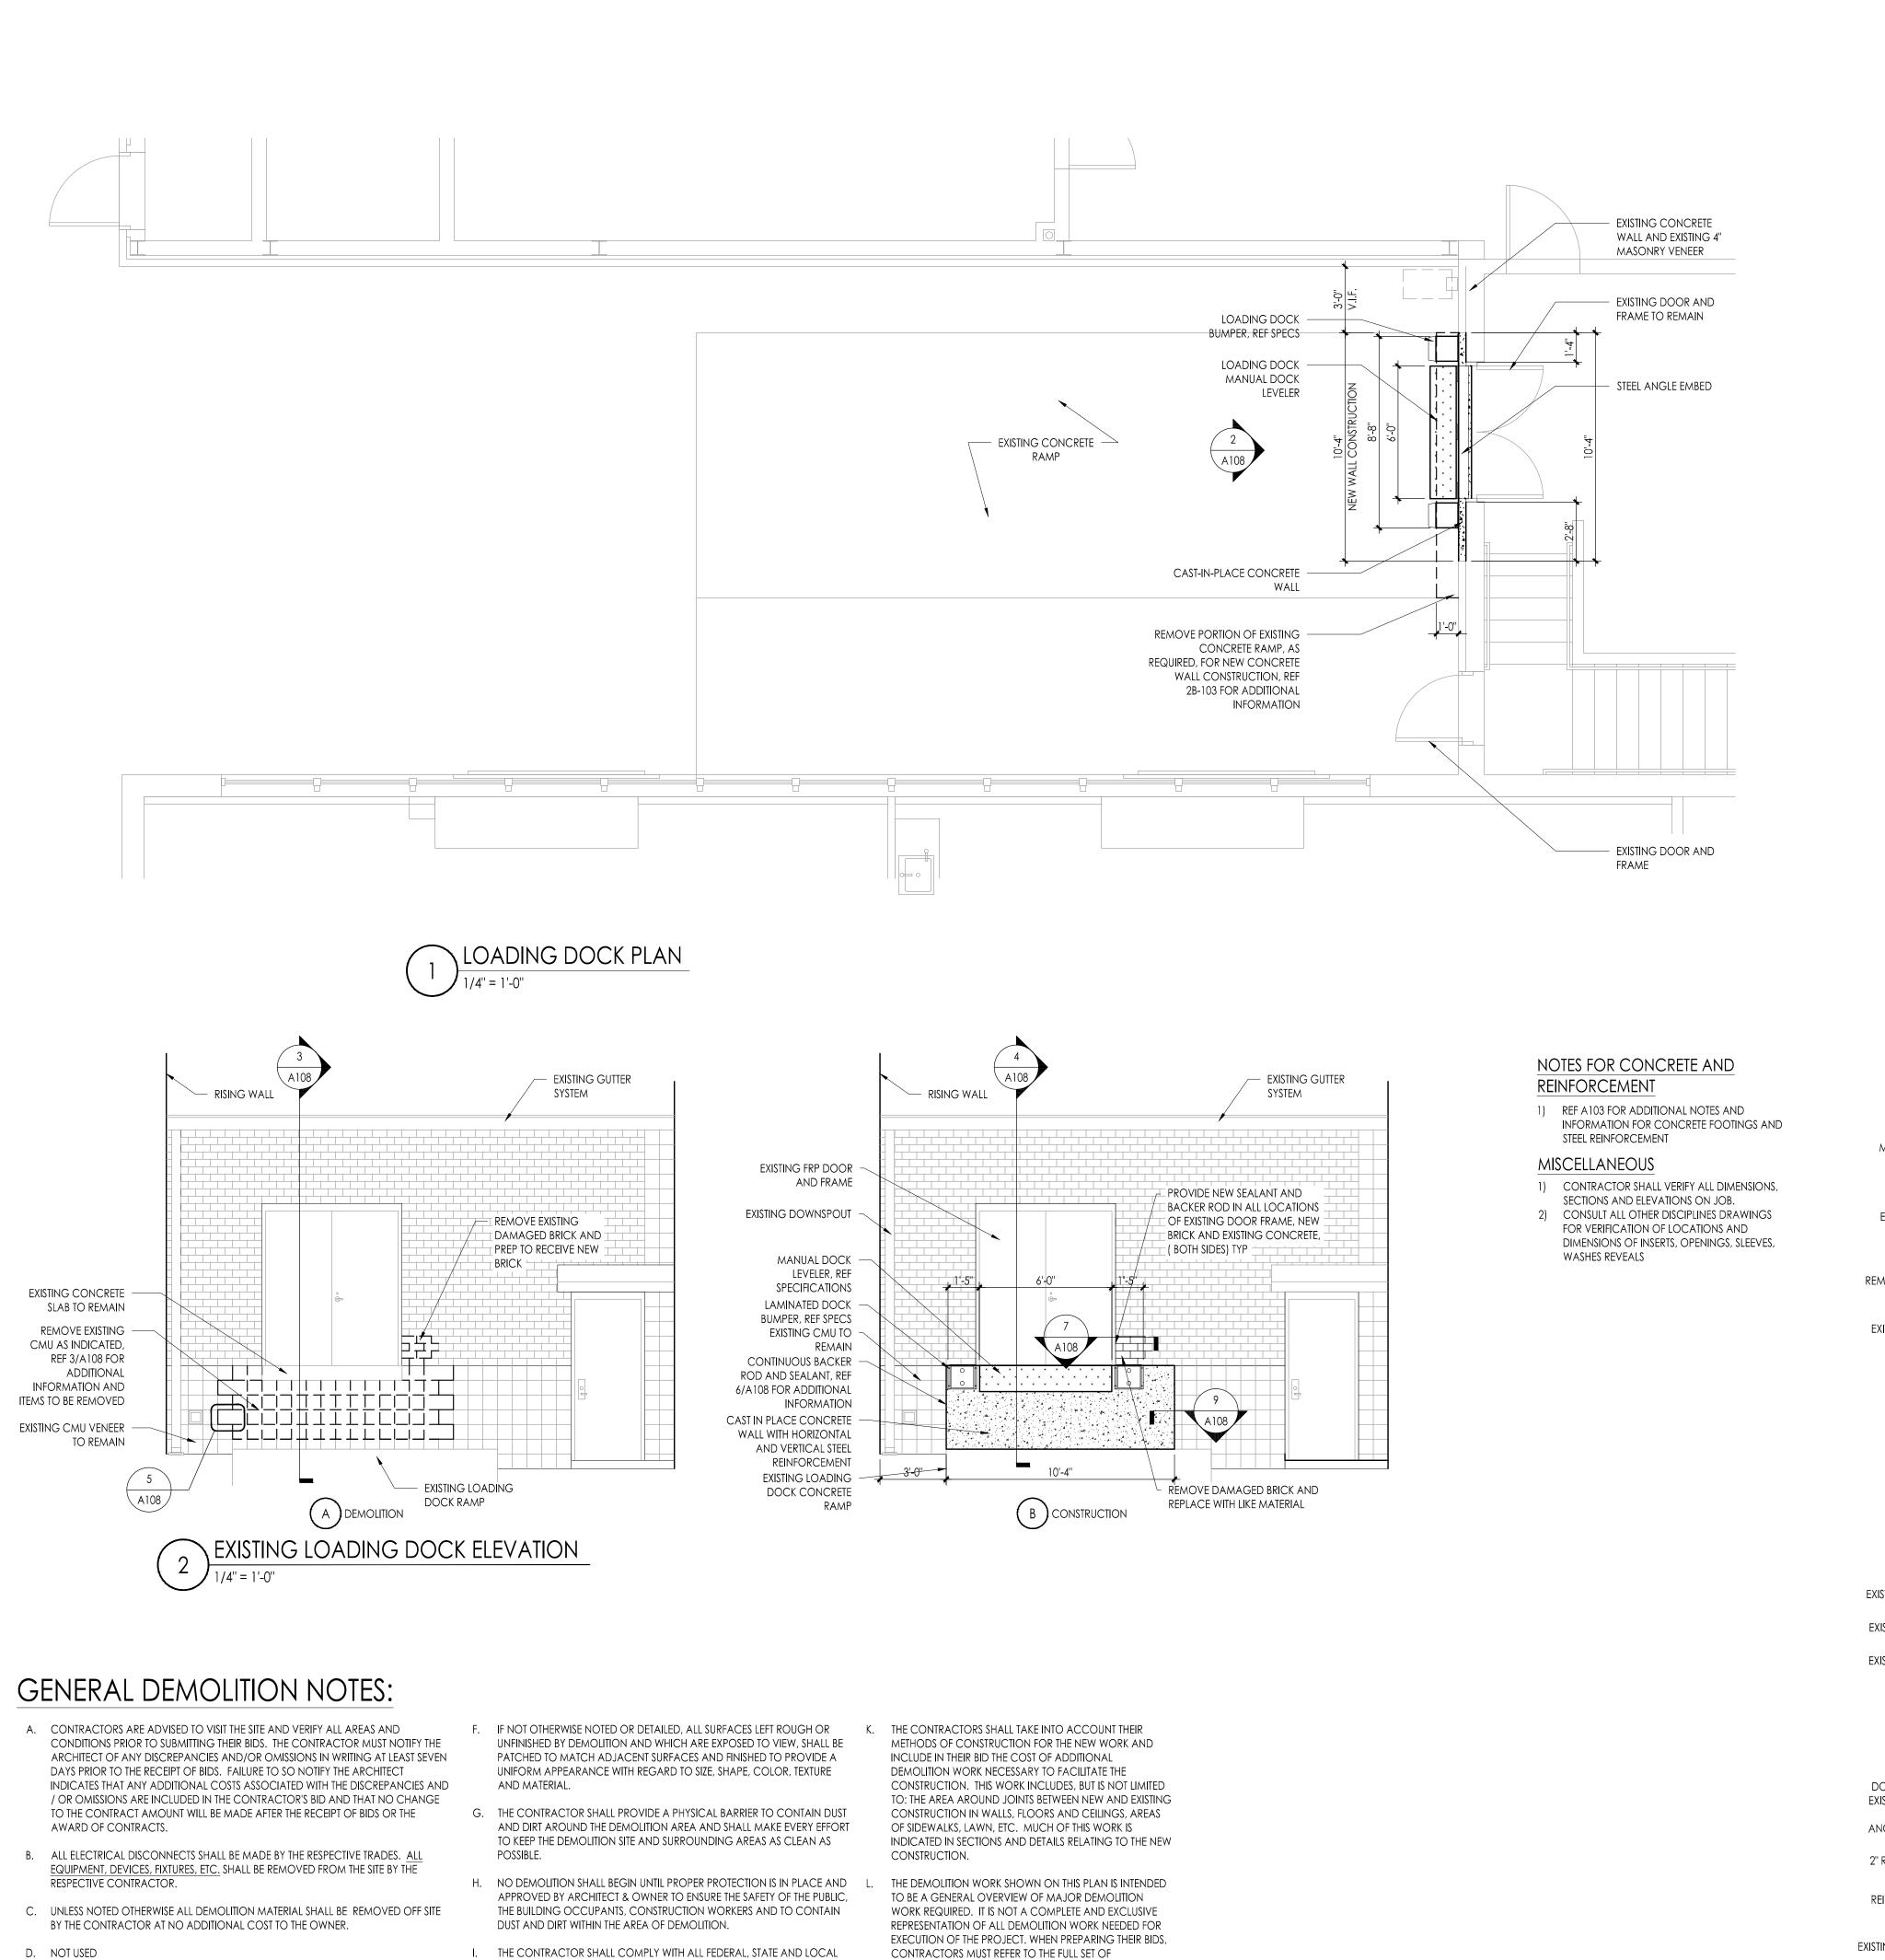

- E. THE CONTRACTOR SHALL MAKE EVERY EFFORT TO PROTECT PORTIONS OF THE EXISTING CONSTRUCTION WHICH ARE ADJACENT TO AREAS TO BE DEMOLISHED. MAKE ALL CUTS AS NEATLY AS POSSIBLE. REFER TO FLOOR PLAN DRAWINGS FOR FINISHING OF THESE AREAS.
- LAWS REGARDING THE REMOVAL AND DISPOSAL OF ALL MATERIALS &
 - J. J. THE CONTRACTOR SHALL PROVIDE PROTECTION AGAINST INCLEMENT WEATHER FOR THE EXISTING BUILDING DURING THE INTERIM PERIOD BETWEEN M. ALL PRIME CONTRACTORS ARE RESPONSIBLE FOR THEIR DEMOLITION AND THE COMPLETION OF NEW CONSTRUCTION.
- CONTRACTORS MUST REFER TO THE FULL SET OF CONSTRUCTION DOCUMENTS FOR VARIOUS MISCELLANEOUS ITEMS WHICH MUST BE REMOVED AND/OR RELOCATED AS PART OF THE WORK.
 - OWN CUTTING AND PATCHING SEE SPECIFICATION.

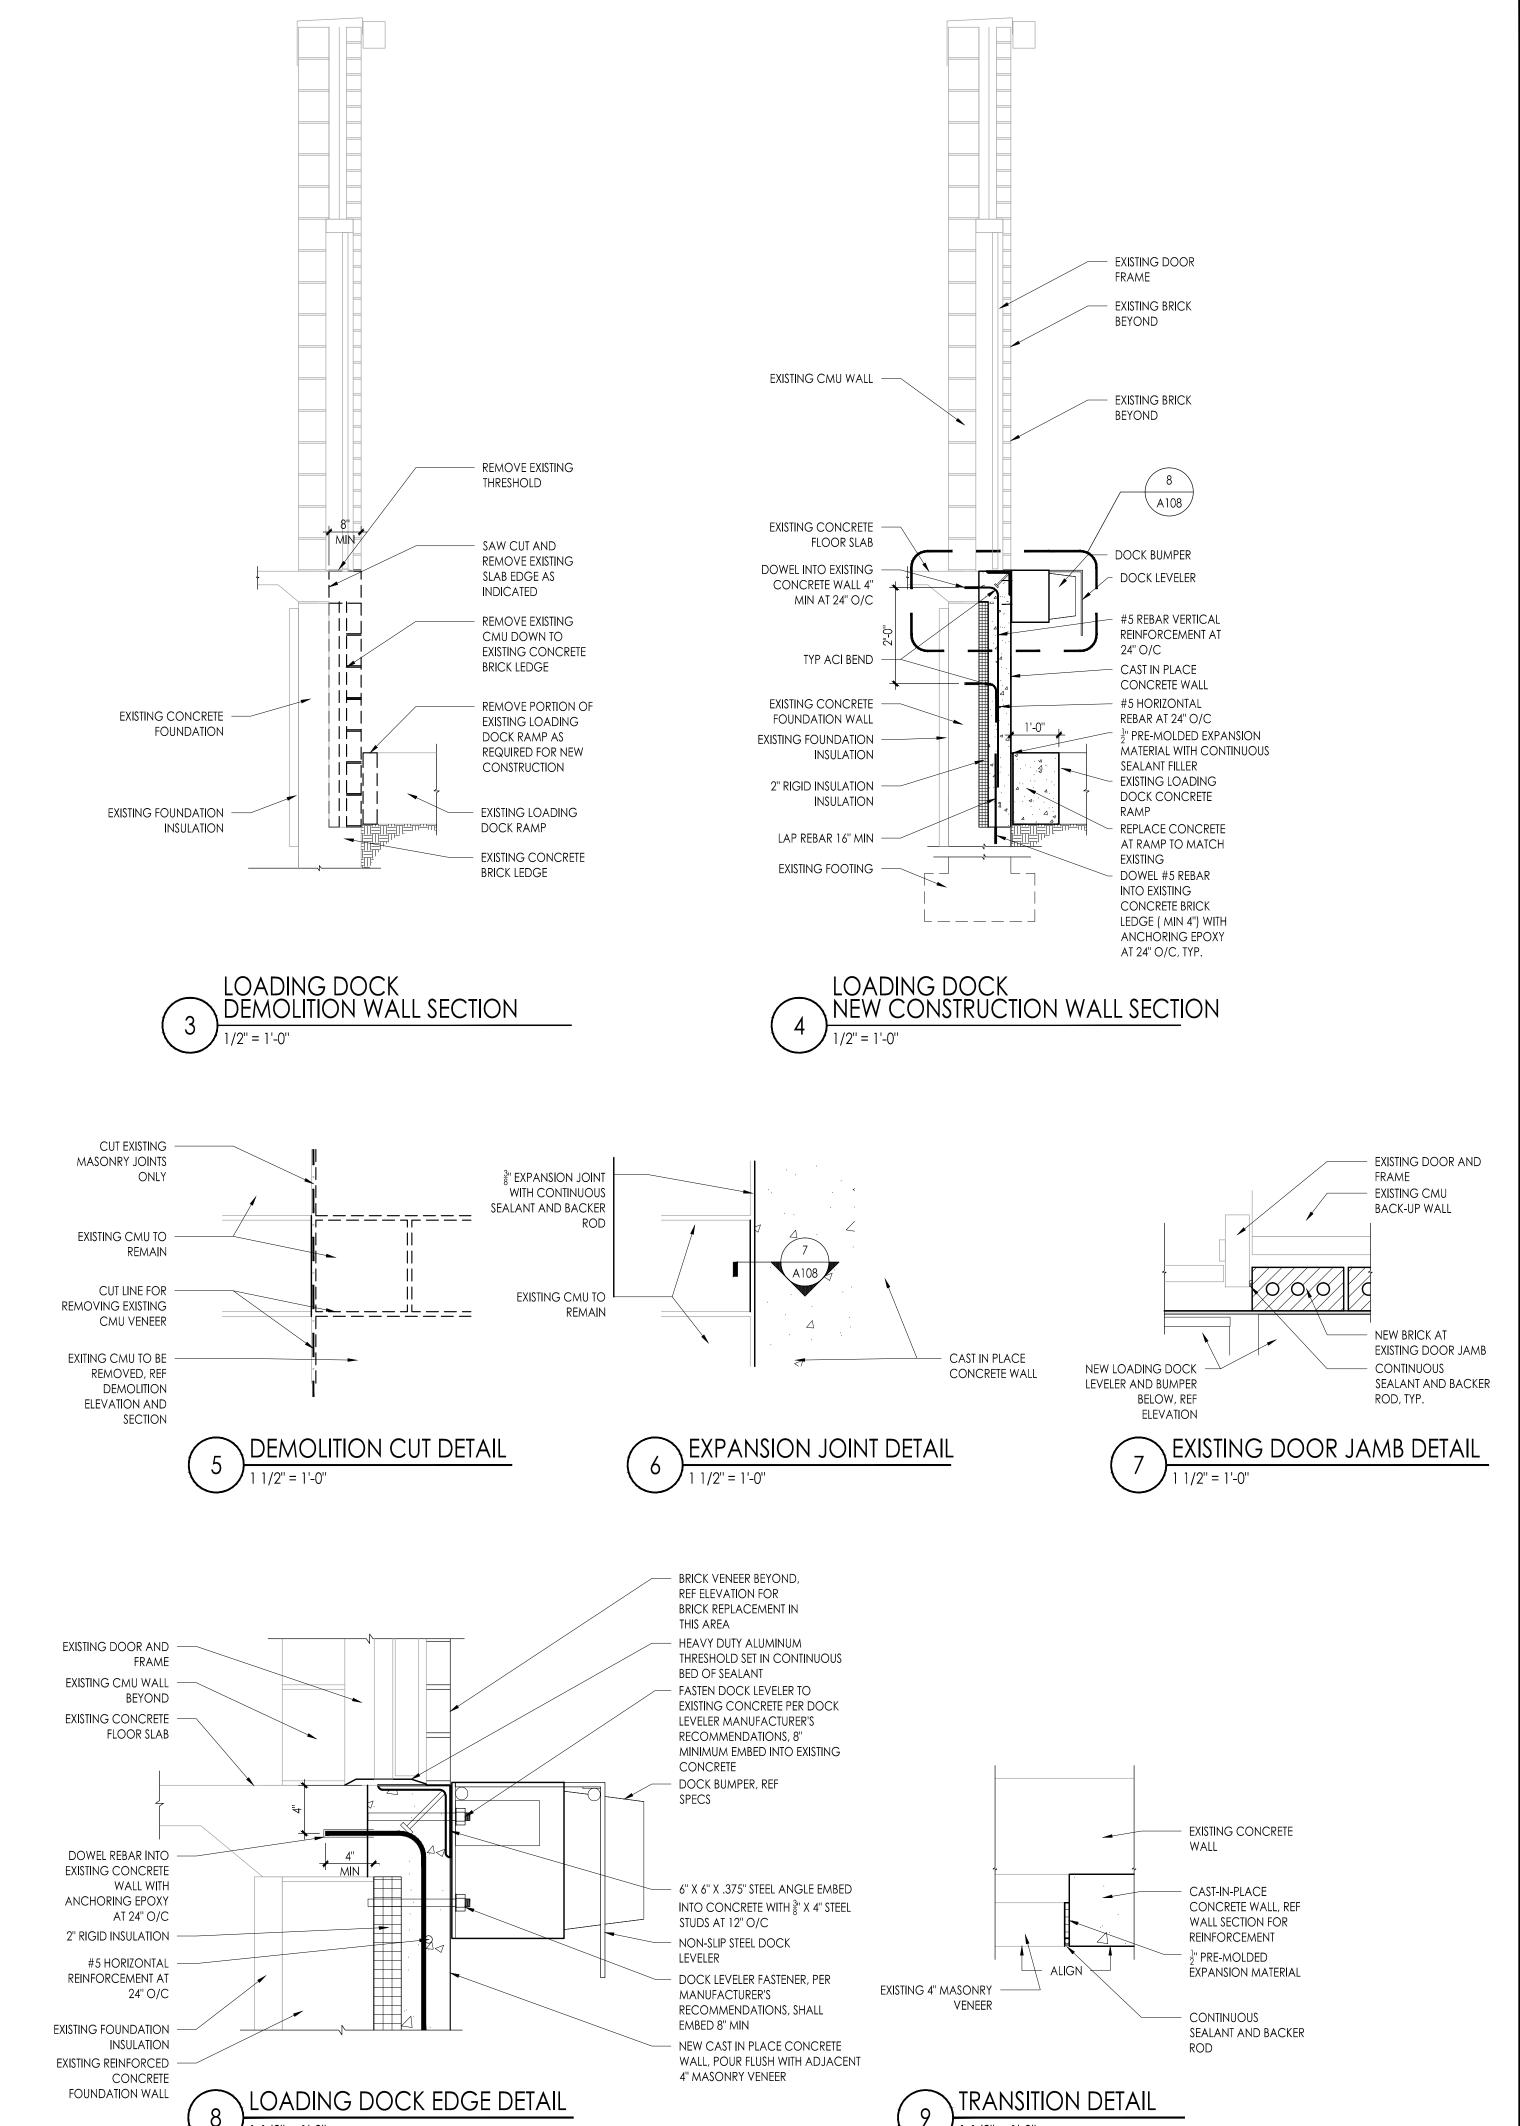


Project Owner Name HAMILTON TOWNSHIP BOARD OF EDUCATION

Project Location 5801 3rd ST MAYS LANDING, NJ 08330

Project Number 4937B Project Date 02.15.2019 Checked By Drawn By Scale AS NOTED

Drawing Name LOADING DOCK LEVELER SECTIONS **ELEVATIONS** AND DETAILS

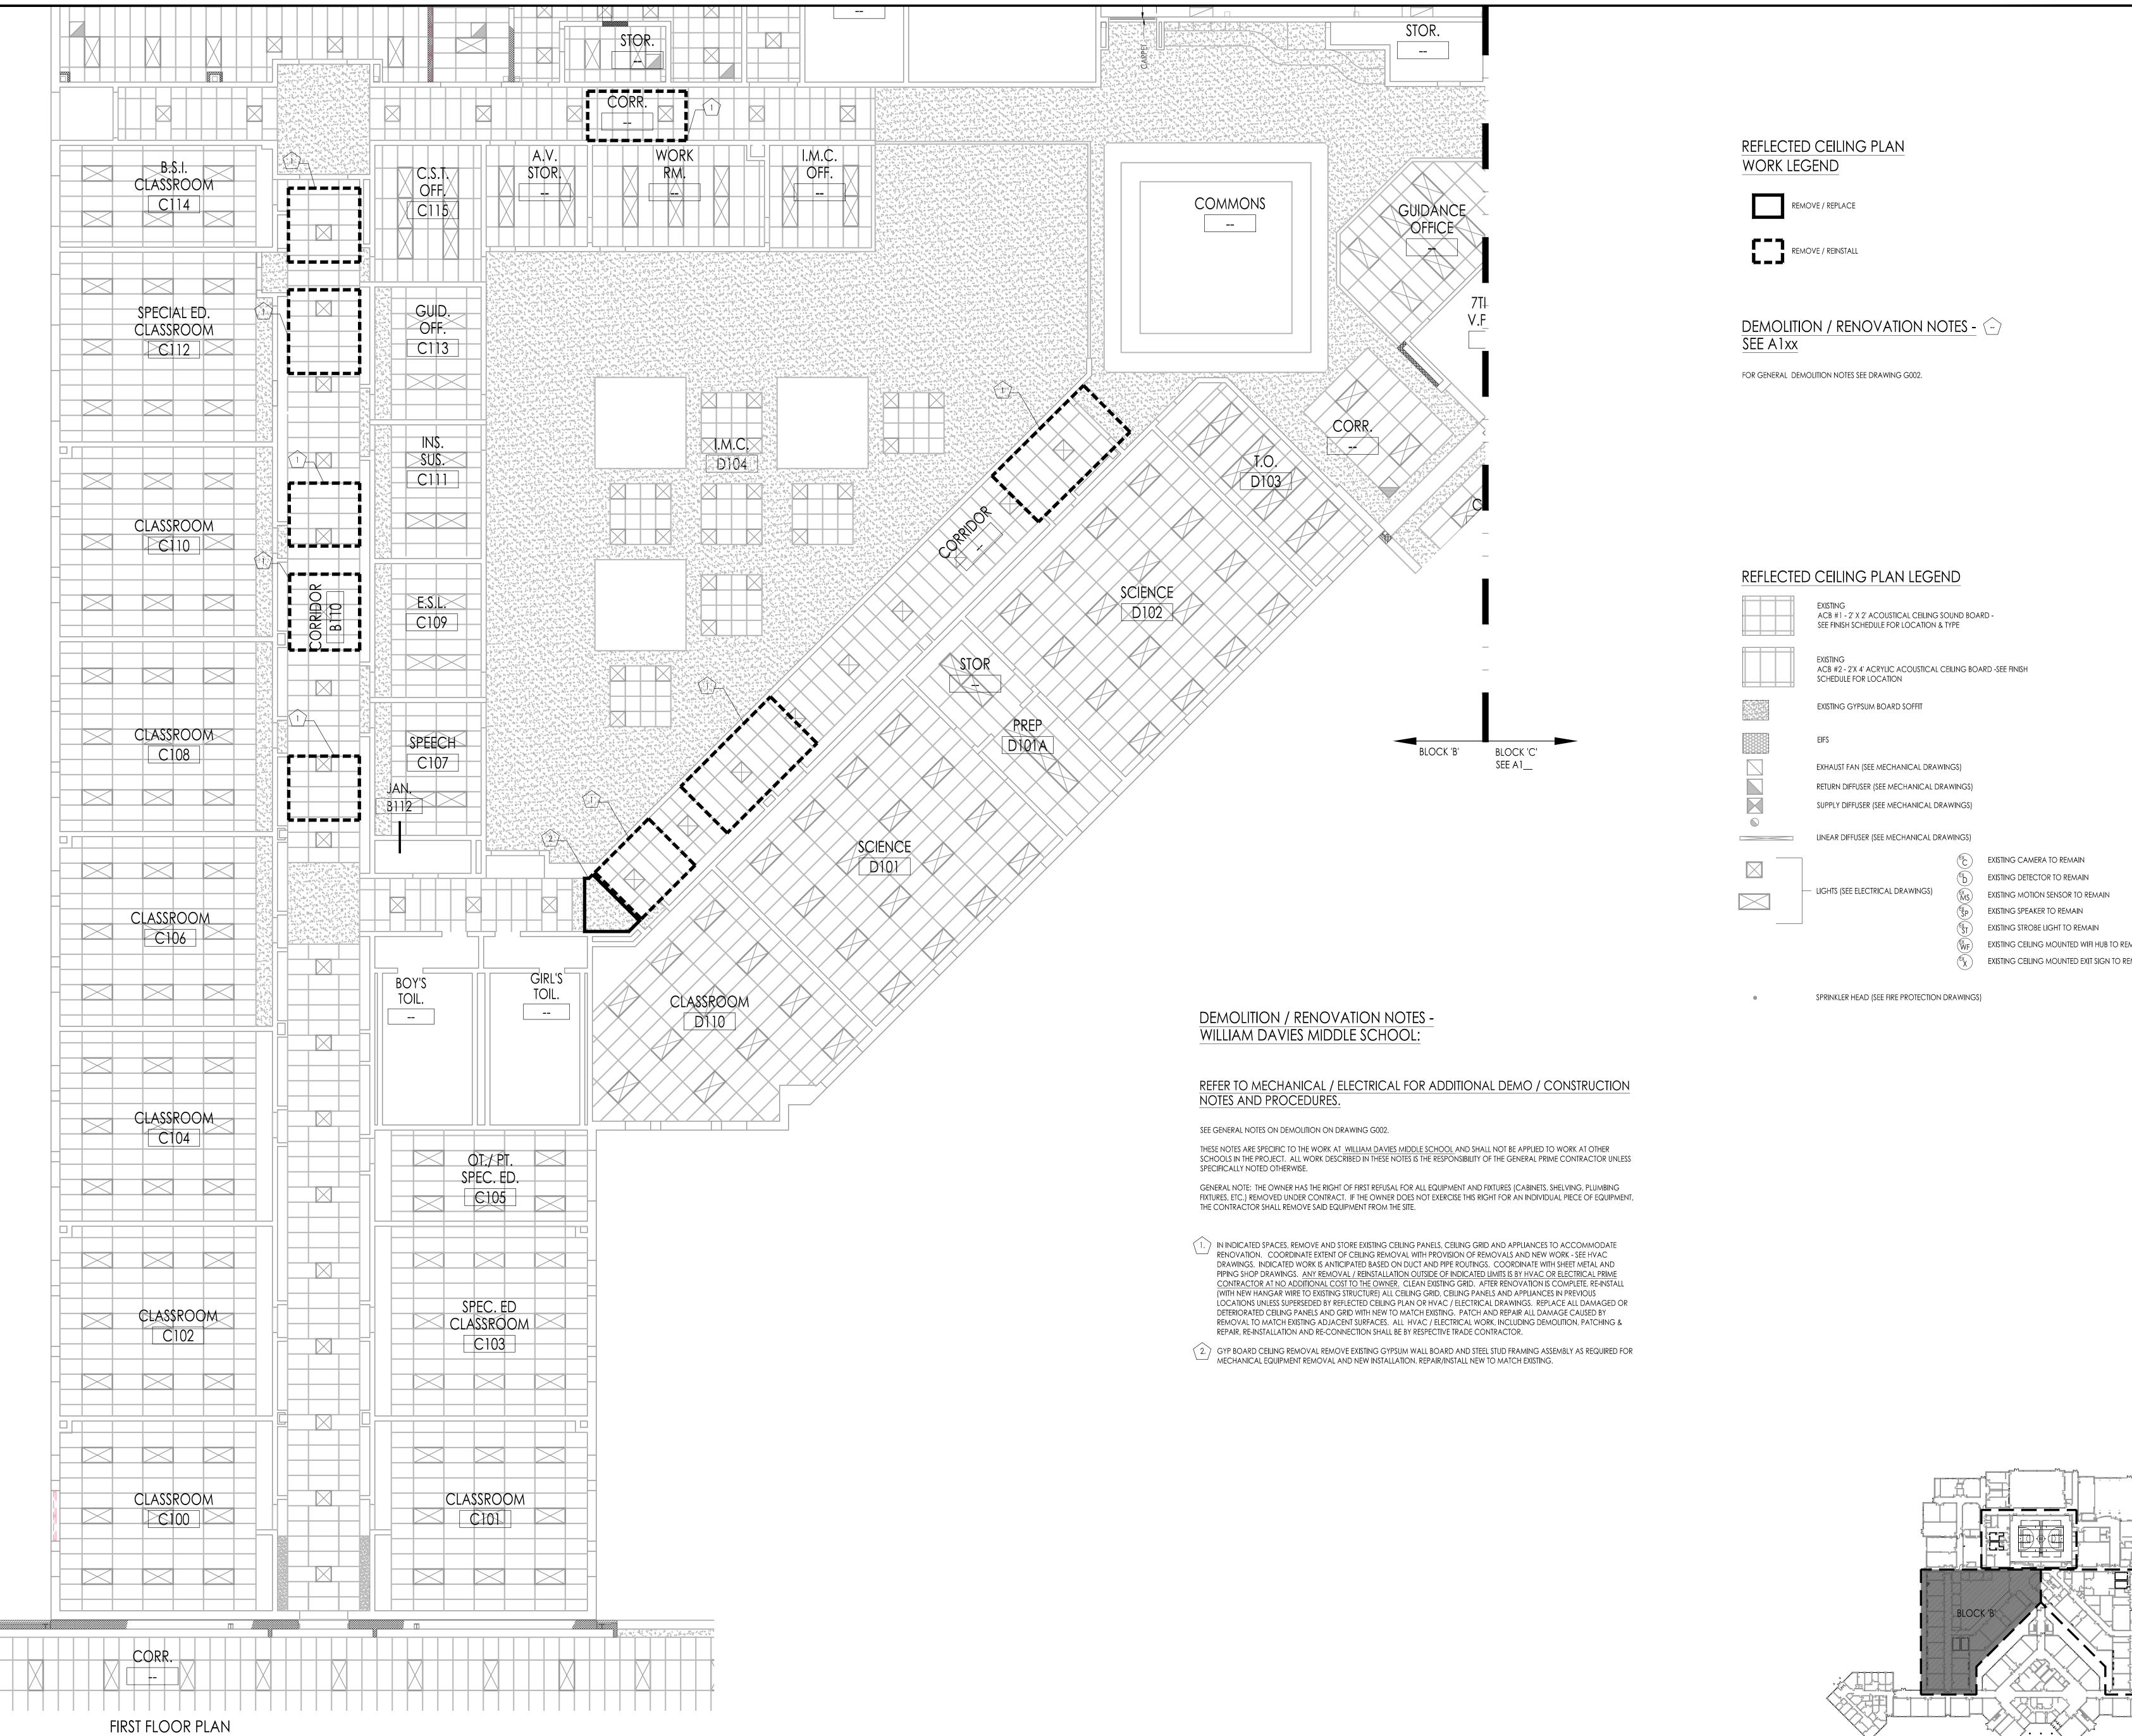

Scale: 1/8" = 1'-0"

EXISTING CEILING MOUNTED WIFI HUB TO REMAIN

EXISTING CEILING MOUNTED EXIT SIGN TO REMAIN

Project Location 1876 DENNIS FORMAN DR MAYS LANDING, NJ 08330

ALTERATIONS AND

RENOVATIONS TO

WILLIAM DAVIES

MIDDLE SCHOOL

Project Owner Name

OF EDUCATION

TOWNSHIP BOARD

HAMILTON

Project Number


Project Date 02.15.2019 Checked By Drawn By

AS NOTED

Drawing Name PARTIAL FIRST FLOOR REFLECTED CEILING PLAN

BLOCK B

No. Date Description

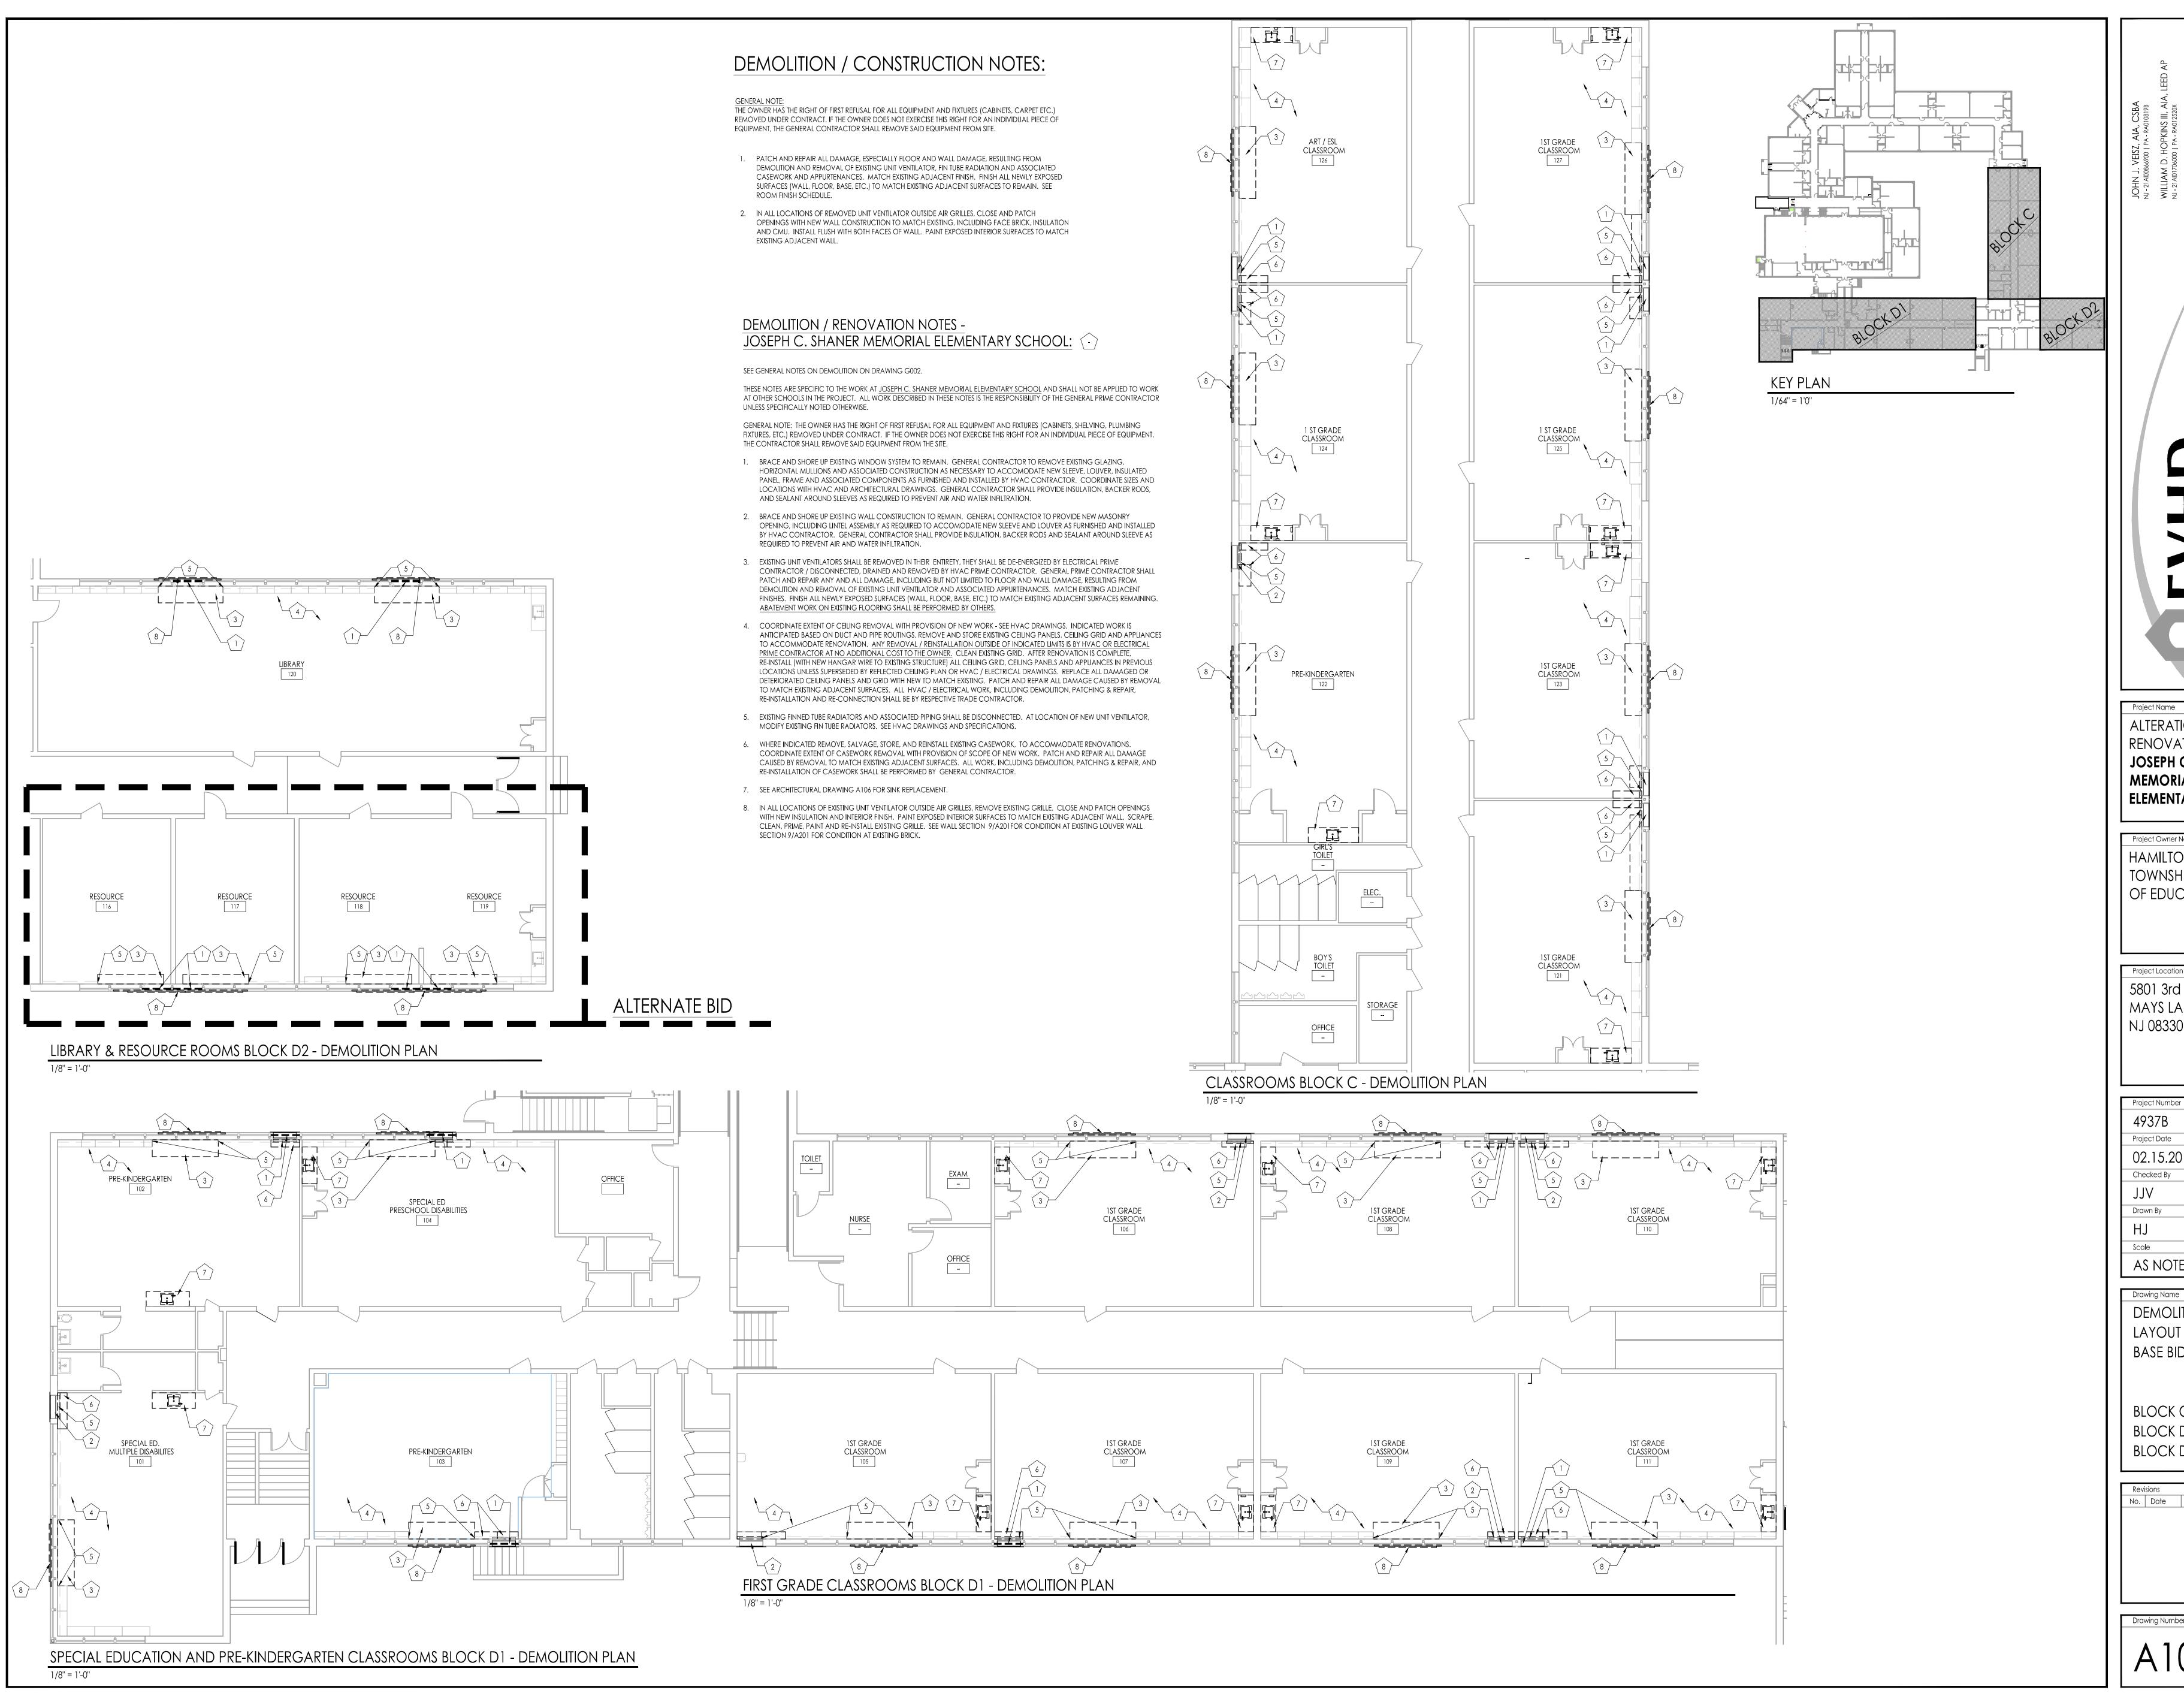

Project Owner Name HAMILTON TOWNSHIP BOARD OF EDUCATION


Project Location 5801 3rd ST MAYS LANDING, NJ 08330

Project Number Project Date 02.15.2019 Checked By

AS NOTED

DEMOLITION PLAN LAYOUT & NOTES **BASE BID**

BLOCK C BLOCK D1 BLOCK D2

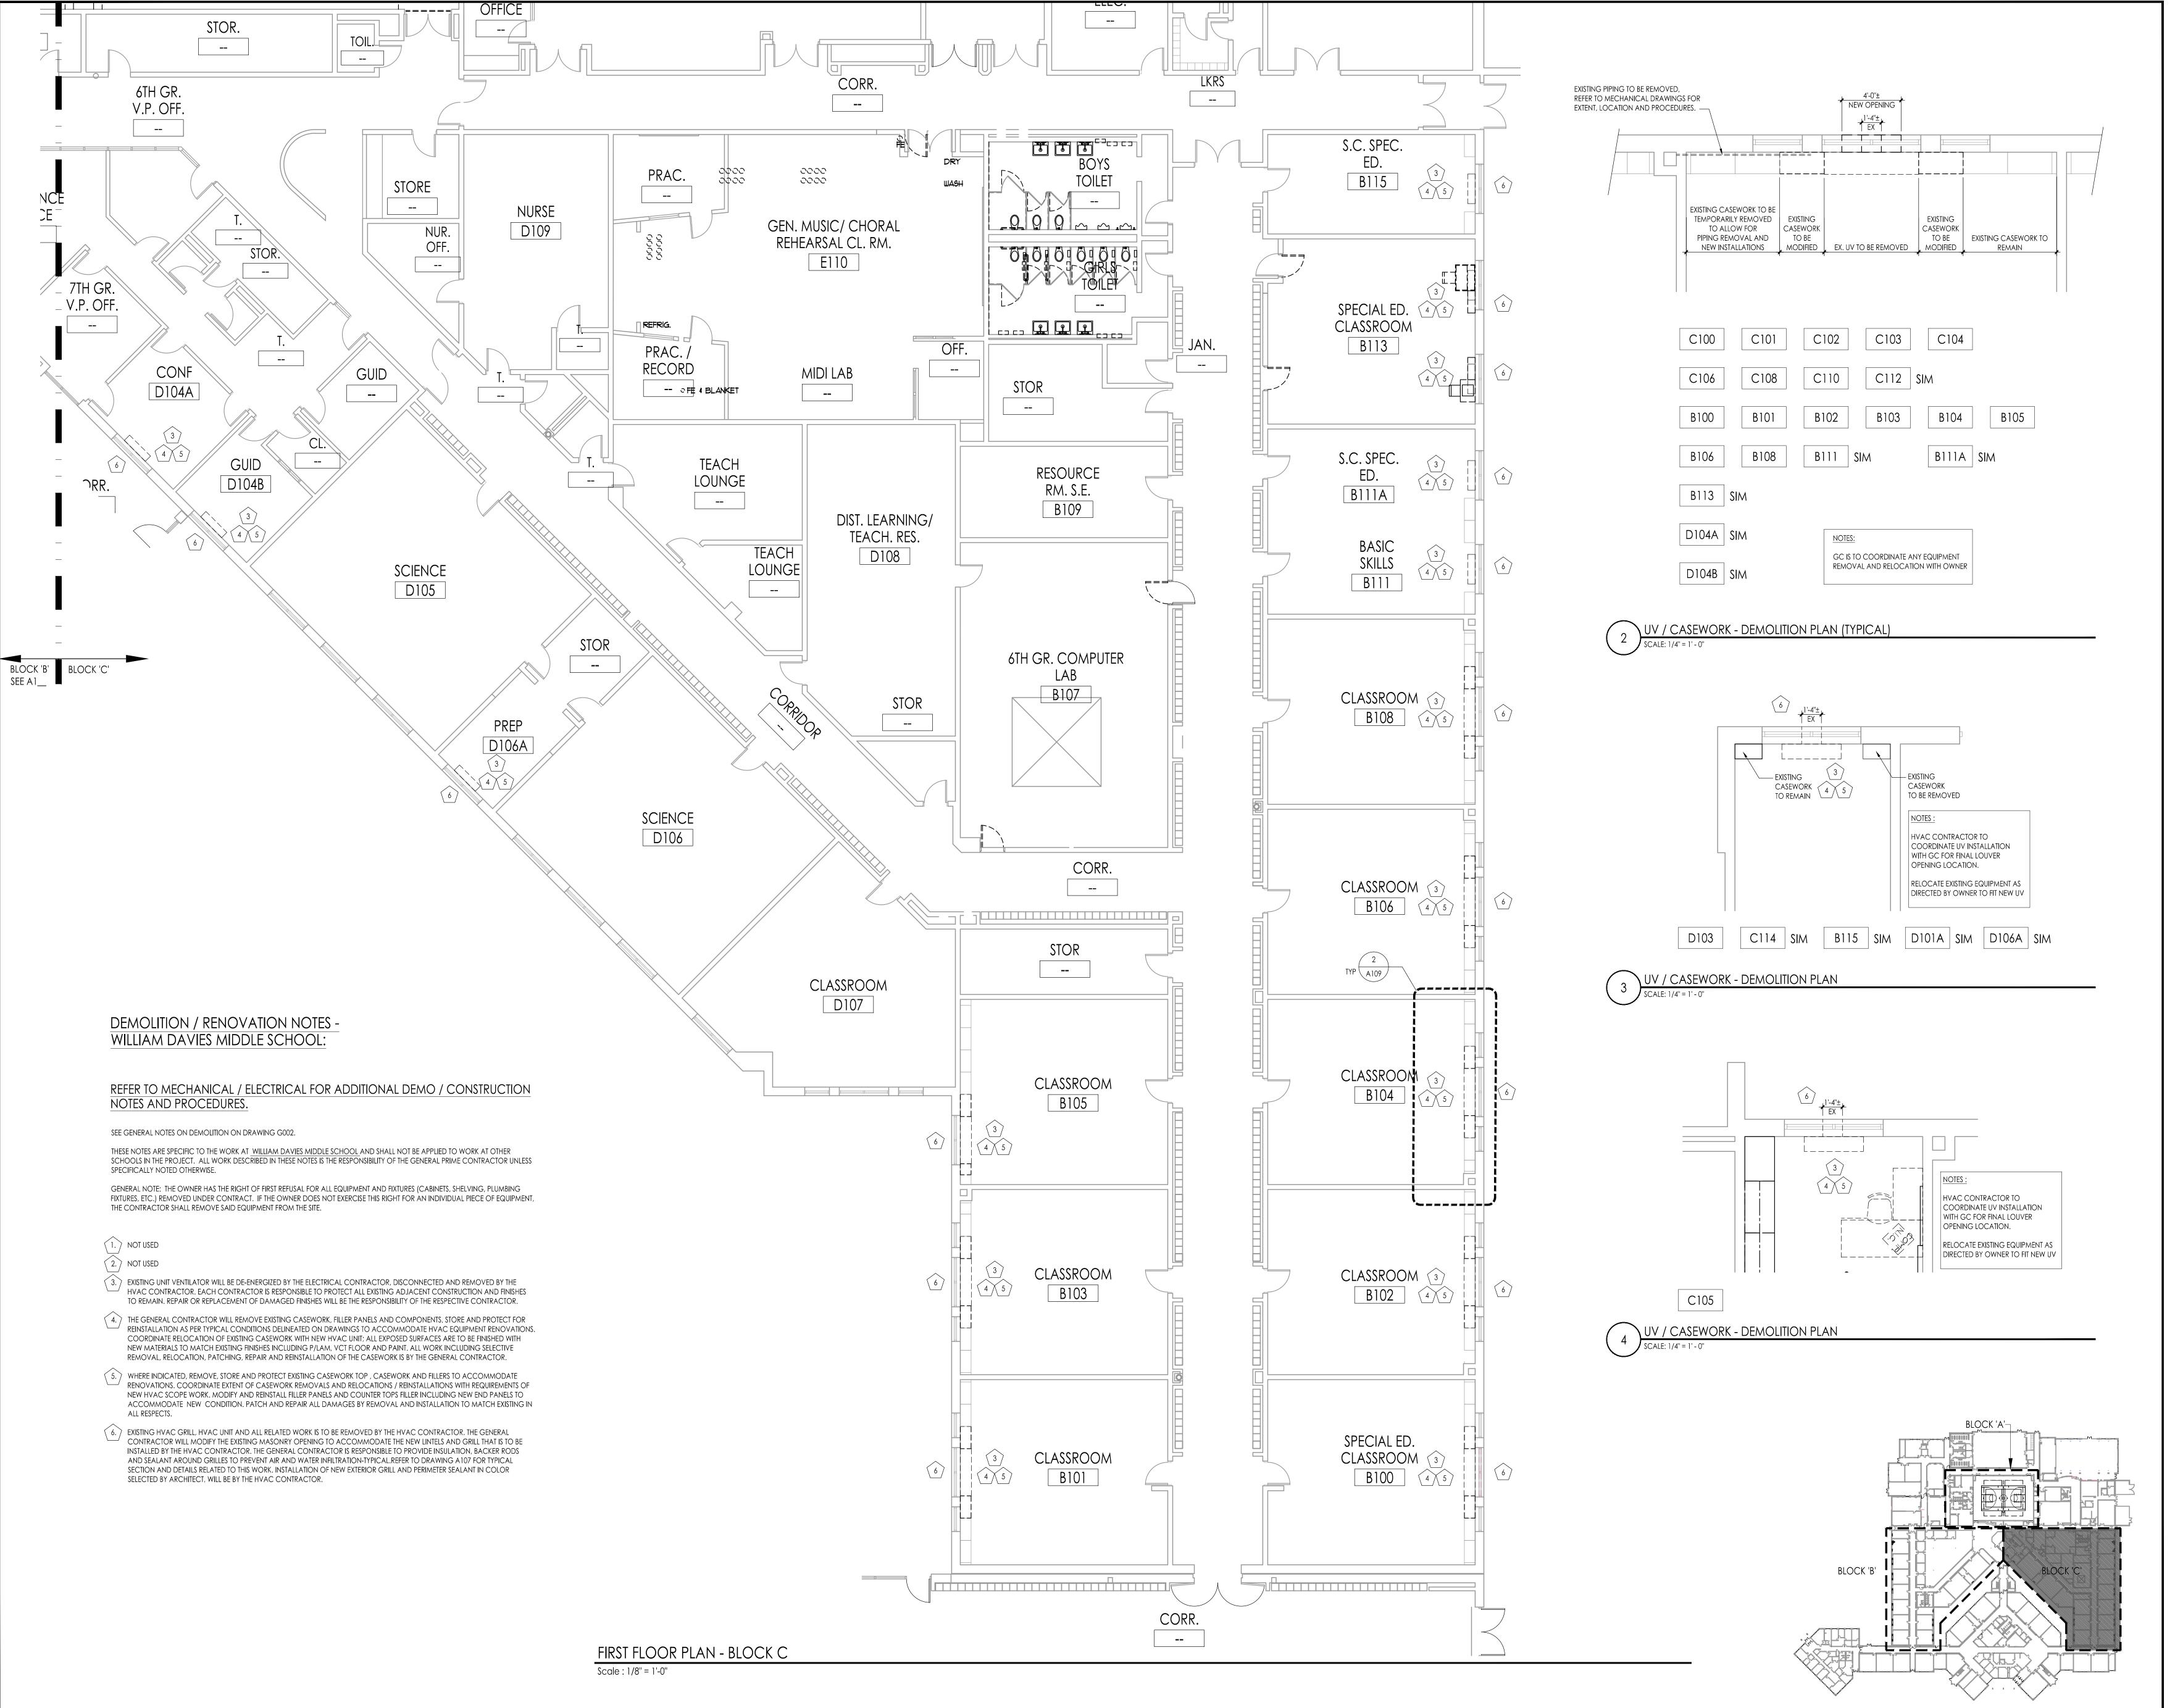

JOHN J. VEISZ, AIA, CSBA
NJ-21A100866900 | PA-RA010819B
WILLIAM D. HOPKINS III, AIA, LEED AP
NJ-21A101706000 | PA-RA012520X
GEORGE R. DUTHIE JR., AIA, PP
NJ-21A101299200

architects
planners

ytak Veisz Hopkins Duthie P C

orate: 1515 Lower Ferry Road - Trenton - New Jersey 08628

F V H
sylvania: 140 Whitaker Ave - Mont Clare - Pennsylvania 19453

ALTERATIONS AND RENOVATIONS TO WILLIAM DAVIES MIDDLE SCHOOL

Project Owner Name

HAMILTON

TOWNSHIP BOARD

OF EDUCATION

Project Location

1876 DENNIS
FORMAN DR
MAYS LANDING,
NJ 08330

Project Number

4937C

Project Date

02.15.2019

Checked By

JJV

Scale
AS NOTED

Drawing Name

Drawn By


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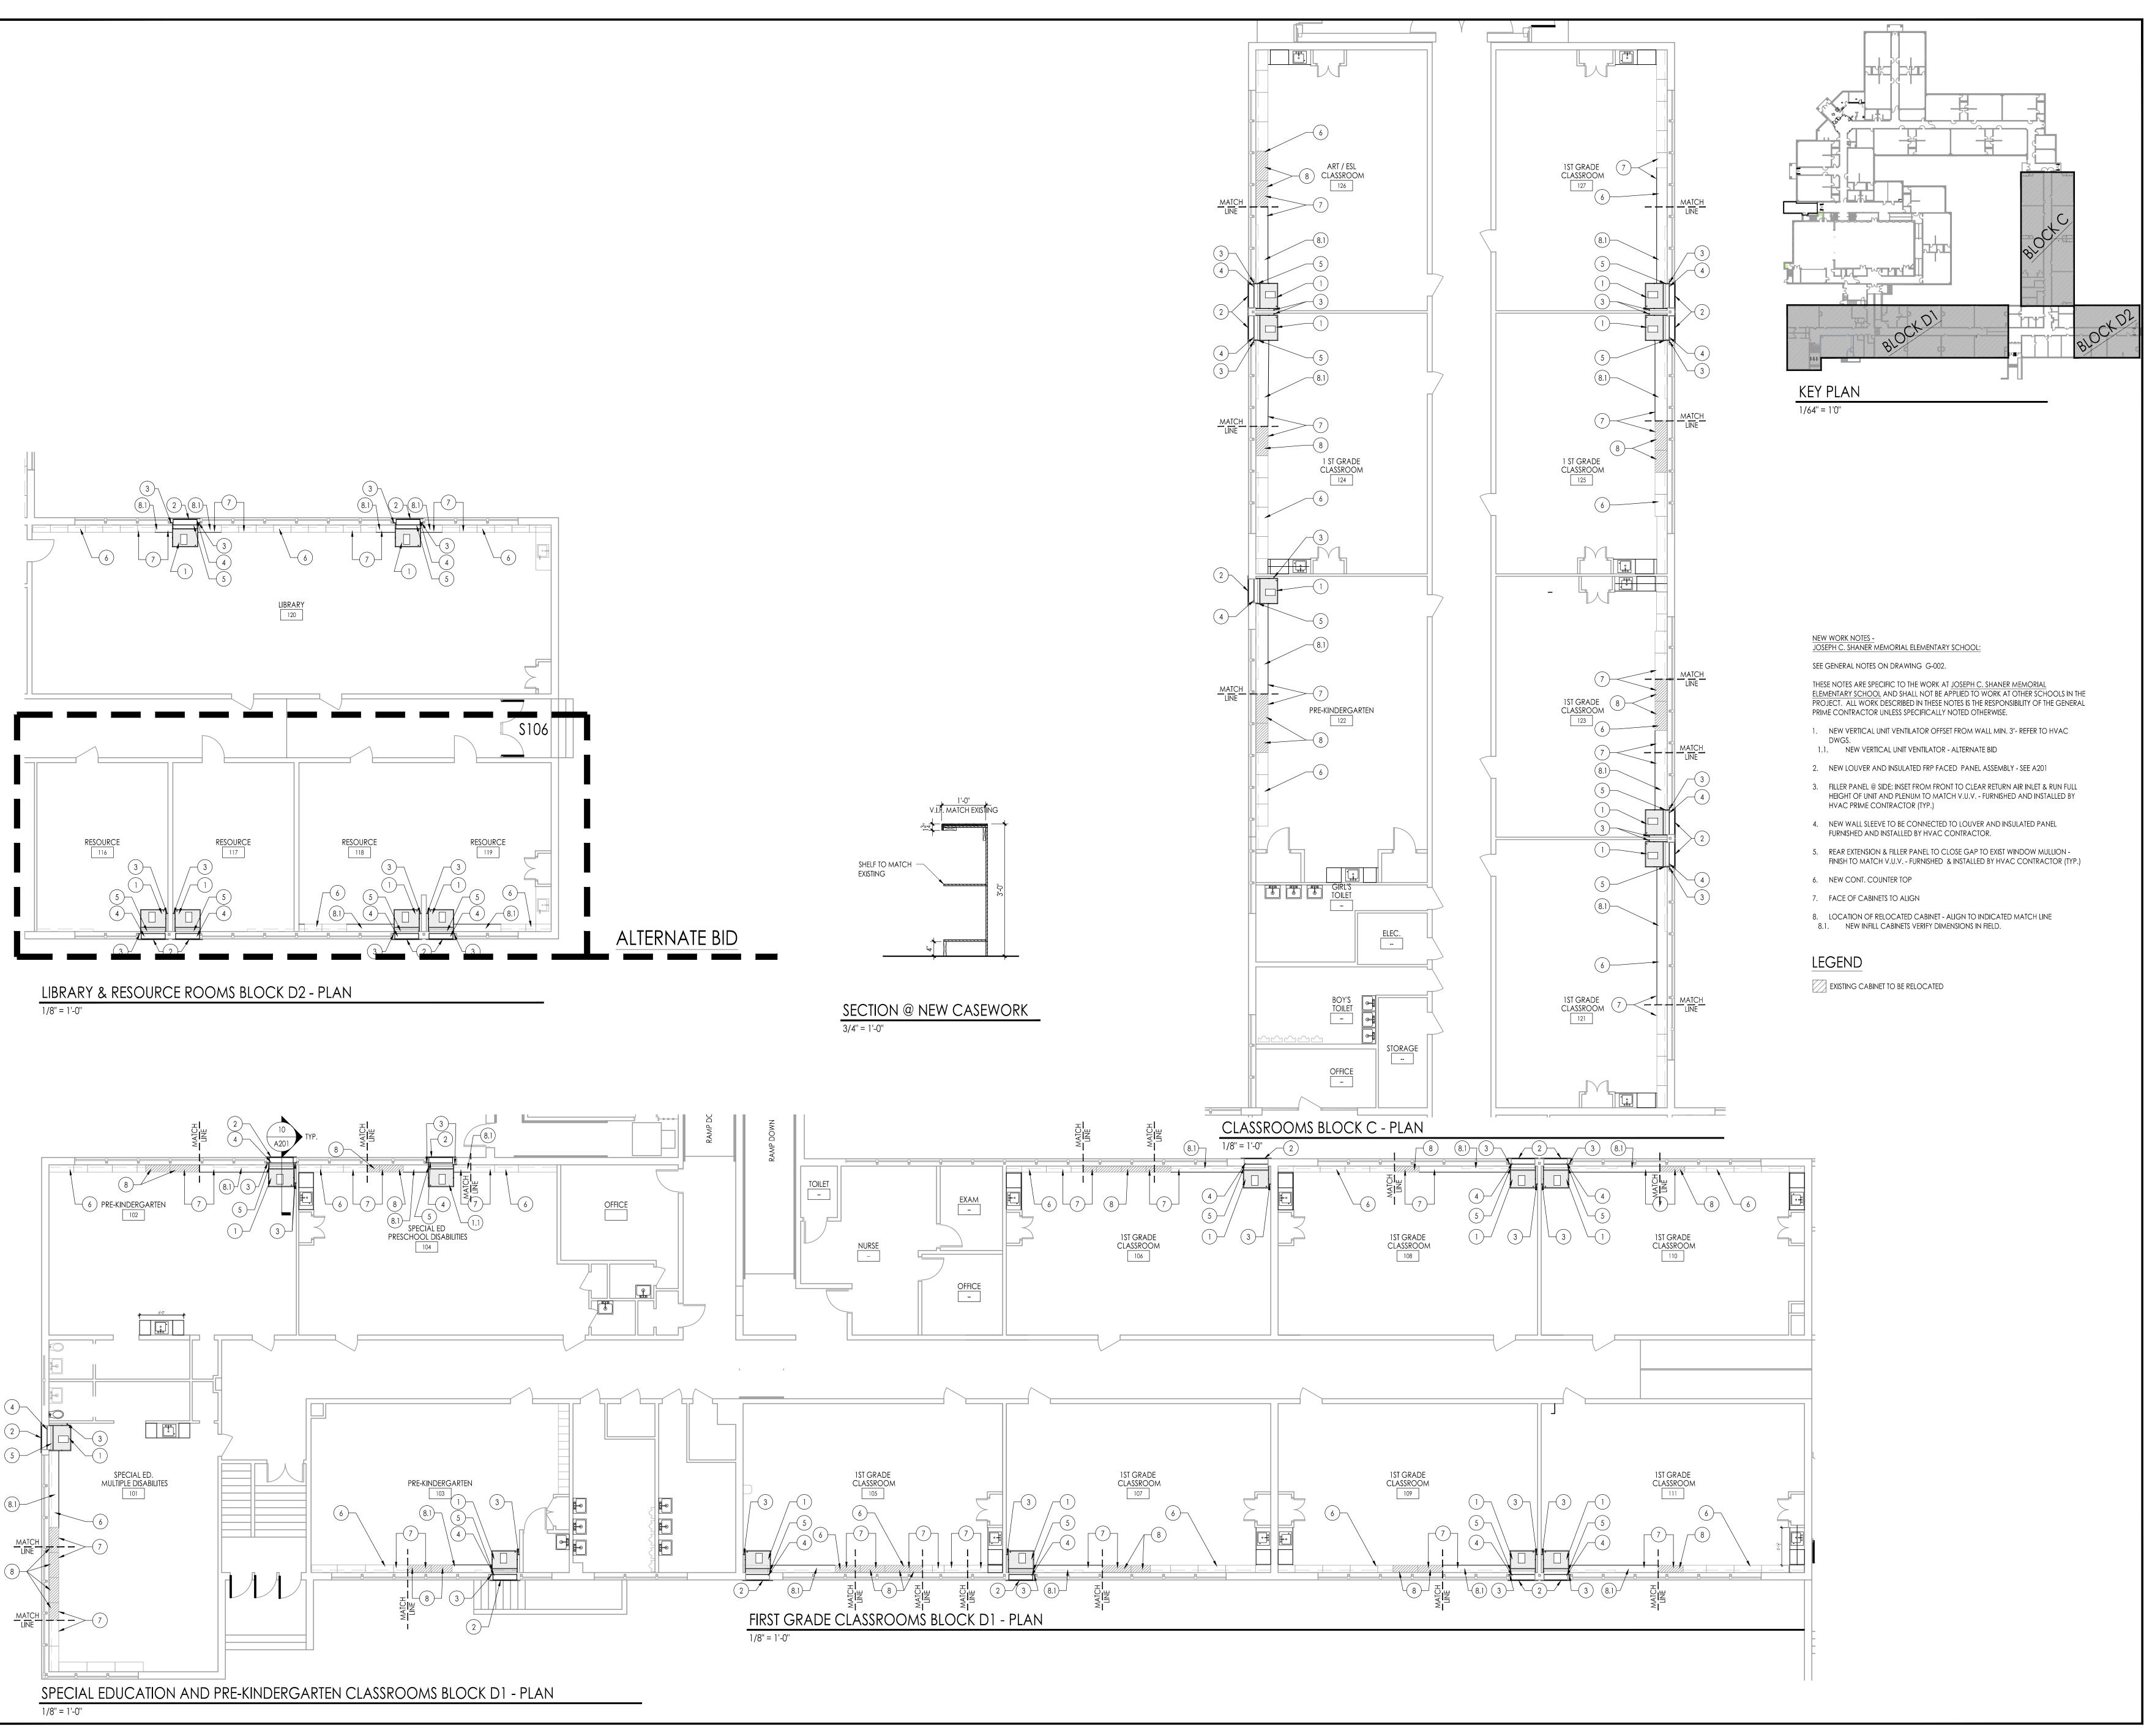
PARTIAL
FIRST FLOOR
HVAC
DEMOLITION
PLAN

BLOCK C

Revisions

No. Date Description



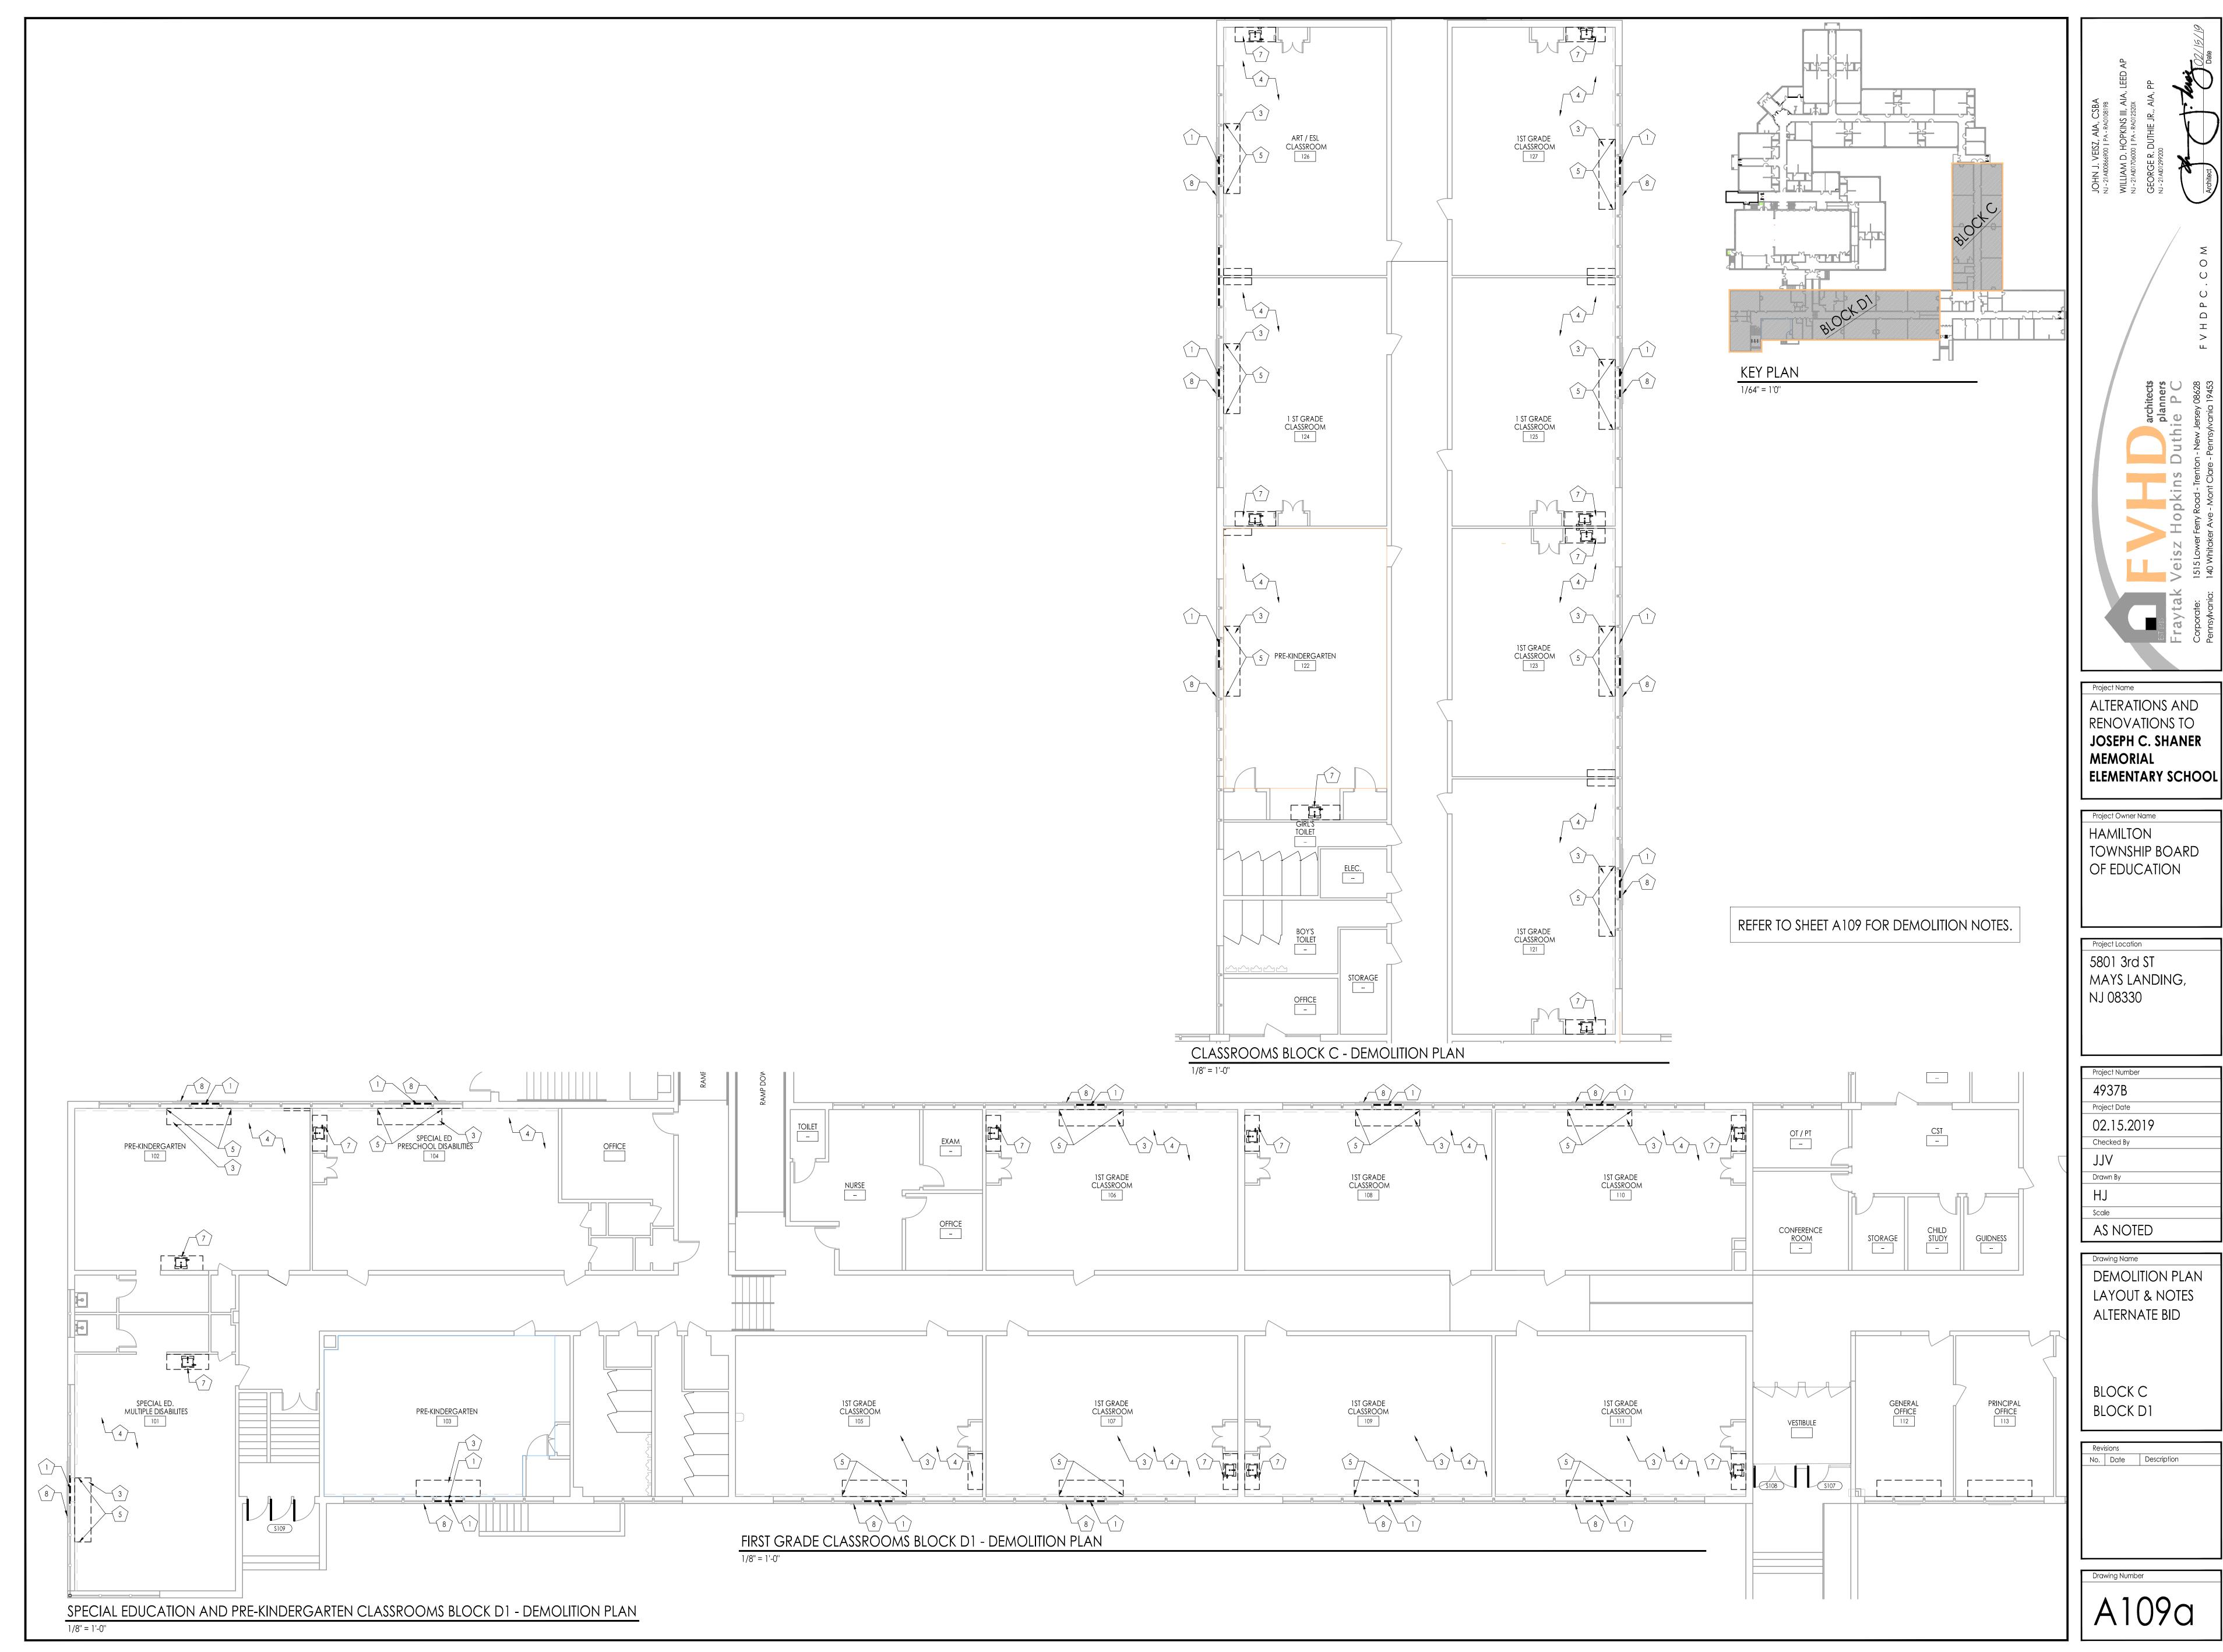

JOHN J. VEISZ, AIA, CSBA

NJ-21AI00866900 | PA-RA010819B

WILLIAM D. HOPKINS III, AIA, LEED AP

NJ-21AI01706000 | PA-RA012520X

GEORGE R. DUTHIE JR., AIA, PP

NJ-21AI01299200

ak Veisz Hopkins Duthie P C

1515 Lower Ferry Road - Trenton - New Jersey 08628

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Project Name

ALTERATIONS AND
RENOVATIONS TO
JOSEPH C. SHANER
MEMORIAL
ELEMENTARY SCHOOL

Project Owner Name

HAMILTON

TOWNSHIP BOARD

OF EDUCATION

Project Location
5801 3rd ST
MAYS LANDING,
NJ 08330

Project Number

4937B

Project Date

02.15.2019

Checked By

JJV

Drawn By

HJ

AS NOTED

Drawing Name

FLOOR PLAN


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FLOOR PLAN LAYOUT & NOTES BASE BID

BLOCK C BLOCK D2 BLOCK D2


Revisions

No. Date Description

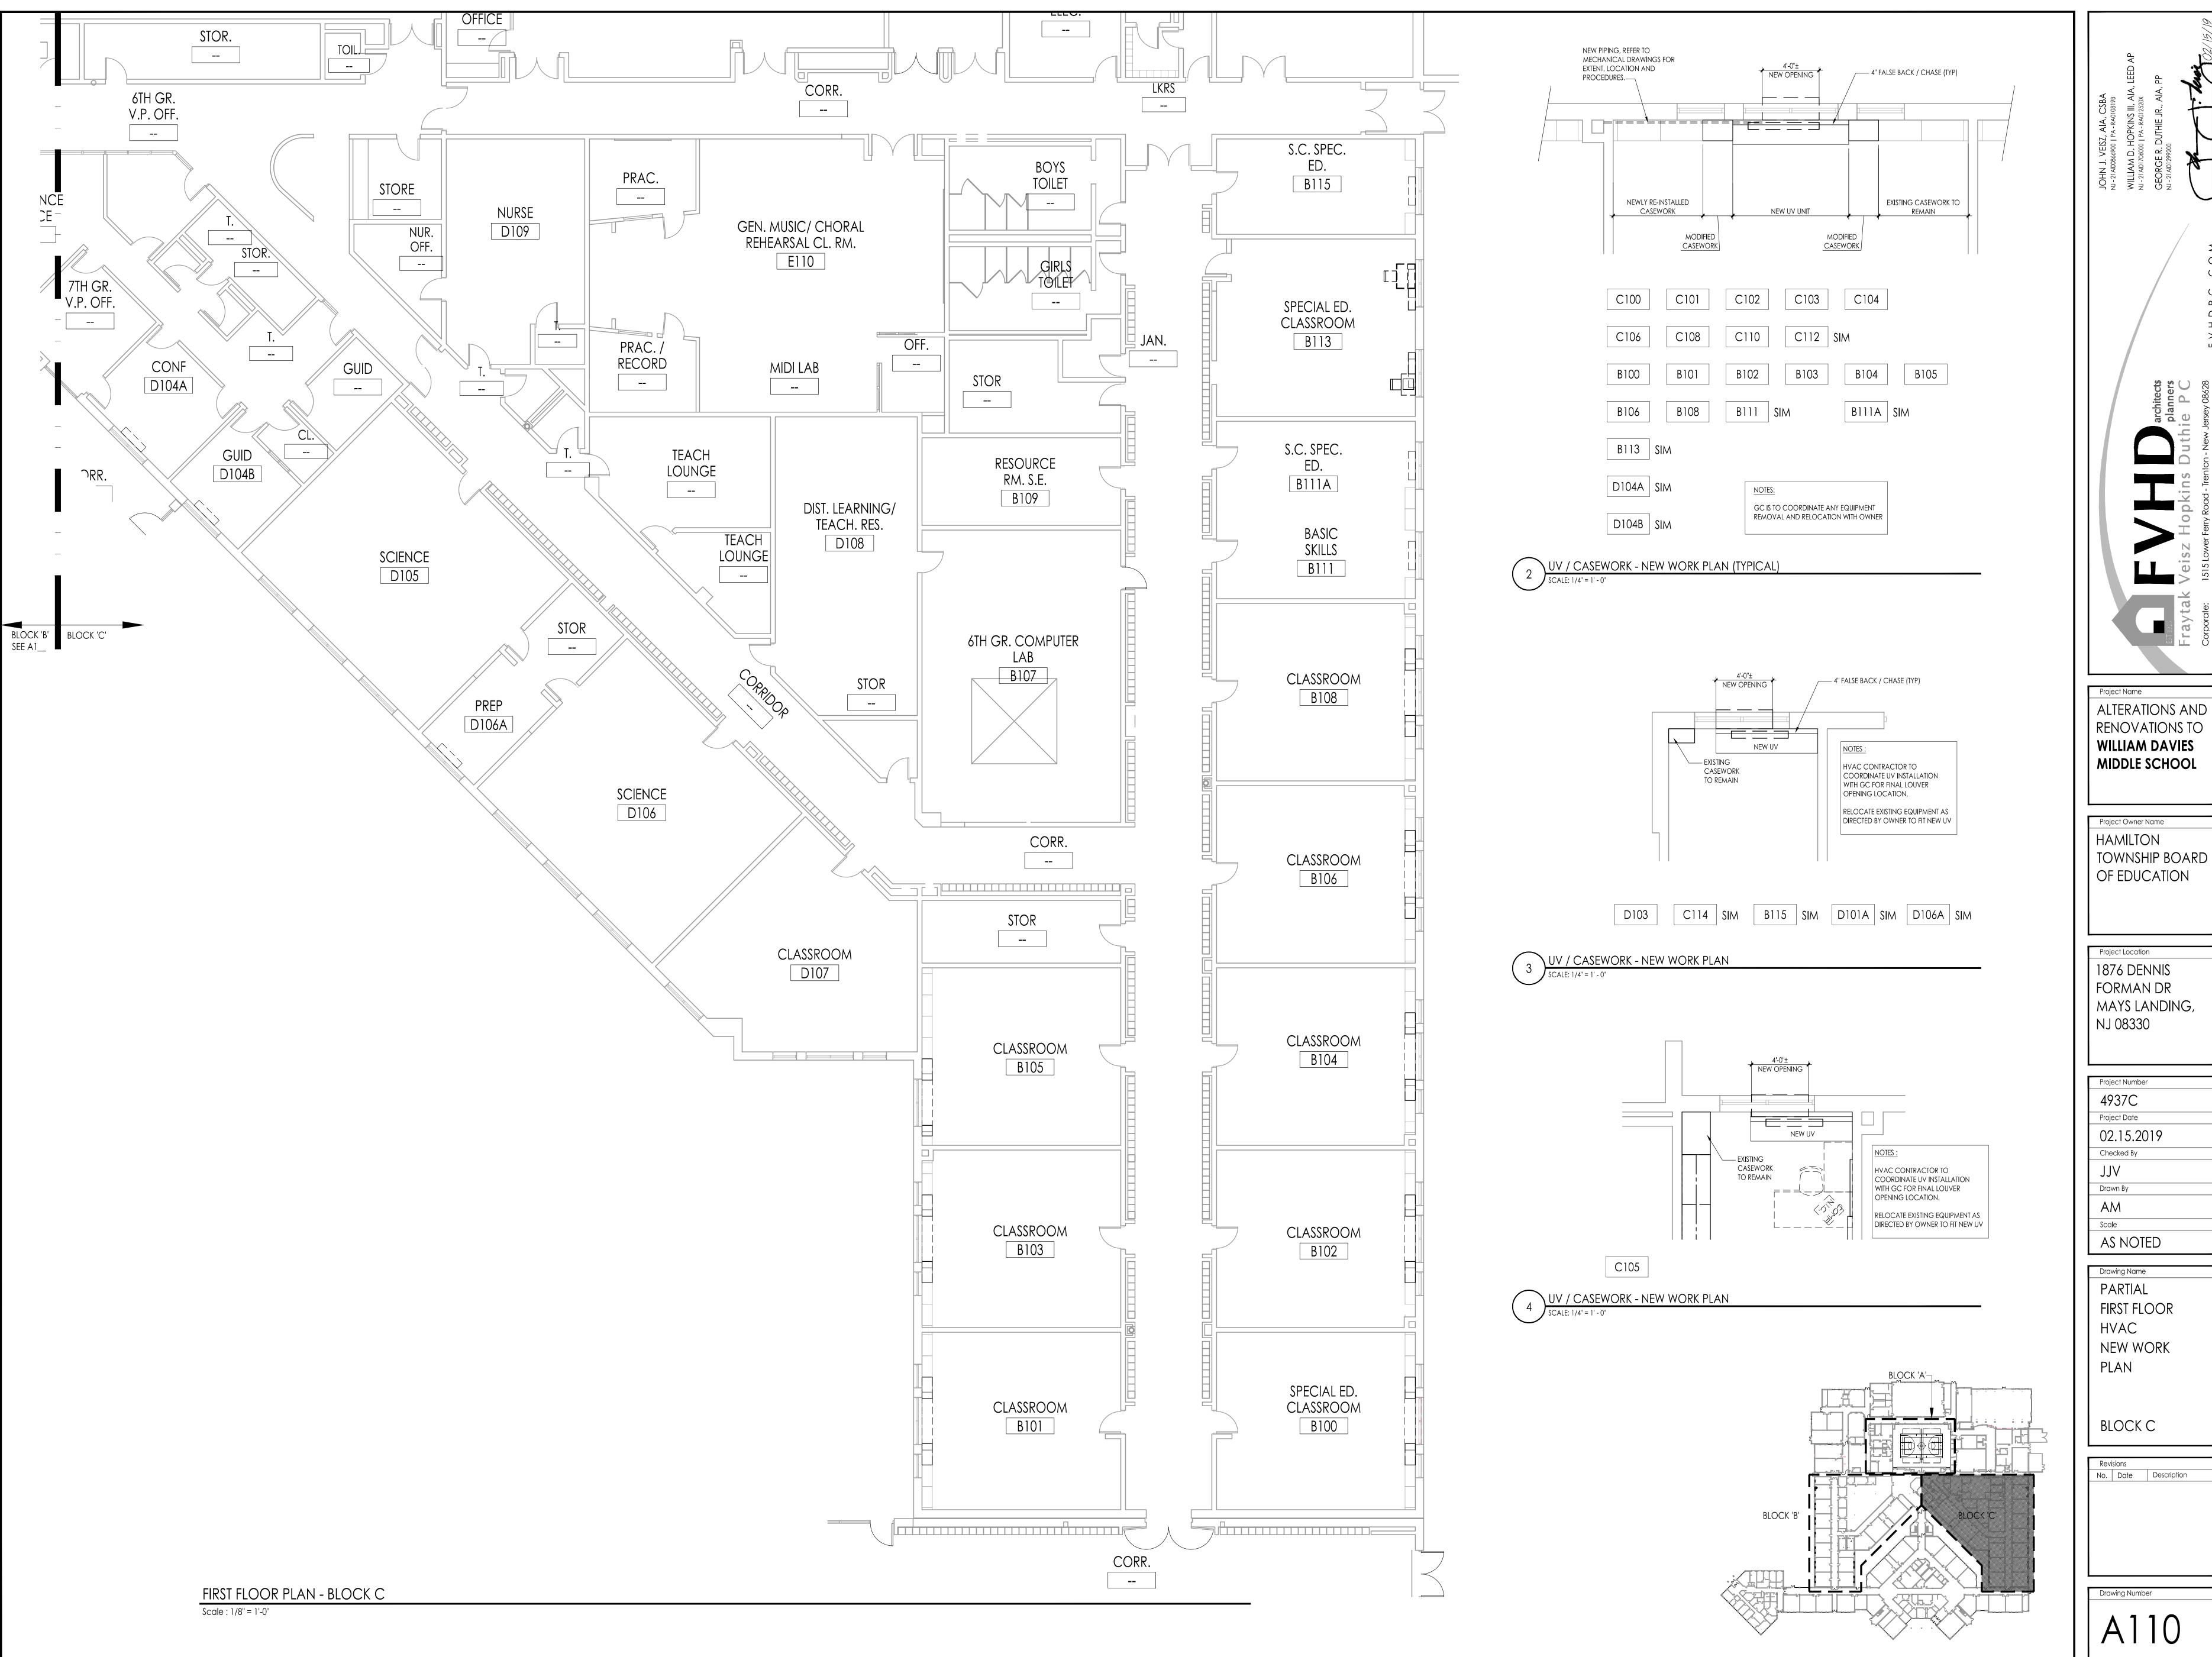

BLOCK C

Revisions
No. Date Description

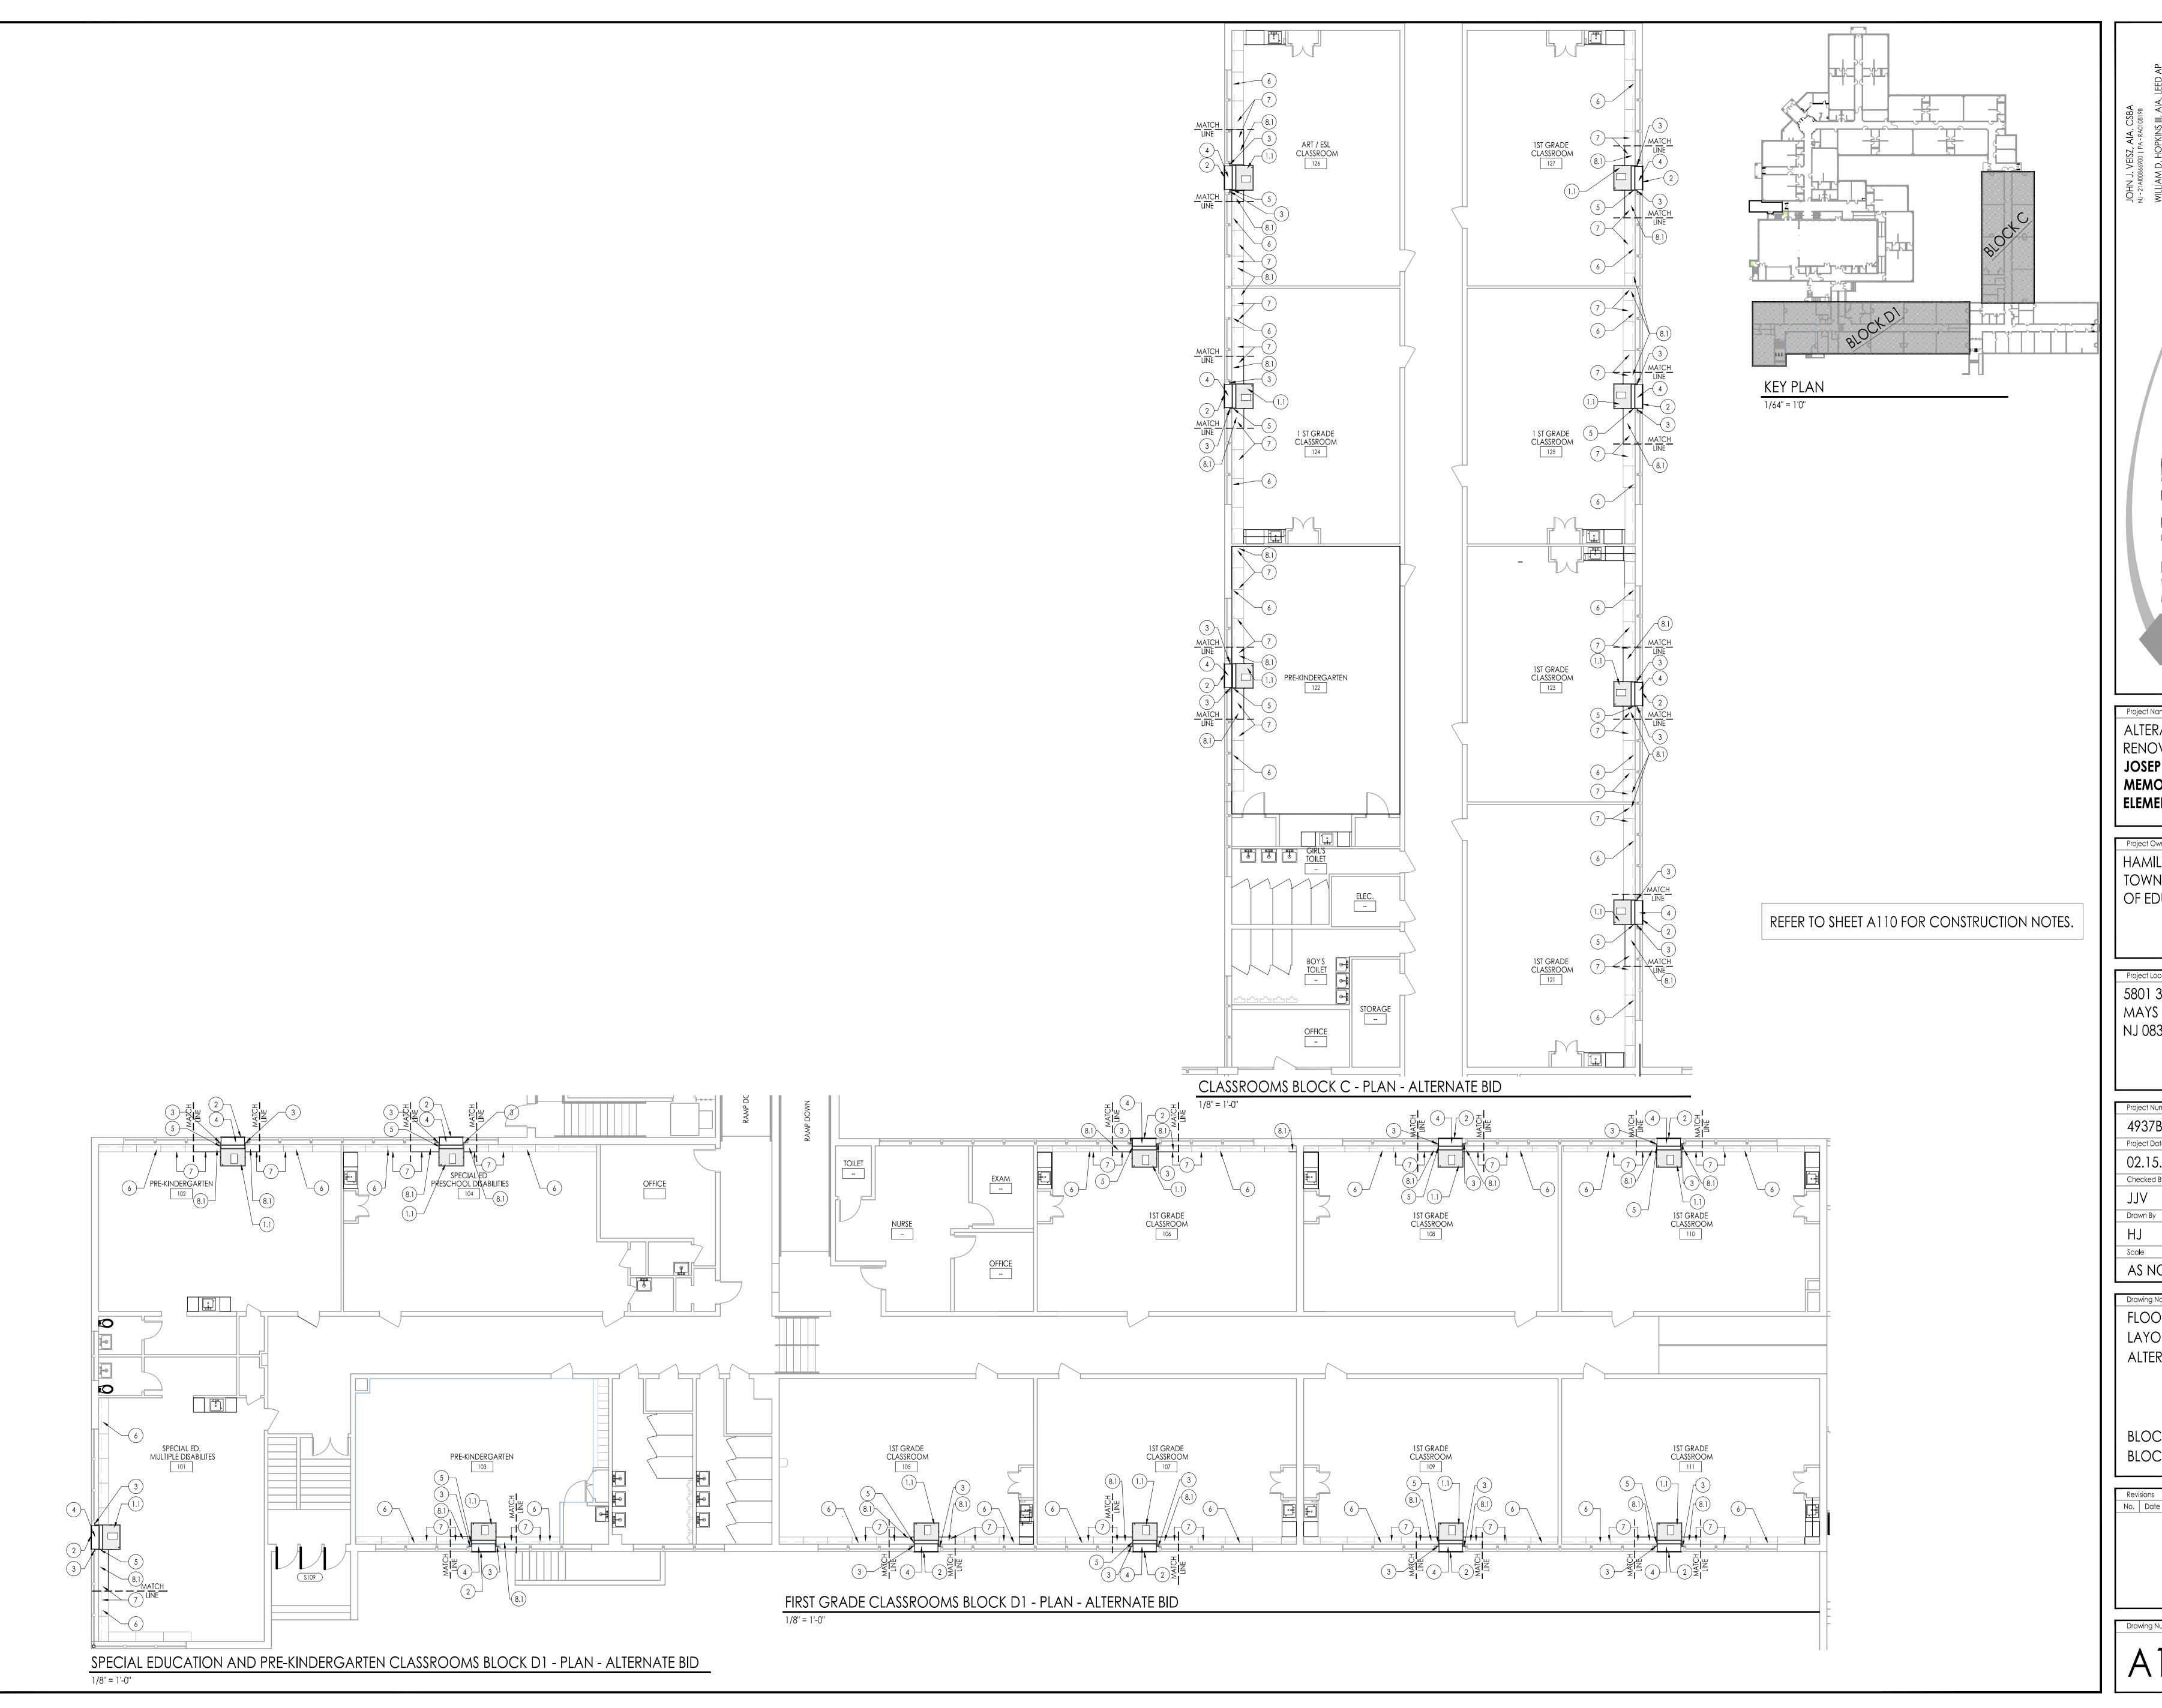

Project Owner Name HAMILTON TOWNSHIP BOARD OF EDUCATION

Project Location 5801 3rd ST MAYS LANDING, NJ 08330

Project Number 4937B Project Date 02.15.2019 Checked By

AS NOTED

FLOOR PLAN LAYOUT & NOTES ALTERNATE BID

BLOCK C BLOCK D1

No. Date Description

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JOHN J. VEISZ, AIA, CSBA
NJ-21AI00866900 I PA-RA0108198
WILLIAM D. HOPKINS III, AIA, LEED AP
NJ-21AI01706000 I PA-RA012520X
GEORGE R. DUTHIE JR., AIA, PP
NJ-21AI01299200

The planners planners planners list Veisz Hopkins Duthie P C list lower Ferry Road - Trenton - New Jersey 08628 F V H D P C

ALTERATIONS AND RENOVATIONS TO WILLIAM DAVIES MIDDLE SCHOOL

Project Owner Name

HAMILTON

TOWNSHIP BOARD

OF EDUCATION

Project Location

1876 DENNIS
FORMAN DR
MAYS LANDING,
NJ 08330

Project Number

4937C

Project Date

02.15.2019

Checked By

JJV

Drawn By

KM

Scale

PARTIAL
FIRST FLOOR
REFLECTED
CEILING PLAN

AS NOTED


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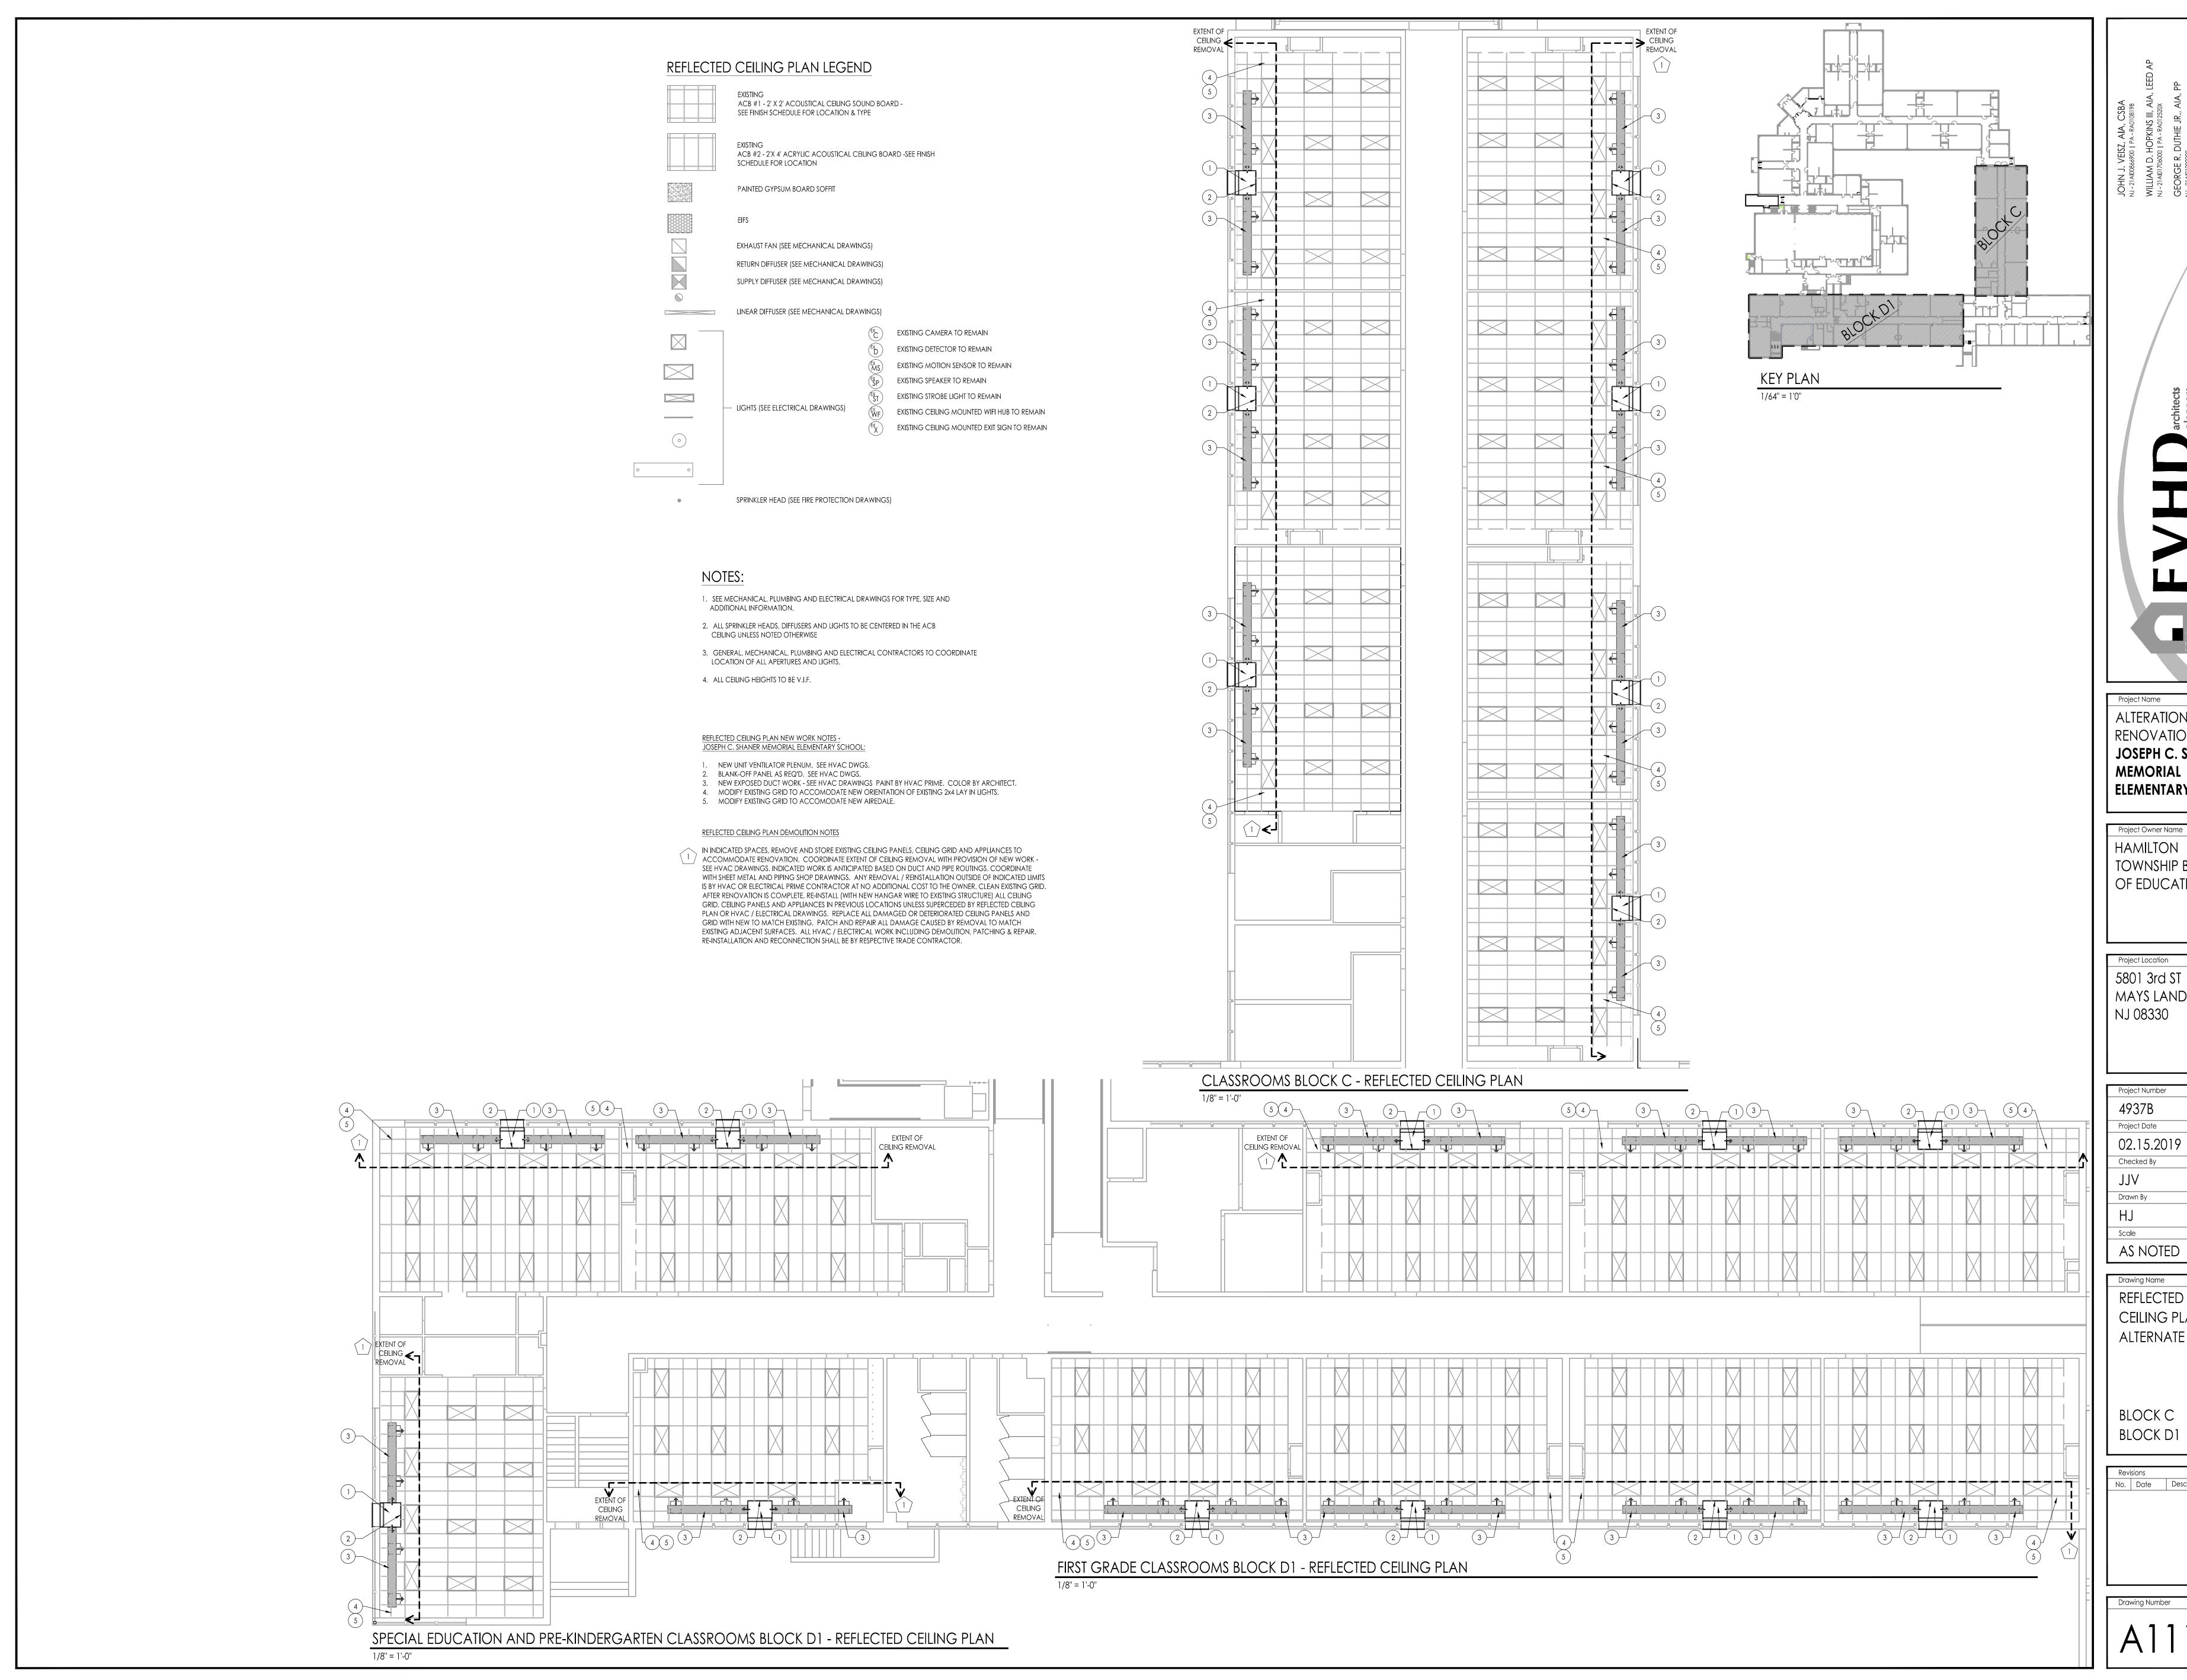
Revisions

No. Date Description

Drawing Number

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Project Owner Name HAMILTON TOWNSHIP BOARD OF EDUCATION


Project Location 5801 3rd ST MAYS LANDING, NJ 08330

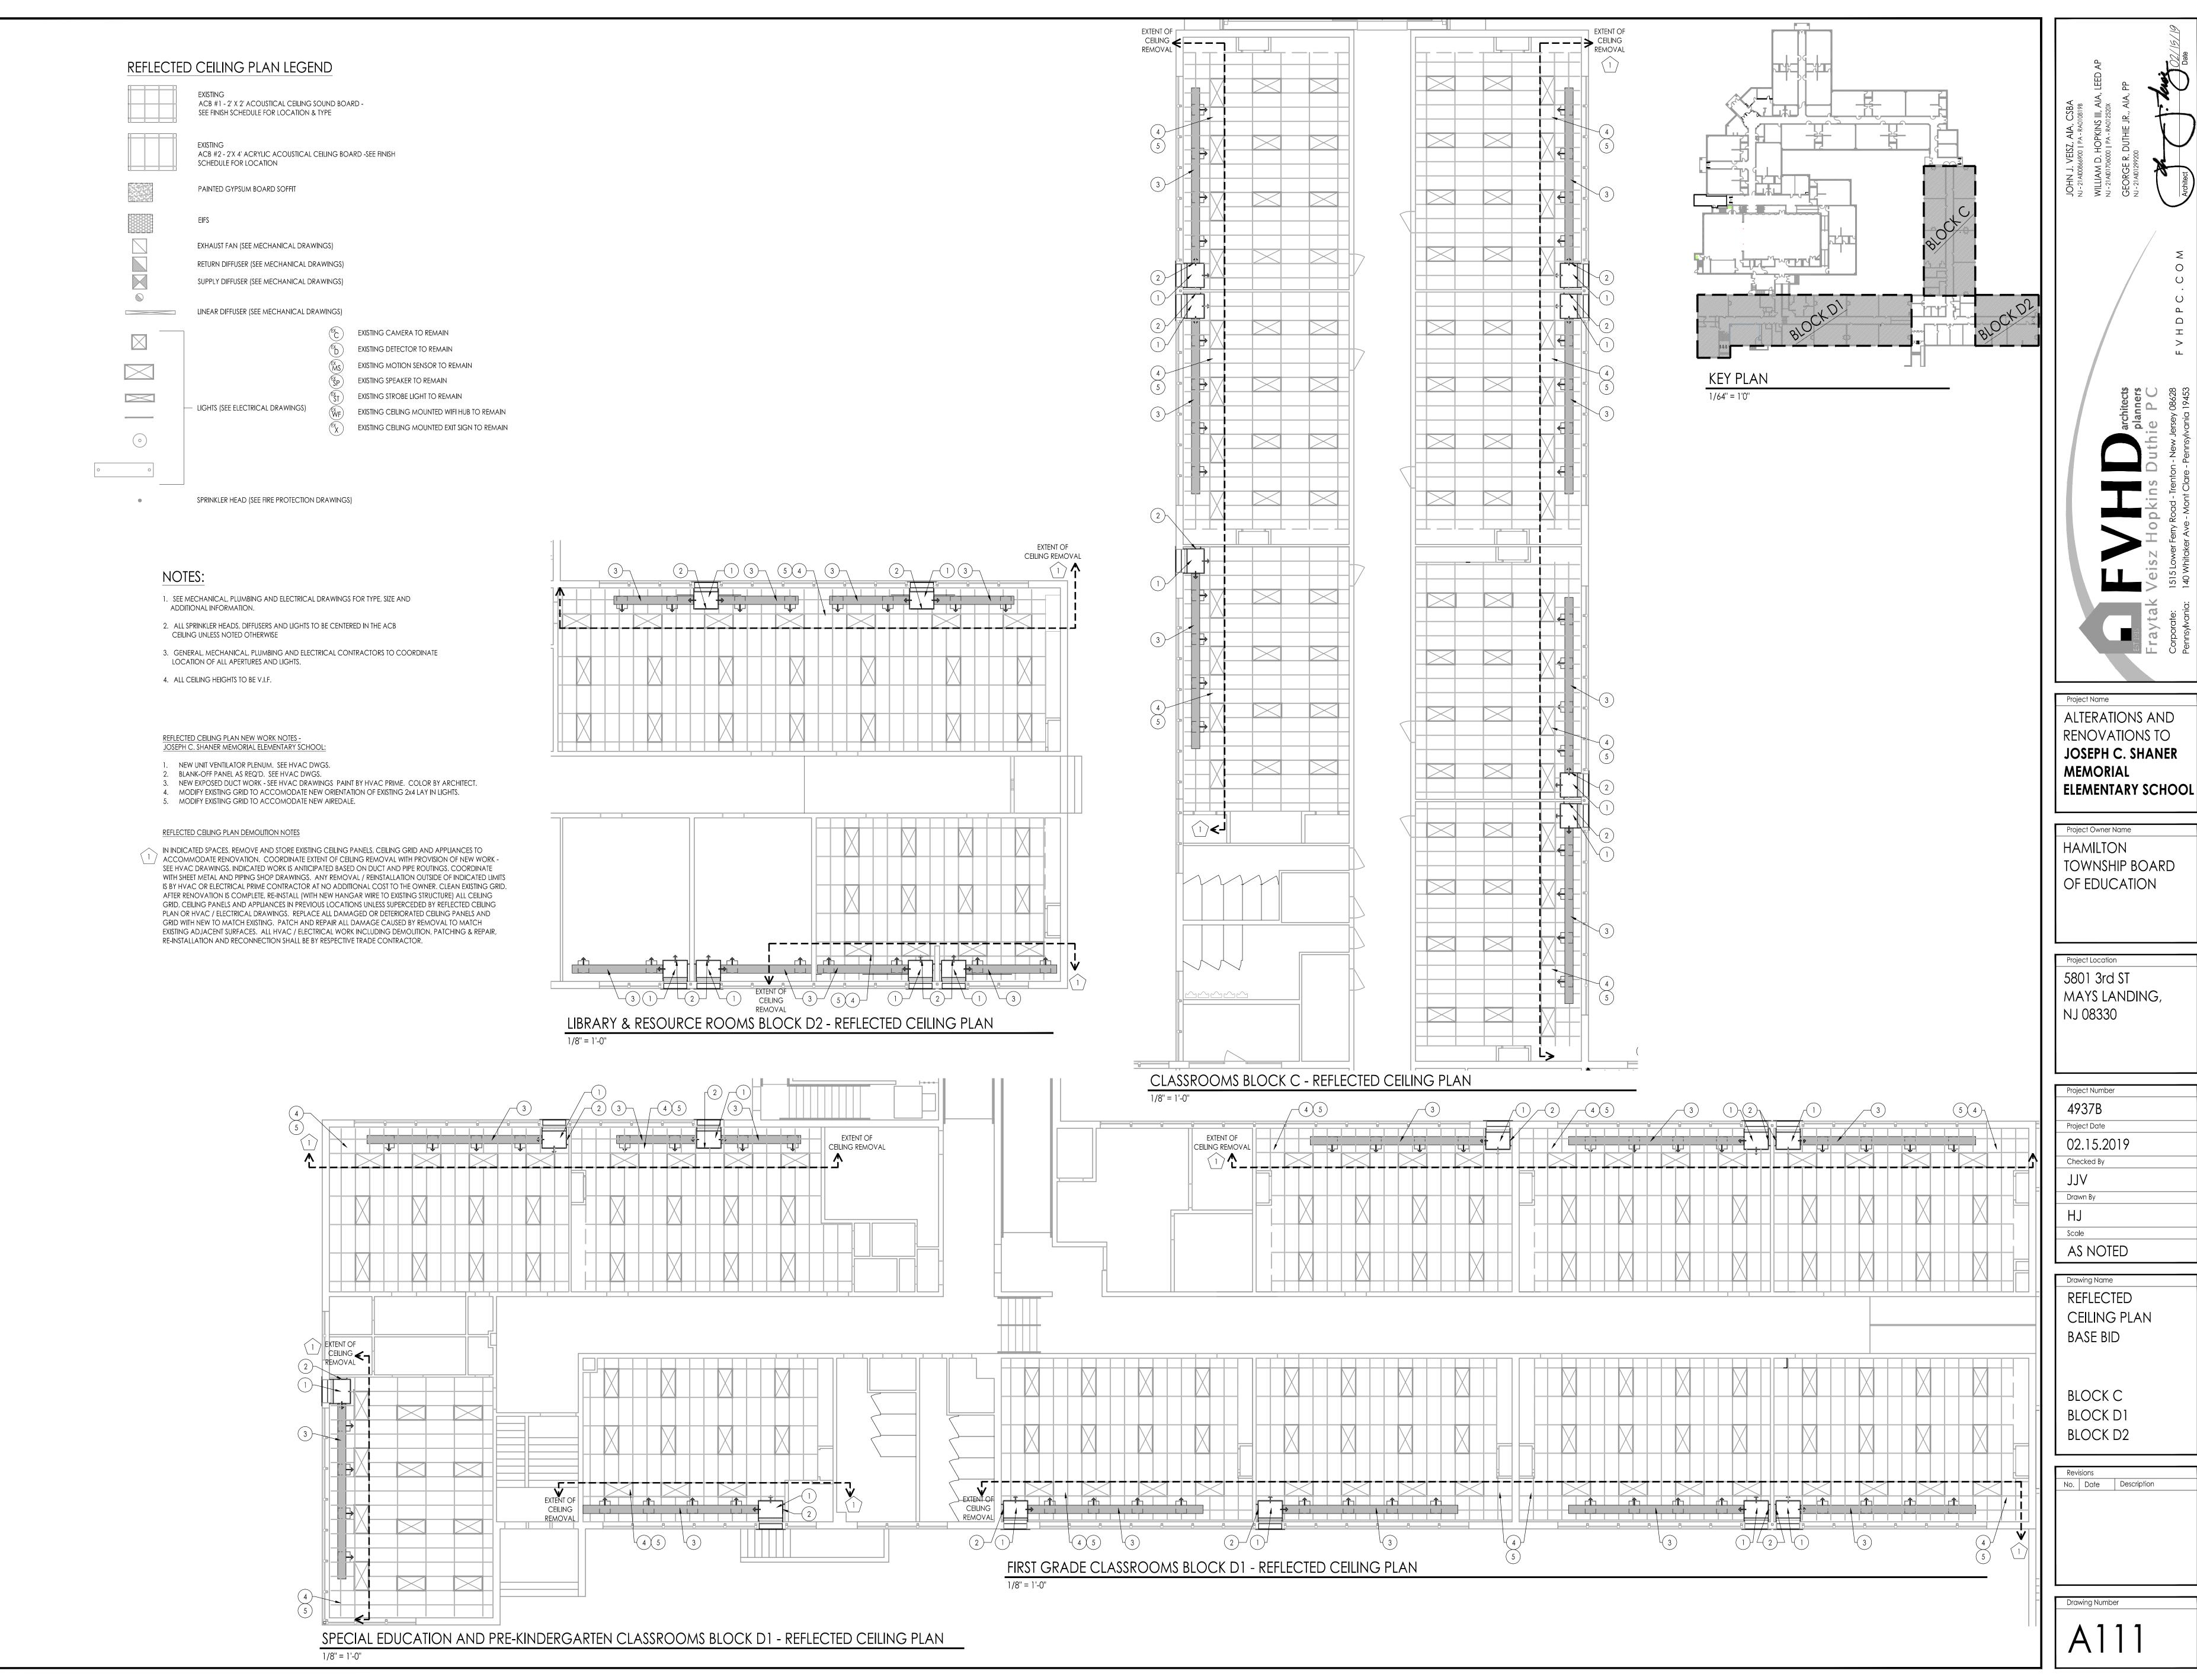
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02.15.2019

CEILING PLAN ALTERNATE BID


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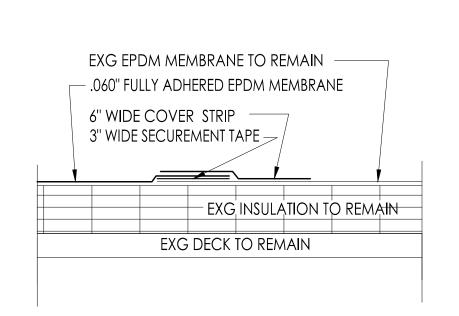


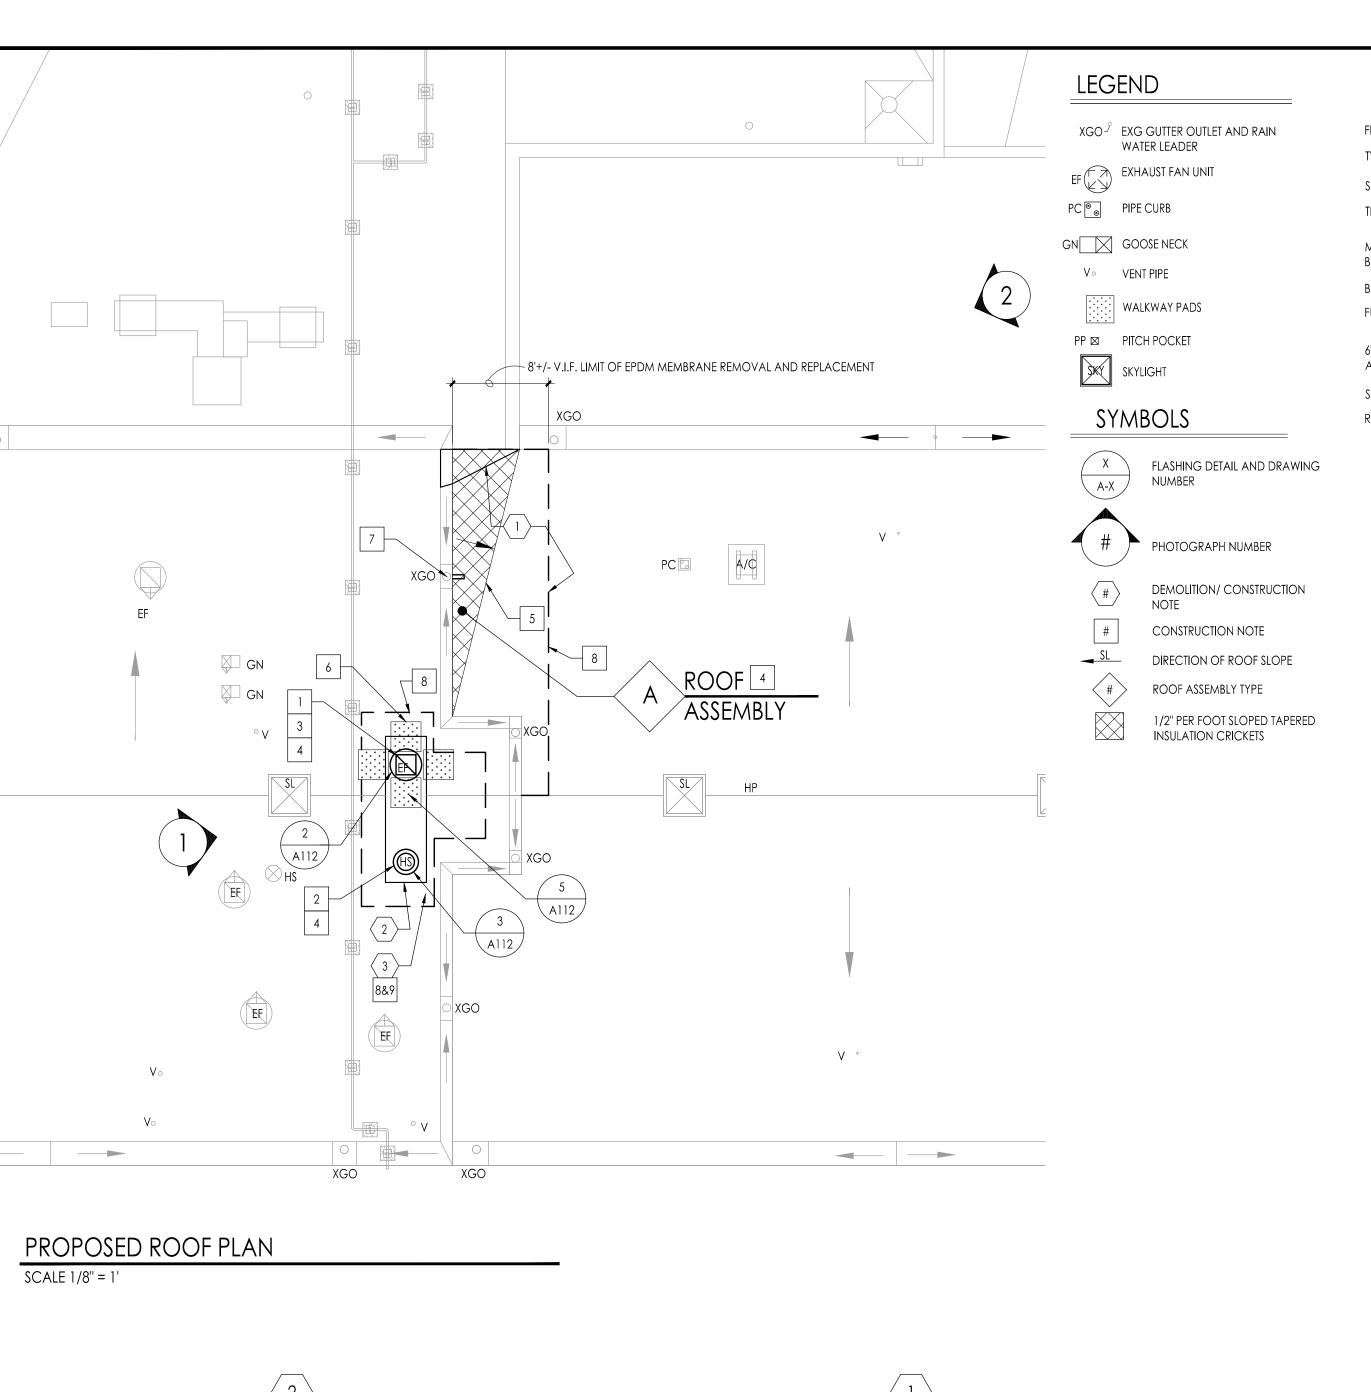

NOTE: FOR INSULATION ADHESIVE BEAD SPACING SEE DETAIL 6 THIS SHEET

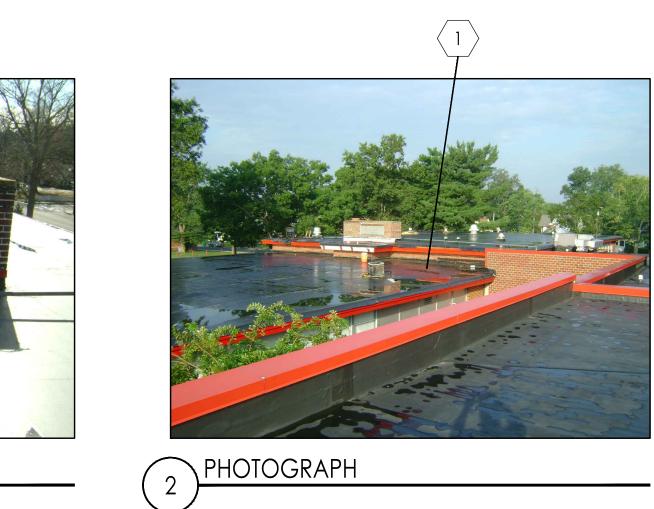
PHOTOGRAPH



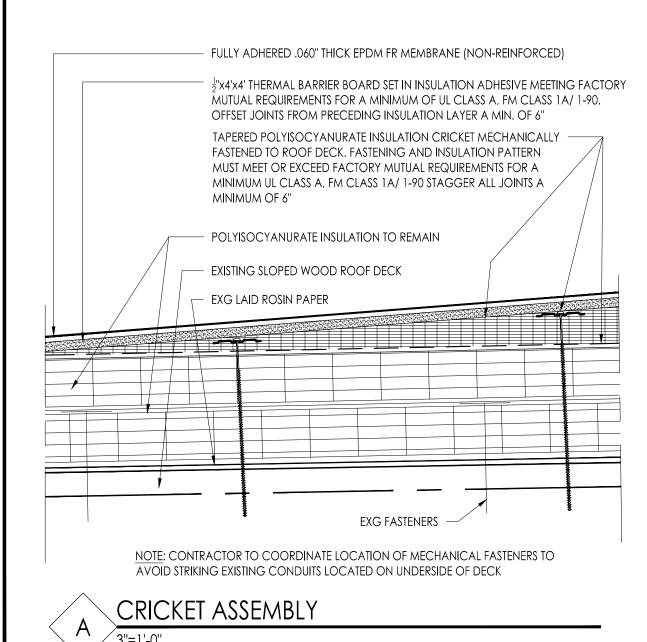


TYPICAL SPLICE OF NEW ROOF MEMBRANE INTO YEXG ROOF MEMBRANE

FLASHING SUBSTRATE - WALL OR CURB TWO PIECE METAL COUNTERFLASHING SEALANT ---TERMINATION BAR FASTENED AT 6" O.C. MECHANICALLY FASTENED $\frac{1}{2}$ " THERMAL BARRIER BOARD BONDING ADHESIVE -FULLY ADHERE .060" EPDM MEMBRANE 6" WIDE REINFORCES SECUREMENT STRIP FASTENED — AT 6" O.C. W/ FASTENER THROUGH PLATE SPLICE ADHESIVE ROOFING SYSTEM EXISTING ROOF DECK TO REMAIN TYPICAL BASE FLASHING DETAII

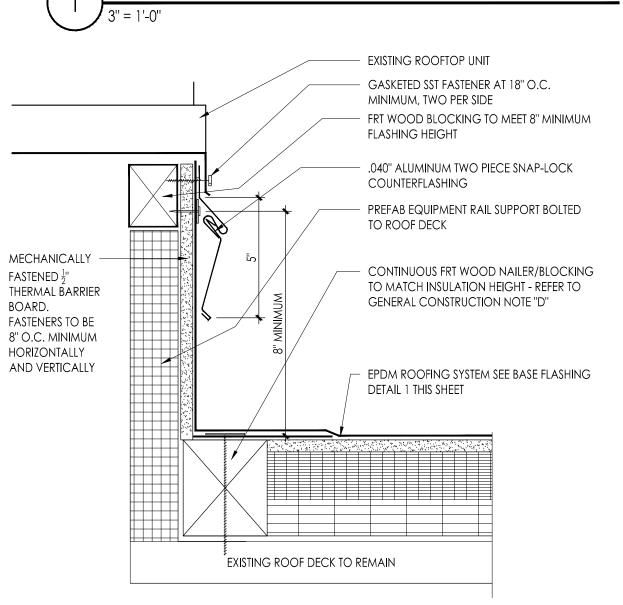



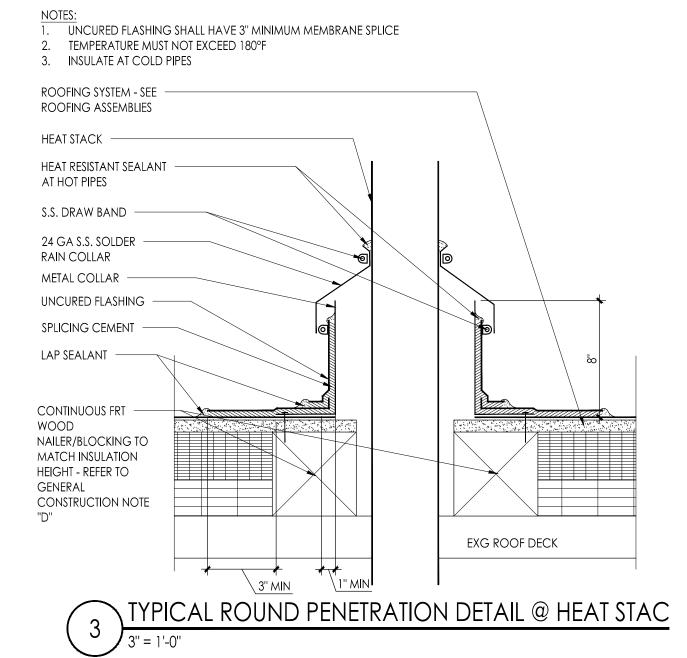

WALKWAYS MUST NOT IMPEDE THE FREE FLOW OF WATER TO THE DRAINAGE POINTS 30" X 30" WALKWAY PADS SET IN SPLICING CEMENT W/ 3" MAX. SPACING - EPDM MEMBRANE



GENERAL DEMOLITION NOTES:

- A. THE ROOFING CONTRACTOR SHALL VERIFY THE EXACT LOCATION, DIMENSION, CONDITION AND QUANTITY OF ALL ROOFTOP EQUIPMENT AND APPURTENANCES WHICH INCLUDES, BUT ARE NOT LIMITED TO: EXHAUST FANS, VENT PIPES, DRAINS, HATCHES, FLUE PIPES, HOT STACKS, HVAC EQUIPMENT, CURBS, BASE FLASHING AND OTHER PENETRATIONS AND WORK ASSOCIATED WITH THIS ROOF PROJECT. INCORPORATE SAME IN THE ROOF INSULATION SHOP DRAWING SUBMITTAL.
- B. THE ROOFING CONTRACTOR SHALL BE RESPONSIBLE TO PERFORM DEMOLITION CAREFULLY CAUSING NO DAMAGE TO EXISTING CONSTRUCTION TO REMAIN. ANY DAMAGES MUST BE REPAIRED AND OR REPLACED BY THE ROOFING CONTRACTOR TO THE OWNER'S AND ARCHITECTS SATISFACTION AND AT NO ADDITIONAL COST TO THE CONTRACT PRICE. PRIOR TO THE COMMENCEMENT OF WORK, THE ROOFING CONTRACTOR IS RESPONSIBLE TO INSPECT AND PHOTOGRAPH EXISTING CONDITIONS WHICH COULD BE MISCONSTRUED AS DAMAGE RESULTING FROM DEMOLITION AND
- C. FOR PURPOSES OF THIS PROJECT, REMOVE SHALL MEAN REMOVE AND DISPOSE OF SAME OFF SITE IN AN APPROVED AND LEGAL MANNER
- D. DETAILS REFERENCED IN THE PHOTOGRAPHS AND ON THESE DRAWINGS ARE TYPICAL. PHOTOGRAPHS ARE INTENDED TO SHOW TYPICAL EXISTING CONDITIONS AND ARE NOT INTENDED TO LIMIT SCOPE. THE ROOFING CONTRACTOR SHALL VERIFY THE TOTAL NUMBER AND EXACT LOCATION OF CONDITIONS IN THE FIELD AND PERFORM WORK IN ACCORDANCE WITH THE DETAILS REFERENCED AND/OR THOSE WHICH ARE SIMILAR.
- E. THE ROOFING CONTRACTOR SHALL COORDINATE ALL DUMPSTER STAGING AND TRUCK ROUTES WITH THE OWNER. THE ROOFING CONTRACTOR SHALL PROTECT ALL EXISTING PAVED AND PLANTED AREAS. THE ROOFING CONTRACTOR SHALL REPAIR ANY PAVED OR PLANTED AREAS TO THE SATISFACTION OF THE OWNER. THE REPAIRS ARE TO INCLUDE, BUT ARE NOT LIMITED TO, REPAVING OF ASPHALT DRIVEWAYS AND PARKING LOTS, REGRADING AND SEEDING OF LAWN AND PLAYGROUND AREAS AND REPLACING DAMAGED PLANTS, SHRUBS, ETC. ALL REPAIRS AND RESTORATIONS SHALL BE DONE AT NO ADDITIONAL COST TO THE CONTRACT PRICE.
- F. THE BUILDING IS OCCUPIED. THE ROOFING CONTRACTOR IS SOLELY RESPONSIBLE FOR ALL MEANS AND METHODS OF CONSTRUCTION AND FOR THE SAFETY OF ALL PERSONS AT THE PROJECT SITE.

DEMOLITION NOTES:

- REMOVE EXISTING CRICKET AND ROOFING MEMBRANE IN THIS AREA.
- DEMOLISH AND REMOVE EXISTING CHIMNEY BY GENERAL CONTRACTOR. ROOFING CONTRACTOR TO PROVIDE AND MAINTAIN WATERTIGHT CONDITION AFTER CHIMNEY IS REMOVED.
- \langle 3 \rangle remove existing roof in its entirety to the top of the existing roof deck which is to remain.

GENERAL CONSTRUCTION NOTES

- A. PROVIDE ROOFING MATERIALS THAT COMPLY WITH A CLASS "A" SYSTEM.
- B. NEW IMPOSED DEAD LOAD IS EQUAL TO OR LESS THAN EXISTING DEAD LOAD.
- C. ALL LOW SLOPED ROOF AREAS ARE MINIMUM OF $\frac{1}{4}$ " PER FOOT IN THE FIELD AND $\frac{1}{2}$ " PER FOOT AT THE CRICKETS. SLOPE OF CRICKET IS PERPENDICULAR TO CRICKET
- D. FRT WOOD BLOCKING SHOWN ON DRAWINGS IS DIAGRAMMATIC. PROVIDE FIRE RETARDANT TREATED WOOD BLOCKING CONSTRUCTION IN THICKNESS AND HEIGHT TO MATCH THICKNESS OF ROOF ASSEMBLY.
- E. THE ROOFING CONTRACTOR IS RESPONSIBLE FOR FLASHING ALL ROOF TOP PENETRATIONS, UNITS, AND CURBS ON THE ROOFS TO A WATERTIGHT CONDITION TO BE INCLUDED IN THE MANUFACTURER'S WARRANTY. REVIEW ALL DRAWINGS INCLUDED IN THIS SET FOR ROOFTOP PENETRATIONS. ALL ROOF TOP PENETRATIONS,
- UNITS, AND CURBS SHALL BE A MINIMUM OF 8" ABOVE THE ROOF SYSTE.M. F. HIGH POINTS INDICATED ON DRAWINGS ARE SHOWN FOR GUIDANCE ONLY. THE CONTRACTOR IS RESPONSIBLE FOR FINAL TAPERED INSULATION DESIGN. ANY REQUIRED ADJUSTMENTS MADE BY THE CONTRACTOR TO THE INDICATED DESIGN GUIDELINES ARE AT NO ADDITIONAL COST TO THE OWNER.
- G. UNLESS NOTED OTHERWISE ALL ROOFING, ACCESSORIES, MATERIALS, ETC. SHALL BE CONSIDERED NEW.
- H. CONTRACTOR SHALL MAKE NECESSARY TIE-INS AND ALTERATIONS TO EXISTING ROOF IN ACCORDANCE WITH ORIGINAL ROOF MANUFACTURERS REQUIREMENTS, SO AS TO MAINTAIN ORIGINAL WARRANTY ON EXISTING ROOF.
- I. CONTRACTOR SHALL AT ALL TIMES HAVE A FULL SET OF DRAWINGS AND SPECIFICATIONS ON ROOF TOP WHILE WORK IS IN PROGRESS
- J. CONTRACTOR IS RESPONSIBLE TO RECTIFY ANY PONDING WATER ON FINISHED ROOF SURFACE THAT REMAINS AFTER 48 HOURS AT NO ADDITIONAL COST.

CONSTRUCTION NOTES - EPDM


- ROOFTOP EQUIPMENT: RAISE CURBS ON FRT WOOD BLOCKING TO ACHIEVE THE MINIMUM 8" FLASHING HEIGHT REQUIRED. APPLY EPDM ROOFING MEMBRANE UP CURB USING SECUREMENT STRIP AT BASE OF CURB AND FASTEN ALONG TOP EDGE. INSTALL TWO-PIECE COUNTERFLASHING UP UNDER THE ROOFTOP UNIT'S COUNTERFLASHING WITH CONTINUOUS CORNERS SEE DETAIL 2 THIS SHEET.
- HEAT STACKS: INSTALL ROOF ANGLE FLANGE AND MEMBRANE FLASHING ON THE TOP SURFACE OF THE NEW ROOFING MEMBRANE SYSTEM. COVER TOP OF ROOF
 ANGLE FLANGE WITH LIMBRELLA SECURED IN PLACE WITH A STRAP CLAMP AND HEAT RESISTANT SEALANT SEE DETAIL 3 THIS SHEET. ANGLE FLANGE WITH UMBRELLA SECURED IN PLACE WITH A STRAP CLAMP AND HEAT RESISTANT SEALANT - SEE DETAIL 3 THIS SHEET.
- ALL CONDITIONS MEETING THE ROOFING PERPENDICULAR: INSTALL INSULATION AND SECUREMENT STRIP FASTERILD TO ROOF DEGLET THE BOOF OF THE SECUREMENT STRIP WITH EPDM MEMBRANE UP VERTICAL SURFACE. ADHERE MEMBRANE TO INSULATION AND VERTICAL SURFACE WITH BONDING ADHESIVE AND TO THE SECUREMENT STRIP WITH THE TOP EDGE OF THE MEMBRANE SECURE MEMBRANE ALONG THE TOP EDGE EPDM ALL CONDITIONS MEETING THE ROOFING PERPENDICULAR: INSTALL INSULATION AND SECUREMENT STRIP FASTENED TO ROOF DECK AT THE BASE OF THE WALL. RUN SPLICE ADHESIVE. APPLY WATERBLOCK BEHIND MEMBRANE JUST BELOW THE TOP EDGE OF THE MEMBRANE. SECURE MEMBRANE ALONG THE TOP EDGE EPDM THROUGH TERMINATION BAR 6" O.C. AND APPLY SEALANT. COVER ALL TERMINATION BARS WITH TWO-PIECE METAL COUNTERFLASHING SEE DETAIL 1 THIS SHEET.
- EXG ROOFS TO REMAIN ARE UNDER WARRANTY, INSTALLATION OF ROOFTOP EQUIPMENT IN THESE AREAS SHALL BE DONE IN ACCORDANCE WITH THE ROOFING MANUFACTURES REQUIREMENTS TO MAINTAIN SAID WARRANTY, TYPICAL.
- CONSTRUCT 1/2" PER SLOPE CRICKET W/ POLYISOCYANURATE INSULATION AND 1/2" THICK THERMAL BARRIER BOARD. FASTEN POLYISOCYANURATE INSULATION THROUGH EXISTING ROOF SYSTEM INTO WOOD DECK. THERMAL BARRIER BOARD SHALL BE ADHEARED TO POLYISOCYANURATE INSULATION - SEE ASSEMBLY "A" THIS SHEET.
- WALKWAY PADS INSTALL AROUND ALL ROOFTOP UNITS, AND ROOFTOP EQUIPMENT. MODIFY WALKWAYS AS REQUIRED SO THAT THE PAD DOES NOT IMPEDE THE FREE FLOW OF WATER TO THE DRAINAGE POINTS. SEE DETAIL 5 THIS SHEET.
- 7 EXG DOWNSPOUT SHORTEN AND MODIFY EXG DOWNSPOUT TO ACCOMMODATE INCREASED HEIGHT OF NEW CRICKET BELOW DOWNSPOUT. IF DOWNSPOUT CANNOT BE MODIFIED REPLACE W/ NEW TO MATCH EXG IN ALL RESPECTS AT NO ADDITIONAL COST TO OWNER.
- 8 NEW MEMBRANE TIE-IN INSTALL NEW EPDM MEMBRANE FLASHING AND SPLICE TO EPDM EXISTING MEMBRANE. TIE-IN AS PER MANUFACTURER'S REQUIREMENTS TO MAINTAIN EXG WARRANTY SEE DETAIL 4 THIS SHEET.
- 9 INSTALL ROOF INSULATION AND THERMAL BARRIER BOARD TO MATCH ADJACENT SLOPE, THICKNESS, R-VALUE AND SLOPE. INSTALL FULLY-ADHERED .060" EPDM MEMBRANE IN BONDING ADHESIVE. DO NOT WALK OR RUN EQUIPMENT UPON NEWLY APPLIED ROOFING PLIES UNTIL THE ADHESIVE HAS SET UP TO ELIMINATE THE

STAGING NOTES:


- 1. ROOF ACCESS THROUGH THE BUILDING IS NOT PERMITTED.
- 2. TEMPORARY TOILETS SHALL BE PROVIDED BY THE CONTRACTOR AND PLACEMENT COORDINATED WITH OWNER.

POTENTIAL FOR VOIDS. INSTALL NEW FLASHING AND METAL COUNTERFLASHING AT HEAT STACK AND ROOF CURB.

- 3. CONSTRUCTION SAFETY FENCING SHALL BE INSTALLED AROUND ALL STAGING AREAS.
- 4. THE CONTRACTOR IS TO CONTACT THE LOCAL MUNICIPALITY AND CONFIRM WORKING HOURS AND COMPLY WITH ALL NOISE ORDINANCE REQUIREMENTS. 5. PARKING, OF CONSTRUCTION VEHICLES, DUMPSTERS, AND EQUIPMENT IS NOT PERMITTED ON THE STREETS.
- 6. DUMPSTERS MUST BE EMPTIED AT THE END OF EACH WORK DAY.
- 7. NO ENTRANCES, EXITS OR DRIVEWAYS SHALL BE BLOCKED AT ANY TIME.
- 8. ALL STAGING AREAS MUST BE APPROVED IN ADVANCE BY THE OWNER. THE ROOFING CONTRACTOR MUST SUBMIT A STAGING PLAN AND HAVE THE PLAN APPROVED BY THE OWNER. IF CHANGES TO THE STAGING PLAN MUST BE MADE DURING THE PROJECT, THE ROOFING CONTRACTOR MUST RESUBMIT A REVISED PLAN TO THE OWNER AND OBTAIN WRITTEN APPROVAL
- 9. THE CONTRACTOR IS NOT PERMITTED TO USE THE ROOFS THAT ARE NOT IN CONTRACT IN ANY CAPACITY.
- 10. ALL LAWN AND PAVED AREAS DAMAGED OR DISTURBED IN ANY WAY SHALL BE CLEANED AND RESTORED TO PRE-CONSTRUCTION CONDITION AT THE CONCLUSION OF THE WORK.
- 11. NO STAGING IS PERMITTED ON THE SIDEWALKS.

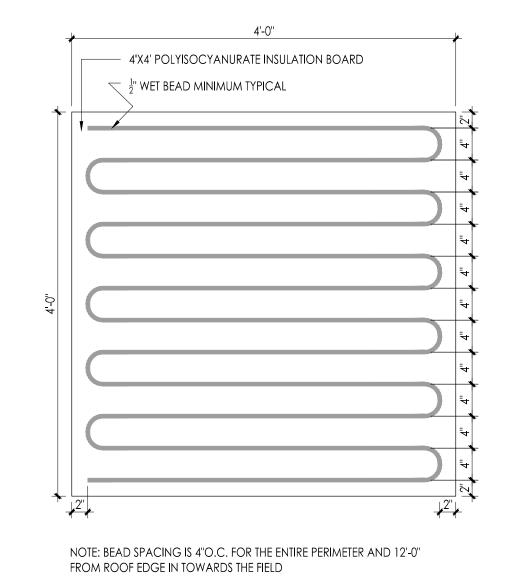



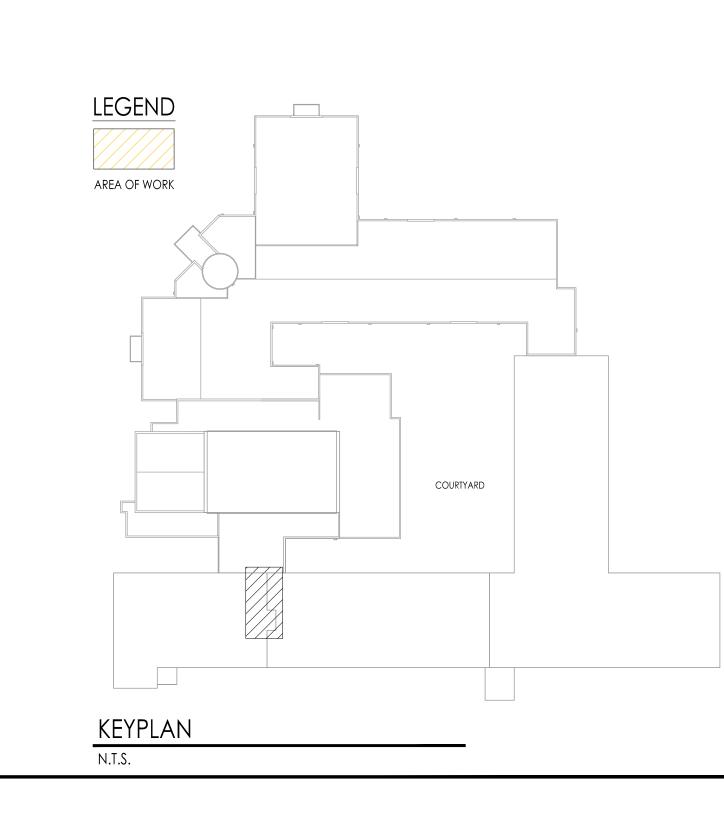

ALTERATIONS AND RENOVATIONS TO **JOSEPH C. SHANER MEMORIAL ELEMENTARY SCHOOL**

Project Owner Name HAMILTON TOWNSHIP BOARD OF EDUCATION

Project Location 5801 3rd ST MAYS LANDING, NJ 08330


Project Number 4937B Project Date 02.15.2019


Checked By Drawn By

AS NOTED

Drawing Name PARTIAL ROOF PLAN, NOTES AND ROOFING DETAILS

No. Date Description

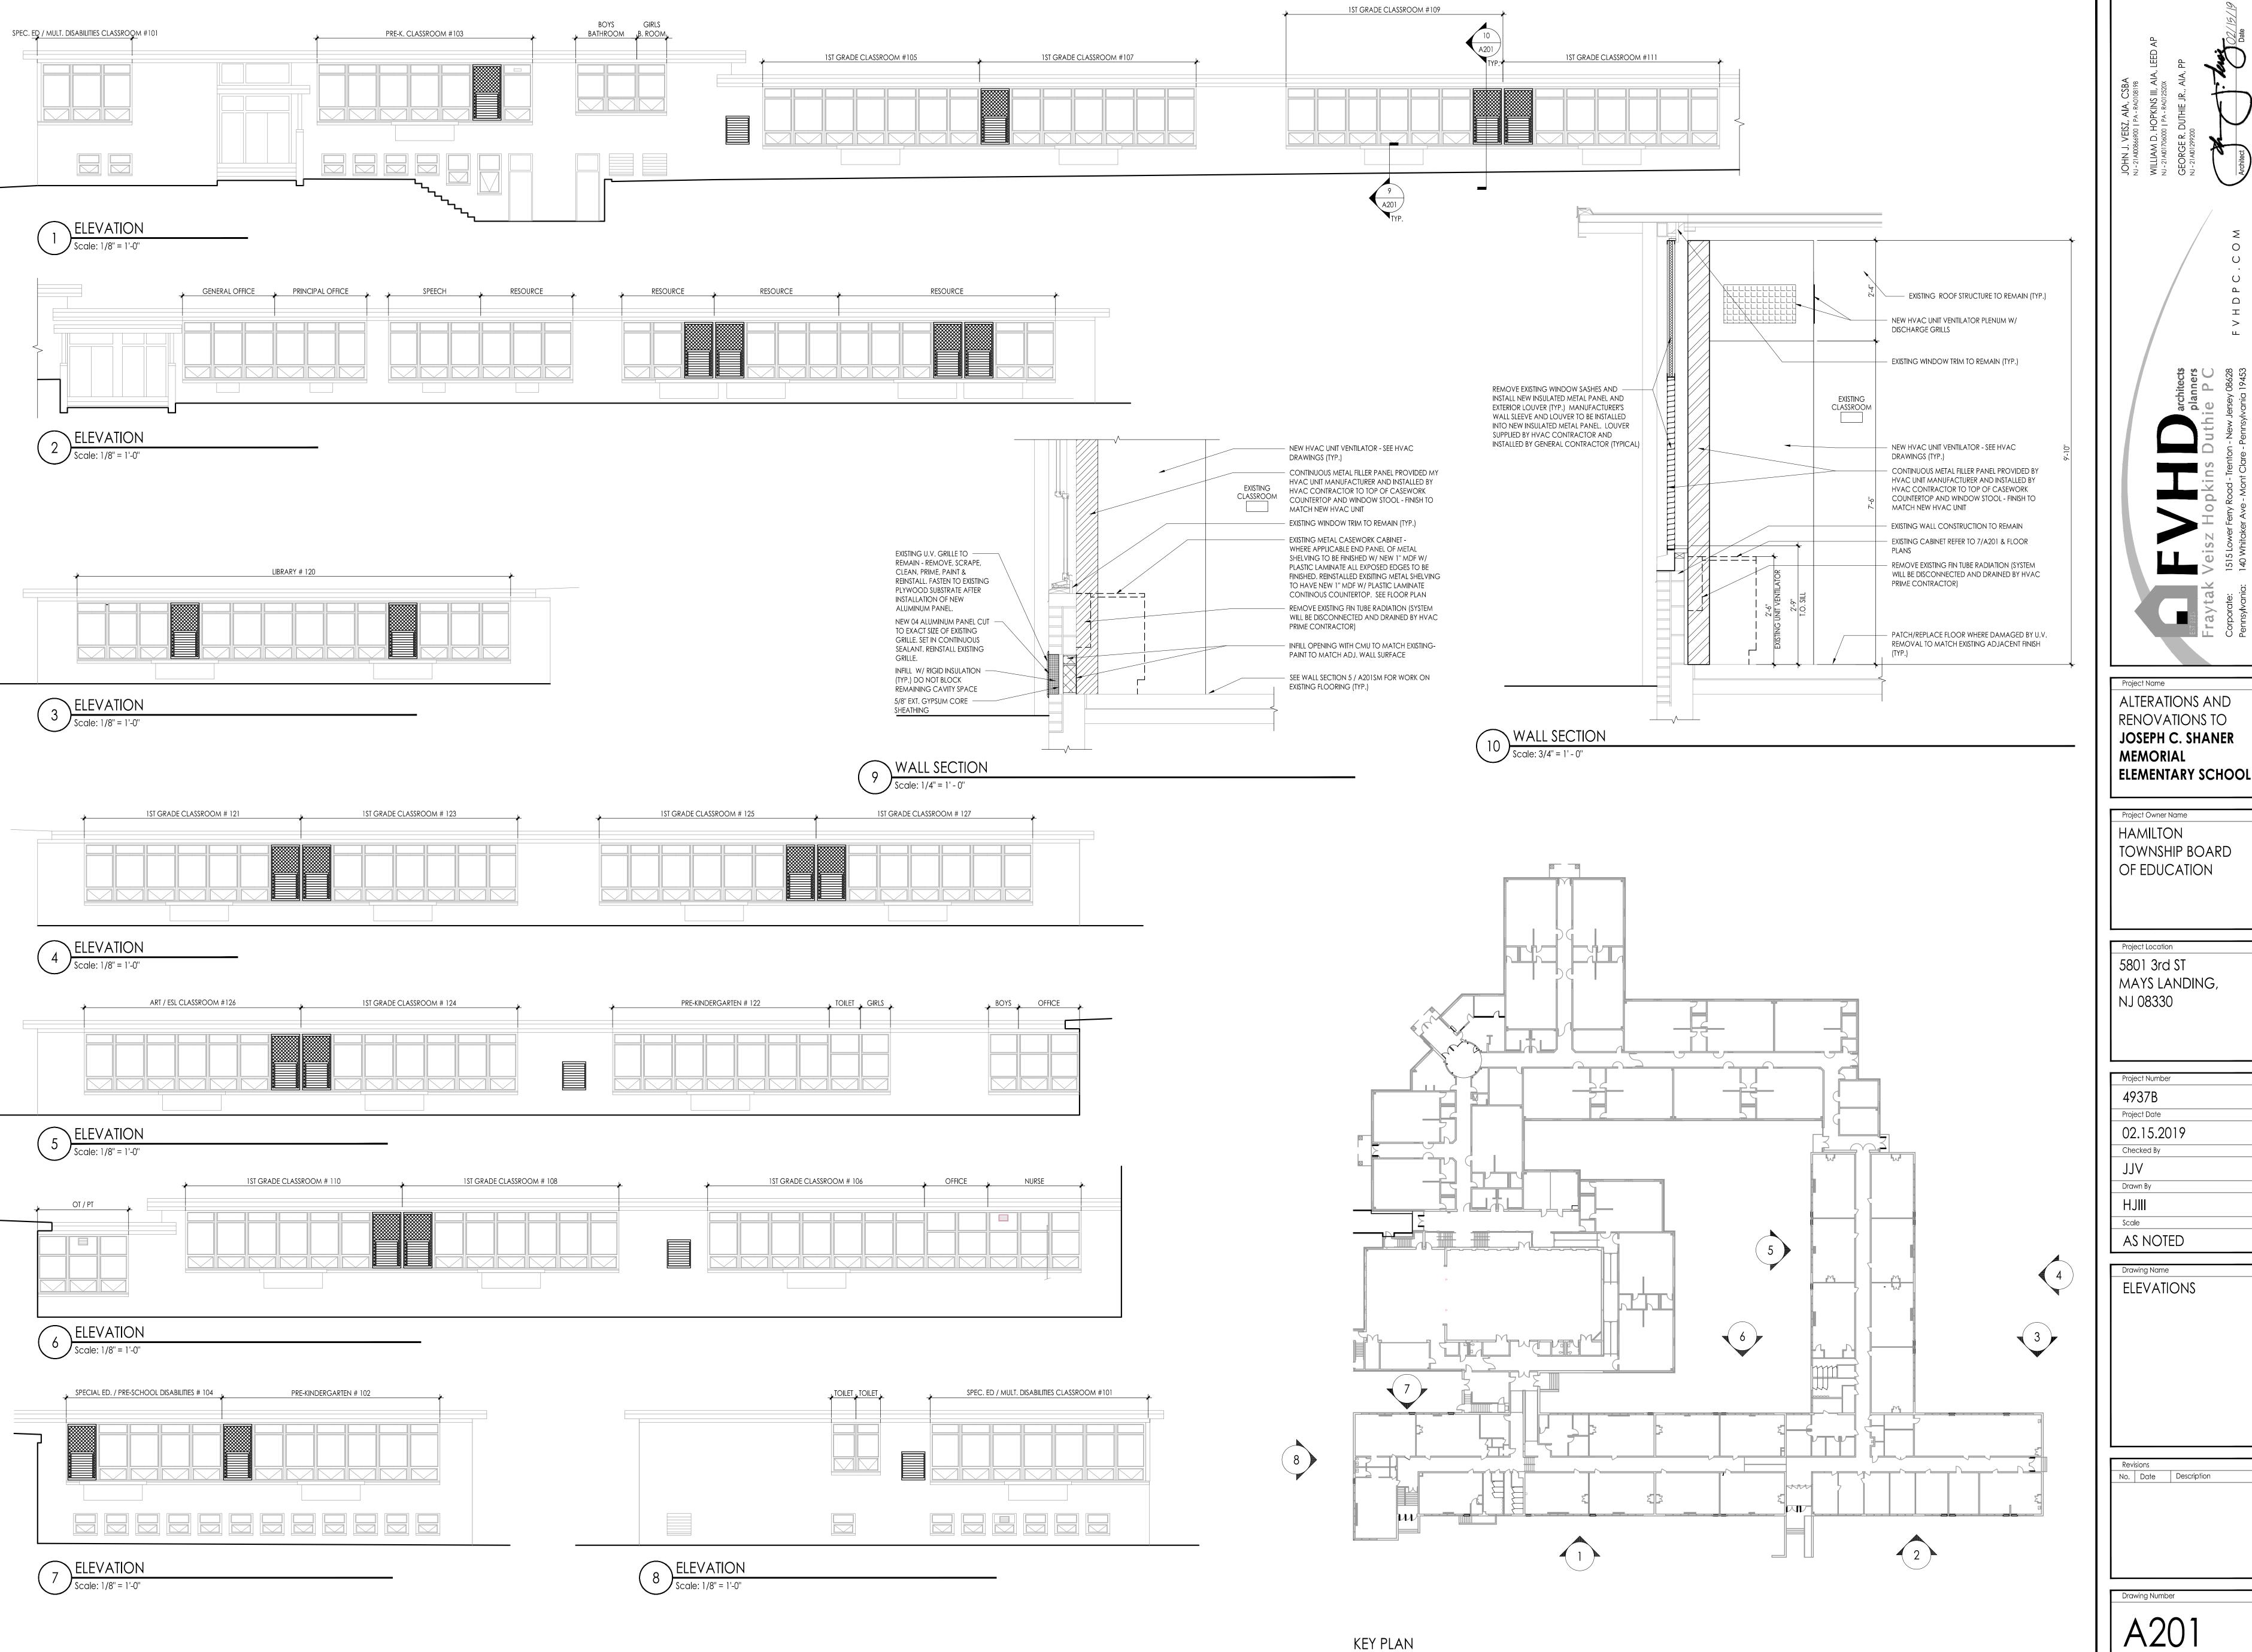

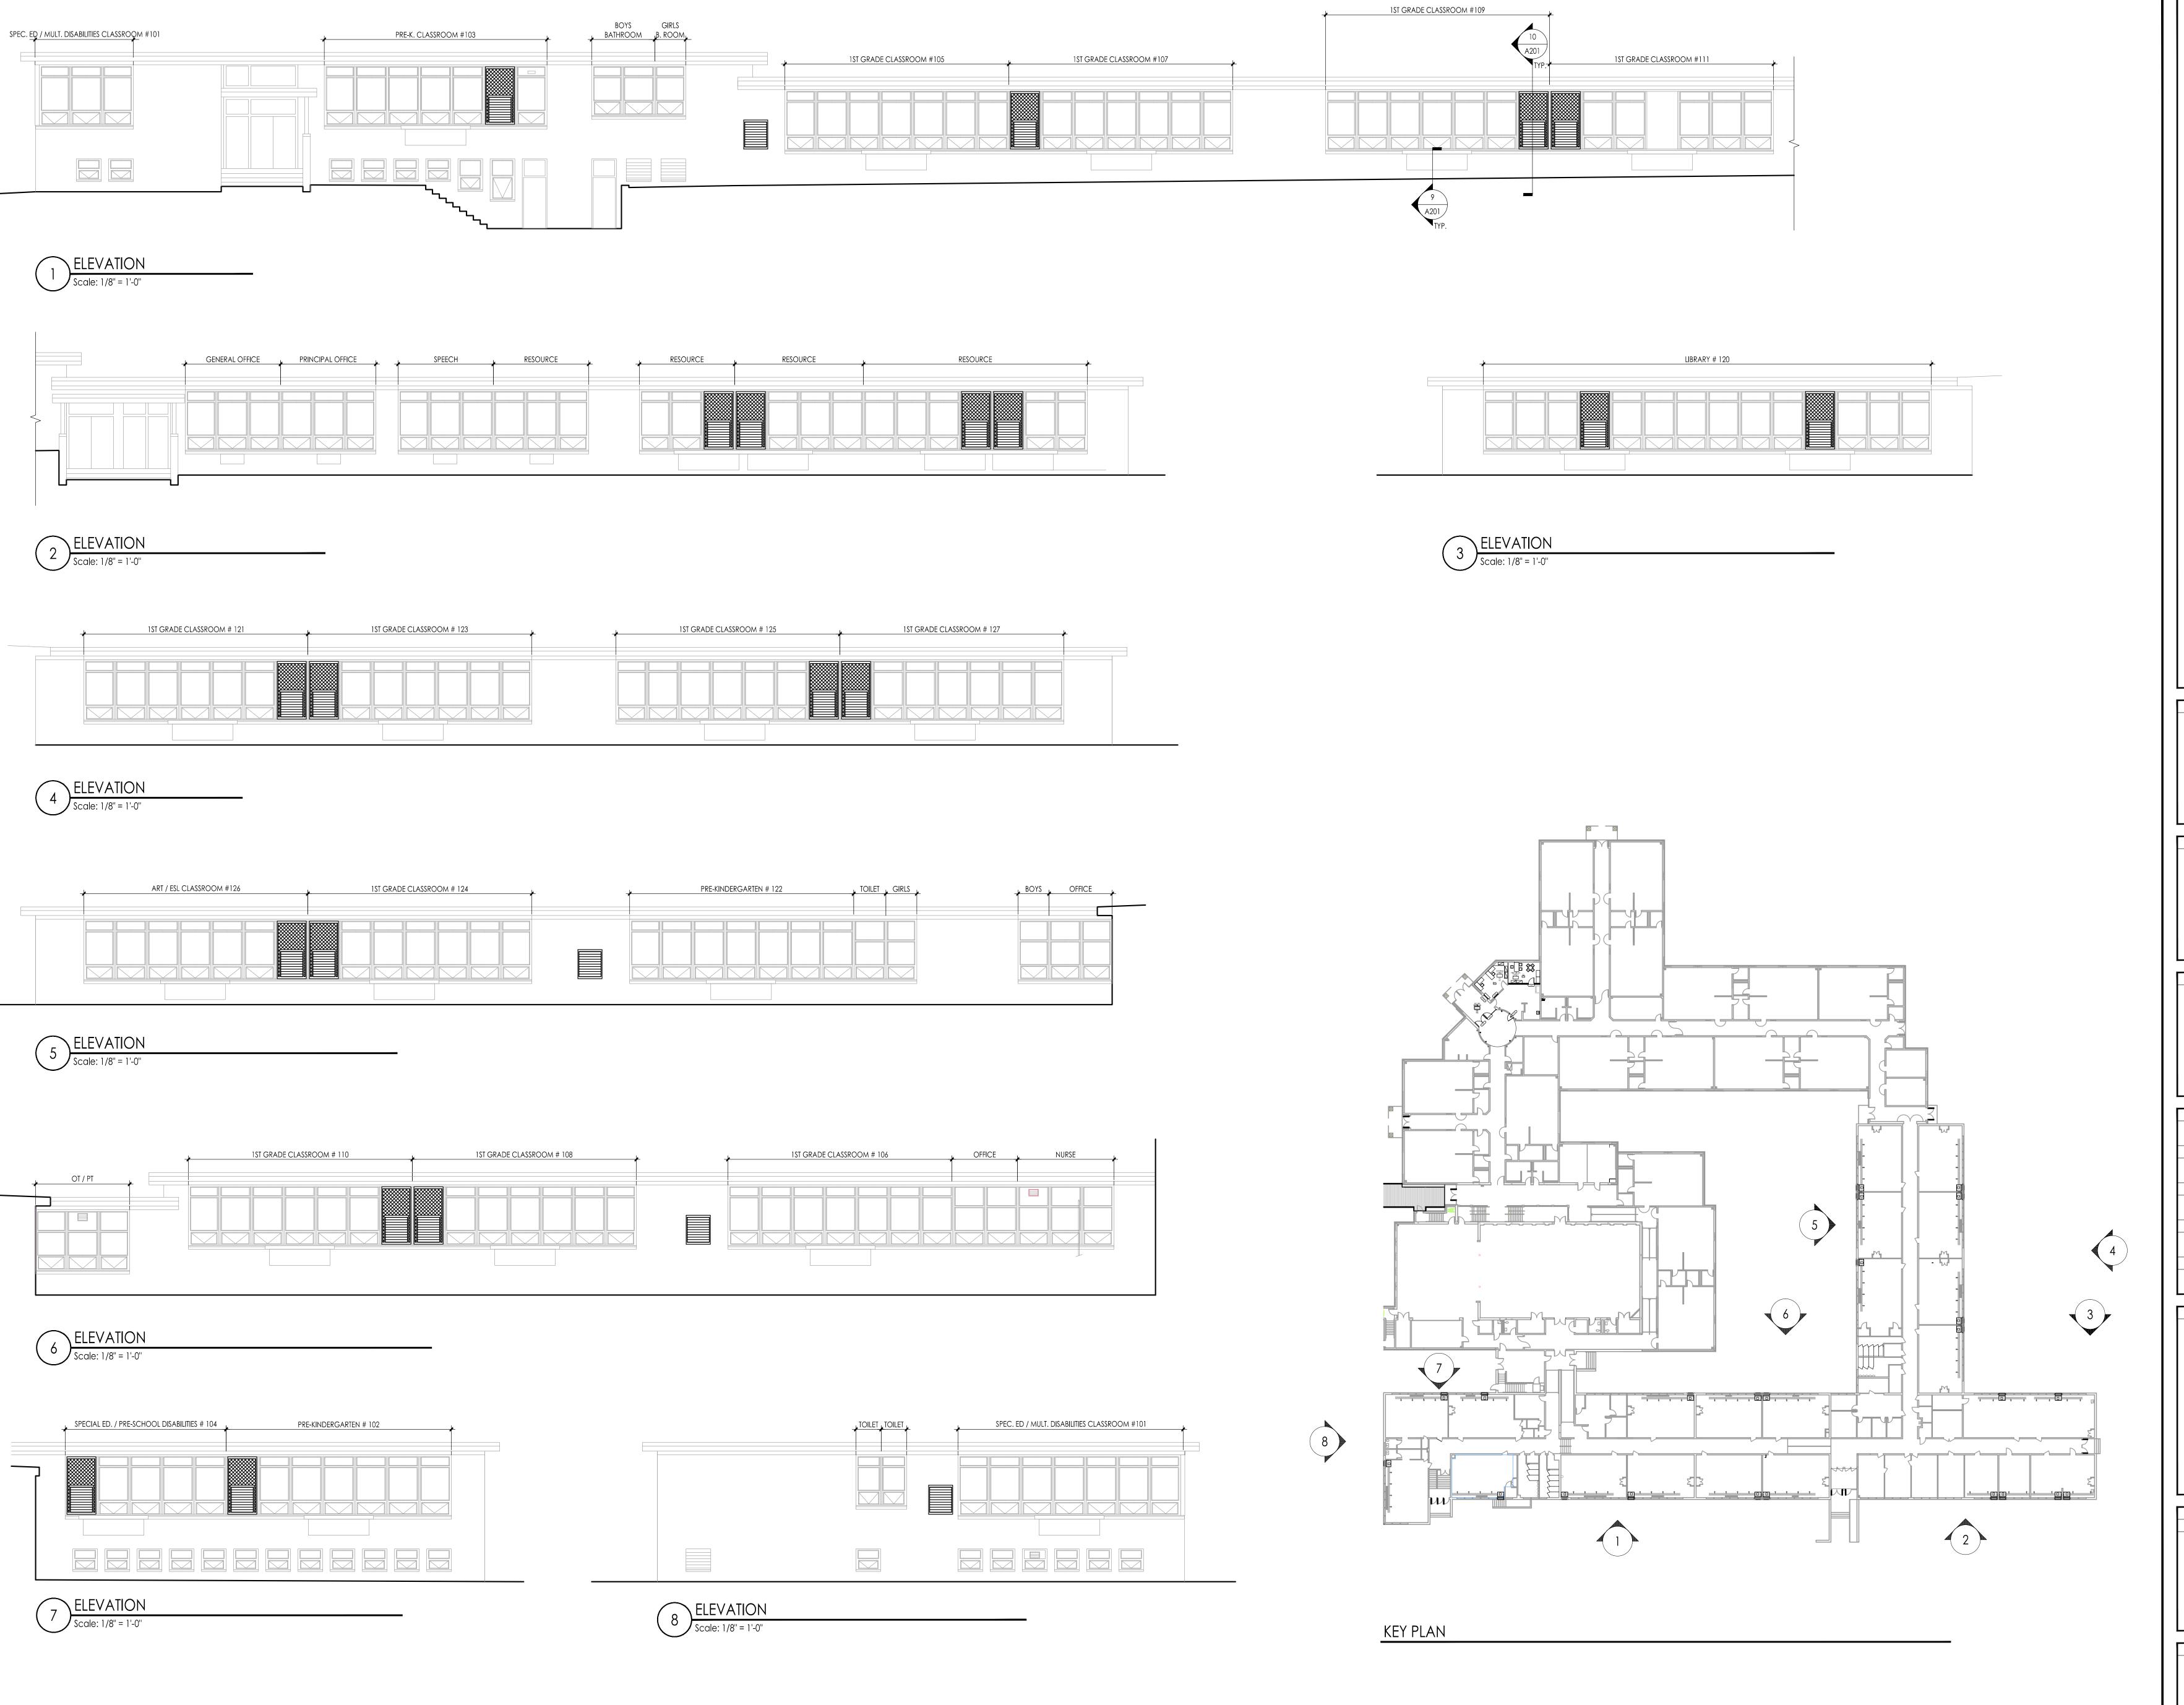

JOHN J. VEISZ, AIA, CSBA
NJ-21AI00866900 I PA-RA0108198
WILLIAM D. HOPKINS III, AIA, LEED AP
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architects
planners
isz Hopkins Duthie P C
Lower Ferry Road - Trenton - New Jersey 08628
Whitaker Ave - Mont Clare - Pennsylvania 19453
F V H D P C . C

Project Name

ALTERATIONS AND
RENOVATIONS TO
JOSEPH C. SHANER
MEMORIAL
ELEMENTARY SCHOOL

Project Owner Name

HAMILTON

TOWNSHIP BOARD

OF EDUCATION

5801 3rd ST MAYS LANDING, NJ 08330

Project Number

4937B

Project Date

02.15.2019

Checked By

JJV

Drawn By

Scale
AS NOTED

ELEVATIONS ALTERNATE BID

Revisions
No. Date Description

A201a