
S	Sheet List Table
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	NOTES, ABBREVIATION, AND
A 000	SYMBOLS
A-002	TYPICAL MOUNTING HEIGHTS
AP101	PHASING PLAN
A-101	DEMOLITION PLAN
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A-501	SCHEDULES AND DETAILS
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DELAWARE RIVER AND BAY AUTHORITY CAPE MAY - LEWES FERRY

CONTRACT NO. CMLF-C19-06 R2
CAPE MAY DISPATCH CENTER REHAB
CAPE MAY TERMINAL - POLICE AND
ADMINISTRATION BUILDING
NEW JERSEY

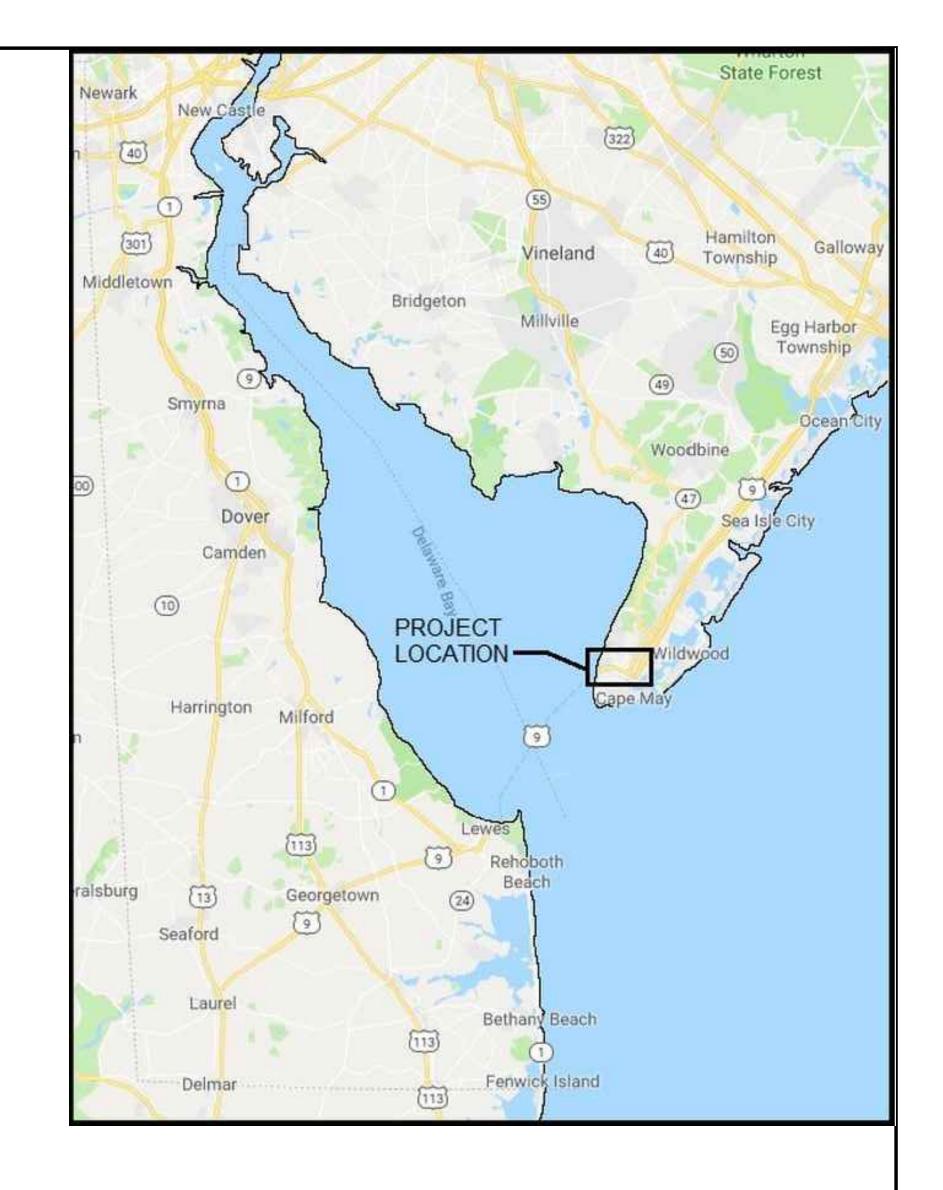








DRBA CAPE MAY-LEWES FERRY TERMINAL POLICE AND ADMINISTRATION BUILDING



				REVISION		
	CHECT		BY	DESCRIPTION	DATE	NO.
	'ER SHEET					
G-000						
SHEET NO. 1	SCALE: AS NOTED	DATE: MAY 2022				
JILLI NO.	SOALL. AS NOTED	DAIL, WAI 2022				

ABBREVIATIONS	SYMBOLS LEGEND	BUILDING INFORMATION	UTIONS IdioJAED.com P.O. BOX 254 AND 216285
8. AND L ANGLE FO.S. FACE OF MASONIPY L ANGLE FO.S. FACE OF STUDS	SYMBOLS LEGEND STRUCTURAL GRID LINE WALL SECTION (3) SHEET WHERE DRAWN (4.1) BUILDING SECTION (A) SHEET WHERE DRAWN (4.1) DETAIL IDENTIFICATION (3) SHEET WHERE DRAWN (4.1) A DETAIL IDENTIFICATION (A) SHEET WHERE DRAWN (4.1) WALL TYPE TAG WINDOW IDENTIFICATION TAG KEY NOTE TAG. SEE KEY NOTE INSTRUCTIONS / NARRATIVE FOR MORE INFORMATION REI) DOOR IDENTIFICATION TAG FINFLOOR O'CO' CREI DOOR IDENTIFICATION TAG ELEVATION LEVEL MARKER	1. APPLICABLE CODES AND STANDARDS INTERNATIONAL BUILDING CODE 2018, NEW JERSEY ADDITION INTERNATIONAL MECHANICAL CODE 2018 INTERNATIONAL STANDARD PLUMBING CODE INATIONAL STANDARD PLUMBING CODE NATIONAL STANDARD PLUMBING CODE PROJECT: POLICE DISPATCH REMOVALHORS NIP PLUMBING CONTRACT ON CONCENSIONS, CO	THAT IN OR SET 110 SEEA, DELAWARE OFFICE 2500 WRANGLE HILL ROAD, STE. 110 PROVIDENCE OFFICE 2713 FRONT STREET, STE. 403 PROVIDENCE OFFICE 272 FRONT STREET, P. D. BOX 254 PROVIDENCE HILL ROAD, STE. 110 PROVIDENCE OFFICE 273 FRONT STREET, P. D. BOX 254 PROVIDENCE OFFICE 274 WRANGLAND 276286 PROVIDENCE OFFICE 275 FRONT STREET, P. D. BOX 254 PROVIDENCE HILL ROAD, STE. 110 PROVIDENCE OFFICE 276 FRONT STREET, P. D. BOX 254 PROVIDENCE HILL ROAD, STE. 110 PROVIDENCE OFFICE 277 FRONT STREET, P. D. BOX 254 PROVIDENCE OFFICE 277 FRONT STREET, P. D. BOX 254 PROVIDENCE OFFICE 278 FRONT STREET, P. D. BOX 254 PROVIDENCE OFFICE 279 FRONT STREET, P. D. BOX 254 PROVIDENCE OFFICE 270 FRONT STREET, P. D. BOX 254 PROVIDENCE OFFICE 270 FRONT STREET, P. D. BOX 254 PROVIDENCE OFFICE 271 FRONT STREET, P. D. BOX 254 PROVIDENCE OFFICE 271 FRONT STREET, P. D. BOX 254 PROVIDENCE OFFICE 272 FRONT STREET, P. D. BOX 254 PROVIDENCE OFFICE 273 FRONT STREET, P. D. BOX 254 PROVIDENCE OFFICE 274 FRONT STREET, P. D. BOX 254 PROVIDENCE OFFICE 275 FRONT STREET, P. D. BOX 254 PROVIDENCE OFFICE 275 FRONT STREET, P. D. BOX 254 PROVIDENCE OFFICE 276 FRONT STREET, P. D. BOX 254 PROVIDENCE OFFICE 277 FRONT STREET, P. D. BOX 254 PROVIDENCE OFFICE 276 FRONT STREET, P. D. BOX 254 PROVIDENCE OFFICE 277 FRONT STREET, P. D. BOX 254 PROVIDENCE OFFICE 277 FRONT STREET, P. D. BOX 254 PROVIDENCE OFFICE 277 FRONT STREET, P. D. BOX 254 PROVIDENCE OFFICE 277 FRONT STREET, P. D. BOX 254 PROVIDENCE OFFICE 277 FRONT STREET, P. D. BOX 254 PROVIDENCE OFFICE 278 FRONT STREET, P. D. BOX 254 PROVIDENCE OFFICE 278 FRONT STREET, P. D. BOX 254 PROVIDENCE OFFICE 278 FRONT STREET, P. D. BOX 254 PROVIDENCE OFFICE 278 FRONT STREET, P. D.
Control	DENOTES PLAN DETAIL (DETAIL #VISHEET AJ.7) DENOTES 2 HOUR FIRE RATING EXISTING WALL TO REMAIN NEW WALL CONSTRUCTION (SEE WALL TYPE FOR CONSTRUCTION MATUS) WALL DEMOLITION REVISION ROOM ROOM ROOM ROOM NUMBER 102 ROOM NUMBER 4PPROX. FLOOR AREA	Security of the security of the control of the cont	ARCHITECT / ENGINEER SEAL BETWEEN AND BAY AUTHORITY BETWEEN AUTHORIT

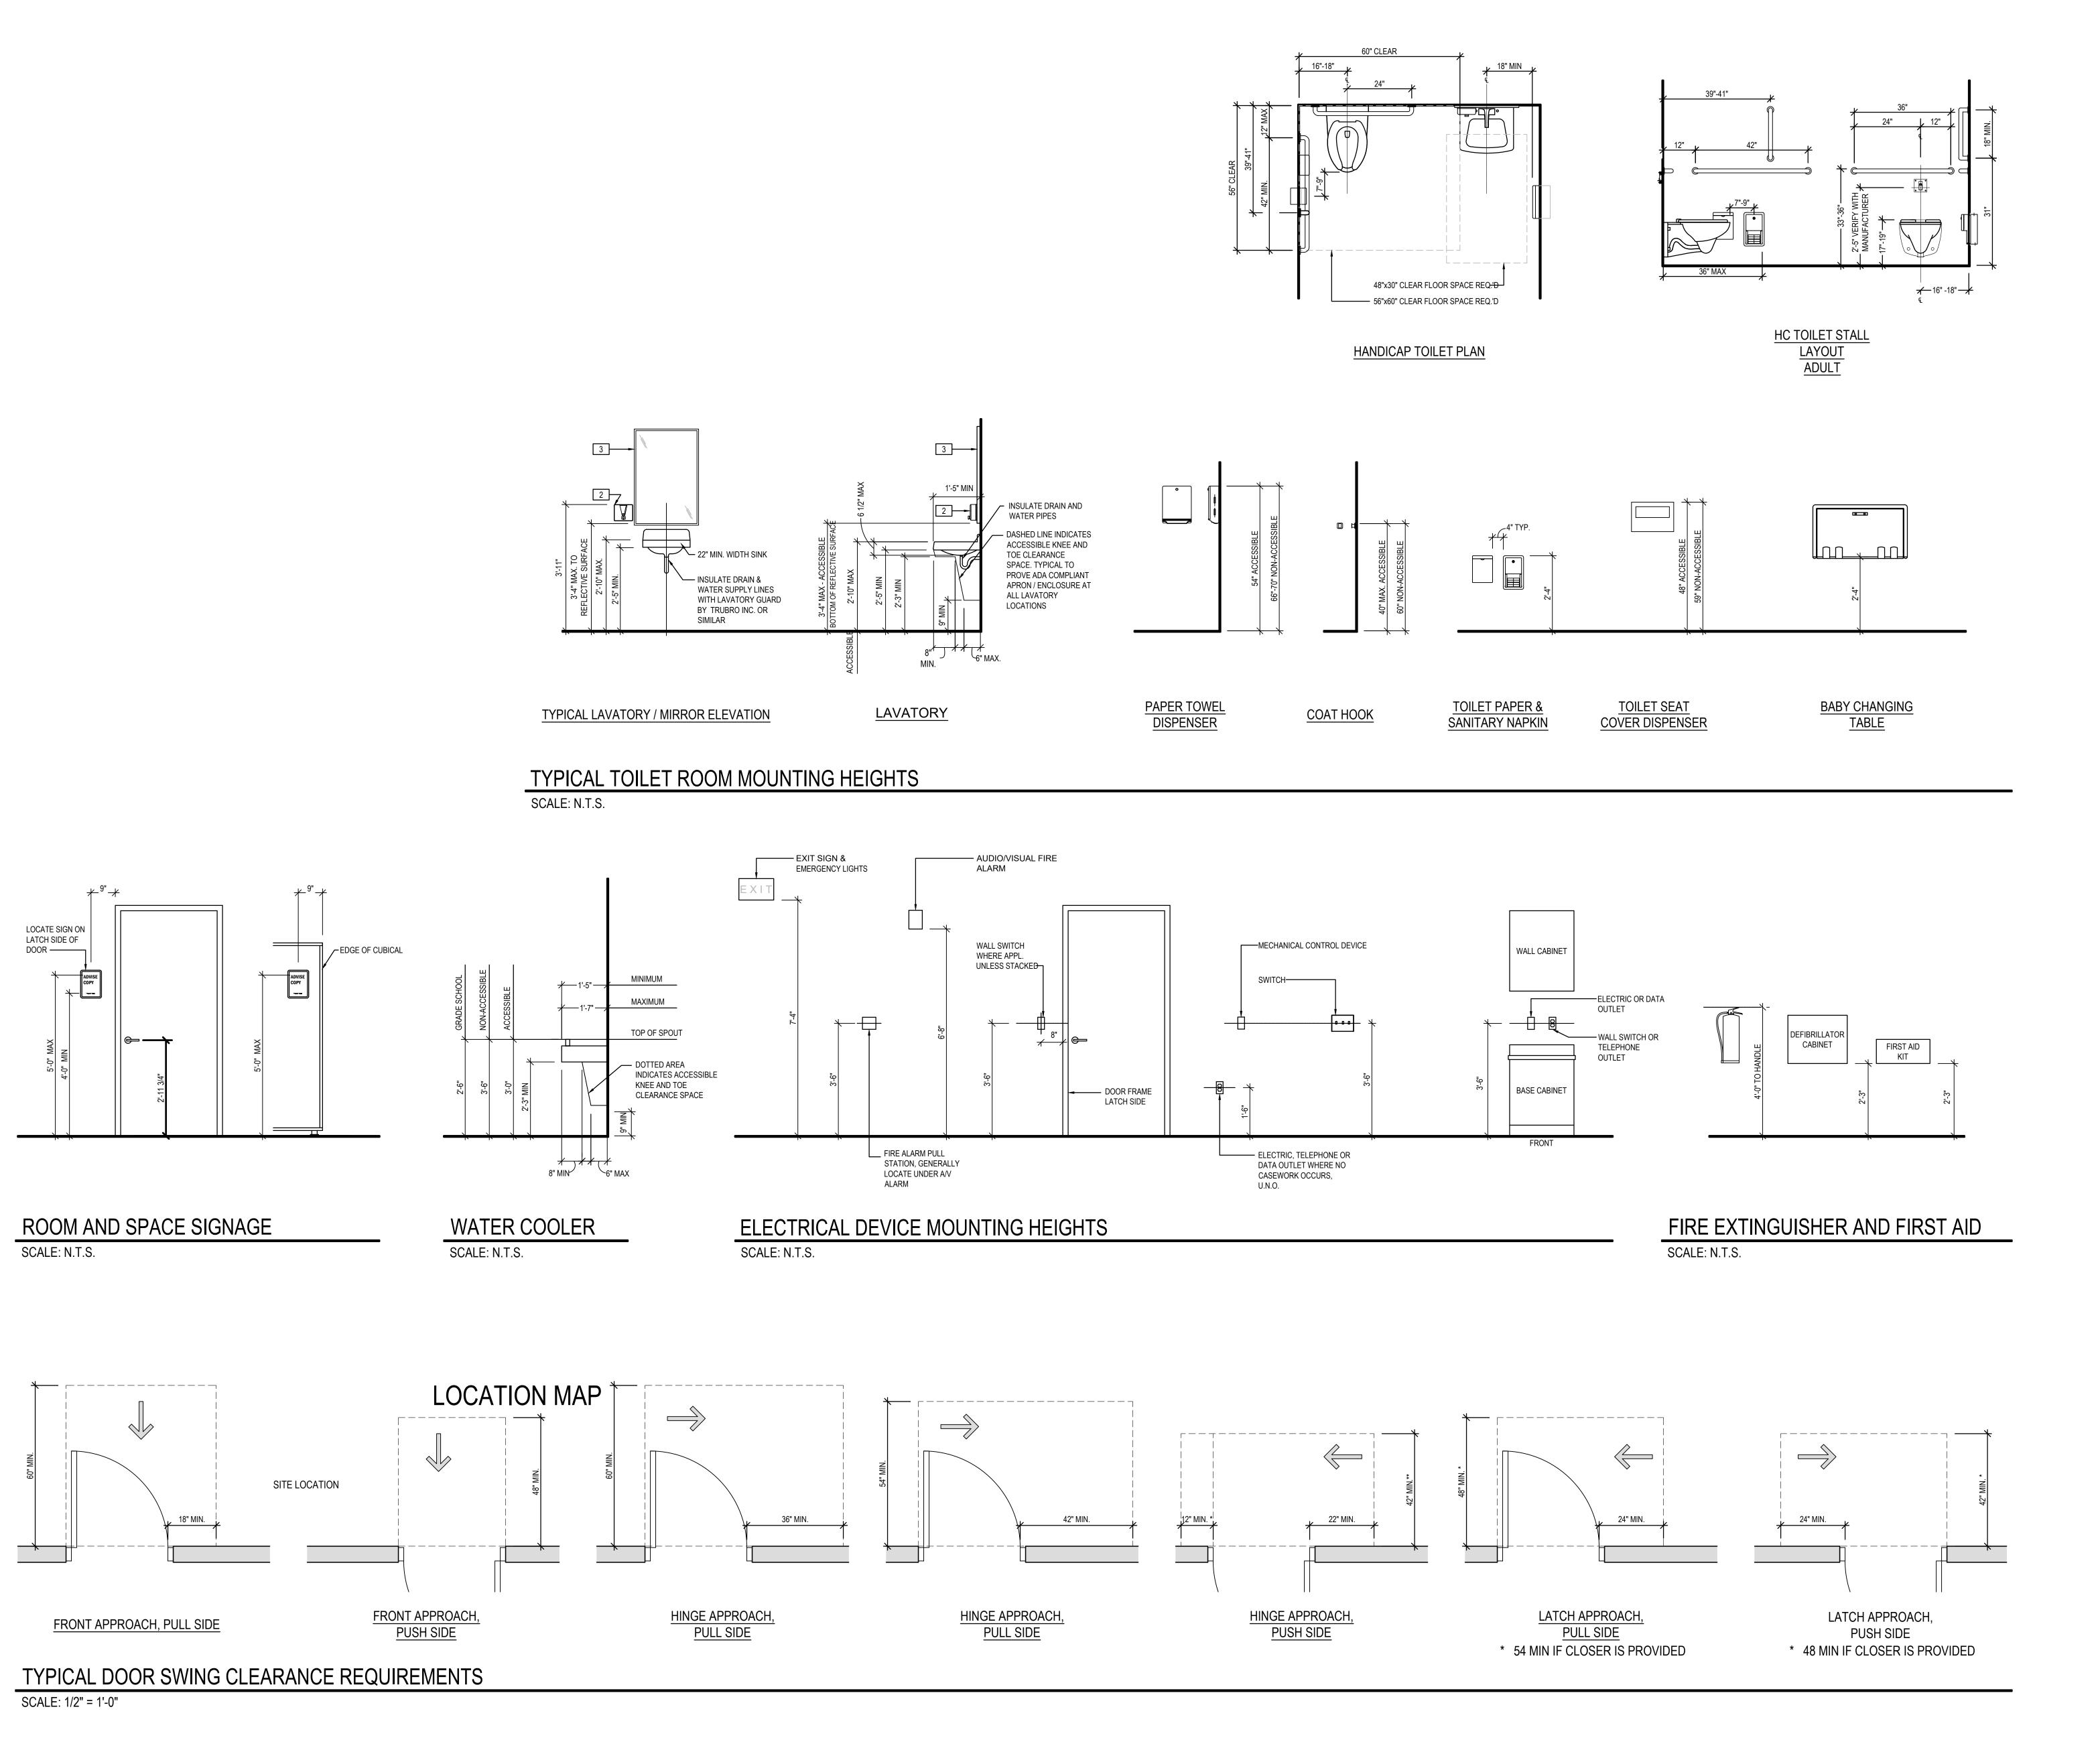

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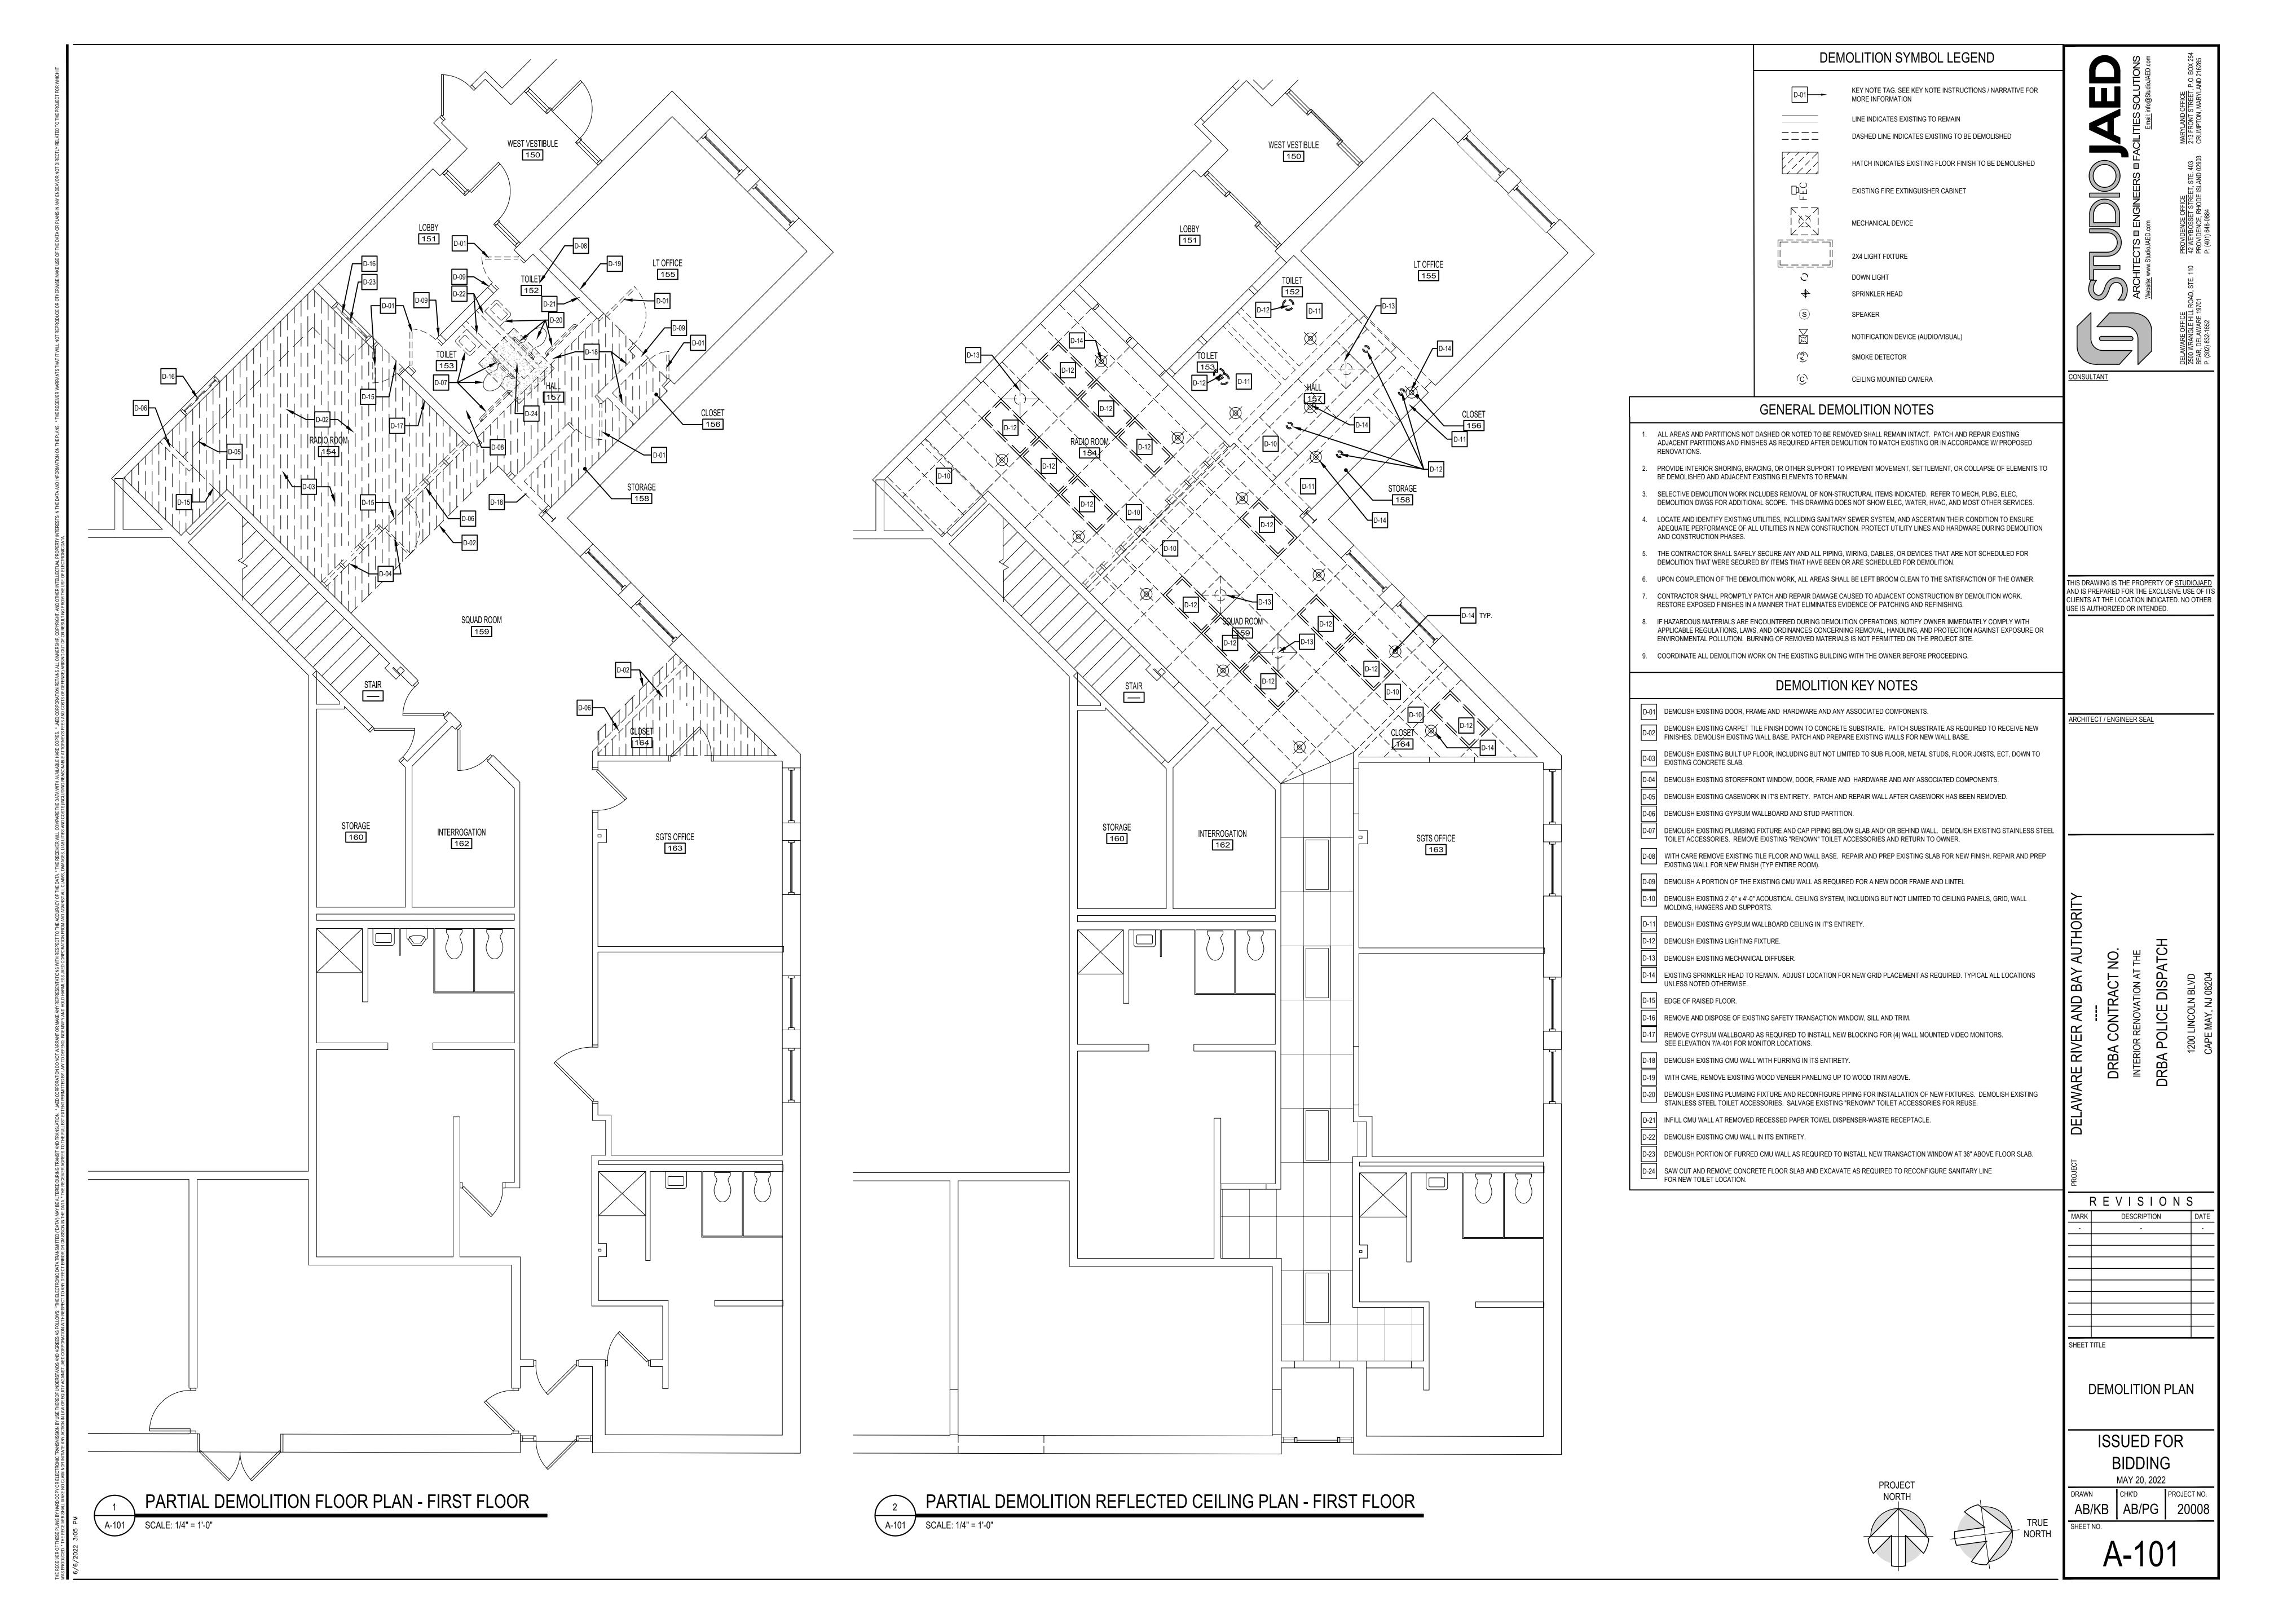
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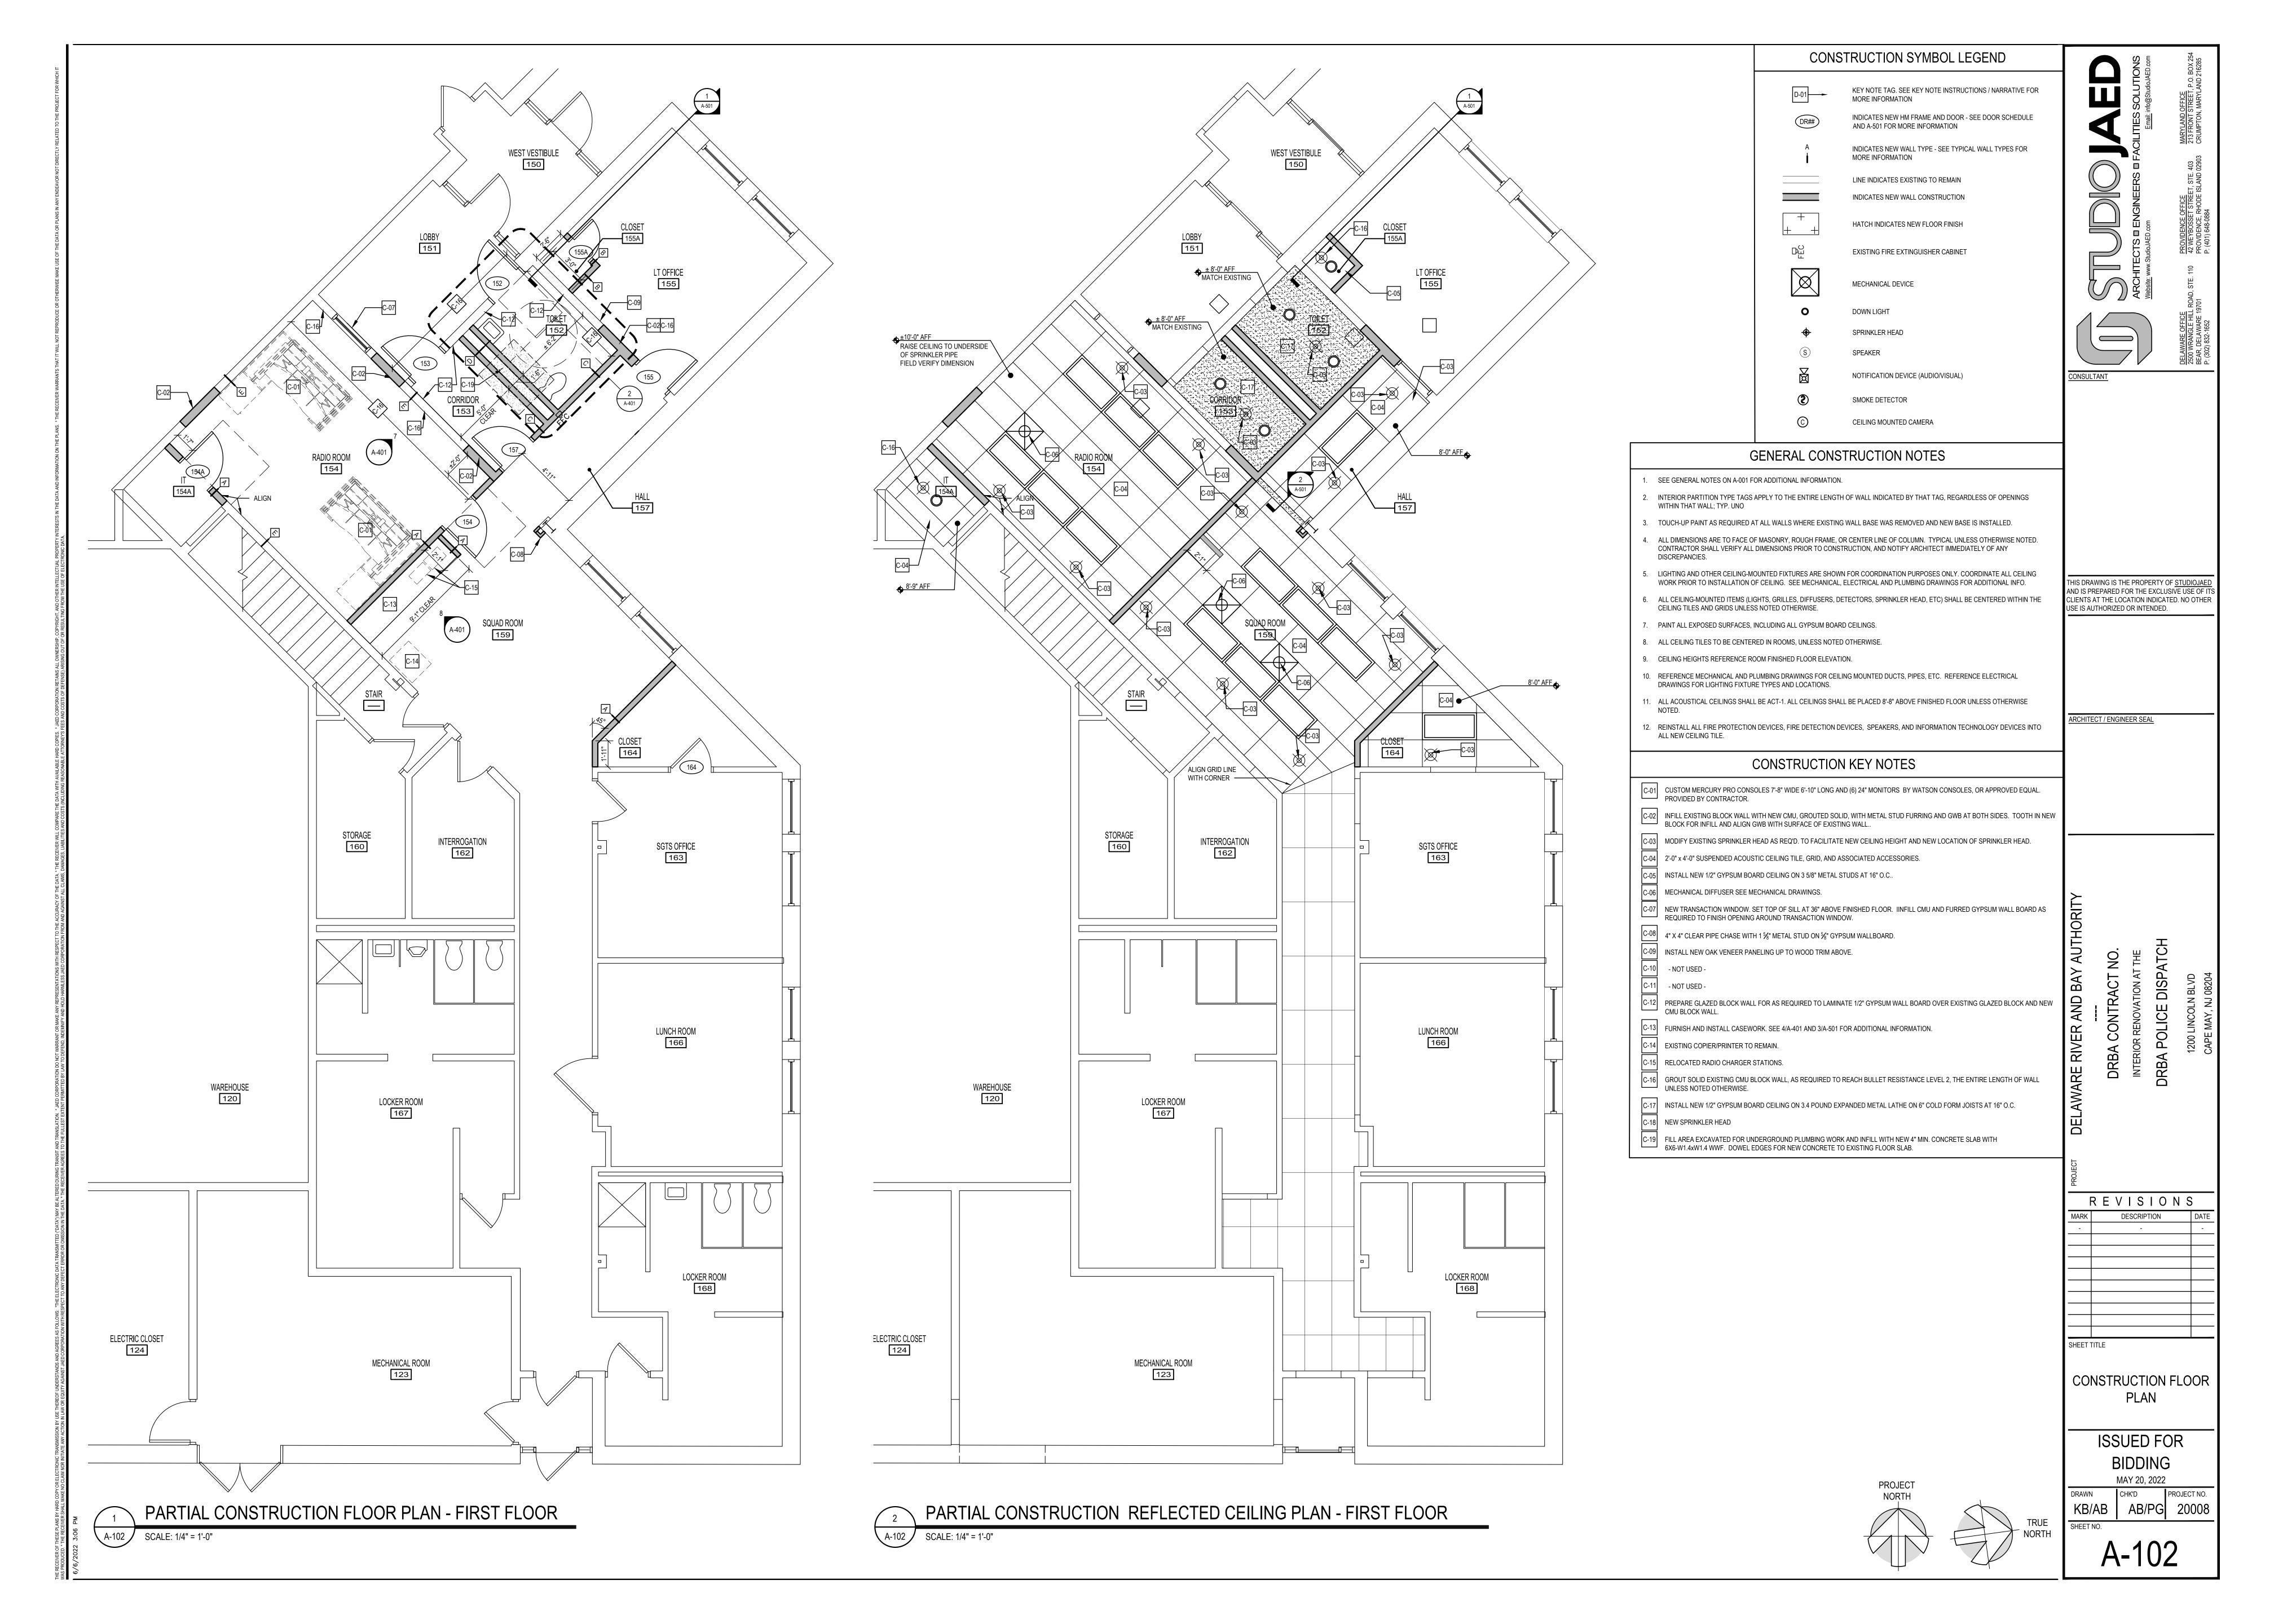
ISSUED FOR **BIDDING** MAY 20, 2022


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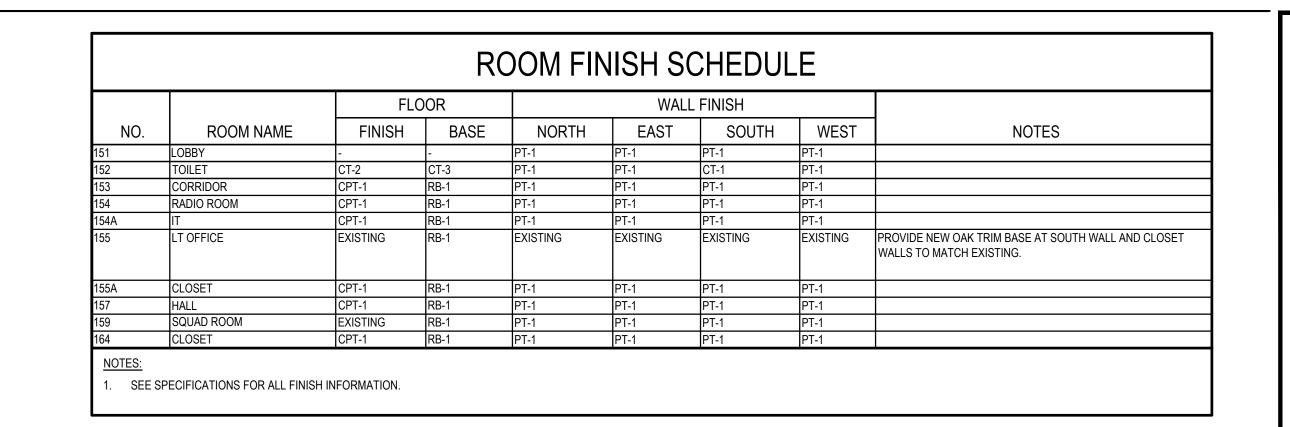
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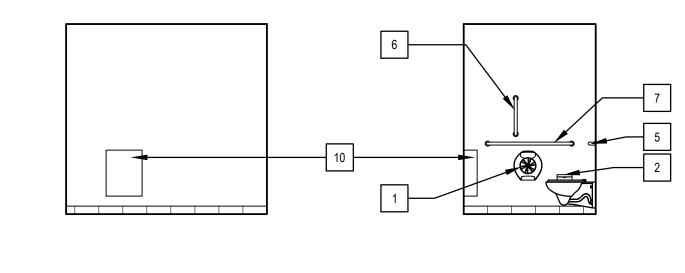












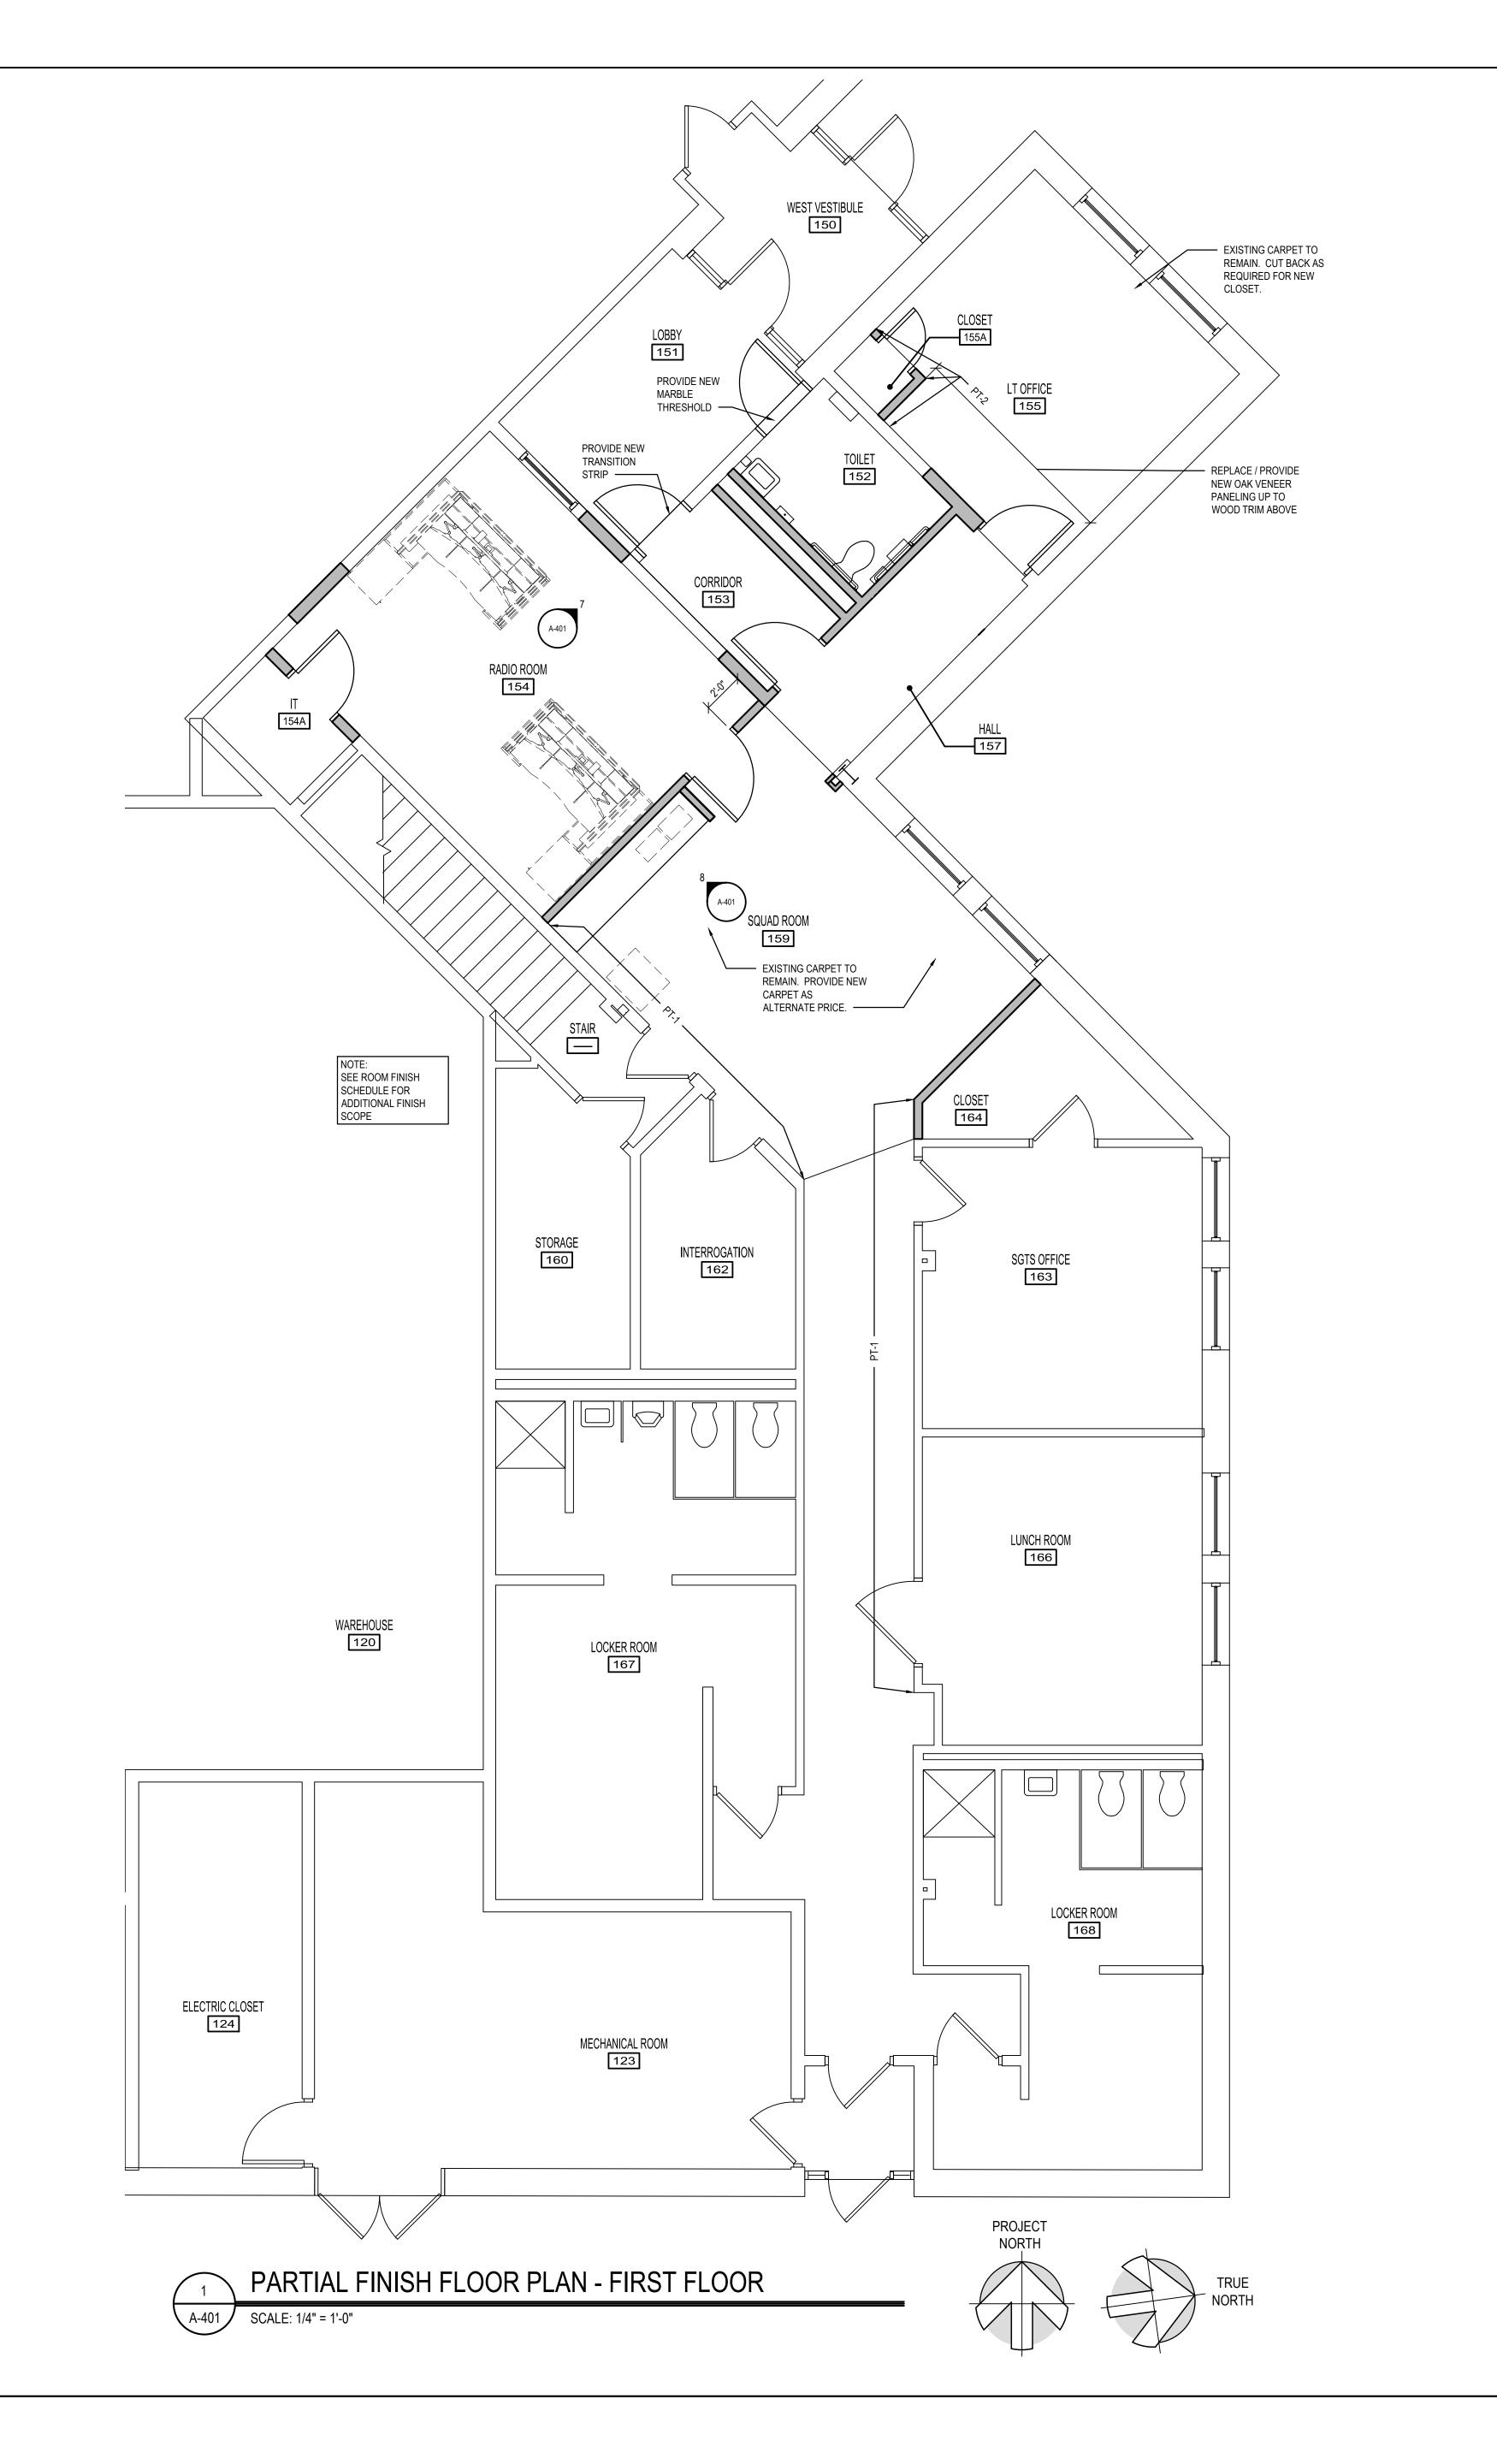

3 **ELEVATION**A-401 SCALE: 1/4" = 1'-0"

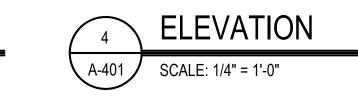

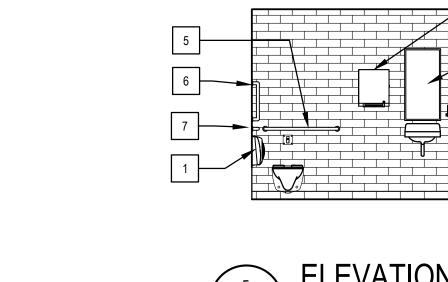

ENLARGED TOILET ROOM KEY

TOILET PAPER DISPENSER

SANITARY NAPKIN DISPOSAL

3 COAT HOOK

4 18x 36 MIRROR

5 36" GRAB BAR

7 42" GRAB BAR

8 SOAP DISPENSER

6 18" VERTICAL GRAB BAR

PAPER TOWEL DISPENSER

A-401 SCALE: 1/2" = 1'-0"

10 SURFACE MOUNTED WASTE RECEPTACLE

REINSTALL SALVAGED DISPENSER

BRADLEY 4722-15

BRADLEY 780

BRADLEY 812x36

BRADLEY 812x18


BRADLEY 812x42


TOILET ROOM - ENLARGED PLAN


REINSTALL SALVAGED DISPENSER


REINSTALL SALVAGED DISPENSER

5 **ELEVATION**A-401 SCALE: 1/4" = 1'-0"

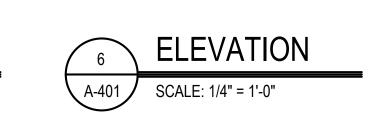

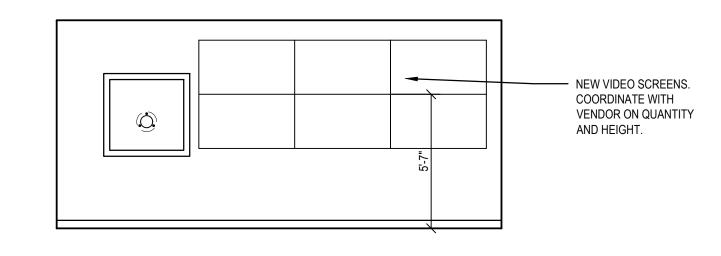

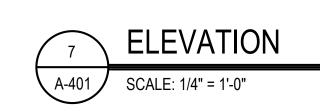

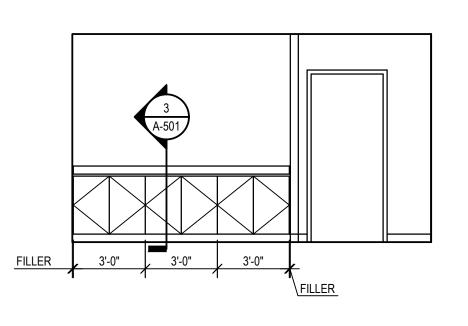

8 **ELEVATION**A-401 SCALE: 1/4" = 1'-0"

ARCHITECTS = ENGINEERS = FACILITIES SOLUTIONS
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ORBA CONTRACT NO.

NTERIOR RENOVATION AT THE

RBA POLICE DISPATCH

DRF INTE

REVISIONS


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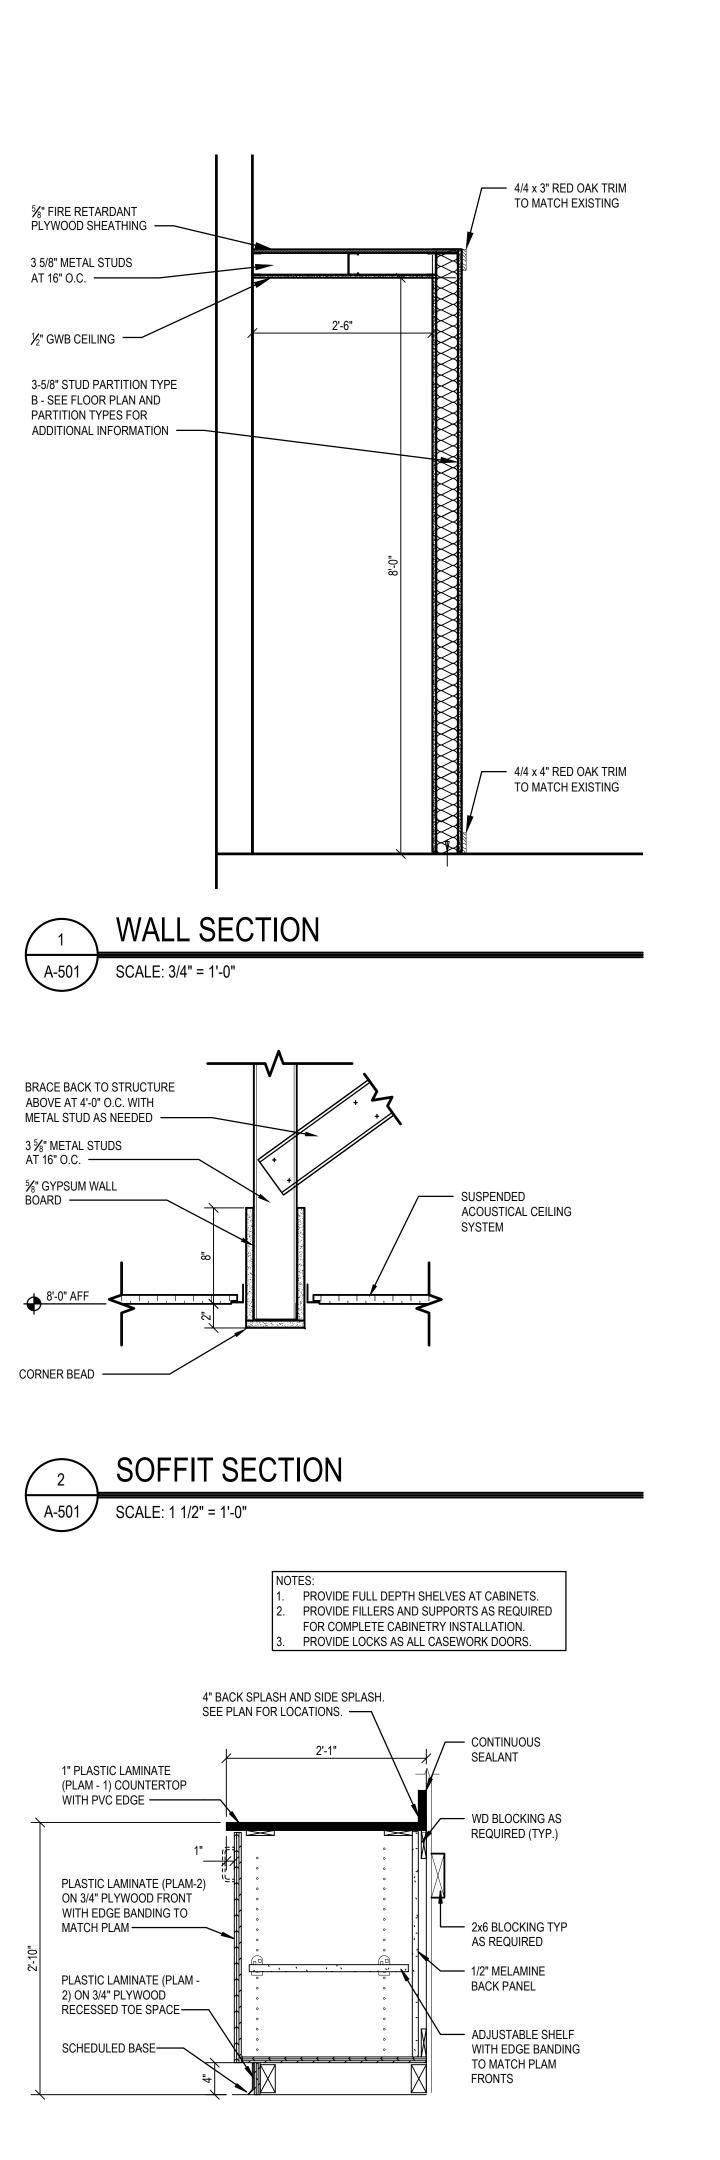
- - -
SHEET TITLE

FINISH PLAN, ENLARGED PLANS AND ELEVATIONS

ISSUED FOR BIDDING MAY 20, 2022

A-401



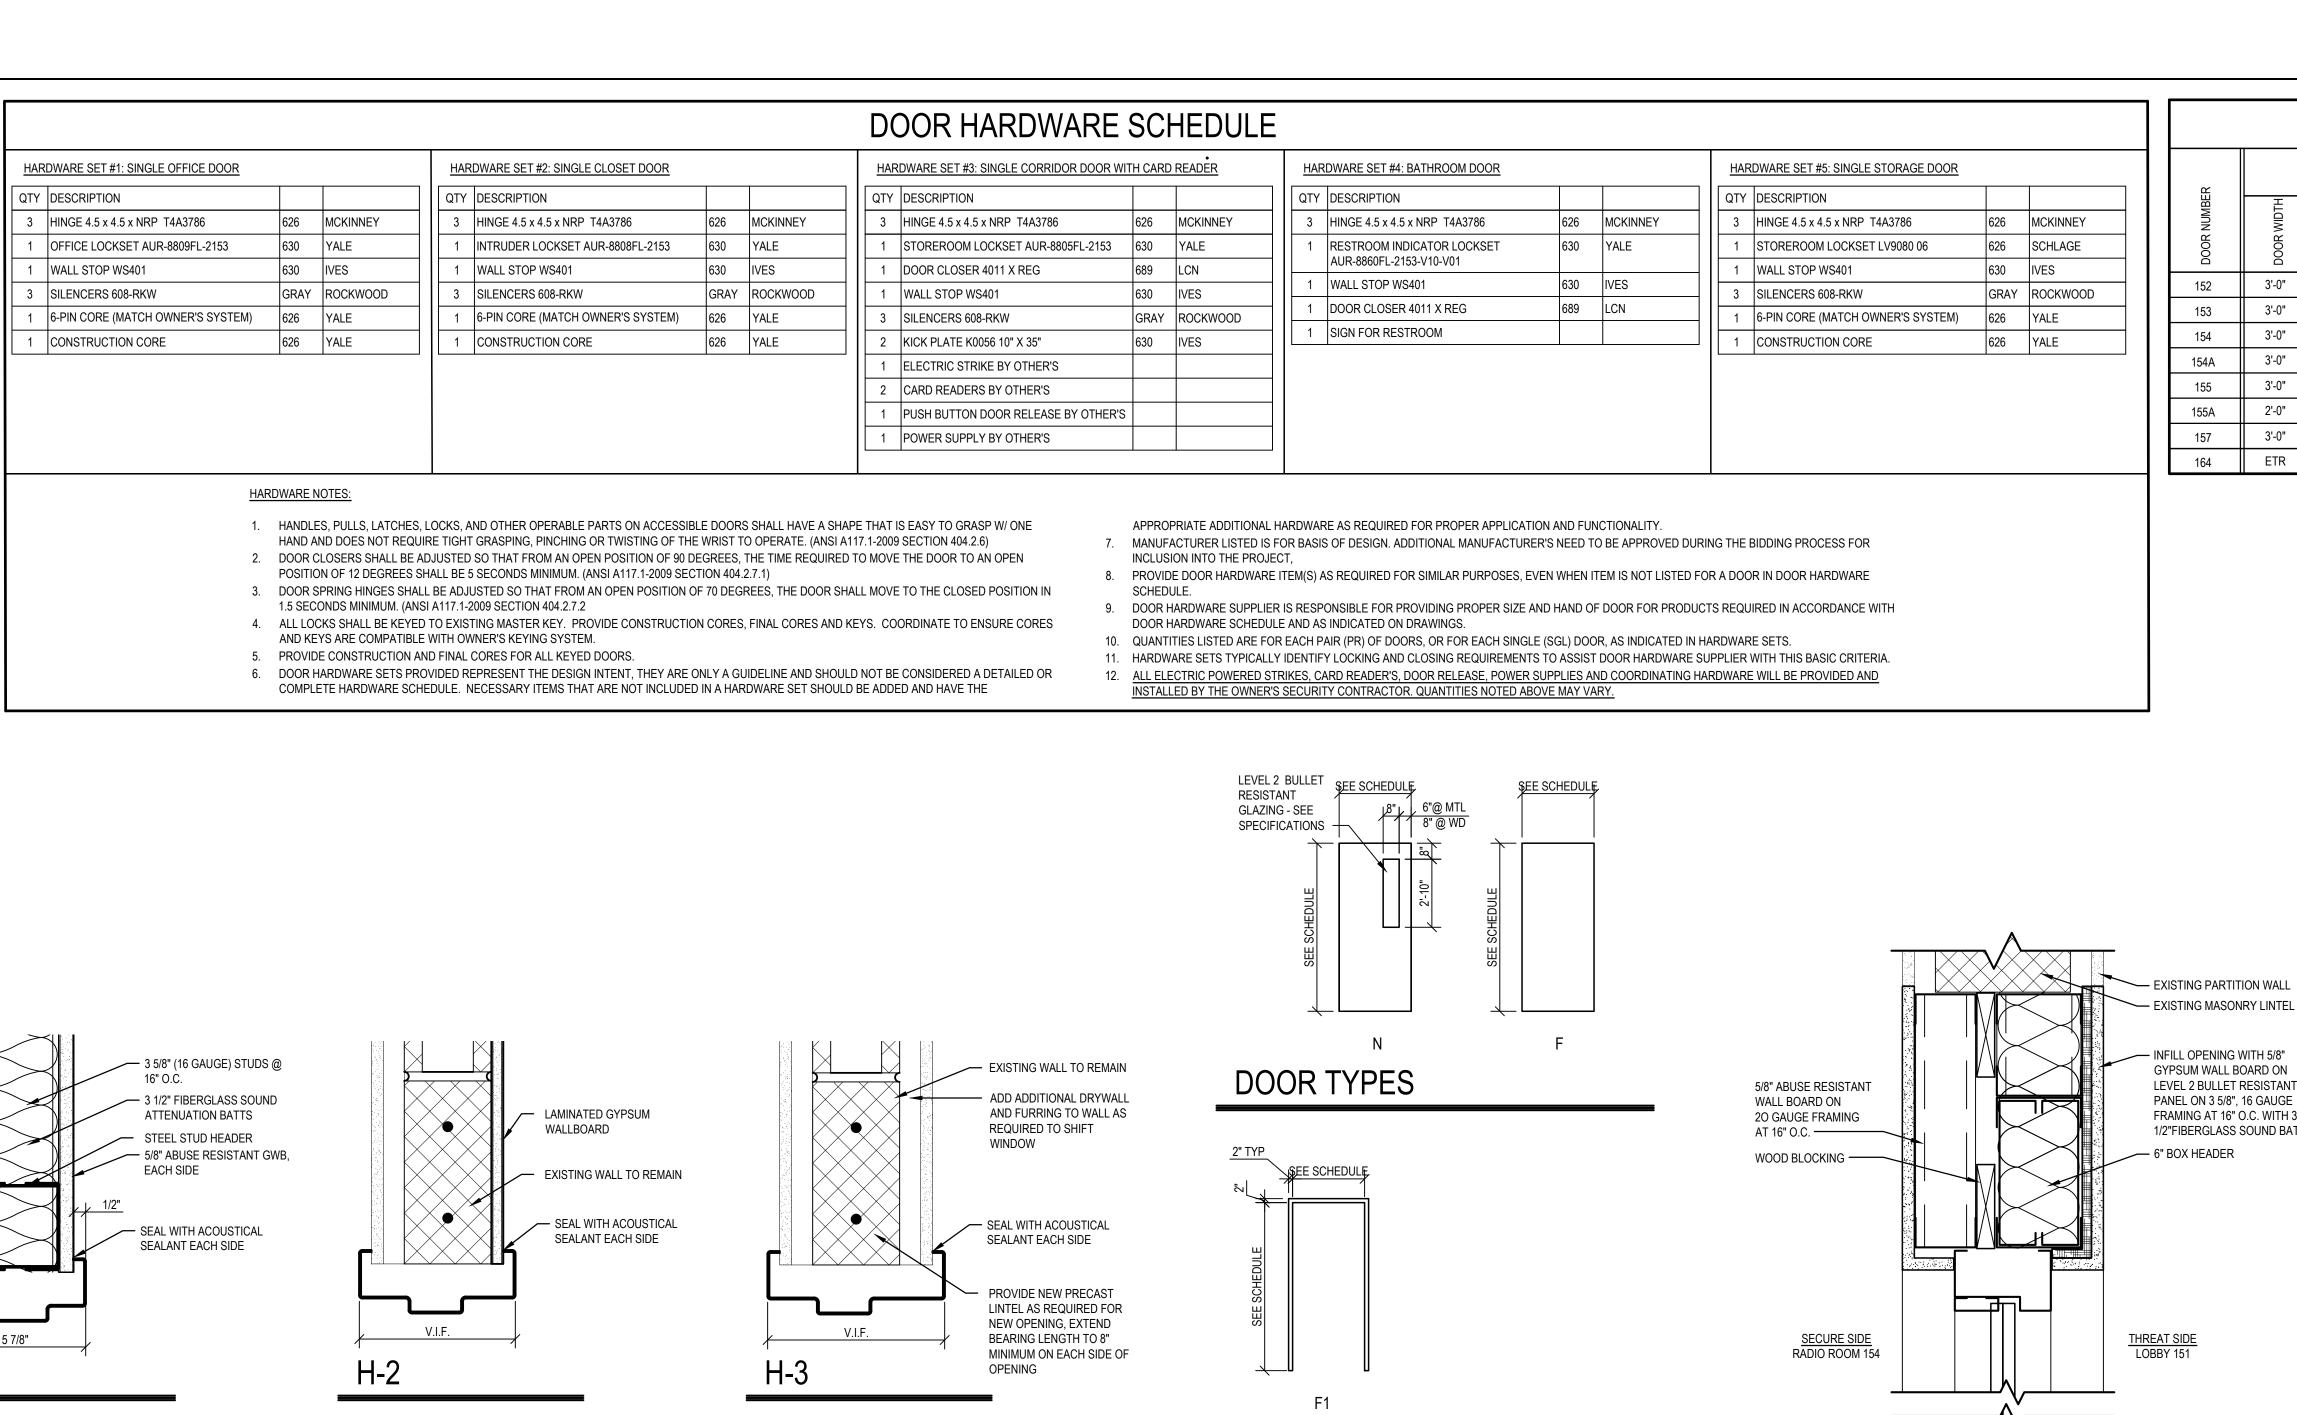

CASEWORK SECTION

A-501 / SCALE: 1" = 1'-0"

DOOR SCHEDULE

TYPE

ETR

MATERIAL FINISH

HM PAINTED

HM PAINTED

HM PAINTED

HM PAINTED

HM PAINTED

HM

ETR

PAINTED

ETR

DETAILS

H-2

H-1

H-1

H-3

H-1 J-1 2

ETR ETR ETR

DESCRIPTION

TYPE MATERIAL FINISH

WD

WD

WD

WD

WD

ETR

WD

3'-0"

3'-0"

2'-0"

3'-0"

ETR

154A

- INFILL OPENING WITH 5/8"

GYPSUM WALL BOARD ON

LEVEL 2 BULLET RESISTANT

PANEL ON 3 5/8", 16 GAUGE

FRAMING AT 16" O.C. WITH 3

1/2"FIBERGLASS SOUND BATTS

7'-0"

7'-0"

7'-0"

ETR

1 3/4"

1 3/4"

ETR

STAINED

STAINED

STAINED


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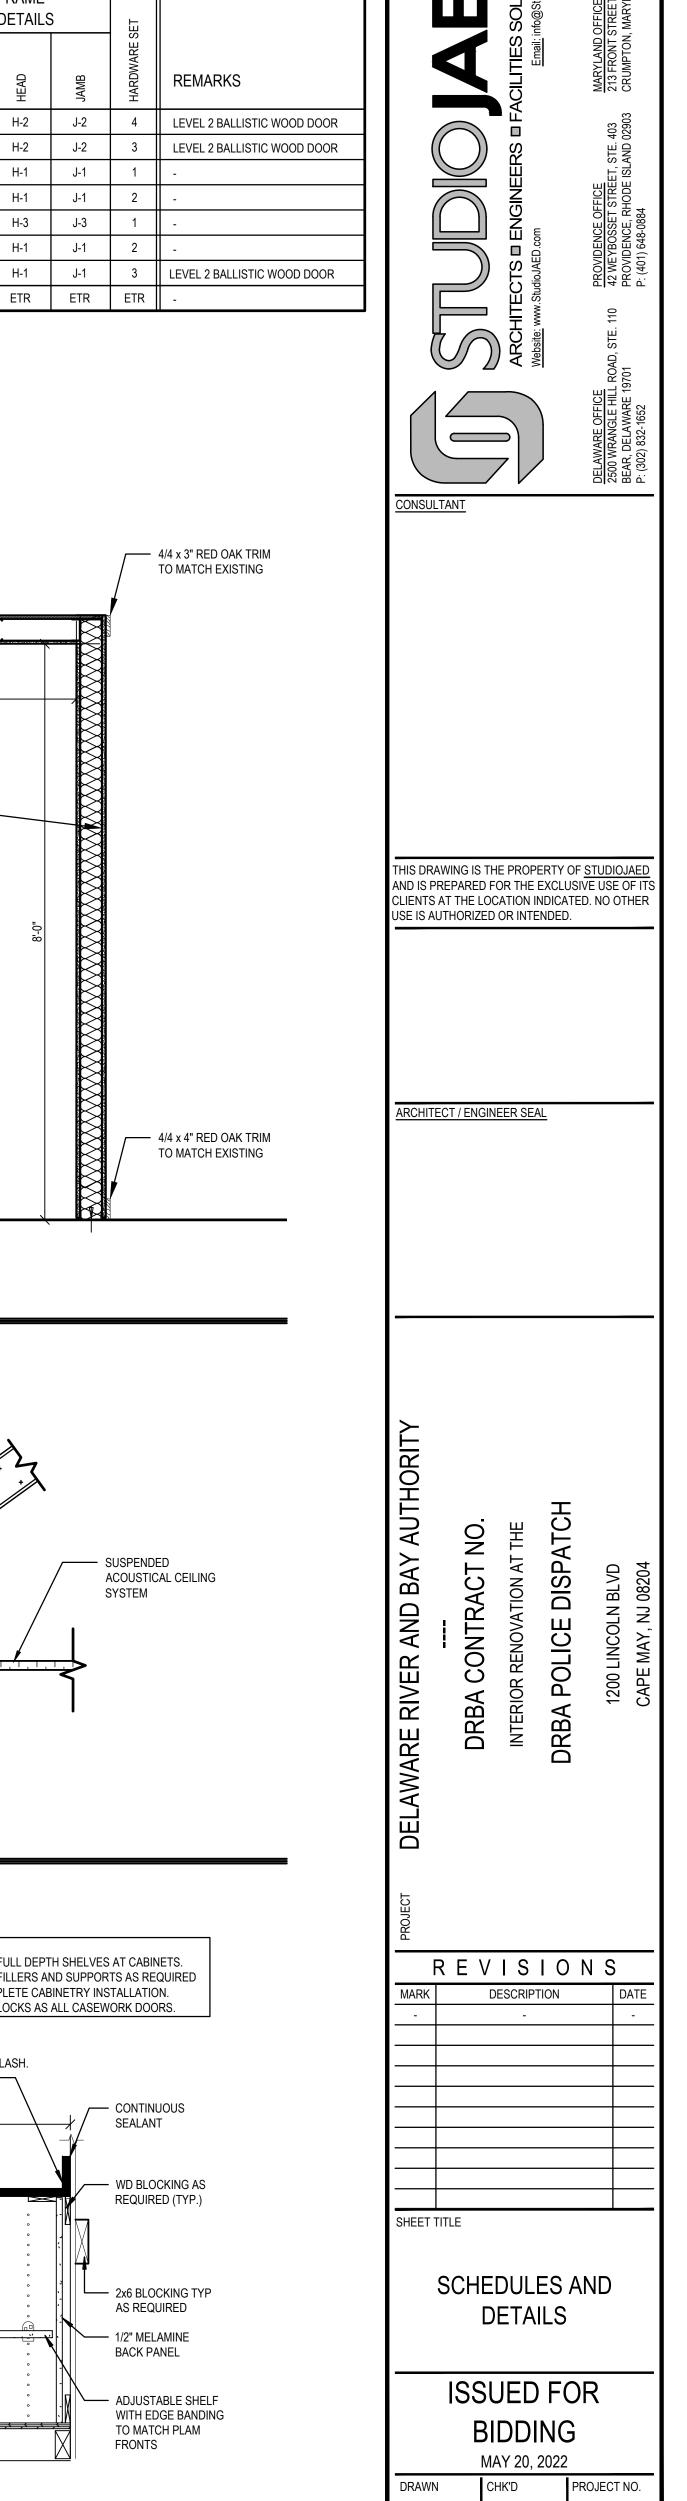
STAINED

STAINED

STAINED

ETR



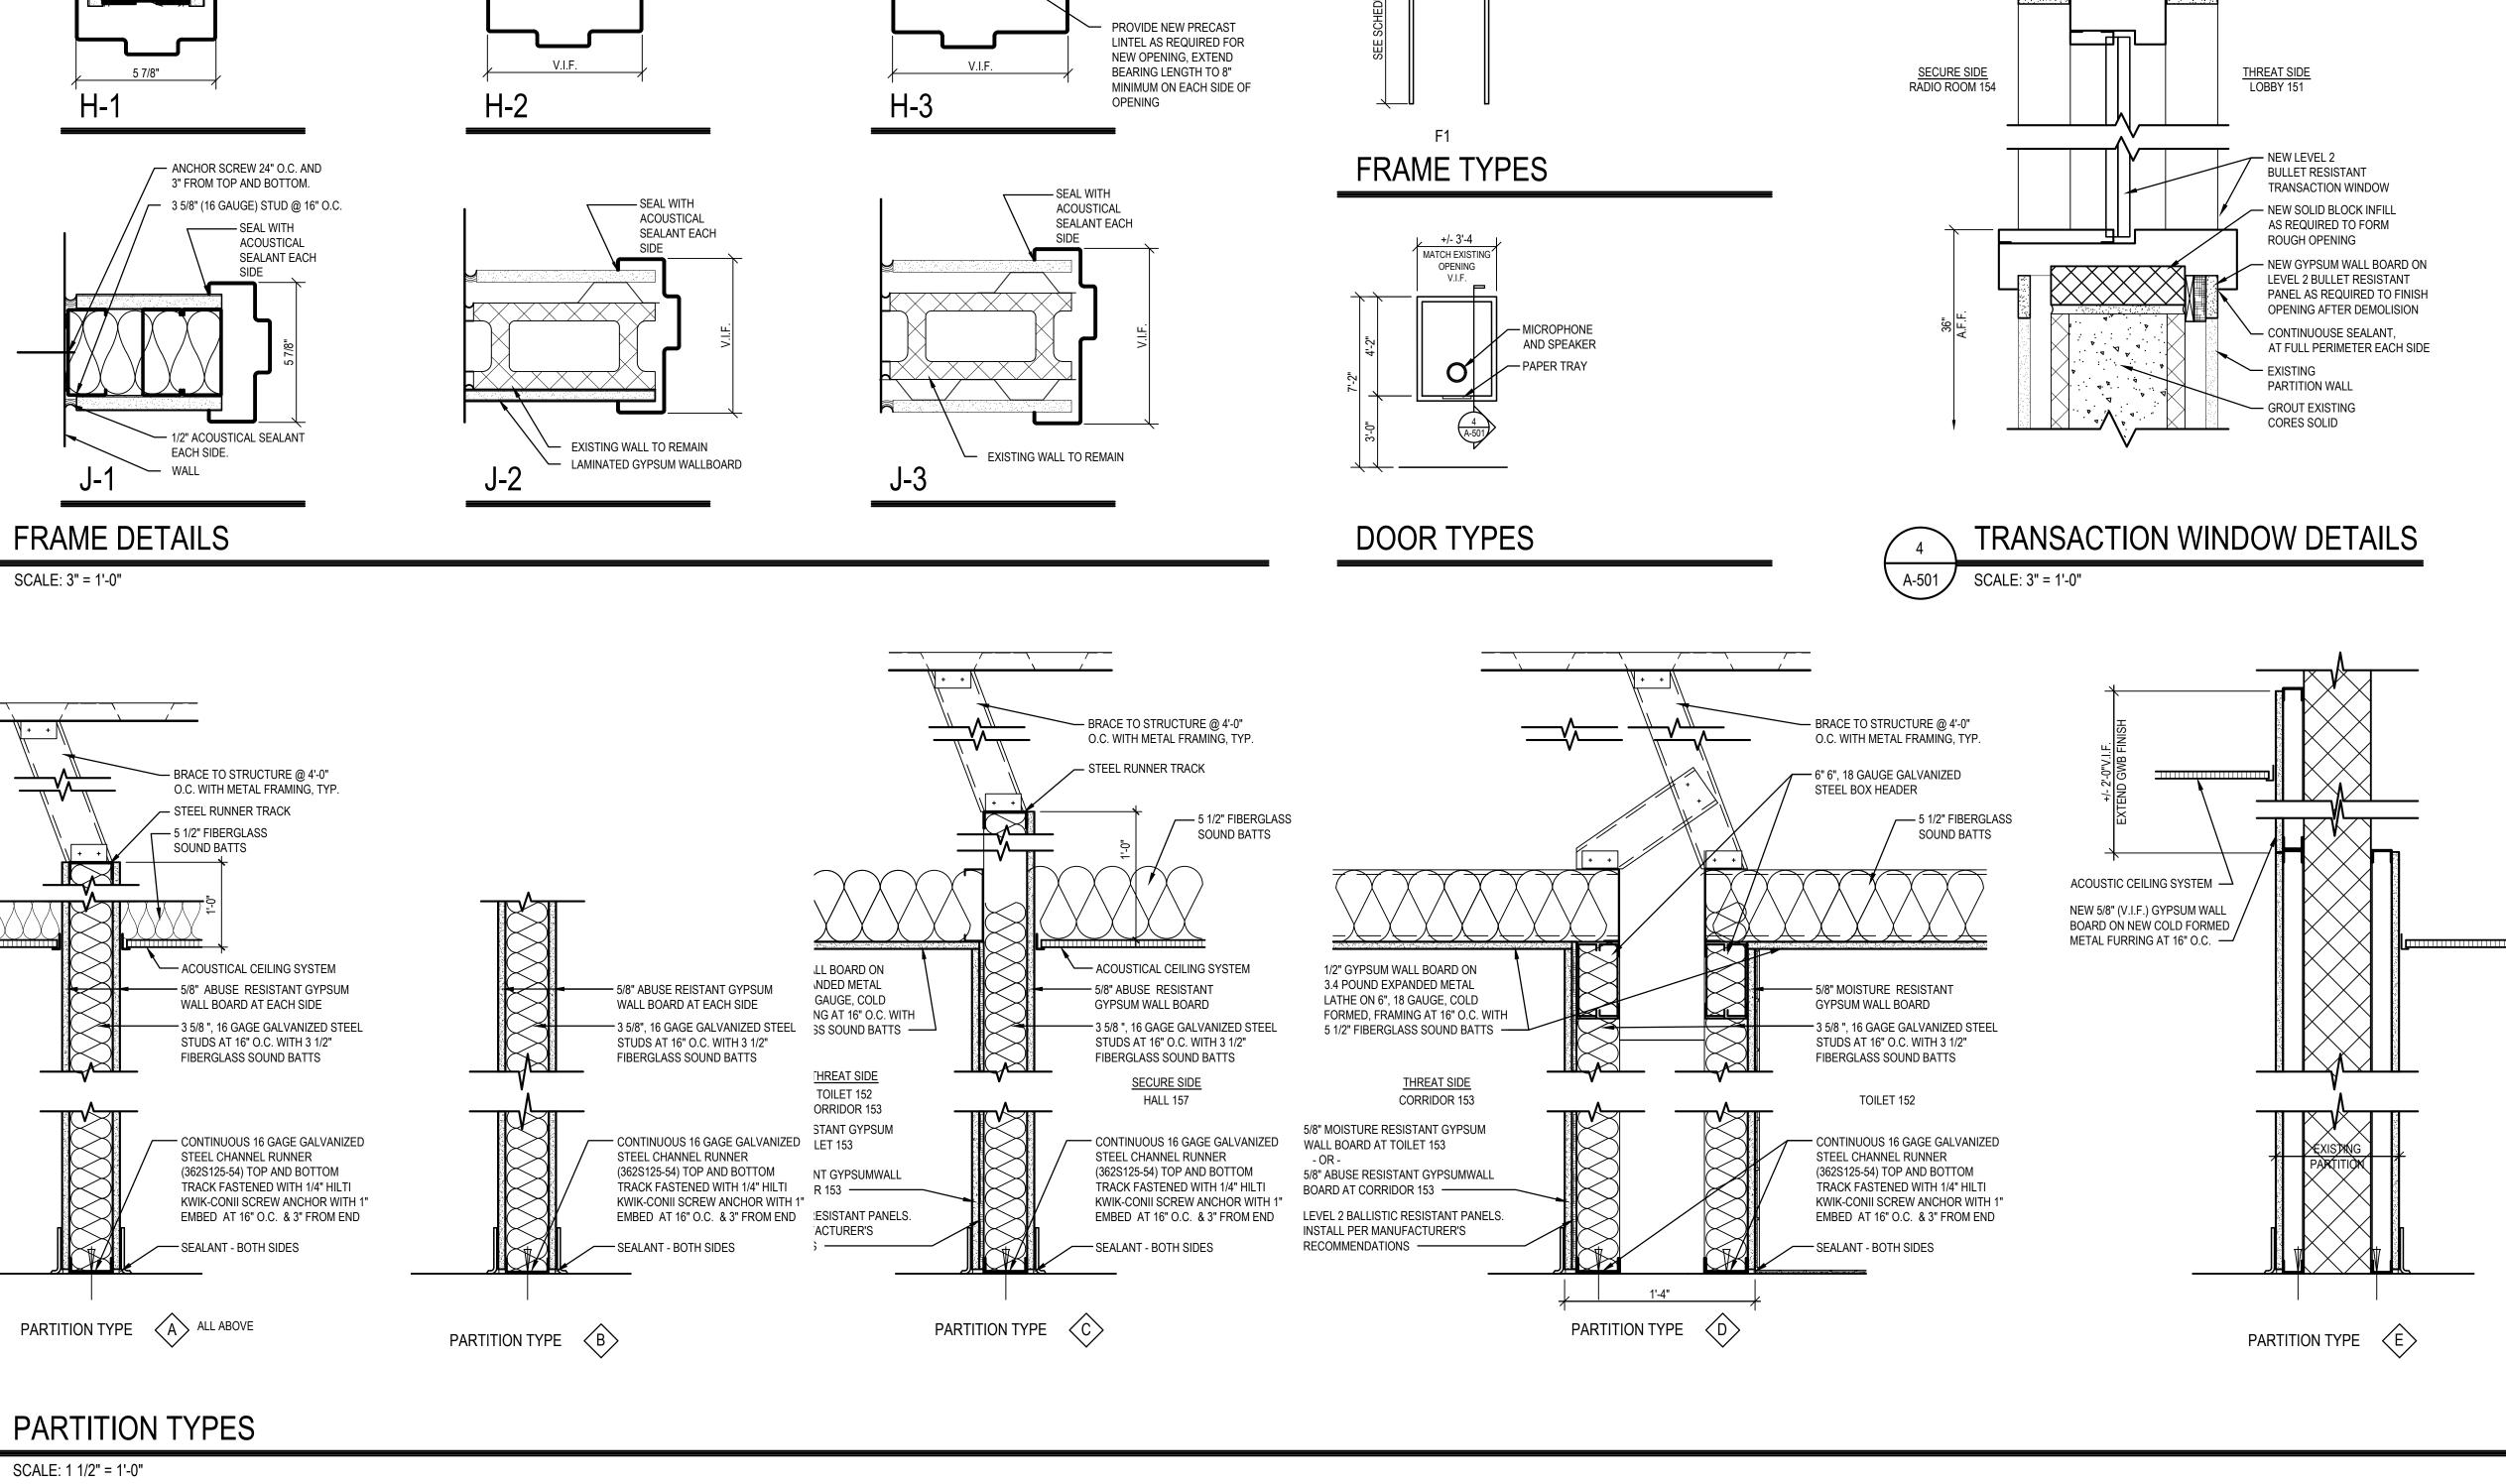

KB/AB | AB/PG | 20008

A-501

SHEET NO.

GENERAL NOTES (APPLY TO WORK PROVIDED UNDER DIV. 20):

- 1. <u>GENERAL:</u> FURNISH LABOR, EQUIPMENT AND MATERIALS NECESSARY FOR THE INSTALLATION OF THE COMPLETE MECHANICAL SYSTEMS AS SPECIFIED HEREIN AND INDICATED IN THE CONTRACT DOCUMENTS. OUTLINE DESCRIPTION AND DIAGRAMMATIC REPRESENTATION OF SYSTEM OPERATION AND EQUIPMENT DOES NOT LIMIT CONTRACTOR LIABILITY FOR FURNISHING AND INSTALLING COMPLETE AND OPERABLE SYSTEMS.
- 2. <u>APPLICABLE CODES:</u> THE INSTALLATION SHALL COMPLY WITH THE LATEST EDITION OF THE CODE OF THE LOCAL AUTHORITY HAVING JURISDICTION.
- 3. NOTE DEFINITIONS: "DRAWING NOTES" APPLY TO THE ENTIRE DRAWING ON WHICH THEY APPEAR, WHERE RELEVANT. "SPECIFIC NOTES" APPLY ONLY WHERE INDICATED WITH THE "SPECIFIC NOTE" SYMBOL. REFER TO LEGEND.
- 4. DUCTWORK TO BE SHEET METAL UNLESS NOTED OTHERWISE.
- 5. PROVIDE REQUIRED CLEARANCE FOR MAINTENANCE IN ACCORDANCE WITH MANUFACTURERS RECOMMENDATIONS OR AS REQUIRED BY CODE FOR MECHANICAL EQUIPMENT.
- 6. VERIFY THAT EXISTING EQUIPMENT THAT IS TO REMAIN IS FULLY FUNCTIONAL AND OPERATIONAL.
- 7. <u>PERMITS:</u> INCLUDE IN THE BID PRICE THE PAYMENT OF NECESSARY PERMITS. FURNISH THE OWNER PRIOR TO THE FINAL PAYMENT A CERTIFICATE FROM THE INSPECTION DEPARTMENT HAVING JURISDICTION CERTIFYING THAT THE WORK MEETS THE REQUIREMENTS OF THE LOCAL INSPECTION AUTHORITIES AND/OR THE NATIONAL BOARD OF FIRE UNDERWRITERS.
- 8. SCHEDULING: COORDINATE WITH THE OWNER FOR SCHEDULING OF WORK.
- 9. WORK SHALL BE INSTALLED IN A NEAT AND WORKMANLIKE MANNER.
- 10. KEEP THE WORK SITE AND SURROUNDING AREA FREE FROM ACCUMULATION OF WASTE MATERIALS OR RUBBISH GENERATED BY WORK FROM THIS CONTRACT. PROPERLY AND LEGALLY DISPOSE OF MATERIALS.
- 11. SAFETY: JOB SITE SAFETY SHALL BE IN STRICT ACCORDANCE WITH LOCAL, STATE, AND FEDERAL REQUIREMENTS.
- 12. VISIT THE SITE AND CAREFULLY EXAMINE EXISTING CONDITIONS THAT MAY AFFECT THE BID.
- 13. EXISTING MECHANICAL INSTALLATION: EXISTING MECHANICAL WORK WHICH WILL NOT BE RENDERED OBSOLETE AND WHICH MAY BE DISTURBED DUE TO ANY CHANGES REQUIRED UNDER THIS CONTRACT SHALL BE RESTORED TO ITS ORIGINAL OPERATING CONDITION. OTHER MECHANICAL ITEMS RENDERED OBSOLETE SHALL BE ABANDONED WHERE CONCEALED AND REMOVED WHERE EXPOSED.
- 14. WHERE EXISTING MECHANICAL WORK INTERFERES WITH NEW WORK AND WHERE SUCH INSTALLATIONS ARE TO REMAIN IN USE, THE INSTALLATIONS SHALL BE DISCONNECTED AND RELOCATED AND/OR RECONNECTED TO COORDINATE WITH NEW WORK AS INDICATED IN THE CONTRACT DOCUMENTS AND AS SPECIFIED.
- 15. DO NOT DISCONTINUE ANY MECHANICAL SYSTEM SERVICE WITHOUT FIRST OBTAINING WRITTEN APPROVAL FROM THE USER AGENCY. THE MECHANICAL SYSTEM OUTAGES SHALL BE KEPT TO A MINIMUM.
- 16. PROVIDE SUBMITTALS (SHOP DRAWINGS) FOR REVIEW FOR NEW MATERIALS AND EQUIPMENT. PRIOR TO SUBMITTING, REVIEW SUBMITTALS FOR COMPLIANCE WITH THE CONTRACT DOCUMENTS, CONFLICTS WITH OTHER TRADES, AND CONSTRUCTABILITY. IDENTIFY ANY DEVIATIONS IN SUBMITTALS FROM CONTRACT DOCUMENTS. ENGINEER'S REVIEW OF SUBMITTALS DOES NOT INCLUDE REVIEW OF DIMENSIONS, DETAILS, OR QUANTITIES. REVIEW DOES NOT WAIVE ANY REQUIREMENTS OF CONTRACT DOCUMENTS, INCLUDING REQUIREMENT TO PROVIDE A COMPLETE AND FUNCTIONAL SYSTEM.
- 17. WHEN MOUNTING MECHANICAL WORK IN AREAS SUBJECT TO PEDESTRIAN TRAFFIC, MAINTAIN REQUIRED HEADROOM CLEARANCES.
- 18. MECHANICAL MATERIALS AND EQUIPMENT SHALL BE INSTALLED AS TO MAINTAIN THEIR RESPECTIVE UL RATING AND SHALL CONFORM TO FACTORY MUTUAL STANDARDS AS APPLICABLE.
- 19. MECHANICAL WORK SHALL BE CONCEALED IN FINISHED AREAS SHOWN ON THE ARCHITECTURAL DRAWINGS UNLESS NOTED OTHERWISE.
- 20. <u>EQUIPMENT LOCATIONS</u>: REFER TO THE ARCHITECTURAL DRAWINGS FOR EXACT DIFFUSER LOCATIONS AND THE ELECTRICAL DRAWINGS FOR EXACT ELECTRICAL EQUIPMENT LOCATIONS. LOCATIONS OF MECHANICAL EQUIPMENT, DUCTWORK, AND PIPING ARE SHOWN DIAGRAMMATICALLY. DETERMINE EXACT LOCATIONS IN THE FIELD.
- 21. WHERE NEW OR RELOCATED CONTROL DEVICES ARE SHOWN ON EXISTING WALLS, CUT WALL, INSTALL DEVICE AND CONDUIT, AND REPAIR WALL PROPERLY TO ITS ORIGINAL CONDITION.
- 22. SEALING FITTINGS AND APPROVED SEALING COMPOUND SHALL BE INSTALLED IN ACCORDANCE WITH THE APPLICABLE CODE. SEAL AROUND PENETRATIONS OF FIRE-RATED WALLS WITH AN APPROVED SEALANT.
- 23. LOCATIONS OF DUCTWORK, AIR DEVICES, TEMPERATURE CONTROLS, AND EQUIPMENT SHALL BE COORDINATED WITH THE ARCHITECTURAL LAYOUTS, EQUIPMENT CUTS AND PLUMBING/ELECTRICAL PLANS. NO WORK SHALL BE INSTALLED UNTIL THE LOCATIONS HAVE BEEN VERIFIED. BRING ANY DISCREPANCY TO THE ARCHITECTS ATTENTION PRIOR TO MANUFACTURING OF DUCTWORK OR INSTALLATION.
- 24. NORTH ARROWS ON THESE DRAWINGS INDICATE PLAN NORTH ONLY.
- 25. INSTALL A MANUAL VOLUME DAMPER IN EACH BRANCH DUCT THAT RUNS TO (1) AIR DEVICE.
- 26. PROVIDE PIPE SLEEVE FOR PIPING PENETRATIONS THROUGH RATED SLABS OR WALLS.
- 27. DUCT JOINTS SHALL BE SEALED USING 3M MODEL 540 DUCT SEALER. EXCESS SEALER SHALL BE REMOVED FROM DUCTWORK AND JOINTS. PAINT SEALED JOINTS TO MATCH FINISH OF DUCTWORK.
- 28. IN AREAS WHERE WORK IS INSTALLED IN CLOSE PROXIMITY TO WORK OF OTHER TRADES OR WITHIN TRADES COVERED BY THIS DIVISION OF THE SPECIFICATIONS, PREPARE LARGER SCALE DRAWINGS CONSISTING OF PLANS AND SECTIONS TO SHOW HOW WORK IS TO BE INSTALLED IN RELATION TO WORK OF OTHER TRADES.

GENERAL DEMOLITION NOTES (APPLY TO WORK PROVIDED UNDER DIVISION 20):

- 1. DEMOLITION WORK IS GENERALLY INDICATED AS PART OF THESE NOTES AND THE NOTES INDICATED ON THE ARCHITECTURAL DEMOLITION PLANS.
- 2. VERIFY THAT EXISTING PIPING, EQUIPMENT, ETC. THAT IS CALLED FOR REMOVAL IS NO LONGER IN SERVICE BEFORE BEGINNING DEMOLITION.
- 3. THE DEMOLITION NOTES INDICATE THE MAIN COMPONENTS OF SYSTEMS AND EQUIPMENT THAT SHALL BE REMOVED UNDER THIS CONTRACT. IF SYSTEMS AND EQUIPMENT ARE FOUND DURING CONSTRUCTION THAT THE OWNER AUTHORIZES FOR REMOVAL BUT HAVE NOT BEEN SPECIFICALLY CALLED FOR DEMOLITION, REMOVE THE SYSTEMS AND FOLIPMENT
- 4. WHEN THE WORK SPECIFIED HEREUNDER CONNECTS TO ANY EXISTING EQUIPMENT, PIPING, ETC., PERFORM NECESSARY ALTERATIONS, CUTTING, FITTING, ETC. OF THE EXISTING WORK AS MAY BE NECESSARY OR REQUIRED TO MAKE SATISFACTORY CONNECTIONS BETWEEN THE NEW AND EXISTING WORK AND LEAVE THE COMPLETE WORK IN A FINISHED AND WORKMANLIKE CONDITION.
- 5. WHEN THE WORK SPECIFIED UNDER OTHER DIVISIONS NECESSITATES RELOCATION OF EXISTING EQUIPMENT, PIPING, ETC. PERFORM WORK AND MAKE NECESSARY CHANGES TO EXISTING WORK AS MAY BE REQUIRED TO LEAVE THE COMPLETED WORK IN A FINISHED AND WORKMANLIKE CONDITION.
- . REMOVE FROM THE PREMISES AND DISPOSE OF EXISTING PIPING, MATERIAL, FIXTURES, EQUIPMENT, ETC. NOT REQUIRED FOR RE- USE OR RE-INSTALLATION.
- 7. DELIVER ON THE PREMISES WHERE DIRECTED EXISTING MATERIAL AND EQUIPMENT WHICH IS REMOVED AND IS DESIRED BY THE OWNER OR IS INDICATED TO REMAIN THE PROPERTY OF THE OWNER.
- 8. OTHER MATERIALS AND EQUIPMENT WHICH ARE REMOVED SHALL BECOME THE PROPERTY OF THE CONTRACTOR AND SHALL BE REMOVED FROM THE PREMISES.
- 9. PIPING ABANDONED IN CONCRETE SLABS, WALLS, OR OTHER INACCESSIBLE LOCATIONS SHALL BE LEFT EMPTY.

COMMON CONTROLS NOTES:

- 1. ALL MECHANICAL SYSTEM CONTROLS COMPONENTS AND SEQUENCES SHALL BE COORDINATED AND INTEGRATED WITH THE EXISTING JCI METASYS BUILDING MANAGEMENT SYSTEM.
- 2. PROVIDE ALL NECESSARY WIRING, CONTROLS COMPONENTS, EQUIPMENT, SOFTWARE MODIFICATIONS, AND POWER TRANSFORMERS REQUIRED FOR A FULLY FUNCTIONING, LOCAL STAND-ALONE SYSTEM OPERATION, WITH CENTRAL JCI METASYS BAS SYSTEM MONITORING, AND CONTROLS OVERRIDE CAPABILITY.

HVAC CONTROL SEQUENCES:

1. EXHAUST FAN: (EF-8)

A. DURING OCCUPIED PERIODS EF-8 IS TO BE ENERGIZED AND RUNNING CONTINUOUSLY.

B. DURING UNOCCUPIED PERIODS EF-8 IS TO BE OFF.

2. ELECTRIC BASEBOARD HEATERS: (EBH-1)

A. LOCAL WALL MOUNTED THERMOSTAT IS TO CONTROL UNIT TO MAINTAIN A SPACE TEMPERATURE OF 68 DEGREES F (ADJUSTABLE).

3. SPLIT SYSTEM: (ACU-1/ ACCU-1)

A. SYSTEM IS TO CYCLE PER THE MANUFACTURER PROVIDED CONTROLS BASED ON A SIGNAL FROM A WALL MOUNTED THERMOSTAT TO MAINTAIN A SPACE TEMPERATURE SET POINT OF 72 DEGREE F (ADJUSTABLE).

BAS MONITORING AND CONTROL:

1. PROVIDE EF-8 WITH MONITORING AND CONTROL FOR THE FOLLOWING:

A. FAN ON/OFF

2. PROVIDE ACU-1/ ACCU-1 WITH MONITORING AND CONTROL FOR THE FOLLOWING:
A. UNIT ON/OFF

B. SPACE TEMPERATURE SETPOINT (ADJUSTABLE)

C. SPACE TEMPERATURE SETPOINT (ADJUSTABLE)

C. SPACE TEMPERATURE (MONITORING AND HIGH TEMP. ALARM ONLY)

MECHANICAI <u>symbol</u>	L LLGLIND	ABBREV	DESCRIPTION	ABBREV
CT -		CT/CTWS CTR/CTWR	COOLING TOWER WATER SUPPLY COOLING TOWER WATER RETURN	ABV
– – – – – CTR – – – C –		C	CONDENSER WATER SUPPLY	AFF
C		CR	CONDENSER WATER RETURN	AHU
			FLOW METER FITTING	BTU CB
			REDUCED PRESSURE ZONE	CFH
T.			BACKFLOW PREVENTER	CFM
) TP	TP	TRAP PRIMER RELIEF VALVE	CL
	'	MAV	MANUAL AIR VALVE	СТ
AAV \diamondsuit		AAV	AUTOMATIC AIR VALVE	CTW
+	<u></u>		STRAINER W/VALVE	CW DIFF
۷	*		UNION	DB
				DN
		SA	SHOCK ABSORBER	EAT
F3			FLOW SWITCH	EBH
Φ			THERMOMETER/THERMOSTAT	EF
I			THEDMOMETED WELL	ESP
			THERMOMETER WELL	EL EX/EXIST.
P			PRESSURE GAUGE W/	EXH
I	·		SYPHON & NEEDLE VALVE	EXTR
			PRESSURE GAUGE W/NEEDLE VALVE	FBR
		PG	PRESSURE GAUGE TAPPING	(FLOOR PLA -M-1)
			PIPE GUIDE	GR
×		TOV	ANCHOR TEMPERATURE CONTROL VALVE (2.14/A)	GPM
—————————————————————————————————————		TCV TCV	TEMPERATURE CONTROL VALVE (2-WAY) TEMPERATURE CONTROL VALVE (3-WAY)	HWS
		101	STEAM TRAP ASSEMBLY (THERMODYNAMIC)	HWR
			DRIP POINT	HUH
			BUCKET TRAP	LAT LVR
		F&T	FLOAT AND THERMOSTATIC TRAP	KW
	∧ 		FLEXIBLE PIPE CONNECTION	MBH
	<u> </u>		OS&Y VALVE W/ TAMPER SWITCH	OA
 5			SHUTOFF VALVE	PD
			CHECK VALVE	PSI
BWV BWV	BWV	BWV	BACK WATER VALVE	RA REG
	A .			RX
─ ────────────────────────────		PRV	PRESSURE REDUCING VALVE	SA
o	9		PIPE TURNING UP	TSP
	9		PIPE TURNING DOWN	TYP
	9 _~			V-PH
			TEE TURNING UP TEE TURNING DOWN	VTR UG
	F		TEE TORRING BOWN	UH
①			THERMOSTAT	
			SUPPLY DUCT TURNED UP	SYMBOL
X			SUPPLY DUCT TURNED DOWN	
			RETURN OR OUTSIDE AIR DUCT TURNED UP	
			RETURN OR OUTSIDE AIR DUCT	
	pun l		TURNED DOWN	
	\sim			
			EXHAUST AIR DUCT TURNED UP	
l y			EXHAUST AIR DUCT TURNED DOWN	
			FLEXIBLE DUCT CONNECTION	
		DD	DUCT SMOKE DETECTOR	
	MVD	MVD	MANUAL VOLUME DAMPER	
	MOD	MOD	MOTOR OPERATED DAMPER	
	SD	SD	SMOKE DAMPER	
	FD	FD	FIRE DAMPER	
	BDD	BDD	BACKDRAFT DAMPER	
$r \lor \lor \lor \lor$	< < < < < < < < < < < < < < < < < < <	OBD	OPPOSED BLADE DAMPER	
	-		MATCH LINE	
_			PIPING BELOW GRADE	
1	>		SECTION DESIGNATION	
1	/		OLO HON DEGIONATION	DELAWAR
1			DETAIL DESIGNATION	DELAWAR CAF
\ 1	/			1



DESCRIPTION

EXTENT OF NEW WORK

EXTENT OF DEMOLITION

AREA TO BE DEMOLISHED

DELAWARE RIVER AND BAY AUTHORITY CAPE MAY — LEWES FERRY

CONTRACT NO. CMLF-C19-06
TERMINAL POLICE AND ADMINISTRATION
BUILDING - DISPATCH CENTER REHAB

GENERAL NOTES
SYMBOLS AND
ABBREVIATIONS

DESCRIPTION

ABOVE FINISHED FLOOR

BRITISH THERMAL UNIT

AIR HANDLING UNIT

CUBIC FEET HOUR

CUBIC FEET MINUTE

CATCH BASIN

CENTER LINE

COLD WATER

DIFFUSER

DRY BULB

EXHAUST FAN

EXISTING TO REMAIN

PLAN ON DRAWING M-1

GALLONS PER MINUTE

HOT WATER SUPPLY

HOT WATER RETURN

HYDRONIC UNIT HEATER

LEAVING AIR TEMPERATURE

POUNDS PER SQUARE INCH

TOTAL STATIC PRESSURE

VENT THROUGH ROOF

UNDER GROUND

<u>ABBREV</u>

UNIT HEATER

ELEVATION

EXISTING EXHAUST

GRILLE

LOUVER

KILOWATTS

OUTSIDE AIR

RETURN AIR

REGISTER

SUPPLY AIR

TYPICAL

THOUSAND BTU/HR

PRESSURE DROP

REMOVE EXISTING

DOWN

COOLING TOWER

COOLING TOWER WATER

ENTERING AIR TEMPERATURE

EXTERNAL STATIC PRESSURE

FIN TUBE BASEBOARD RADIATION

ELECTRIC BASEBOARD HEATER

ABOVE

M-000

DATE: MAY 2022 SCALE: AS NOTED SHEET NO.

REVISION


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SPECIFIC DEMOLITION NOTES (APPLY TO THIS DRAWING WHERE INDICATED):

REMOVE RETURN REGISTER/CEILING DIFFUSER, CLEAN, AND RETAIN FOR REINSTALLATION AS PART OF NEW WORK. DEMOLISH AND REPLACE ANY FLEXIBLE DUCTWORK.

EXISTING THERMOSTAT TO BE REMOVED AND REINSTALLED.


DISCONNECT AND REMOVE EXISTING ELECTRIC BASEBOARD HEATER AND SAVE FOR REINSTALLATION.

4 REMOVE HW PIPE RISER.

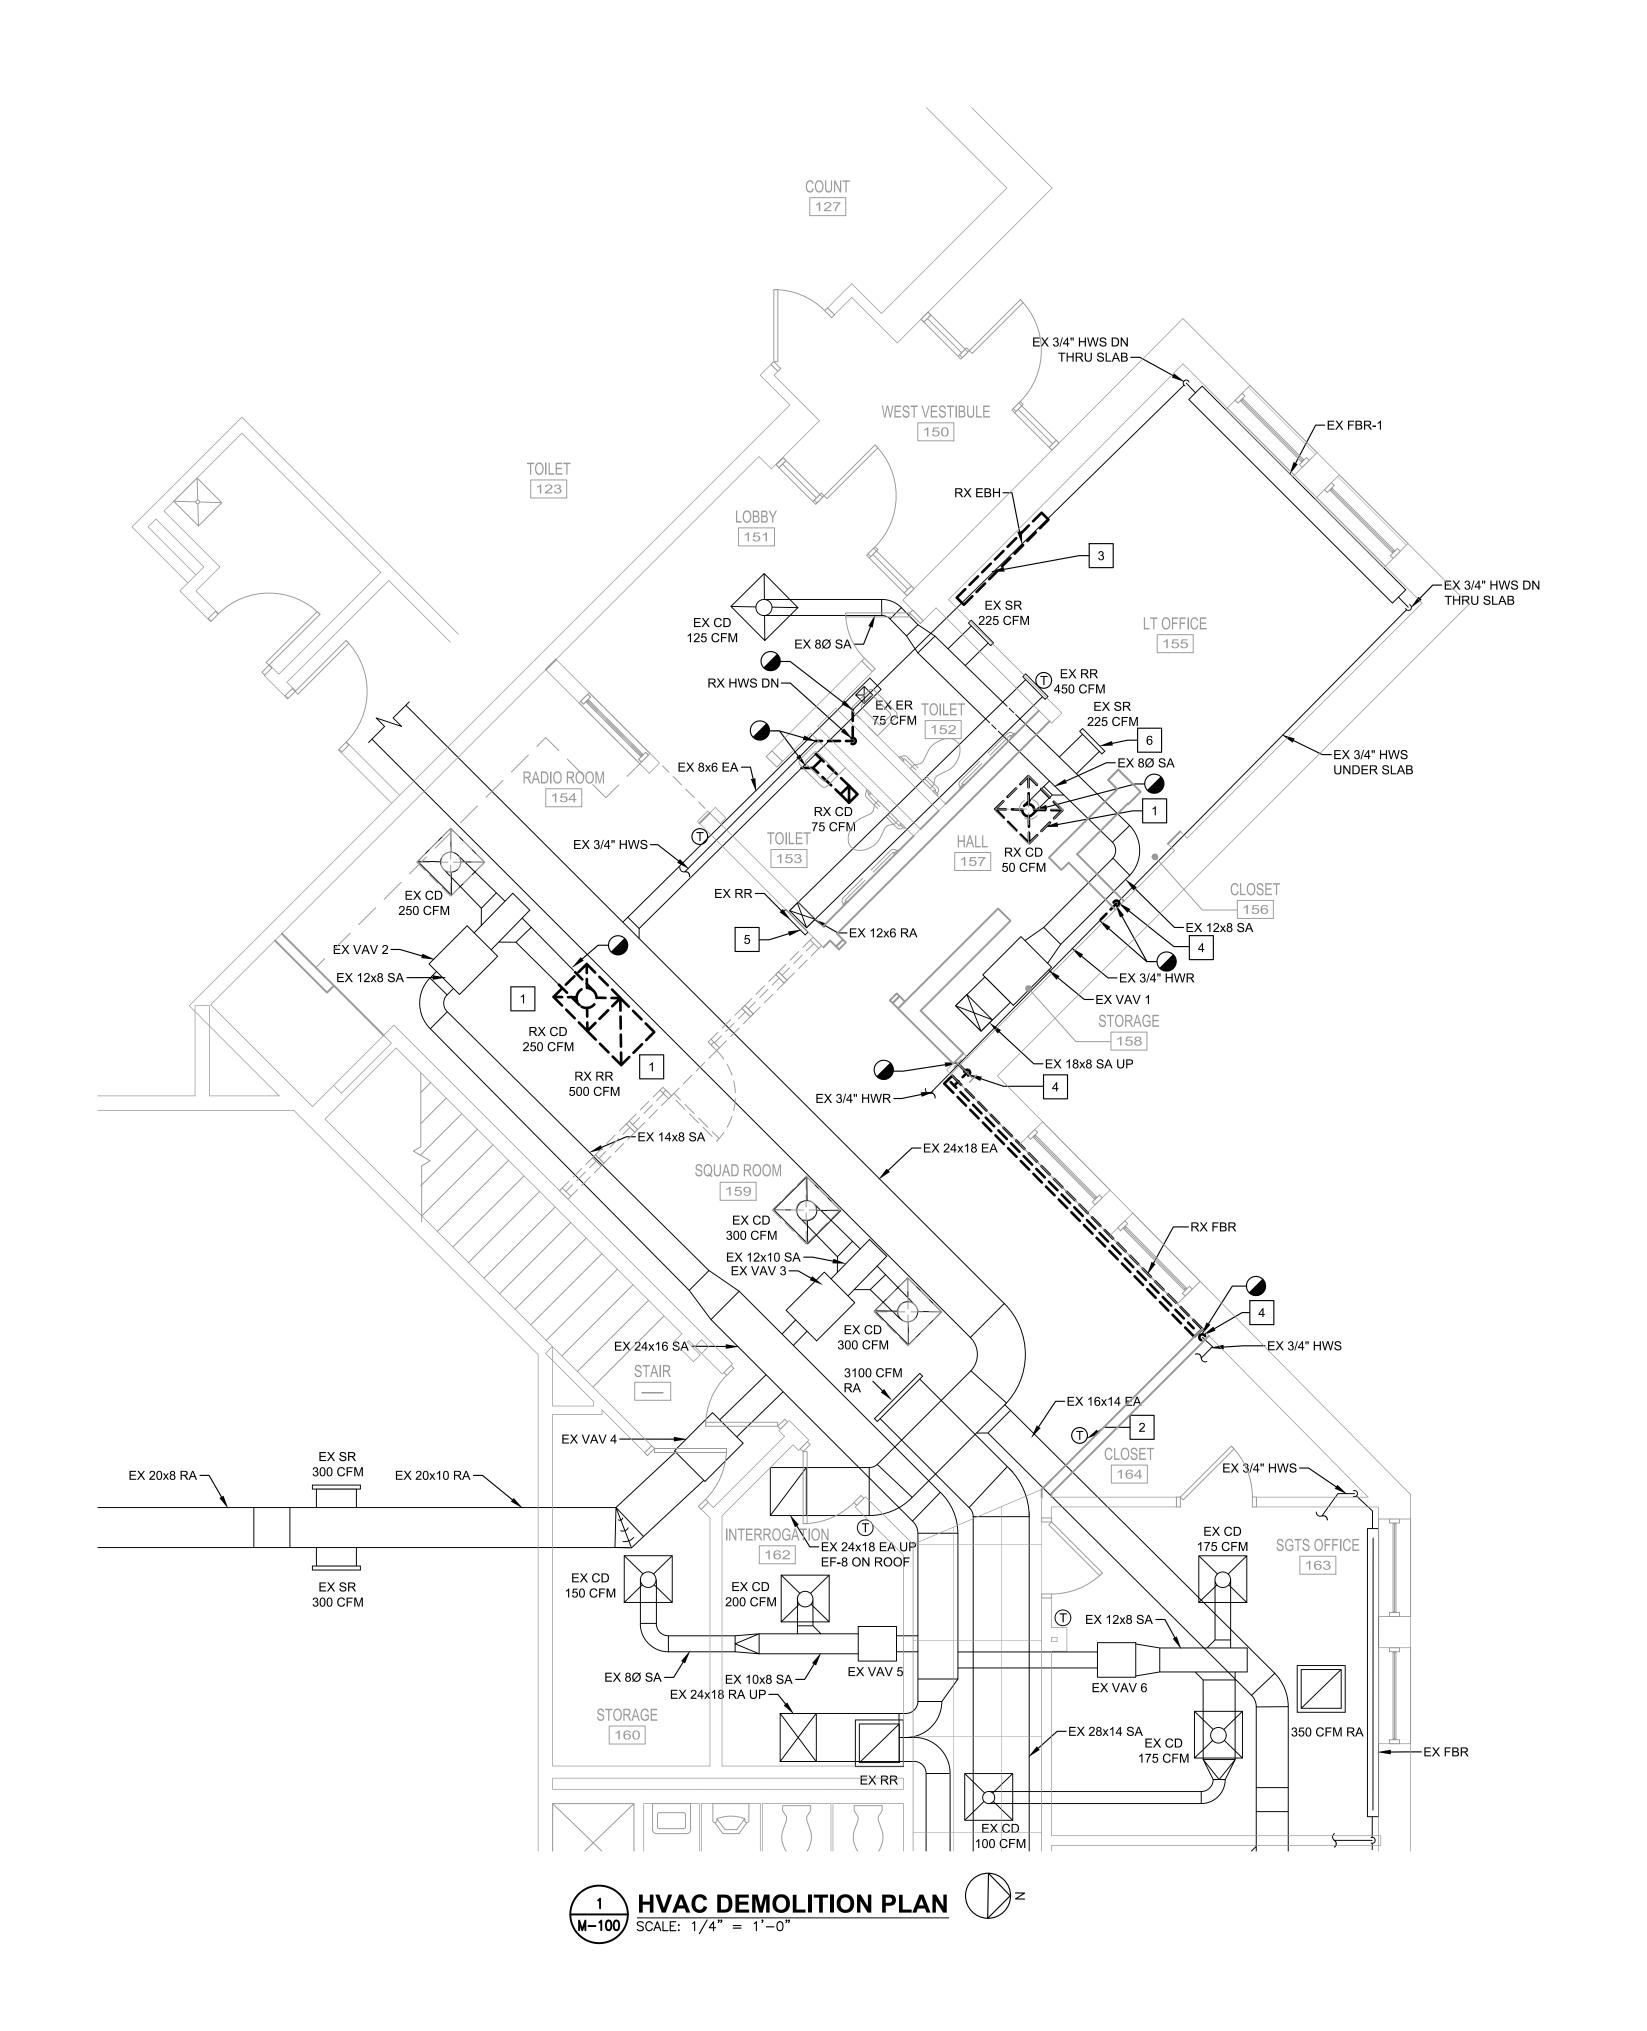5 EXISTING REGISTER ABOVE CEILING IN PLENUM.

REMOVE THERMOSTAT AND STORE FOR REINSTALLATION AS PART OF NEW WORK.

DEMOLITION WORK SHALL BE DONE IN PHASES. COORDINATE WORK WITH NEW INSTALLATIONS.

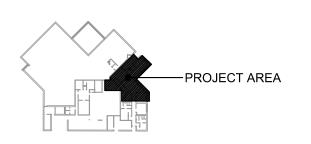





DELAWARE RIVER AND BAY AUTHORITY

CAPE MAY — LEWES FERRY

CONTRACT NO. CMLF-C19-06
TERMINAL POLICE AND ADMINISTRATION
BUILDING - DISPATCH CENTER REHAB

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HVAC	DEMOLITION	PLAN	

DATE: MAY 2022 SCALE: AS NOTED SHEET NO. 10


0 1 2 4 8 12

GRAPHIC SCALE


1/4" = 1'-0"

SPECIFIC NOTES (APPLY TO THIS **DRAWING WHERE INDICATED):**

REMOVE EXHAUST FAN AND REPAIR ROOF CURB AS REQUIRED.

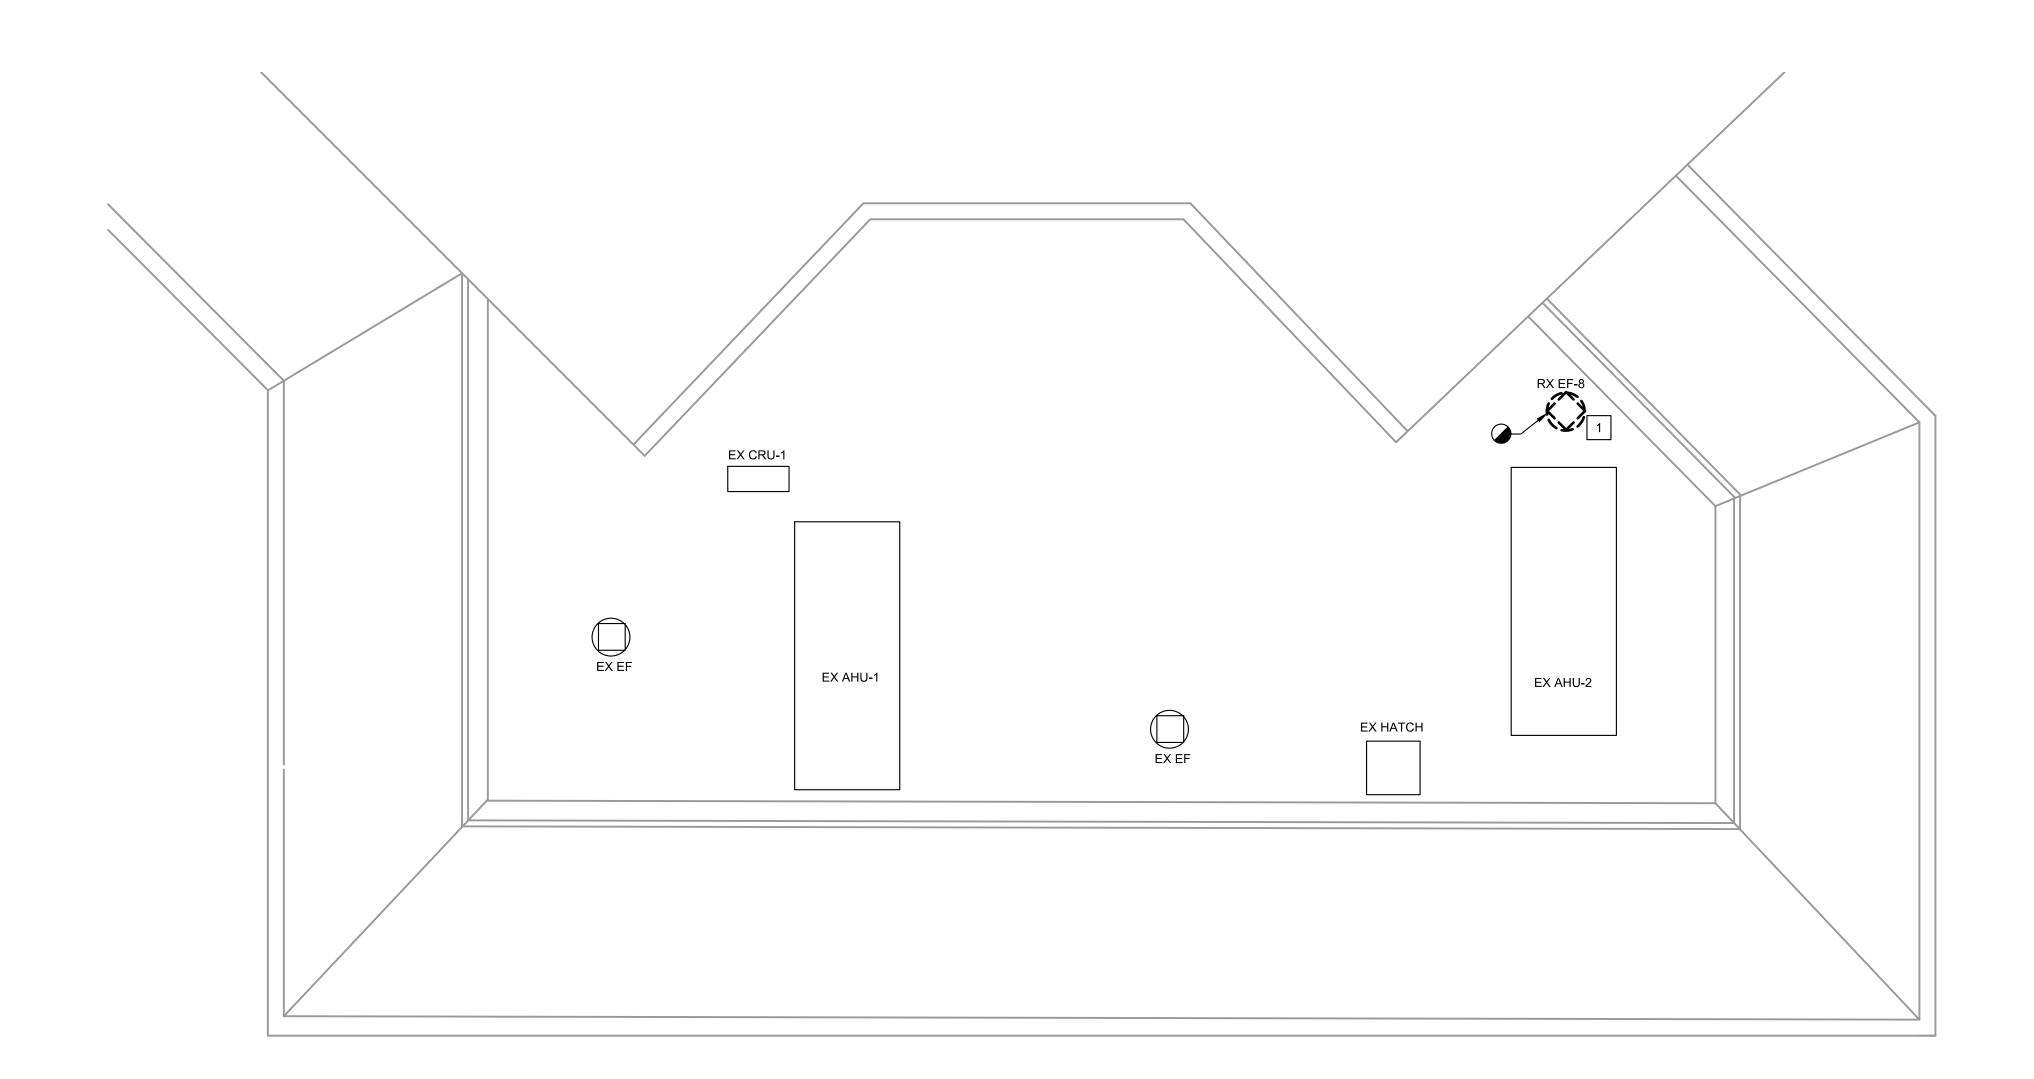



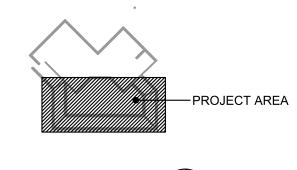



	NO.
2 4 8 16 2	4
GRAPHIC SCALE	
1/8" = 1'-0"	

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DELAWARE RIVER AND BAY AUTHORITY CAPE MAY — LEWES FERRY

CONTRACT NO. CMLF-C19-06 TERMINAL POLICE AND ADMINISTRATION BUILDING — DISPATCH CENTER REHAB

ROOF	HVAC	DEMOLITION
	PL	AN

M-101

DATE: MAY 2022	SCALE:	AS NOTED	SHEET NO.	11

DRAWING NOTES:

1. SEAL WALL PIPE PENETRATIONS.

SPECIFIC NOTES: (APPLY TO THIS DRAWING WHERE INDICATED):

- (1) REINSTALL EXISTING AIR DEVICE AT THIS LOCATION.
- 2 REINSTALL EXISTING THERMOSTAT WITH VAV BOX.
- 3/4" HWR WITH INSULATION ROUTED UNDER SLAB. CUT AND PATCH FLOOR AS REQUIRED. COORDINATE WITH OTHER DISCIPLINES.
- 4 3/4" HWR DROP DOWN THRU SLAB IN WALL.
- $\langle 5 \rangle$ COORDINATE PIPE ROUTING WITH DUCTWORK.
- SUSPEND REFRIGERANT PIPING FROM STRUCTURE. COORDINATE ROUTING WITH EXISTING CONDITIONS.
- 7 REINSTALL AND RECONNECT EXISTING ELECTRIC BASEBOARD HEATER
- 8 PATCH AND SEAL EXHAUST DUCT AT REMOVED BRANCH.
- 9 REINSTALL THERMOSTAT.






CONTRACT NO. CMLF—C19—06
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BUILDING — DISPATCH CENTER REHAB

HVAC PLAN

M-110

DATE: MAY 2022 SCALE: AS NOTED SHEET NO.

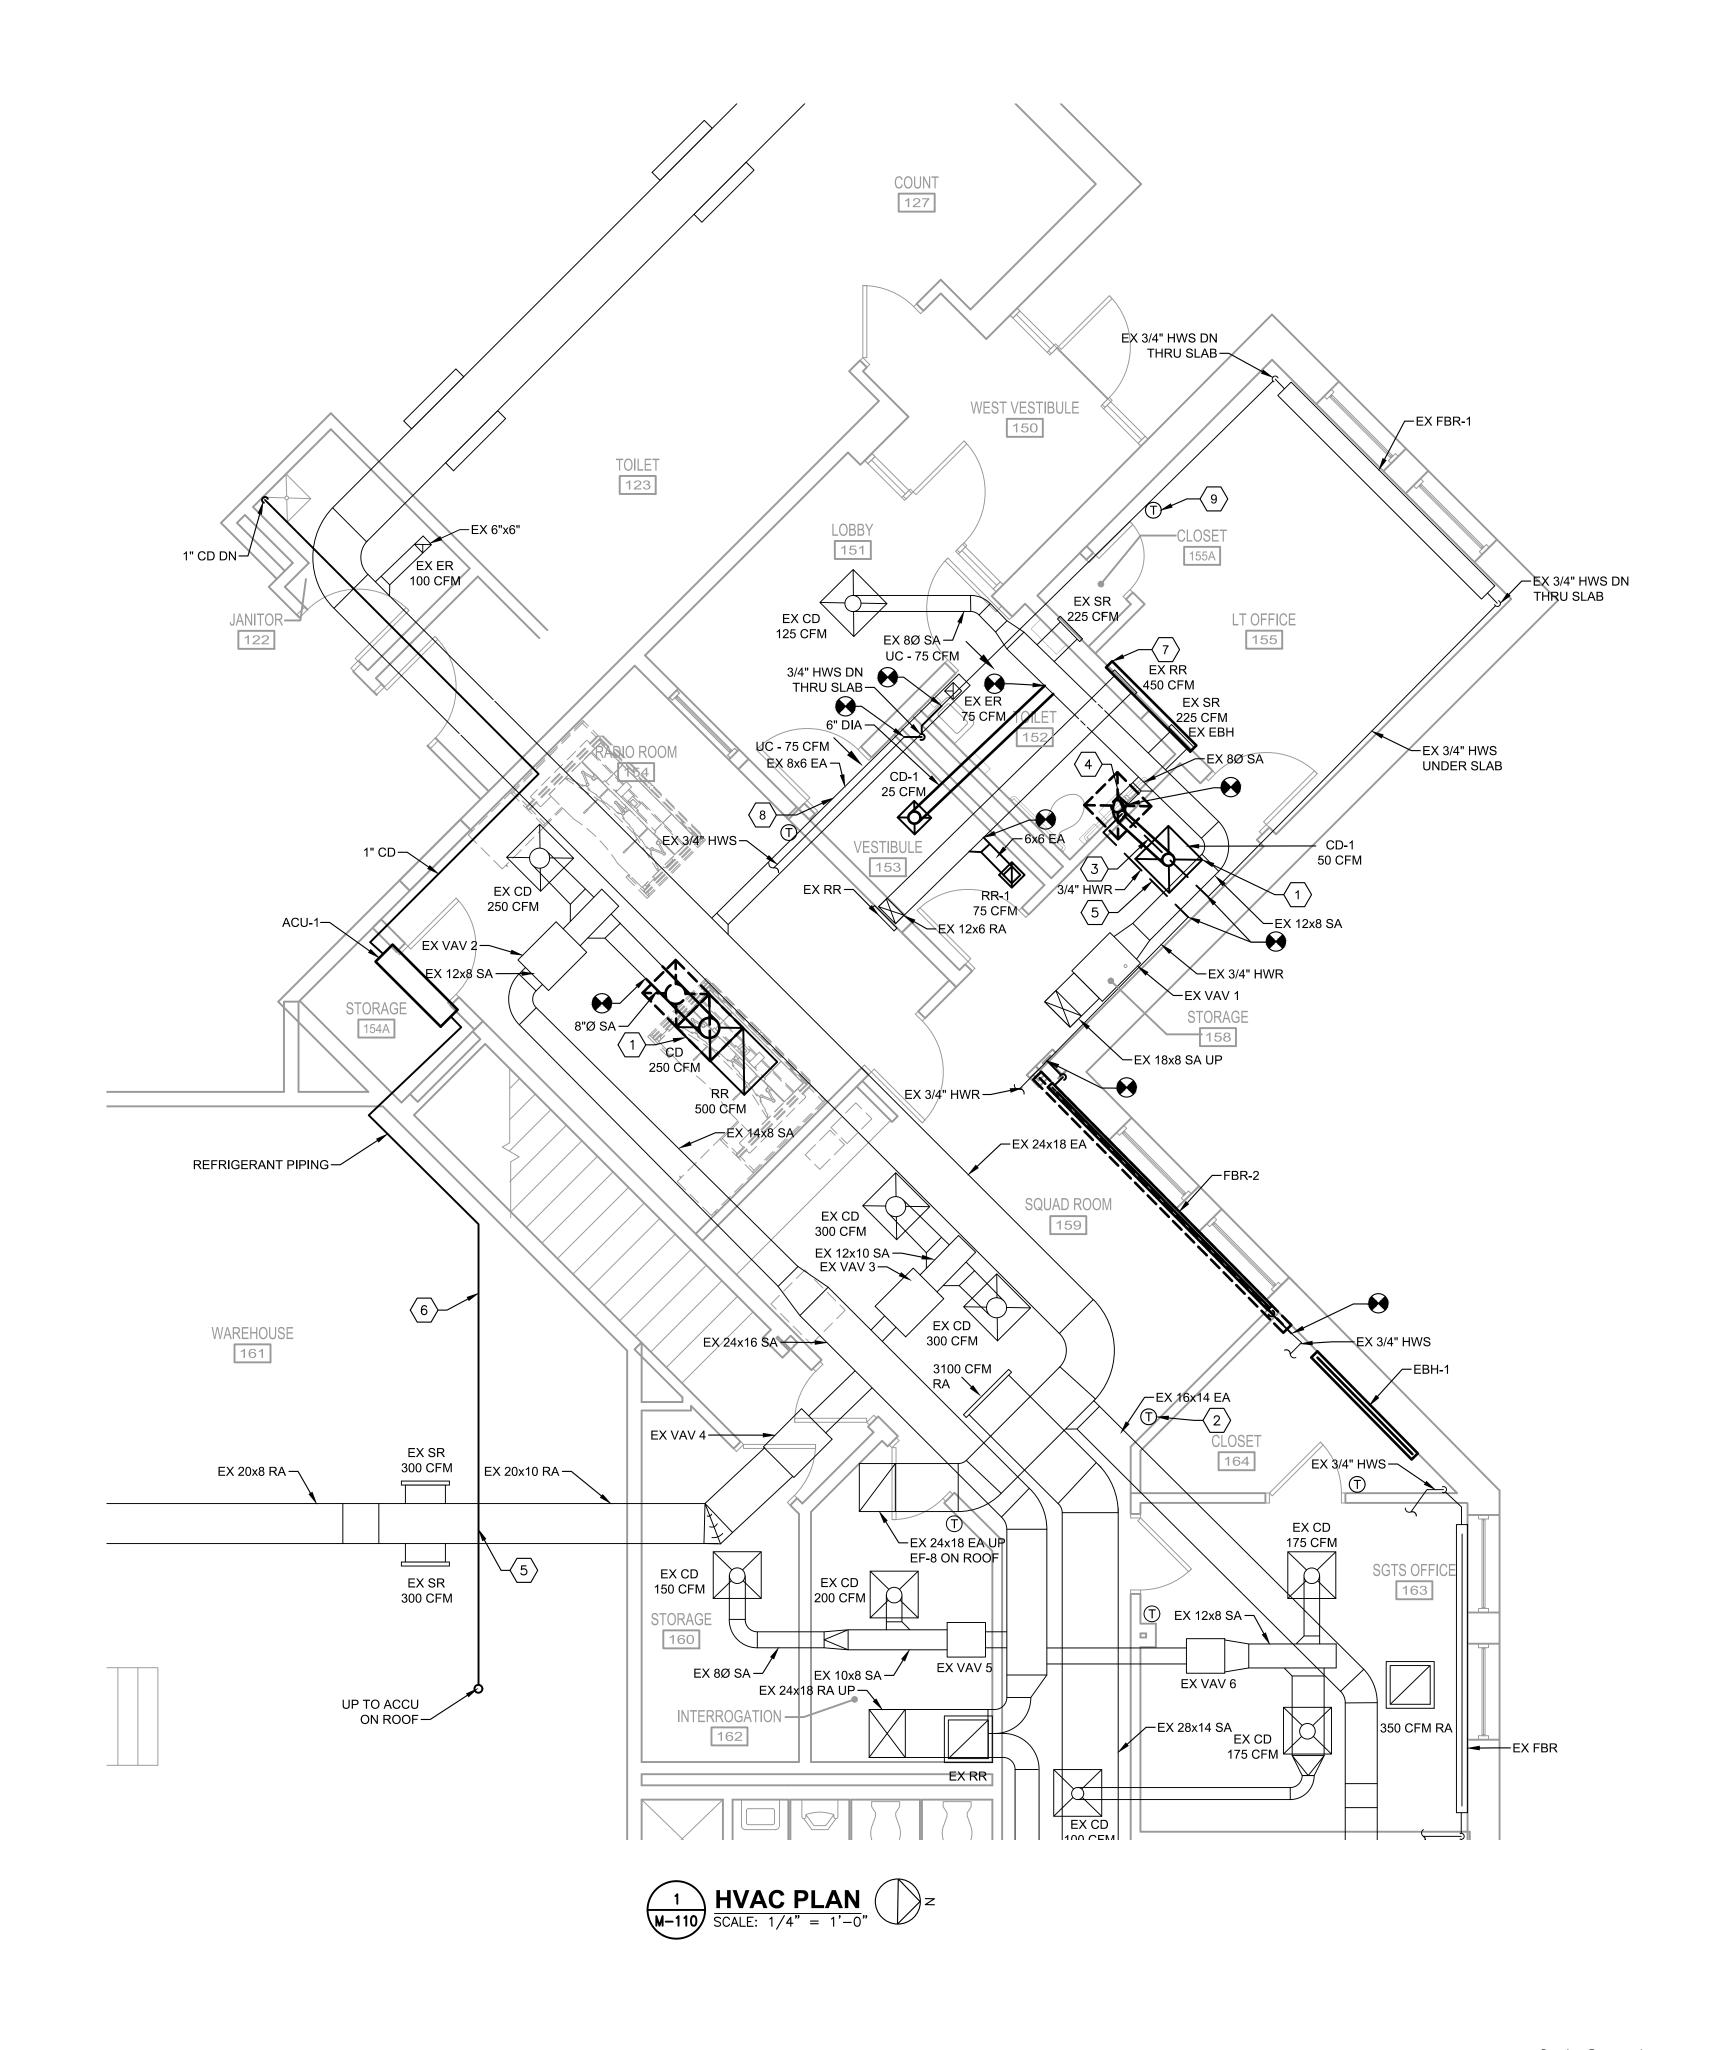



GRAPHIC SCALE 1/4" = 1'-0"


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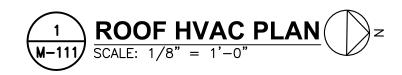
DRAWING NOTES:


- COORDINATE WORK WITH OTHER TRADES AND EXISTING CONDITIONS
- REFRIGERANT PIPING IS TO BE INSULATED WITH JACKETING SEALED WEATHER TIGHT.


SPECIFIC NOTES: (APPLY TO THIS DRAWING WHERE INDICATED):

1 REFRIGERANT PIPING ROOF PENETRATION.



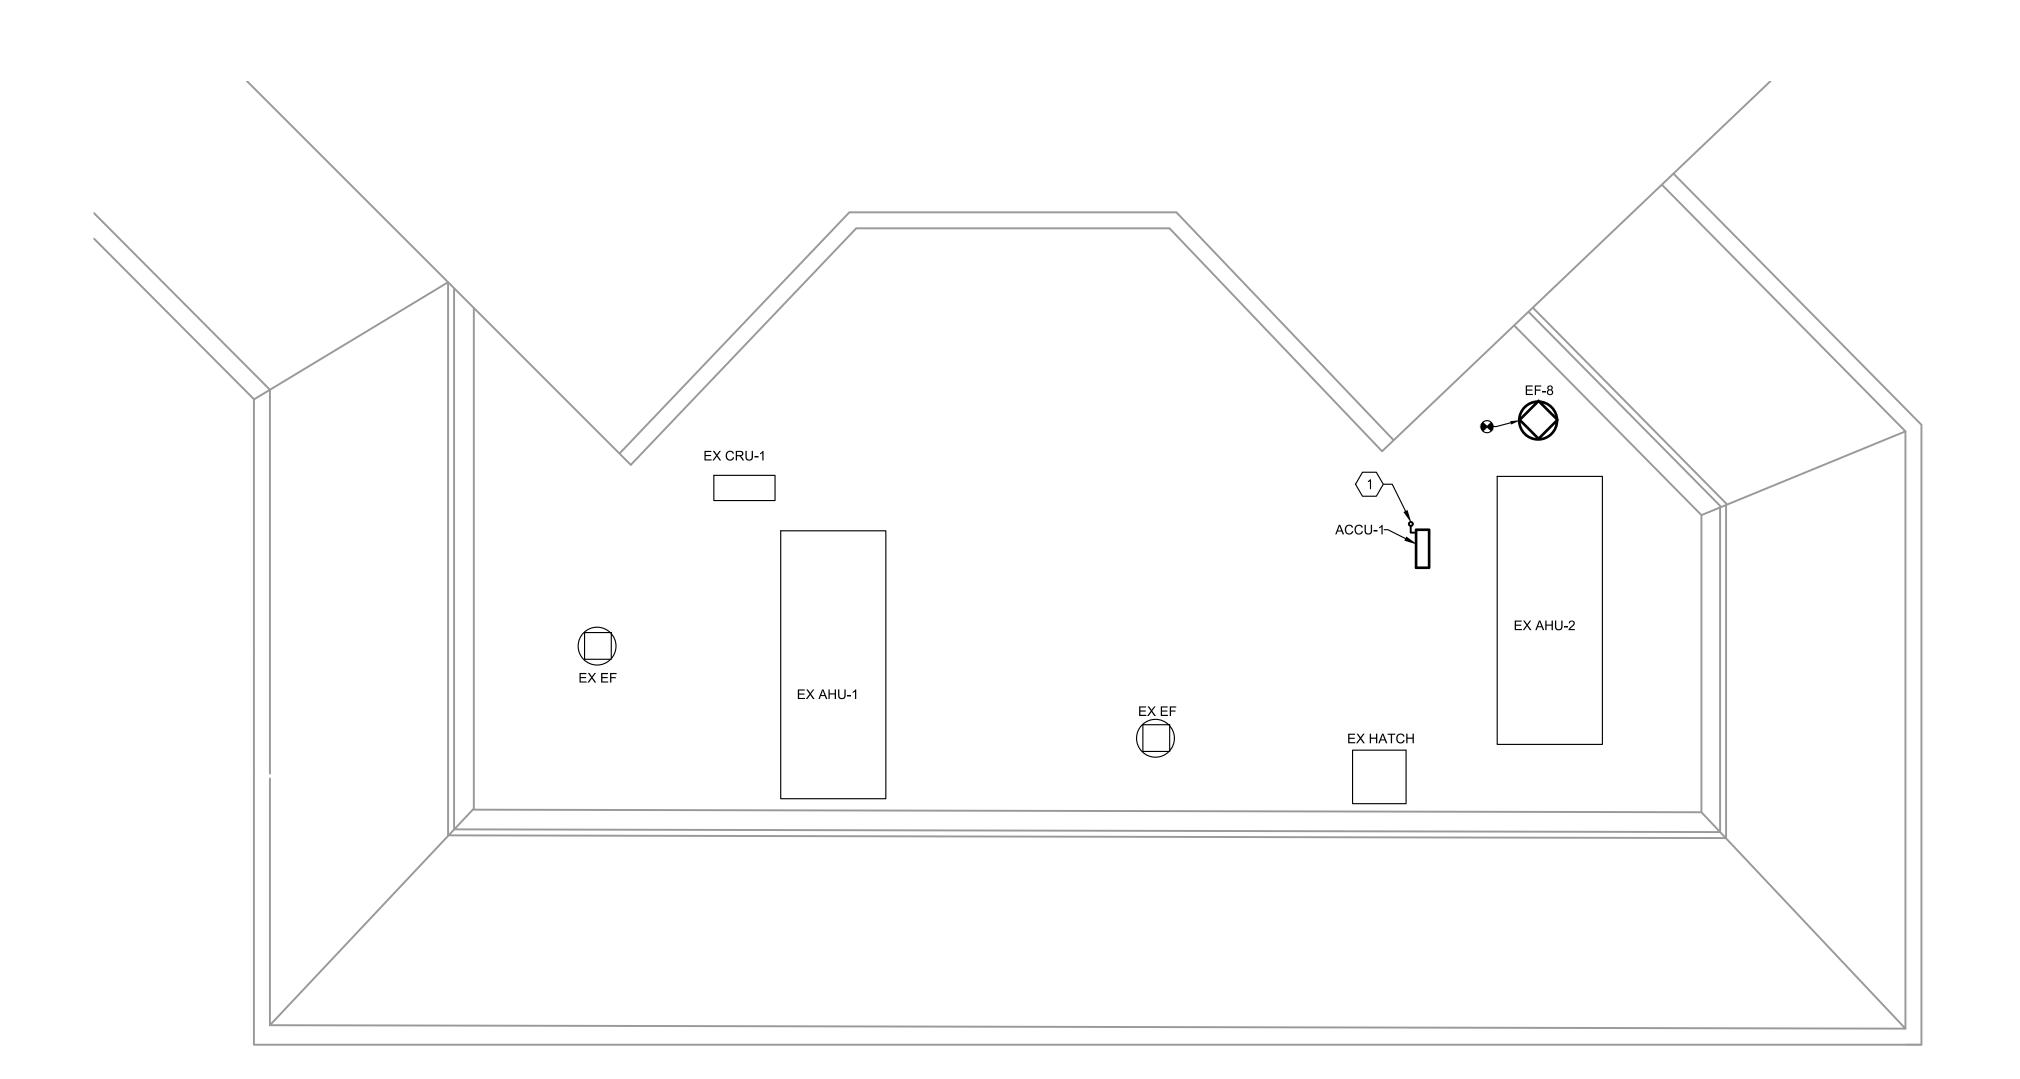

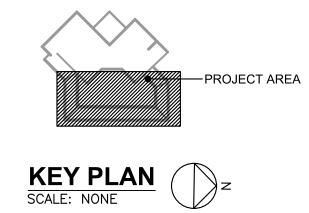

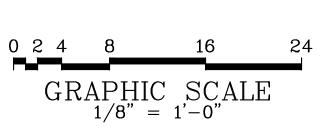

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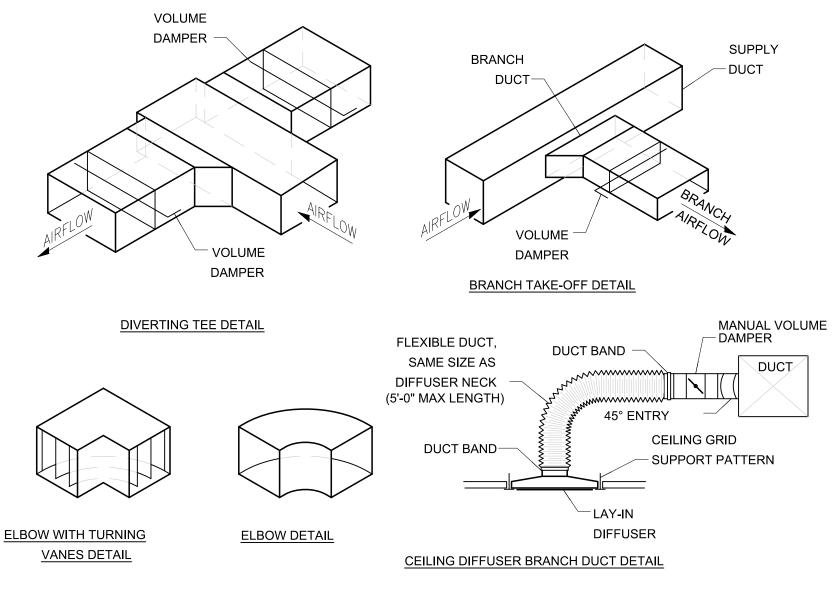
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CONTRACT NO. CMLF—C19—06
TERMINAL POLICE AND ADMINISTRATION
BUILDING — DISPATCH CENTER REHAB


OOF HVAC PLAN	
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M-111

DATE: MAY 2022 SCALE: AS NOTED SHEET NO. 13




1) TYPICAL DUCT DETAILS
NOT TO SCALE

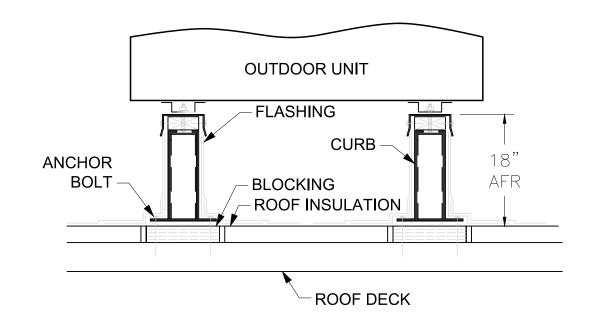

NOTES:

- ANCHOR SECURELY PER MANUFACTURERS INSTALLATION GUIDE.
 VERIFY SPACING WITH MANUFACTURERS INSTALLATION INSTRUCTIONS.
- VERIFY SPACING WITH MANUFACTURERS IN
 RE-FLASH AND PATCH ROOF WATER TIGHT.

 $4 \frac{\mathsf{ROOF} \ \mathsf{RAIL} \ \mathsf{DETAIL}}{\mathsf{NOTTO} \ \mathsf{SCALE}}$

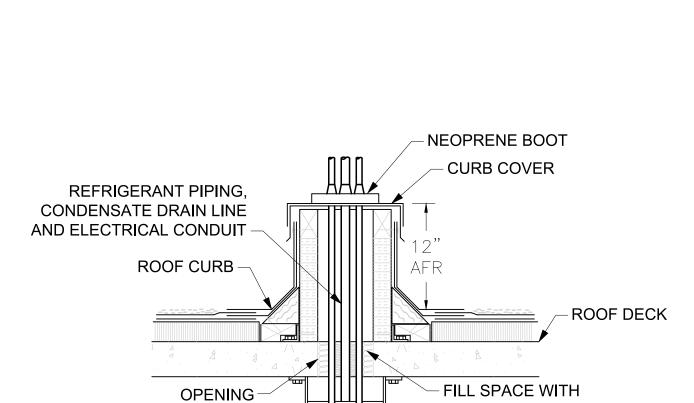

NOTES:

- 1. VERIFY PIPE AND CONDUIT SIZES AND QUANTITIES
- 2. PIPE INSULATION NOT SHOWN

CONDENSING

POWER WIRING FOR

CONTROL WIRING FOR OUTDOOR UNIT

BETWEEN UNITS.

ELECTRICAL/CONTROL WIRING.

DETAIL - SPLIT SYSTEM

NOT TO SCALE

INDOOR UNIT

CONDENSATE

DRAIN PIPING

LIQUID LINE

INDOOR UNIT

AS REQUIRED

CONDENSATE PUMP

GAS LINE

FLOOR DRAIN

2. PIPE SIZES AND CONFIGURATIONS SHALL BE PER MANUFACTURER'S

1/2" THICK. PROVIDE WITH JACKETING OUTSIDE OF BUILDING.

INCHES CLEARANCE TO EXISTING PIPING, EQUIPMENT, AND

SPECIFICATIONS AND RECOMMENDATIONS.

1. INSTALL COPPER TYPE 'ACR' REFRIGERANT PIPING AND ACCESSORIES AS

3. INSULATE BOTH REFRIGERANT LINES PER MFR RECOMMENDATIONS. MIN

4. ROUTE OUTDOOR CONTROL WIRING WITH, AND SECURE TO, GAS LINE

5. INSTALL REFRIGERANT PIPING PARALLEL OR PERPENDICULAR TO THE LINES OF THE BUILDING STRUCTURE ALLOWING A MINIMUM OF FOUR

INSULATION


PIPE HANGER

RECOMMENDED BY AND IN ACCORDANCE WITH MFR. AND RECOGNIZED

UNIT

3. CUT AND PATCH ROOF OPENING WEATHER TIGHT

5 ROOF-TOP PIPE CURB DETAIL

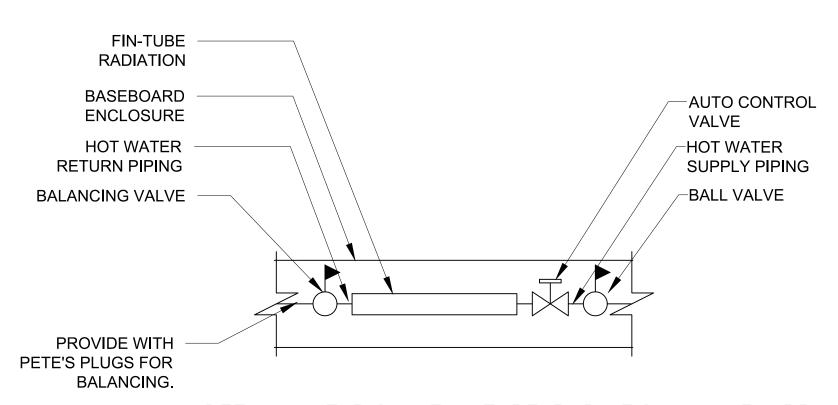

3 DETAIL - TYPICAL FIN-TUBE RADIATION VALVE ARRANGEMENT NOT TO SCALE





SHEET NO. 14

DELAWARE RIVER AND BAY AUTHORITY
CAPE MAY — LEWES FERRY

CONTRACT NO. CMLF—C19—06
TERMINAL POLICE AND ADMINISTRATION
BUILDING — DISPATCH CENTER REHAB

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HVAC DETAILS
M-501

SCALE: AS NOTED

DUCTLESS SPLIT SYSTEM INDOOR UNIT SCHEDULE									
		VING NOMINAL TONNAGE SUPPLY AIR OUTSIDE AIR TEMPERATURE DB (F) WB (F)		COOLING				MODEL	REMARKS
TAG	SERVING		EMPERATURE	COOLING	MANUFACTURER				
			City	DB (F)	WB (F)	CAPACITY (MBH)			
ACU-1	IT ROOM	2	635	95	75	24	MITSUBISHI	PKA	1, 2

- 1. PROVIDE WITH ELECTRICAL DISCONNECT AND WALL MOUNTED THERMOSTAT. PROVIDE WITH CONDENSATE PUMP. REFRIGERANT R-410A.
- 2. INDOOR UNIT IS POWERED FROM OUTDOOR UNIT.

	SPLIT SYSTEM OUTDOOR UNIT SCHEDULE											
TAC	AG SERVING COOLING OA TEMP		OA TEMP SEED SEED	ELECTRICAL				NAANUICACTUDED	MODEL			
TAG	SERVING	CAPACITY (MBH)	CAPACITY (MBH) DB (F) WB (F)	SEER	VOLTAGE	PHASE	MCA (A)	MOCP (A)	MANUFACTURER	MODEL		
ACCU-1	ACU-1	24	95	75	10.6	17	208	1	18	30	MITSUBISHI	PUY-A24NHA6

	EXISTING VAV BOX SCHEDULE									
TAC	CEDVING	AIRFLOW	HEATING	CAPACITY	NAANUIFACTURER	MODEL				
TAG	SERVING	(CFM)	МВН	GPM	MANUFACTURER	MODEL				
VAV-1	115 LOBBY & 155 LT OFFICE	650	-	-	TRANE	VCWF-08				
VAV-2	154 RADIO ROOM	500	-	-	TRANE	VCWF-08				
VAV-3	159 SQUAD ROOM	600	-	-	TRANE	VCWF-08				
VAV-4	161 WAREHOUSE	1200	-	-	TRANE	VCWF-12				
VAV-5	INTERROGATION/STORAGE	350	-	-	TRANE	VCWF-06				
VAV-6	163 SGTS OFFICE	450	-	-	TRANE	VCWF-08				
VAV-7	LUNCH ROOM	400	-	-	TRANE	VCWF-08				
VAV-8	MEN'S LOCKER ROOM	450	8.2	1	TRANE	VFWC-08				
VAV-9	WOMEN'S LOCKER ROOM	350	14	1.5	TRANE	VFWC-08				
VAV-11	203 PC TRAINING	650	-	-	TRANE	VCWF-08				
VAV-12	201 WORKROOM	1900	-	-	TRANE	VCWF-12				

- VAV BOXES ARE EXISTING TO REMAIN.
- 2. MIN AIR SUPPLY FOR BOXES SHALL BE 25% OR AS REQUIRED FOR MAKE-UP

	FIN-TUBE BASEBOARD RADIATION HEATER SCHEDULE									
TAG	SERVING	ROWS	AVERAGE TEMP (°F)	LENGTH (FT)	RECOVERY RATE (BTU/LF)	MANUFACTURER	MODEL	REMARKS		
FBR-1	155 LT OFFICE	1	170	12	775	TRANE	TA	1, 2		
FBR-2	159 SQUAD ROOM	1	170	13	775	TRANE	TA	1, 3		

- 1. COPPER ALUMINIUM 1-1/4", SERIES 60, FINS 2-1/2" x 5-1/4" x 0.015".
- 2. EXISTING TO REMAIN.
- 3. UNIT TO BE CONTROLLED IN A MANNER CONSISTENT WITH THE EXISTING WITH THE EXISTING UNIT TO BE REPLACED.

ZE MANUFACTURER MODEL
12" TITUS 350FL
"x

AIR DEVICE SCHEDULE - SUPPLY DIFFUSER								
TAG	TAG AIRFLOW TYPE SIZE MANUFACTURER MODEL							
CD-1	25 CFM	LAY-IN	12"x12"	TITUS	TMS			
	_							

ELECTRIC BASEBOARD HEATER SCHEDULE								
TAG SERVING	LENGTH	ELECTRICAL			MANUFACTURER	MODEL		
	SERVING	LENGTH	KW	VOLTAGE	PHASE	WANUFACTURER	INIODEL	REMARKS
EBH-1	164 CLOSET	5'-0"	1.25	120	1	BERKO	ASL3	1

NOTES 1. PROVIDE WITH WALL THERMOSTAT.

	EXHAUST FAN SCHEDULE									
	AIRFLOW				ELECTRICAL					
TAG	(CFM)	TYPE	ESP	HP	VOLTAGE	PHASE	MANUFACTURER	MODEL	REMARKS	
EF-8	2875	UPBLAST CENTRIFUGAL	0.75	1.5	480	3	GREENHECK	CUE-200HP	1	

1. PROVIDE WITH ELECTRICAL DISCONNECT SWITCH, VARI-GREEN DRIVE, BACKDRAFT DAMPER. VERIFY THAT NEW EF IS COMPATIBLE WITH EXISTING ROOF CURB. REPLACE CURB AS REQUIRED.



DELAWARE RIVER AND BAY AUTHORITY CAPE MAY - LEWES FERRY

CONTRACT NO. CMLF-C19-06 TERMINAL POLICE AND ADMINISTRATION BUILDING - DISPATCH CENTER REHAB

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HVAC	SCHEDULE	S
		M-

GENERAL NOTES (APPLY TO WORK PROVIDED UNDER DIV. 20):

- 1. GENERAL: FURNISH LABOR, EQUIPMENT AND MATERIALS NECESSARY FOR THE INSTALLATION OF THE COMPLETE PLUMBING SYSTEMS AS SPECIFIED HEREIN AND INDICATED IN THE CONTRACT DOCUMENTS. OUTLINE DESCRIPTION AND DIAGRAMMATIC REPRESENTATION OF SYSTEM OPERATION AND EQUIPMENT DOES NOT LIMIT CONTRACTOR LIABILITY FOR FURNISHING AND INSTALLING COMPLETE AND OPERABLE SYSTEMS.
- 2. APPLICABLE CODES: THE INSTALLATION SHALL COMPLY WITH THE LATEST EDITION OF THE CODE OF THE LOCAL AUTHORITY HAVING JURISDICTION.
- 3. NOTE DEFINITIONS: "DRAWING NOTES" APPLY TO THE ENTIRE DRAWING ON WHICH THEY APPEAR, WHERE RELEVANT. SPECIFIC NOTES" APPLY ONLY WHERE INDICATED WITH THE "SPECIFIC NOTE" SYMBOL. REFER TO LEGEND.
- 4. PROVIDE REQUIRED CLEARANCE FOR MAINTENANCE IN ACCORDANCE WITH MANUFACTURERS RECOMMENDATIONS OR AS REQUIRED BY CODE FOR MECHANICAL AND PLUMBING EQUIPMENT.
- 5. VERIFY THAT EXISTING EQUIPMENT THAT IS TO REMAIN IS FULLY FUNCTIONAL AND OPERATIONAL.
- 6. PERMITS: INCLUDE IN THE BID PRICE THE PAYMENT OF NECESSARY PERMITS. FURNISH THE OWNER PRIOR TO THE FINAL PAYMENT A CERTIFICATE FROM THE INSPECTION DEPARTMENT HAVING JURISDICTION CERTIFYING THAT THE WORK MEETS THE REQUIREMENTS OF THE LOCAL INSPECTION AUTHORITIES AND/OR THE NATIONAL BOARD OF FIRE UNDERWRITERS.
- 7. <u>SCHEDULING:</u> COORDINATE WITH THE OWNER FOR SCHEDULING OF WORK.
- 8. WORK SHALL BE INSTALLED IN A NEAT AND WORKMANLIKE MANNER.
- 9. KEEP THE WORK SITE AND SURROUNDING AREA FREE FROM ACCUMULATION OF WASTE MATERIALS OR RUBBISH GENERATED BY WORK FROM THIS CONTRACT. PROPERLY AND LEGALLY DISPOSE OF MATERIALS.
- 10. SAFETY: JOB SITE SAFETY SHALL BE IN STRICT ACCORDANCE WITH LOCAL, STATE, AND FEDERAL REQUIREMENTS.
- 11. VISIT THE SITE AND CAREFULLY EXAMINE EXISTING CONDITIONS THAT MAY AFFECT THE BID.
- 12. EXISTING PLUMBING INSTALLATION: EXISTING PLUMBING WORK WHICH WILL NOT BE RENDERED OBSOLETE AND WHICH MAY BE DISTURBED DUE TO ANY CHANGES REQUIRED UNDER THIS CONTRACT SHALL BE RESTORED TO ITS ORIGINAL OPERATING CONDITION. OTHER PLUMBING ITEMS OR PLUMBING FIXTURES RENDERED OBSOLETE SHALL BE ABANDONED WHERE CONCEALED AND REMOVED WHERE EXPOSED.
- 13. WHERE EXISTING PLUMBING WORK INTERFERES WITH NEW WORK AND WHERE SUCH INSTALLATIONS ARE TO REMAIN IN USE, THE INSTALLATIONS SHALL BE DISCONNECTED AND RELOCATED AND/OR RECONNECTED TO COORDINATE WITH NEW WORK AS INDICATED IN THE CONTRACT DOCUMENTS AND AS SPECIFIED.
- 14. DO NOT DISCONTINUE ANY PLUMBING SYSTEM SERVICE WITHOUT FIRST OBTAINING WRITTEN APPROVAL FROM THE USER AGENCY. THE PLUMBING SYSTEM OUTAGES SHALL BE KEPT TO A MINIMUM.
- 15. PROVIDE SUBMITTALS (SHOP DRAWINGS) FOR REVIEW FOR NEW MATERIALS AND EQUIPMENT. PRIOR TO SUBMITTING, REVIEW SUBMITTALS FOR COMPLIANCE WITH THE CONTRACT DOCUMENTS, CONFLICTS WITH OTHER TRADES, AND CONSTRUCTABILITY. IDENTIFY ANY DEVIATIONS IN SUBMITTALS FROM CONTRACT DOCUMENTS. ENGINEER'S REVIEW OF SUBMITTALS DOES NOT INCLUDE REVIEW OF DIMENSIONS, DETAILS, OR QUANTITIES. REVIEW DOES NOT WAIVE ANY REQUIREMENTS OF CONTRACT DOCUMENTS, INCLUDING REQUIREMENT TO PROVIDE A COMPLETE AND FUNCTIONAL SYSTEM.
- 16. WHEN MOUNTING PLUMBING WORK IN AREAS SUBJECT TO PEDESTRIAN TRAFFIC, MAINTAIN REQUIRED HEADROOM CLEARANCES.
- 17. PLUMBING MATERIALS AND EQUIPMENT SHALL BE INSTALLED AS TO MAINTAIN THEIR RESPECTIVE UL RATING AND SHALL CONFORM TO FACTORY MUTUAL STANDARDS AS APPLICABLE.
- 18. PLUMBING WORK SHALL BE CONCEALED IN FINISHED AREAS SHOWN ON THE ARCHITECTURAL DRAWINGS UNLESS NOTED OTHERWISE.
- 19. EQUIPMENT LOCATIONS: REFER TO THE ARCHITECTURAL DRAWINGS FOR EXACT FIXTURE LOCATIONS AND THE ELECTRICAL DRAWINGS FOR EXACT ELECTRICAL EQUIPMENT LOCATIONS, LOCATIONS PLUMBING EQUIPMENT AND PIPING ARE SHOWN DIAGRAMMATICALLY. DETERMINE EXACT LOCATIONS IN THE FIELD.
- 20. SEALING FITTINGS AND APPROVED SEALING COMPOUND SHALL BE INSTALLED IN ACCORDANCE WITH THE APPLICABLE CODE. SEAL AROUND PENETRATIONS OF FIRE-RATED WALLS WITH AN APPROVED SEALANT.
- 21. SANITARY AND DRAINAGE PIPING SHALL RUN AT 2% SLOPE MINIMUM, UNLESS NOTED OTHERWISE.
- 22. LOCATIONS OF DRAINS AND CONNECTIONS TO FIXTURES AND EQUIPMENT SHALL BE COORDINATED WITH FLOOR PLANS, EQUIPMENT CUTS AND MECHANCIAL/ELECTRICAL/STRUCTURAL PLANS. NO WORK SHALL BE INSTALLED UNTIL LOCATIONS HAVE BEEN VERIFIED.
- 23. PLUMBING FIXTURES SHALL BE CAULKED TO THE ADJOINING FLOOR OR WALL SURFACE.
- 24. PROVIDE CLEANOUTS IN SANITARY AND DRAIN LINES EVERY 50 FEET UNLESS INDICATED AT CLOSER INTERVALS ON THE DRAWINGS AND AT CHANGES OF DIRECTION.
- 25. THE PLUMBING FIXTURE SCHEDULE AND SPECIFICATIONS SUPERCEDE THE SYMBOLS INDICATED ON THE FLOOR
- 26. PIPE DROPS IN EXTERIOR WALLS SHALL BE INBOARD OF INSULATION.

GENERAL DEMOLITION NOTES (APPLY TO WORK PROVIDED UNDER DIVISION 20):

- 1. DEMOLITION WORK IS GENERALLY INDICATED AS PART OF THESE NOTES AND THE NOTES INDICATED ON THE ARCHITECTURAL DEMOLITION PLANS.
- 2. VERIFY THAT EXISTING PIPING, EQUIPMENT, ETC. THAT IS CALLED FOR REMOVAL IS NO LONGER IN SERVICE BEFORE BEGINNING DEMOLITION.
- 3. THE DEMOLITION NOTES INDICATE THE MAIN COMPONENTS OF SYSTEMS AND EQUIPMENT THAT SHALL BE REMOVED UNDER THIS CONTRACT. IF SYSTEMS AND EQUIPMENT ARE FOUND DURING CONSTRUCTION THAT THE OWNER AUTHORIZES FOR REMOVAL BUT HAVE NOT BEEN SPECIFICALLY CALLED FOR DEMOLITION, REMOVE THE SYSTEMS
- 4. WHEN THE WORK SPECIFIED HEREUNDER CONNECTS TO ANY EXISTING EQUIPMENT, PIPING, ETC., PERFORM NECESSARY ALTERATIONS, CUTTING, FITTING, ETC. OF THE EXISTING WORK AS MAY BE NECESSARY OR REQUIRED TO MAKE SATISFACTORY CONNECTIONS BETWEEN THE NEW AND EXISTING WORK AND LEAVE THE COMPLETE WORK IN A FINISHED AND WORKMANLIKE CONDITION.
- 5. WHEN THE WORK SPECIFIED UNDER OTHER DIVISIONS NECESSITATES RELOCATION OF EXISTING EQUIPMENT, PIPING, ETC. PERFORM WORK AND MAKE NECESSARY CHANGES TO EXISTING WORK AS MAY BE REQUIRED TO LEAVE THE COMPLETED WORK IN A FINISHED AND WORKMANLIKE CONDITION.
- 6. REMOVE FROM THE PREMISES AND DISPOSE OF EXISTING PIPING, MATERIAL, FIXTURES, EQUIPMENT, ETC. NOT REQUIRED FOR RE- USE OR RE-INSTALLATION.
- 7. DELIVER ON THE PREMISES WHERE DIRECTED EXISTING MATERIAL AND EQUIPMENT WHICH IS REMOVED AND IS DESIRED BY THE OWNER OR IS INDICATED TO REMAIN THE PROPERTY OF THE OWNER.
- 8. OTHER MATERIALS AND EQUIPMENT WHICH ARE REMOVED SHALL BECOME THE PROPERTY OF THE CONTRACTOR AND SHALL BE REMOVED FROM THE PREMISES.
- 9. PIPING ABANDONED IN CONCRETE SLABS, WALLS, OR OTHER INACCESSIBLE LOCATIONS SHALL BE LEFT EMPTY.

GENERAL NOTES: FIRE PROTECTION (APPLY TO WORK PROVIDED UNDER DIVISION 20):

- 1. EXISTING SPRINKLER SYSTEM SERVING THE RENOVATED SPACE IS TO REMAIN AND SHALL BE MODIFIED AND EXTENDED AS REQUIRED BY A CERTIFIED SPRINKLER CONTRACTOR TO SUIT NEW CONSTRUCTION.
- 2. REROUTE EXISTING SPRINKLER PIPING AS REQUIRED TO AVOID ROUTING THRU OR ABOVE ELECTRICAL EQUIPMENT ROOMS. ELECTRIC ROOMS SHALL ONLY CONTAIN PIPING THAT SERVES THAT ROOM.
- 3. THE EXISTING SPRINKLER SYSTEM AND SPRINKLER HEADS SHALL BE UPGRADED AS REQUIRED TO MEET ALL CURRENT NFPA 13, NFPA 25 AND ALL APPLICABLE LOCAL FIRE CODES, REGULATIONS AND WITH THE APPROVAL OF THE LOCAL FIRE MARSHAL AND/OR THE AUTHORITY HAVING JURISDICTION.
- 4. EXISTING SPRINKLER PIPING TO REMAIN IS TO BE THOROUGHLY FLUSHED AND TESTED FOR LEAKAGE AND DEFECTS IN WORK AND MATERIALS. A CERTIFIED SPRINKLER ENGINEER SHALL PROVIDE SPRINKLER SHOP DRAWINGS AND HYDRAULIC CALCULATION FOR A LIGHT HAZARD SPRINKLER CLASSIFICATION.
- 5. COORDINATE SPRINKLER HEADS WITH NEW CEILING LAYOUT AND ALL OTHER TRADES. PROVIDE TAMPER/SUPERVISORY SWITCHES AS REQUIRED PER NFPA. SPRINKLER HEADS ARE TO BE PENDANT TYPE TO MATCH
- 6. IN RENOVATED AREAS SUBJECT TO FREEZING, DRY SIDEWALL HEADS SHALL BE USED FROM THE WET SYSTEM SERVING SUCH AREAS.


PLUMBING FIXTURE SCHEDULE										
TAG	DESCRIPTION	CW SIZE	HW SIZE	SAN SIZE	VENT SIZE	NOTES				
P-1	WATER CLOSET	1/2"	-	4"	2"					
P-2	LAVATORY	1/2"	1/2"	2"	2"					

YMBOL	_	ABBREV	DESCRIPTION OANUTARY PURE	
		SP,SAN SW	SANITARY PIPE STORM WATER	
— — SW -		D	DRAIN	
— — — D - — — FDR		FDR	FOUNDATION DRAIN	
		СО	CLEANOUT	
. — — — — — -		VP	VENT PIPE	
		CW	COLD WATER	
	· 	HW	HOT WATER	
		HWC	HOT WATER CIRCULATING	
т -		Т	TEMPERED WATER	
G -		G	GAS	
F		F	FIRE LINE	
N N			FLOW METER FITTING	
			REDUCED PRESSURE ZONE	
Y			BACKFLOW PREVENTER	
		TP	TRAP PRIMER	
	٦		RELIEF VALVE	SYMBOL
		MAV	MANUAL AIR VALVE	
<u>аа</u> v <u> </u>		AAV	AUTOMATIC AIR VALVE	
+	唉		STRAINER W/VALVE	
			UNION	
Ps/	4	SA	SHOCK ABSORBER	
厚			FLOW SWITCH	
Ψ			THERMOMETER/THERMOSTAT	
			THERMOMETER WELL	
(P)	<i>></i>		PRESSURE GAUGE W/ SYPHON & NEEDLE VALVE	
⊕			PRESSURE GAUGE W/NEEDLE VALVE	
	·	PG	PRESSURE GAUGE TAPPING	
			PIPE GUIDE	
			ANCHOR	
łw	W l		FLEXIBLE PIPE CONNECTION	
<u></u>	<u> </u>	OS&Y	OS&Y VALVE W/ TAMPER SWITCH	
			SHUTOFF VALVE	
————————————————————————————————————			CHECK VALVE	
w &	BWY	BWV	BACK WATER VALVE	
—————		PRV	PRESSURE REDUCING VALVE	
			PIPE TURNING UP	
o	7		PIPE TURNING UP PIPE TURNING DOWN	
-	A		I II E TOTANINO DOVIN	
	Jb.		TEE TURNING UP	
			TEE TURNING DOWN	
J —	\ \f	\ \ /LI		
ı	WH	WH	WALL HYDRANT	
WH			GAS PRESSURE REGULATOR	
WH				
'	•	AD	AREA DRAIN	
	•	AD FD	AREA DRAIN FLOOR DRAIN	
®———				
R o AD ⊘FD		FD	FLOOR DRAIN	
®——— o AD ØFD ØFDP		FD FDP	FLOOR DRAIN FLOOR DRAIN WITH TRAP PRIMER ROOF DRAIN FLOOR SINK	
® AD		FD FDP RD	FLOOR DRAIN FLOOR DRAIN WITH TRAP PRIMER ROOF DRAIN	
® AD		FD FDP RD	FLOOR DRAIN FLOOR DRAIN WITH TRAP PRIMER ROOF DRAIN FLOOR SINK	

REVISION

DESCRIPTION

DATE

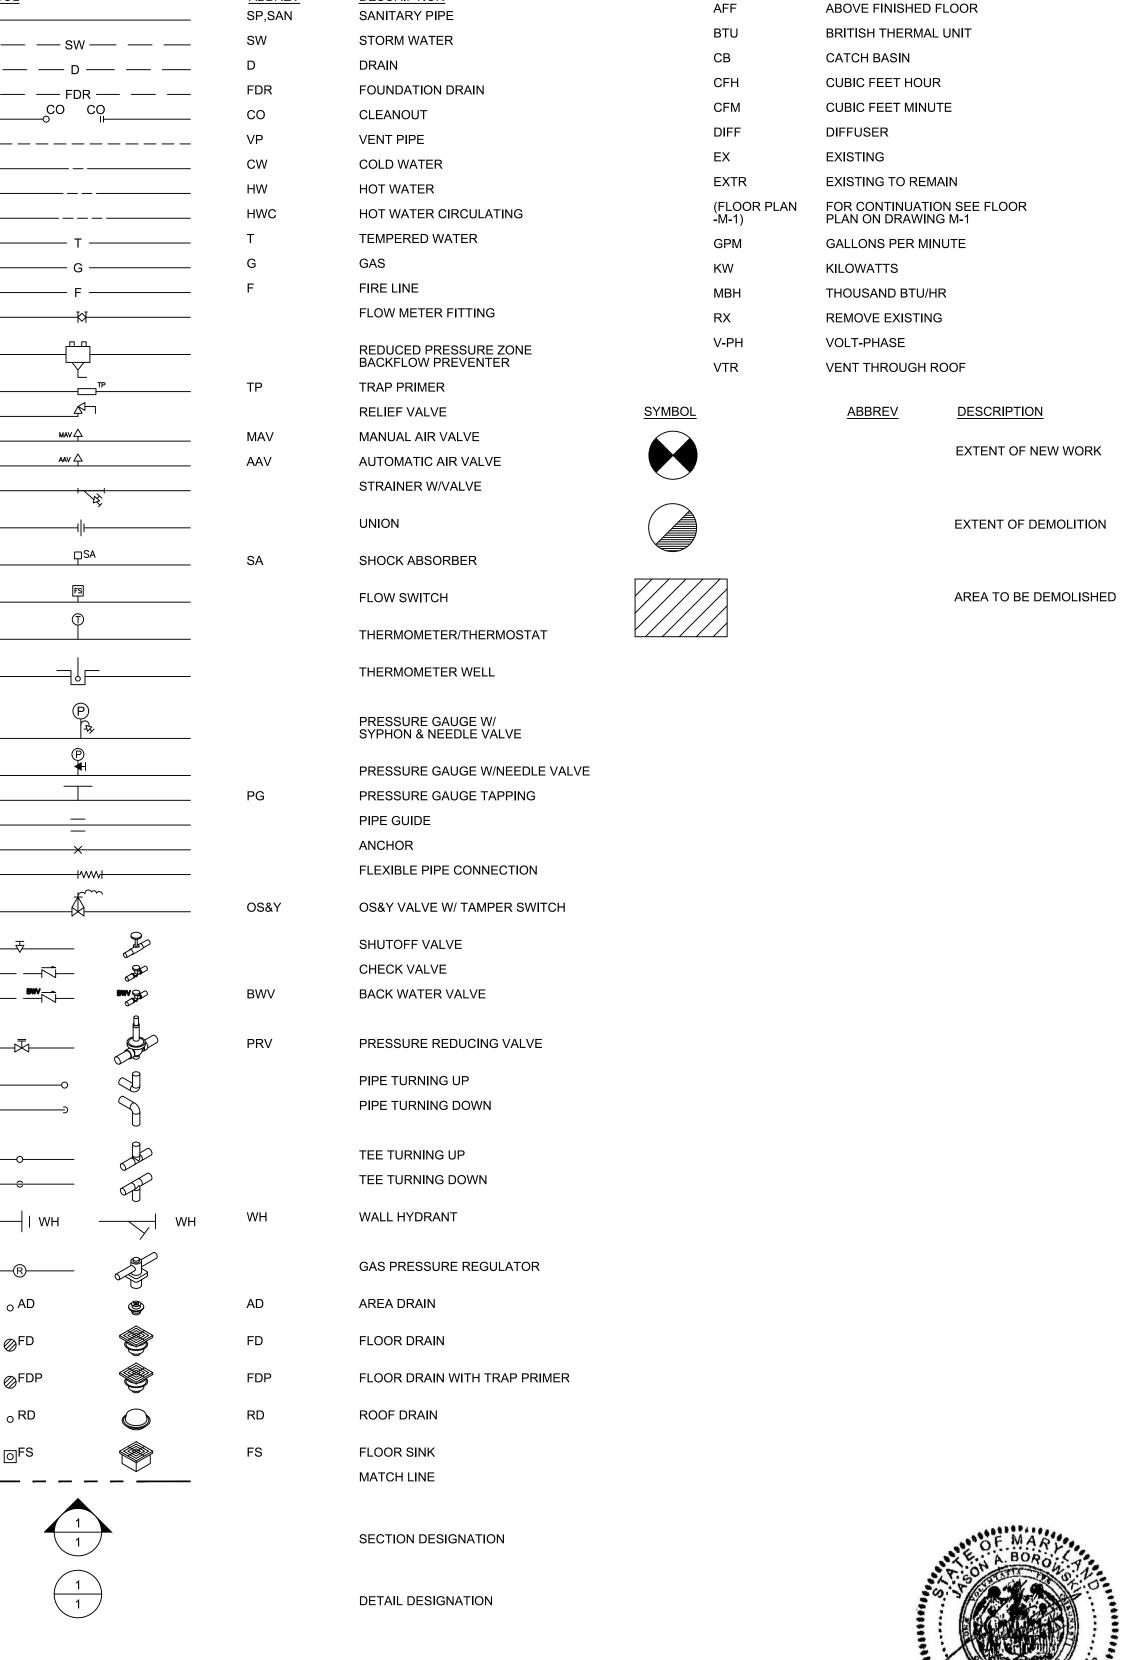

AFF



DELAWARE RIVER AND BAY AUTHORITY CAPE MAY - LEWES FERRY

CONTRACT NO. CMLF-C19-06 TERMINAL POLICE AND ADMINISTRATION BUILDING - DISPATCH CENTER REHAB

GENERAL	NOTES
SYMBOLS	AND
ABBREVI <i>A</i>	ATIONS

P - 000

SCALE: AS NOTED


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CENTURY

ENGINEERING
PLANNE

PLAZA 273, 56 W. MAIN STREET.



SPECIFIC NOTES: (APPLY TO THIS DRAWING WHERE INDICATED):

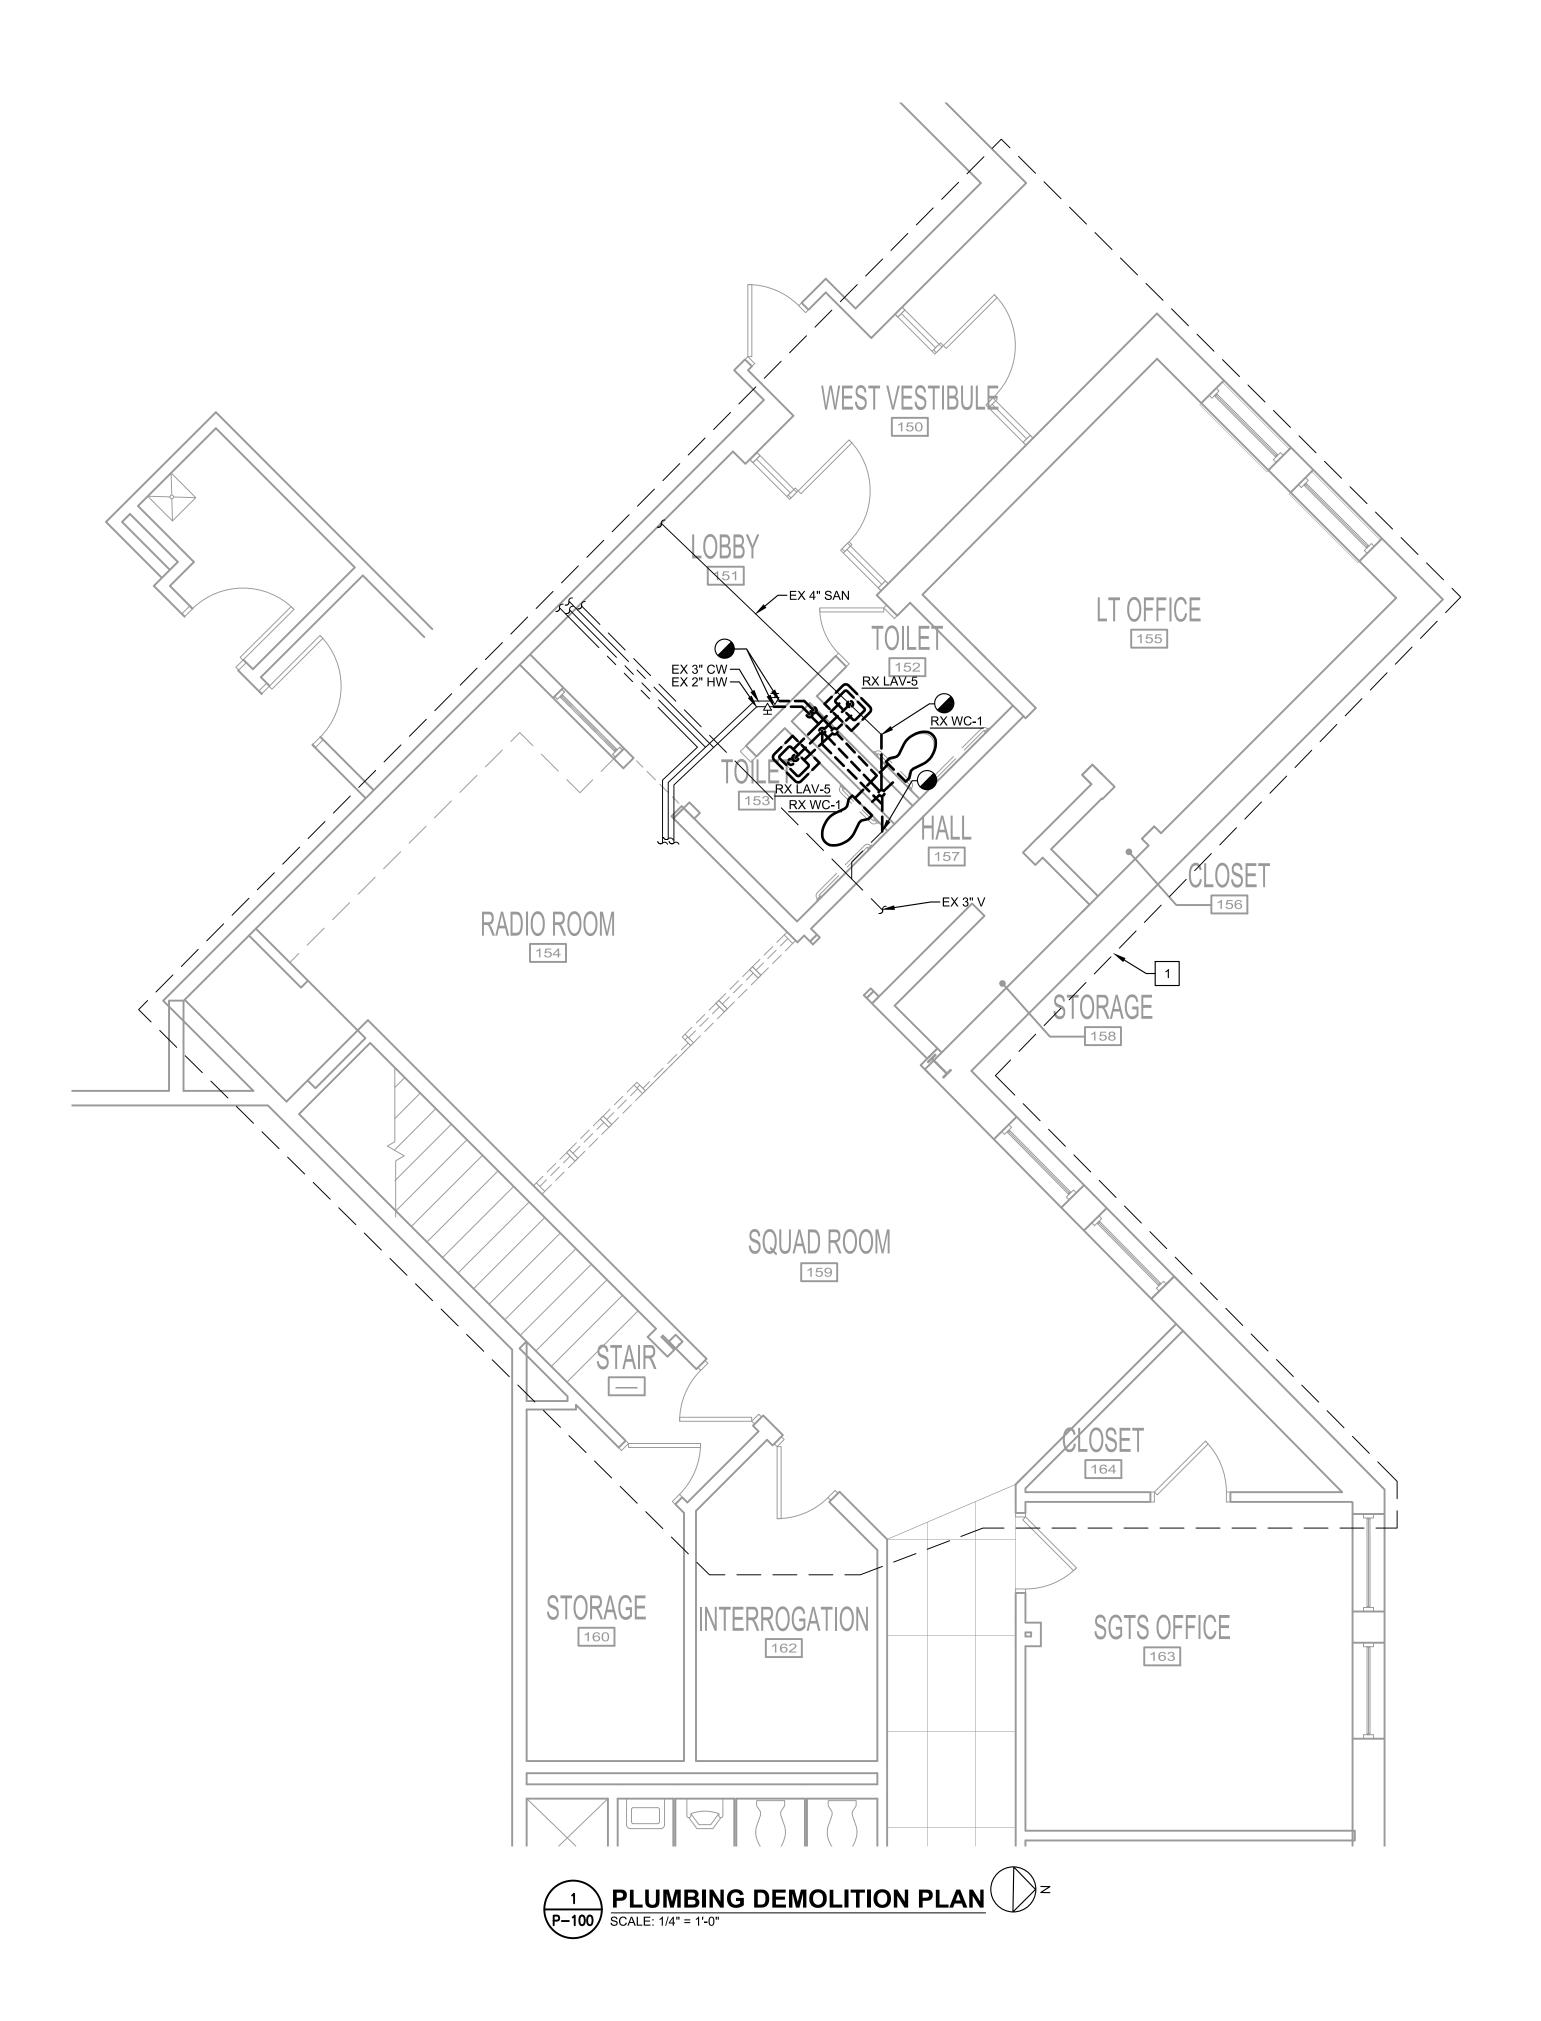SEE GENERAL SPRINKLER NOTES FOR SCOPE OF SPRINKLER WORK IN THIS AREA.

DEMOLITION WORK SHALL BE DONE IN PHASES.
COORDINATE ALL WORK WITH NEW
INSTALLATIONS.







DELAWARE RIVER AND BAY AUTHORITY CAPE MAY - LEWES FERRY


CONTRACT NO. CMLF-C19-06 TERMINAL POLICE AND ADMINISTRATION BUILDING - DISPATCH CENTER REHAB

PLUMBING	DEMOLITION							
PLAN								

P-100 SCALE: AS NOTED SHEET NO. 17 DATE: MAY 2022

GRAPHIC SCALE 1/4" = 1'-0"

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SEE GENERAL SPRINKLER NOTES FOR SCOPE OF SPRINKLER WORK IN THIS AREA.

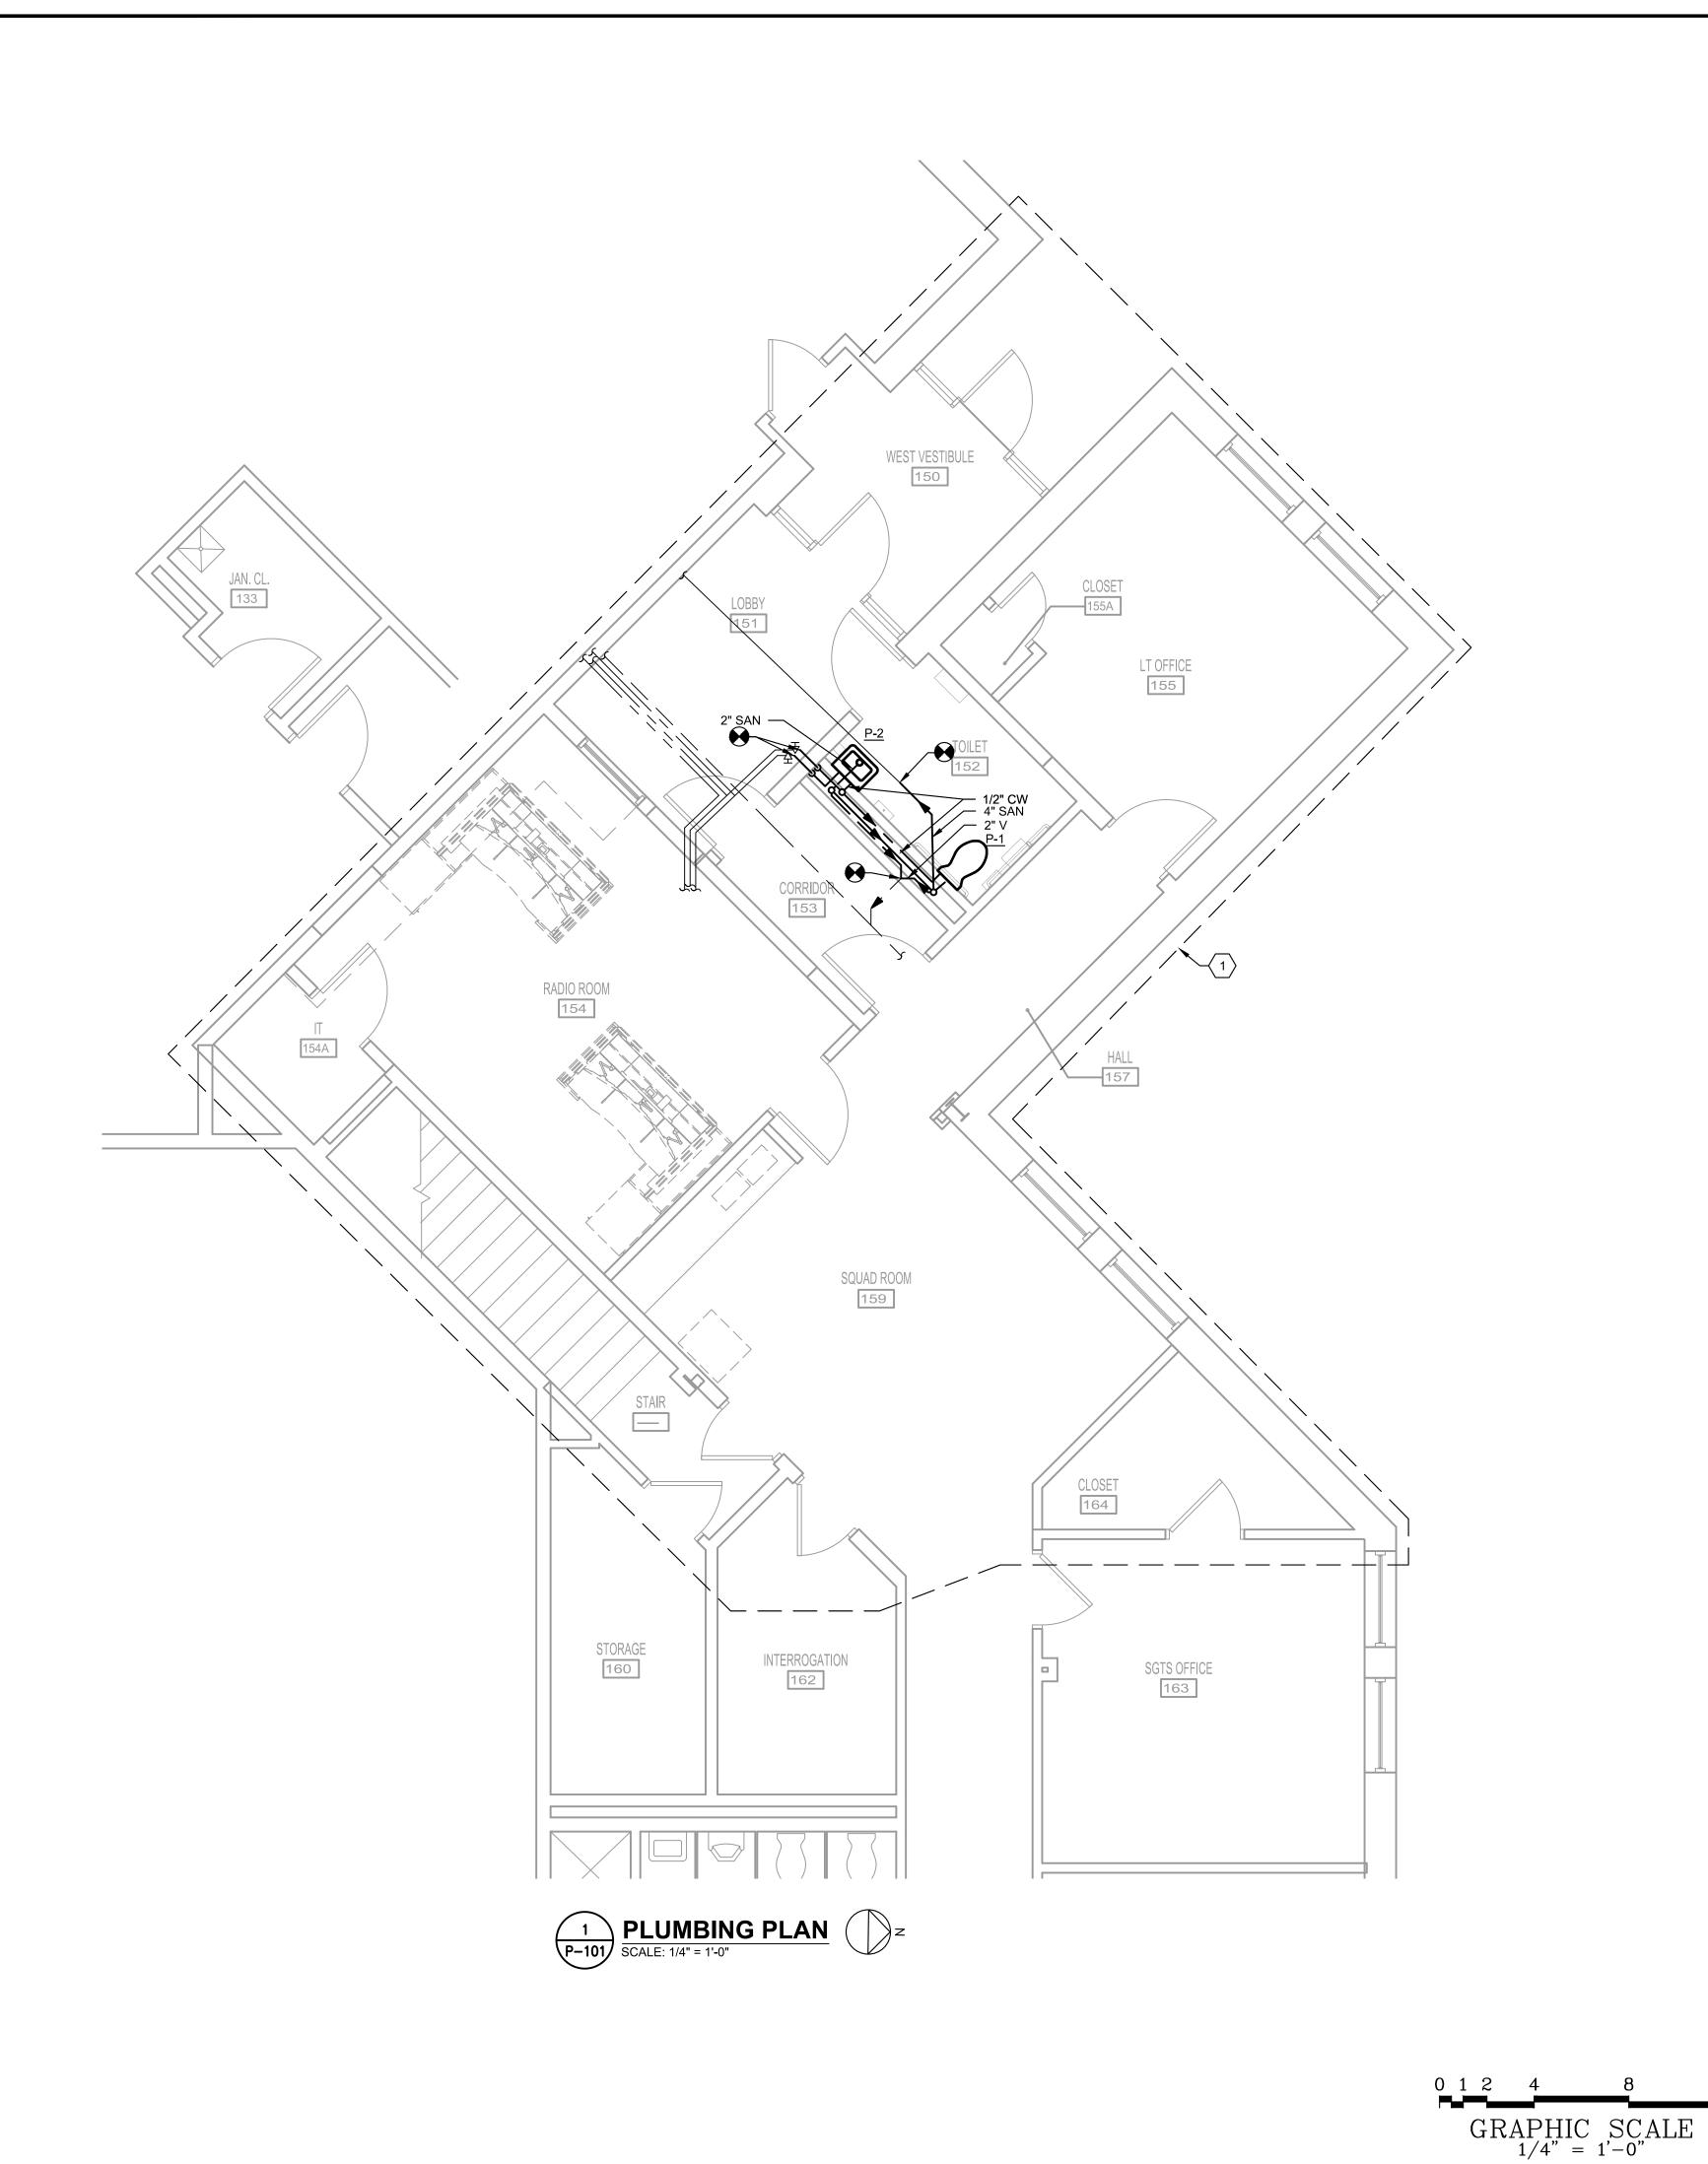



DELAWARE RIVER AND BAY AUTHORITY CAPE MAY - LEWES FERRY

CONTRACT NO. CMLF-C19-06 TERMINAL POLICE AND ADMINISTRATION BUILDING - DISPATCH CENTER REHAB

SCALE: AS NOTED

		REVISION	THE CENTURY	
).	DATE	DESCRIPTION	BY	ENGINEERING
				CONSULTING ENGINEERS - PLANNERS
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$\overline{\overline{\mathbf{G}}}$	PLUMBING	PLAN
Մ		

P-101

SHEET NO. 18

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GENERAL DEMOLITION NOTES

- A. THE CONTRACTOR SHALL FIELD VERIFY THE EXISTING ELECTRICAL WORK SHOWN ON THESE DRAWINGS.
- B. THE EXTENT OF ELECTRICAL DEMOLITION SHALL BE AS NOTED ON THE DRAWINGS. SHOULD THERE BE ANY QUESTION AS TO THE DISPOSITION OF ANY EXISTING ELECTRICAL WORK, IT SHALL BE BROUGHT TO THE ATTENTION OF THE OWNER. THE FINAL DISPOSITION OF SUCH WORK SHALL BE AS DIRECTED BY THE
- C. WHEREVER EXISTING ELECTRICAL WORK IS INDICATED TO BE REMOVED, THE FOLLOWING NOTES SHALL
- 1. WIRING SHALL BE REMOVED AS NOTED ON DRAWINGS.
- 2. SURFACES WHICH ARE DISTURBED BY DEMOLITION UNDER THIS WORK SHALL BE PATCHED WITH MATERIALS TO MATCH THE EXISTING SURFACE. PATCHING SHALL MATCH THE EXISTING SURROUNDING SURFACES, AND SHALL BE DONE TO THE COMPLETE SATISFACTION OF THE OWNER.

GENERAL NOTES - ELECTRICAL WORK

- 1. DRAWINGS SHALL NOT BE SCALED.
- 2. THE ELECTRICAL CONTRACTOR SHALL COORDINATE HIS WORK WITH THAT OF OTHER TRADES. THE MECHANICAL AND OTHER DRAWINGS AND SPECIFICATIONS SHALL BE CONSULTED AND COORDINATED WITH PRIOR TO ROUGH-IN.
- 3. WHEREVER POSSIBLE. THE CONTRACTOR SHALL OBTAIN ACTUAL ROUGH-IN DRAWINGS FOR THE ACTUAL ITEM OF EQUIPMENT TO BE INSTALLED PRIOR TO ROUGH-IN. THIS SHALL APPLY TO EQUIPMENT, WHETHER IT IS TO BE INSTALLED BY THE CONTRACTOR OR BY THE OWNER.
- 4. IT IS THE INTENT OF THESE DRAWINGS THAT NEW ELECTRICAL WORK TO BE INSTALLED IN FINISHED AREAS. BE INSTALLED CONCEALED WITHIN NEW OR EXISTING WALLS, FLOORS OR CEILINGS. ANY AND CUTTING AND PATCHING OF SURFACES SHALL BE PROVIDED BY THE
- 5. WHERE CIRCUIT AND HOMERUN LINES ARE NOT SHOWN, PROVIDE MINIMUM 2#12+1#12 GROUND + PULL STRING IN 1" CONDUIT.
- 6. PROVIDE PULL STRINGS IN ALL CONDUITS.
- 7. WHERE NEW LOADS ARE ADDED AND EXISTING LOADS REMOVED, PROVIDE UPDATED PRINTED CIRCUIT DIRECTORIES FOR PANELBOARDS TO INDICATE TYPE OF LOAD SERVED AND AREA SERVED (E.G. RECEPTACLES-OFFICE 201).
- 8. UNLESS NOTED OTHERWISE, EVERY CONDUIT CONTAINING 120V OR GREATER WIRING SHALL CONTAIN A SEPARATE INSULATED GROUND WIRE RATED FOR 600V.
- 9. ELECTRICAL PENETRATIONS FOR BOXES, DEVICES, EQUIPMENT, WIRING AND RACEWAYS IN FIRE-RESISTANCE-RATED CONSTRUCTION SHALL COMPLY WITH REQUIREMENTS OF THE INTERNATIONAL BUILDING CODE, "PENETRATIONS" SECTION. PROVIDE FIRE SEALANT FOR PENETRATIONS THROUGH FIRE RATED FLOORS AND WALLS TO MAINTAIN THE APPLICABLE FIRE
- 10. PROVIDE STRUCTURAL STEEL FRAME SUPPORTS AS REQUIRED FOR DISCONNECT SWITCHES, MOTOR STARTERS, ETC.. (IF DISCONNECT SWITCHES OR STARTERS ARE LOCATED ON EQUIPMENT HOUSINGS, COORDINATE LOCATIONS WITH EQUIPMENT SUPPLIER TO ENSURE SWITCHES/STARTERS ARE NOT INSTALLED ON EQUIPMENT ACCESS PANELS). MAINTAIN PROPER NATIONAL ELECTRICAL CODE CLEARANCES. IN ADDITION, MAINTAIN PROPER MECHANICAL WORKING CLEARANCES FOR SERVICING OF EQUIPMENT.
- 11. UNLESS INDICATED OTHERWISE, PROVIDE FINAL CONNECTIONS TO EQUIPMENT.

ELECTRICAL ABBREVIATIONS (NOT ALL USED

4	AMPERE(S)	MS	MOTOR STARTER
ADA	AMERICAN DISABILITY ACT	NEC	NATIONAL ELECTRICAL CODE
١FF	ABOVE FINISHED FLOOR	NO	NORMALLY OPEN
AIC .	AMPERES INTERRUPTING CAPACITY	NTS	NOT TO SCALE
\WG	AMERICAN WIRE GAUGE	OC	ON CENTER
	CONDUIT	ОН	OVERHEAD
В	CIRCUIT BREAKER	ОТА	OVER THE AIR
CCT	CORRELATED COLOR TEMPERATURE	Ø	PHASE
CKT	CIRCUIT	P	POLE
CLG	CEILING	PNL	PANELBOARD
)WG	DRAWING	PRI	PRIMARY
X	EXISTING	RL	RELOCATE EXISTING
LA	FULL LOAD AMPERES	RLA	RUNNING LOAD AMPERES
3FI	GROUND FAULT CIRCUIT INTERRUPTER	RMS	ROOT MEAN SQUARE
G/GRD	GROUND	RX	REMOVE EXISTING
I P	HORSEPOWER	SHP	SECURITY HEADEND PANEL
łΖ	HERTZ	S/N	SOLID NEUTRAL
G	ISOLATED GROUND	SPD	SURGE PROTECTIVE DEVICE
sc	SHORT CIRCUIT INTERRUPTING CAPACITY	SWBD	SWITCHBOARD
RMS SY	MMETRICAL AMPERES)	SYM	SYMMETRICAL
ΙB	JUNCTION BOX	TBB	TELECOMMUNICATION BACKBOA
Ccmil	THOUSAND CIRCULAR MILLS	TELE	TELEPHONE
(V	KILOVOLTS	TYP	TYPICAL
(VA	KILO-VOLT-AMPERES	UNO	UNLESS NOTED OTHERWISE
(W	KILOWATTS	V	VOLTS
.TG	LIGHTING	VA	VOLT-AMPERE
.V	LOW VOLTAGE	W	WIRE, WATTS
ЛCA	MINIMUM CIRCUIT AMPACITY	WP	WEATHERPROOF
/ICB	MAIN CIRCUIT BREAKER	Υ	WYE CONNECTED
/ICP	MOTOR CIRCUIT PROTECTOR	1P	SINGLE POLE
ЛΗ	MOUNTING HEIGHT	2P	DOUBLE POLE
/ISC	MISCELLANEOUS	3P	THREE POLE
ЛLO	MAIN LUGS ONLY	4P	FOUR POLE
4000	AAAAAAAAAAAAAAAAAAAAAAAAAAAAAAAAAAAAAA		

FIRE ALARM SYSTEM LEGEND

MAXIMUM OVER-CURRENT PROTECTION DEVICE

HORN-STROBE COMBINATION STROBE

COMMUNICATIONS LEGEND

SMOKE DETECTOR

SINGLE GANG BOX, WALL MOUNT AT 18" A.F.F. UNLESS NOTED OTHERWISE. PROVIDE PULL STRING IN 1" CONDUIT TO ABOVE ACCESSIBLE CEILING.

PANEL NAME EXISTING CONDITION PD TYPE: GE TYPE A SERIES CIRCUIT BREAKER MOUNTIN MAIN BUS RATING: 125 AMP MAIN LUG ONLY				BREAKER MOUNTING S S RATING: 125 AMPS	LOCATION: SQUAD RM 159 SPACE: 42 VOLTAGE: 208Y/120V, 3-PHASE, 4-WIRE PANEL MOUNTING: RECESSED PANEL ENCLOSURE (NEMA): 1 PANEL MIN. A. I. C. RATING: 10K											
CIR. No.	DESCRIPTION	NOTE	CIR. BKR.	WIRE & CONDUIT	AØ	LOAD - VA BØ	cø	\prod	AØ	LOAD - VA	cø	WIRE & CONDUIT	CIR. BKR.	NOTE	DESCRIPTION	CIR. No.
1	LIGHT SQUAD RM		20/1	EXISTING		<u> </u>		1		<u> </u>		EXISTING	20/1		REC RADIO RM	2
3	LIGHT RADIO RM		20/1	EXISTING			1	1 1			1	EXISTING	20/1		REC RA DIO RM	4
5	LIGHT LOBBY		20/1	EXISTING				11				EXISTING	20/1		REC DOOR A LA RM	6
7	LIGHT LIEUTENA NT'S OFFICE		20/1	EXISTING		i		1		1		EXISTING	20/1		REC RA DIO RM	8
9	LIGHT ENTRANCE		20/1	EXISTING			1	1 1			1	EXISTING	20/1		REC RA DIO RM	10
11	LIGHT SERGEANT'S OFFICE		20/1	EXISTING				11				EXISTING	20/2		HAND DRYER WOMEN'S LOCKER	12
13	LIGHT BACK ENTRANCE		20/1	EXISTING		i		1		1		EXISTING	"		п	14
15	LIGHT CORRIDOR		20/1	EXISTING			1	1			1	EXISTING	20/2		HAND DRYER MEN'S LOCKER	16
17	LIGHT WOMEN'S LOCKER RM		20/1	EXISTING				1				EXISTING	"		"	18
19	REC STONE RM		20/1	EXISTING				1		1		EXISTING	20/1		MXL	20
21	LIGHT MEN'S LOCKER RM		20/1	EXISTING			1	1 1			1	EXISTING	20/1		POD	22
23	LIGHT INTERROGATION RM		20/1	EXISTING				11				EXISTING	20/1		UNIT HEATER REAR ENTRANCE	24
25	REC SQUAD RM		20/1	EXISTING		İ		1		1		EXISTING	20/1		SPARE WOMEN'S LOCKER CEILING	26
27	REC LOBBY		20/1	EXISTING			1	1			1	EXISTING	20/1		SPARE WAREHOUSE CEILING	28
29	REC INTERROGATION RM		20/1	EXISTING				1				EXISTING	20/1		SPARE COMMANDER'S CLOSET CEIL.	30
31	REC SERGEANT'S RM		20/1	EXISTING		i		1		1		EXISTING	20/1		SPARE FRONT ENTRANCE	32
33	REC MEN'S LOCKER RM		20/1	EXISTING			1	1			1		20/1		SPARE	34
35	REC WOMEN'S LOCKER RM		20/1	EXISTING				1					20/1		SPARE	36
37	REC RADIO SHELF		20/1	EXISTING		İ		1		1			20/1		SPARE	38
39	REC RADIO SHELF		20/1	EXISTING			1				1	EXISTING	20/2		CIRCUIT TO FRONT PD ENTRANCE	40
41	SPARE		20/1					11				EXISTING	"		n n	42
ONNE	CTED LOAD: 0.00 KVA	l			0	0	0			0 NEUTRAL E T GROUND E				1	'	
BØ								NOT				NING SHALL BEIN ACCO	RDANCEV	VITH TH	HE NEC.	
СØ	0.00 KVA								_ 	2 0.1011	_ ,	5				
طی OTAL			0.00 A		•											
MD	0.00 KVA		0.00 A													

GENERAL SYMBOLS

SPECIFIC DEMOLITION NOTE SPECIFIC NEW WORK NOTE

REVISION NUMBER TAG

NORTH ARROW

REVISION CLOUD

ELECTRICAL LEGEND



LIGHTING FIXTURE

EXIT SIGN, SINGLE OR DUAL FACE: CEILING MOUNTED; WALL MOUNT AT 7'-6" A.F.F. UNLESS NOTED OTHERWISE. PROVIDE WITH INTEGRAL HEADS. SHADING INDICATES NUMBER OF FACES.

SINGLE POLE SWITCH, MOUNT AT 46" A.F.F. U.N.O.

3-WAY SWITCH, MOUNT AT 46" A.F.F. U.N.O.

3-WAY KEYED SWITCH

DIMMER WITH 3-WAY SWITCH, MOUNT AT 46" A.F.F. U.N.O.

DIMMER, MOUNT AT 46" A.F.F. U.N.O.

COMBINATION TYPE WALL BOX OCCUPANCY/VACANCY SENSOR,

MOUNT AT 46" A.F.F. U.N.O. 125V-20A DUPLEX RECEPTACLE, NEMA CONFIGURATION 5-20R,

MOUNT AT 18" A.F.F. UNLESS NOTED OTHERWISE


125V-20A DUPLEX RECEPTACLE, NEMA CONFIGURATION 5-20R, MOUNT AT 9" ABOVE COUNTER UNLESS NOTED OTHERWISE

125V-20A QUAD RECEPTACLE, NEMA CONFIGURATION 5-20R, MOUNT AT 18" A.F.F. UNLESS NOTED OTHERWISE 125V-20A DUPLEX RECEPTACLE, NEMA CONFIGURATION 5-20R,

MOUNT AT 18" A.F.F. UNLESS NOTED OTHERWISE G = GROUND FAULT CIRCUIT INTERRUPTER

WP = WEATHERPROOF WHILE-IN-USE DIE-CAST ALUMINUM COVER

PANELBOARD

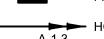

→ HOMERUN TO PANELBOARD:

JUNCTION BOX OR DEVICE BOX

ARROWS INDICATE QUANTITY OF CIRCUITS.

NOTATION INDICATES PANELBOARD AND CIRCUIT NUMBER TO WHICH CIRCUITS ARE TO BE EXTENDED.

SUGGESTED CONSTRUCTION SEQUENCE

CONSTRUCTION SHALL BE IN A PHASED APPROACH, IN ORDER TO MAINTAIN CONTINUITY OF DISPATCH CENTER IN OPERATION. THE TWO MAJOR CONSTRUCTION PHASES ARE RENOVATE THE NON-RADIO ROOM SPACES WHILE KEEPING EXISTING DISPATCH EQUIPMENT IN RADIO ROOM SERVICE AND RENOVATE THE RADIO ROOM. COORDINATE AND SCHEDULE OUTAGES WITH THE AUTHORITY. THE FOLLOWING IS A SUGGESTED SEQUENCE OF GENERAL CONSTRUCTION ACTIVITIES:

- 1. INSTALL NEW PANEL PD AND TRANSFER REMAINING CIRCUITS TO PANEL. MAINTAIN EXISTING PANEL PD IN SERVICE UNTIL CIRCUITS HAVE BEEN TRANSFERRED.
- 2. INSTALL LIGHTING IN NEW CLOSET 155A.
- 3. INSTALL RECEPTACLES AND BOXES IN SQUAD ROOM FOR TEMPORARY WORKSTATION AND WALL-MOUNTED DISPLAYS.
- REMOVE LIGHTING IN SPACE DESIGNATED AS NEW STORAGE 154A. INSTALL LIGHTING AND RECEPTACLE IN NEW STORAGE 154A. INSTALL NEW DISPATCH EQUIPMENT RACK (BY VENDOR).
- INSTALL TEMPORARY CABLING FROM DISPATCH EQUIPMENT RACK TO SQUAD ROOM (BY VENDOR).
- INSTALL DATA CABLING FROM EXISTING IT EQUIPMENT TO DISPATCH EQUIPMENT RACK AND TO TEMPORARY WORKSTATION (BY AUTHORITY IT DEPARTMENT).
- PERFORM TESTING AND CUTOVER TO TEMPORARY WORKSTATION AND WALL-MOUNTED
- PERFORM DEMOLITION WORK IN AREAS DESIGNATED AS PHASE 1, EXCEPT FOR NEW STORAGE 154A THAT DEMOLITION WORK WAS DONE IN PREVIOUS STEP ABOVE.
- PERFORM RENOVATION WORK IN AREAS DESIGNATED AS PHASE 1, EXCEPT FOR NEW STORAGE 154A THAT DEMOLITION WORK WAS DONE IN PREVIOUS STEP ABOVE.
- 10. PERFORM DEMOLITION WORK IN RADIO ROOM 154 THAT IS DESIGNATED AS PHASE 2.
- 11. PERFORM RENOVATION WORK IN RADIO ROOM 154 THAT IS DESIGNATED AS PHASE 2.
- 12. INSTALL RECEPTACLES AND BOXES IN RADIO ROOM 154 FOR BOTH WORKSTATIONS AND
- WALL-MOUNTED DISPLAY. 13. RELOCATE WORKSTATION AND DISPLAY FROM SQUAD ROOM TO RADIO ROOM 154 (BY VENDOR)
- 14. ASSIST VENDOR AND AUTHORITY FOR REMOVAL OF TEMPORARY CABLING AND SUPPORTS. REMOVE TEMPORARY RECEPTACLES AND BOXES.
- 15. INSTALL LOW-VOLTAGE CABLING FOR DISPATCH EQUIPMENT, WORKSTATIONS, AND
- WALL-MOUNTED DISPLAY (BY VENDOR AND AUTHORITY IT DEPARTMENT).
- 16. PERFORM WALL/CEILING REPAIRS AND CLEANUP.

	PANEL NAME NEW	LOCATION: HALL 157 PACE: 42 VOLTAGE: 208Y/120V, 3-PHASE, 4-WIRE														
	PD	S RATING: 125 AMPS G ONLY	PANEL MOUNTING: RECESSED PANEL ENCLOSURE (NEMA): 1													
					PANEL MIN. A. I. C. RATING: 10K											
CIR.	DESCRIPTION		CIR.	WIRE & CONDUIT		LOAD - VA				LOAD - VA		WIRE & CONDUIT	CIR.		DESCRIPTION	CIR.
No.	BESSIAI TION	NOTE	BKR.	WITE & CONDON	AØ	BØ	СØ		AØ	BØ	cø	VIII C C CONDOIT	BKR.	NOTE	E SESSIVI FISH	No.
1	LIGHT SQUAD RM	2	20/1	2#12, 1#12G IN 1"C	270			1 [480			2#12, 1#12G IN 1"C	20/1	2	REC RADIO RM WORKSTATION	2
3	LIGHT RADIO RM	2	20/1	2#12, 1#12G IN 1"C		270	1			480	1	2#12, 1#12G IN 1"C	20/1	2	REC RADIO RM WORKSTATION	4
5	LIGHT LOBBY	1	20/1	EXTEND EXISTING			300	1			100	EXTEND EXISTING	20/1	1	REC DOOR A LA RM	6
7	LIGHT LIEUTENANT'S OFFICE	1	20/1	EXTEND EXISTING	232	1			180			2#12, 1#12G IN 1"C	20/1	2	REC RADIO RM INTERCOM	8
9	LIGHT ENTRANCE	1	20/1	EXTEND EXISTING		100	1			360	1	2#12, 1#12G IN 1"C	20/1	2	REC RADIO RM	10
11	LIGHT SERGEANT'S OFFICE	1	20/1	EXTEND EXISTING			232	1			480	EXTEND EXISTING	20/2	1	HAND DRYER WOMEN'S LOCKER	12
13	LIGHT BACK ENTRANCE	1	20/1	EXTEND EXISTING	100	1			480			EXTEND EXISTING	"	1	"	14
15	LIGHT CORRIDOR	1	20/1	EXTEND EXISTING		580	1			480		EXTEND EXISTING	20/2	1	HAND DRYER MEN'S LOCKER	16
17	LIGHT WOMEN'S LOCKER RM	1	20/1	EXTEND EXISTING			232	1			480	EXTEND EXISTING	"	1	"	18
19	REC STONE RM	1	20/1	EXTEND EXISTING	180	1		1 [200			EXTEND EXISTING	20/1	1	MXL	20
21	LIGHT MEN'S LOCKER RM	1	20/1	EXTEND EXISTING		232	1			720	1	EXTEND EXISTING	20/1	1	POD	22
23	LIGHT INTERROGATION RM	1	20/1	EXTEND EXISTING			100	11			1500	EXTEND EXISTING	20/1	1	UNIT HEATER REAR ENTRANCE	24
25	REC SQUAD RM	2	20/1	2#12, 1#12G IN 1"C	360	1			180			EXTEND EXISTING	20/1	1	SPARE WOMEN'S LOCKER CEILING	26
27	REC LOBBY	1	20/1	EXTEND EXISTING		180	1			180	1	EXTEND EXISTING	20/1	1	SPARE WAREHOUSE CEILING	28
29	REC INTERROGATION RM	1	20/1	EXTEND EXISTING			180	1			180	EXTEND EXISTING	20/1	1	SPARE COMMANDER'S CLOSET CEIL.	30
31	REC SERGEANT'S RM	1	20/1	EXTEND EXISTING	720	1		1 [180			EXTEND EXISTING	20/1	1	SPARE FRONT ENTRANCE	32
33	REC MEN'S LOCKER RM	1	20/1	EXTEND EXISTING		180				720		2#12, 1#12G IN 1"C	20/1	2	REC CLOSET 164, SQUAD RM	34
35	REC WOMEN'S LOCKER RM	1	20/1	EXTEND EXISTING			180		l		480	2#12, 1#12G IN 1"C	20/1	2	REC RADIO ROOM DISPLAYS	36
37	REC RADIO CHARGER	2	20/1	2#12, 1#12G IN 1"C	540			 					20/1	1	SPARE	38
39	REC RADIO CHARGER	2	20/1	2#12, 1#12G IN 1"C		540				500		EXTEND EXISTING	20/2	1	CIRCUIT TO FRONT PD ENTRANCE	40
41	SPARE	1	20/1						l		500	EXTEND EXISTING	"	1	"	42
					2402	2082	1224	1 F	1700	3440	3720					-

CONNECTED LOAD: 5.52 KVA 4.94 KVA 14.57 KVA 40.44 A

26.28 A

X ISOLATED NEUTRAL BUS X EQUIPMENT GROUND BUS

NOTES: GROUNDING AND BONDING SHALL BE IN ACCORDANCE WITH THE NEC. BALANCE ALL PHASES.

1. EXISTING LOAD. EXTEND EXISTING CIRCUIT TO NEW LOCATION. 2. PROVIDE NEW CONNECTION.



DELAWARE RIVER AND BAY AUTHORITY CAPE MAY - LEWES FERRY

CONTRACT NO. CMLF-C19-06 TERMINAL POLICE AND ADMINISTRATION BUILDING - DISPATCH CENTER REHAB


	REVISION			
	REVISION	CENTURY	Г	
DATE	DESCRIPTION	BY		ı
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			CONSULTING ENGINEERS - PLANNERS	ı
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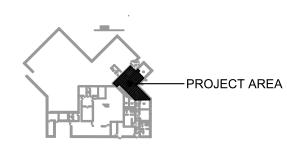
GENERAL NOTES SYMBOLS AND **ABBREVIATIONS**

E-000

SCALE: AS NOTED DATE: MAY 2022

SHEET NO.



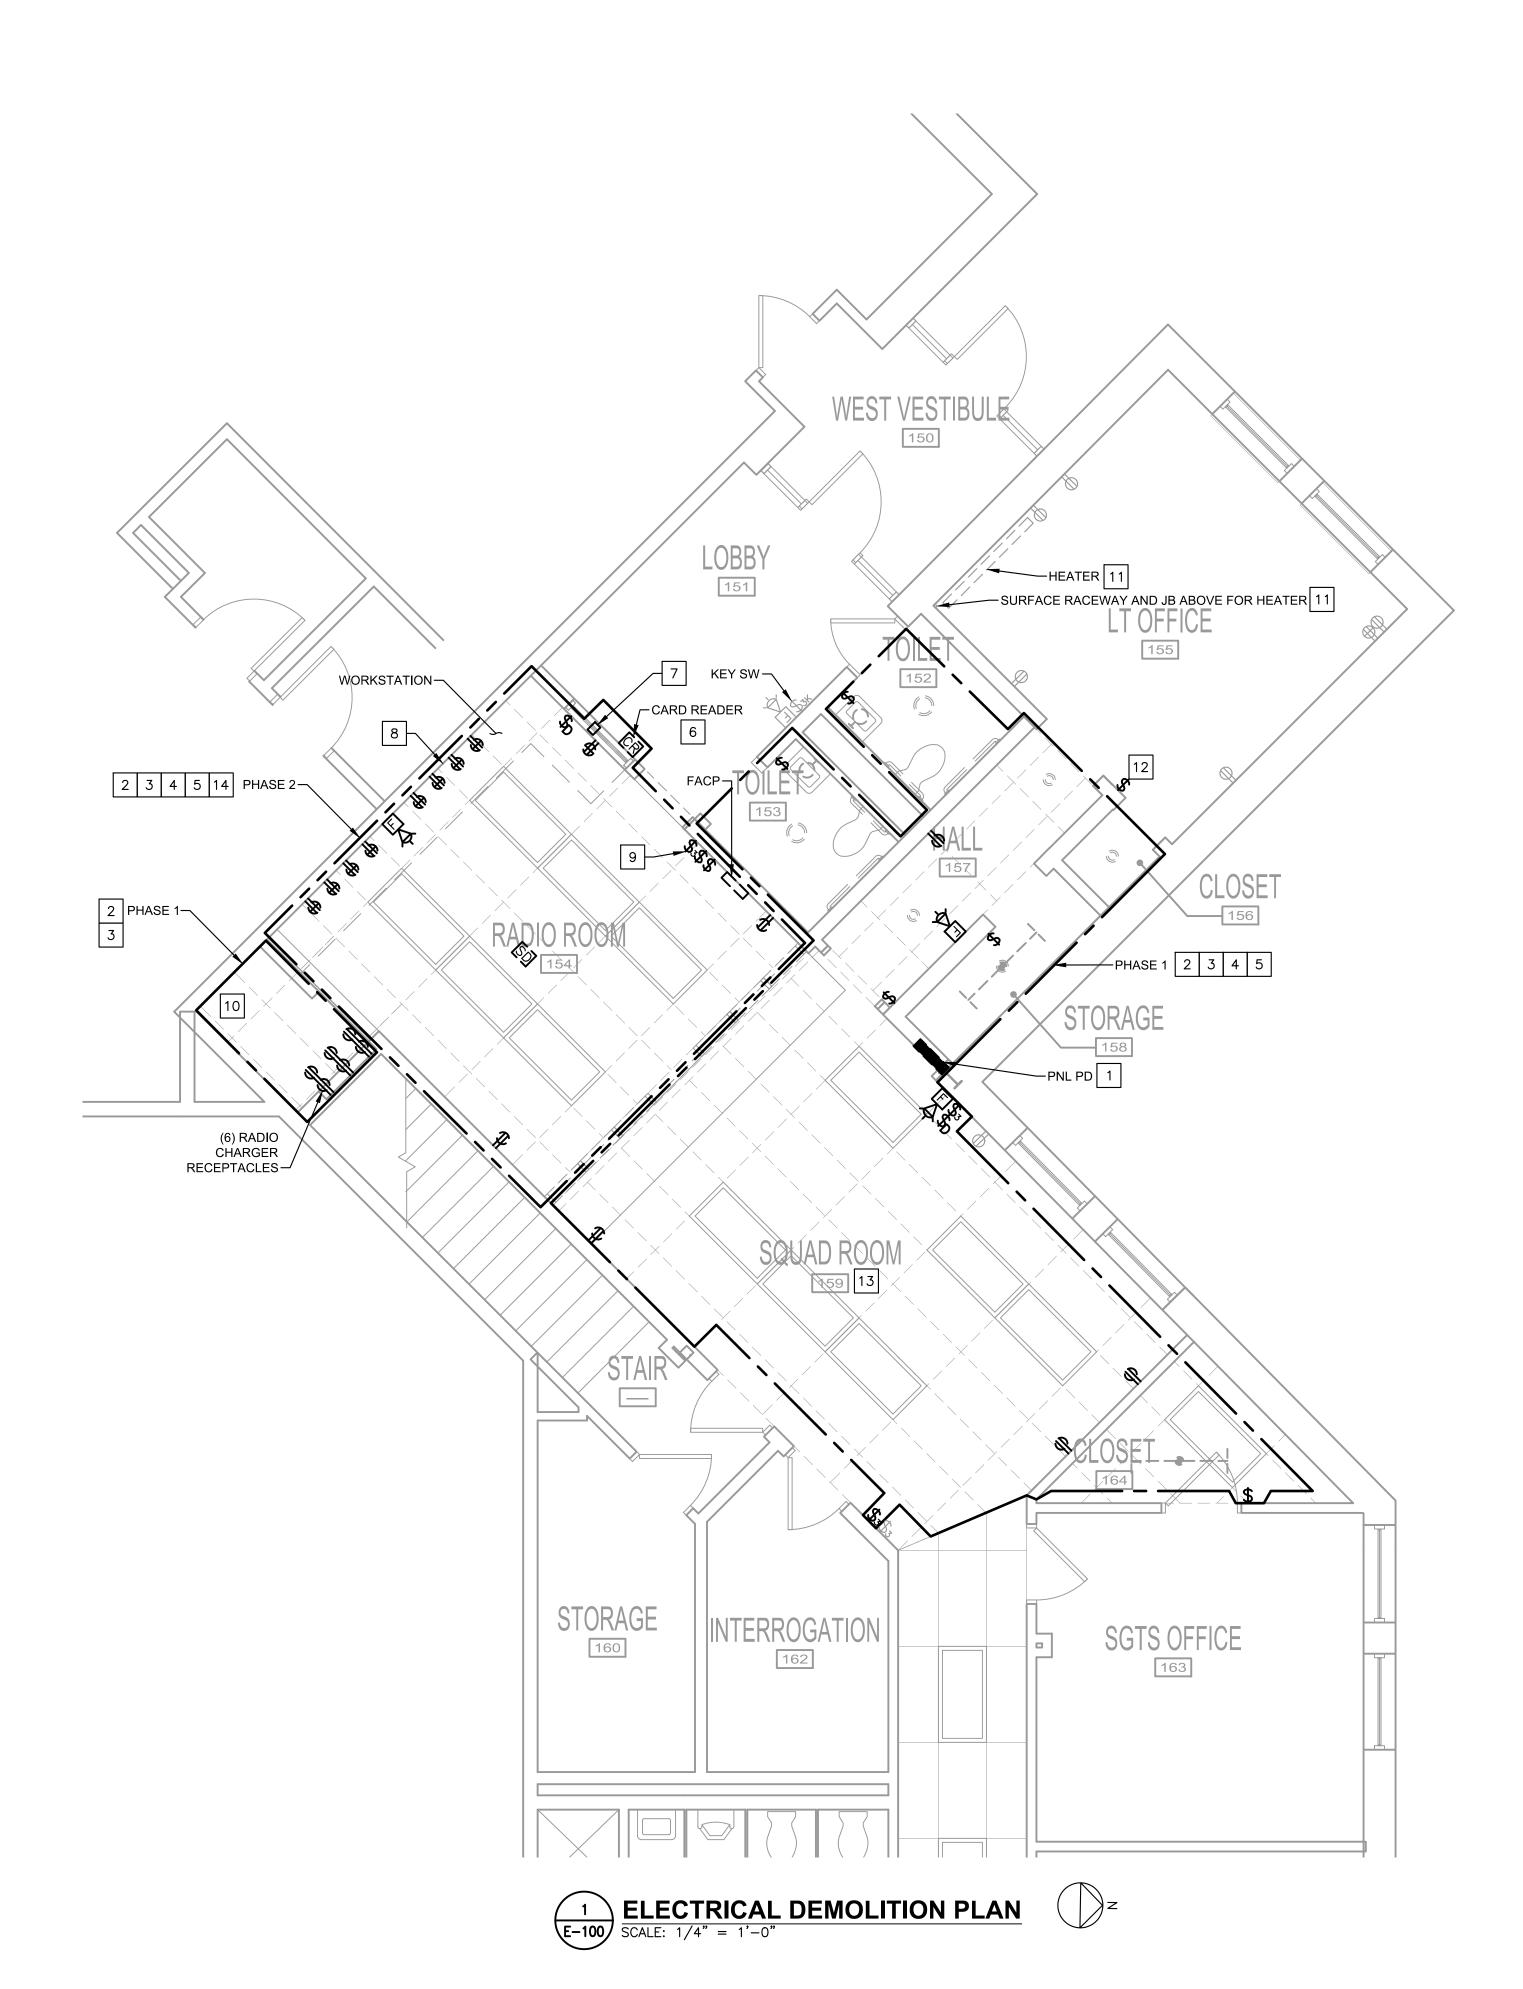



GRAPHIC SCALE 1/4" = 1-0"

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DRAWING NOTES:

- UNLESS NOTED OTHERWISE, EXISTING LIGHTING, EQUIPMENT, AND DEVICES SHALL REMAIN.
- 2. COORDINATE ELECTRICAL DEMOLITION WORK WITH HVAC EQUIPMENT DEMOLITION WORK.
- 3. COORDINATE AND SCHEDULE WITH AUTHORITY FOR ANY INTERRUPTION
- 4. MAINTAIN CIRCUIT CONTINUITY FOR REMAINING RECEPTACLES AND LIGHTING FIXTURES THAT ARE ON THE SAME CIRCUITS WITH THOSE THAT ARE INDICATED TO BE DEMOLISHED.

REFERENCED NOTES (APPLY TO THIS DRAWING WHERE INDICATED):

- ONCE NEW PANEL IS INSTALLED, DISCONNECT AND REMOVE PANEL PD. PULL REMAINING WIRING UP TO ACCESSIBLE CEILING TO ALLOW FOR RECONNECTION TO NEW PANEL.
- DISCONNECT AND REMOVE LIGHTING FIXTURES. REMOVE
 ASSOCIATED LIGHT SWITCHES. REMOVE WIRING AND CONDUITS
 BACK TO SOURCE.
- DISCONNECT AND REMOVE RECEPTACLES. REMOVE ASSOCIATED WIRING AND CONDUITS BACK TO SOURCE.
- DISCONNECT AND REMOVE LOW-VOLTAGE JACKS. REMOVE ASSOCIATED CABLING AND CONDUITS BACK TO SOURCE.
- RELOCATION WORK FOR FIRE ALARM CONTROL PANEL AND
- ASSOCIATED CABLING BY OTHERS.
- 6 DEMOLITION WORK FOR CARD READER, DOOR LOCK, DOOR RELEASE BUTTON, AND ASSOCIATED CABLING BY OTHERS.
- DEMOLITION WORK FOR INTERCOM SYSTEM ON WINDOW AND ASSOCIATED CABLING BY OTHERS.
- TEMPORARILY MAINTAIN DISPATCH EQUIPMENT OPERATION UNTIL CUT OVER TO TEMPORARY WORKSTATION IN SQUAD ROOM.
- THIS SWITCH IS WORKING IN CONJUNCTION WITH KEY SWITCH IN LOBBY FOR LOBBY LIGHTING. DISCONNECT, REMOVE, AND INSTALLED NEW SWITCH SHOWN ON LIGHTING PLAN TO KEEP LOBBY LIGHTING IN OPERATION.
- COORDINATE WITH AUTHORITY AND DISPATCH EQUIPMENT VENDOR TO PREPARE THIS AREA FOR NEW EQUIPMENT RACK.
- DISCONNECT ELECTRIC BASEBOARD HEATER. DETACH FIN TUBE BASEBOARD RADIATION'S CONTROL CABLING SUPPORTED ON THE ELECTRIC BASEBOARD HEATER'S SURFACE RACEWAY. REMOVE ELECTRIC BASEBOARD HEATER'S WIRING AND SURFACE RACEWAY BACK TO JUNCTION BOX MOUNTED HIGH ON WALL. COORDINATE WITH MECHANICAL TO REROUTE FIN TUBE BASEBOARD RADIATION'S CONTROL CABLING.
- DISCONNECT AND REMOVE LIGHT SWITCH. RETAIN WIRING FOR RECONNECTION. PROTECT WIRING DURING PARTIAL WALL DEMOLITION.
- COORDINATE WITH AUTHORITY AND DISPATCH EQUIPMENT VENDOR TO PREPARE THIS AREA FOR TEMPORARY WORKSTATION AND WALL-MOUNTED DISPLAY INSTALLATION.
- REMOVE WIRING AND CONDUITS FOUND UNDER RAISED FLOOR.
 REROUTE ANY REMAINING CIRCUIT VIA WALLS AND ACCESSIBLE



DELAWARE RIVER AND BAY AUTHORITY
CAPE MAY — LEWES FERRY

CONTRACT NO. CMLF—C19—06
TERMINAL POLICE AND ADMINISTRATION
BUILDING — DISPATCH CENTER REHAB

ELECTRICAL DEMOLITION PLAN

E-100

DATE: MAY 2022 SCALE: AS NOTED

SHEET NO.

DRAWINGS NOTES:

- 1. COORDINATE WITH CEILING INSTALLATION.
- CONNECT EXIT SIGNS TO THE SAME CIRCUIT SERVING AREAS AHEAD OF ANY SWITCHING DEVICES.

SPECIFIC NOTES (APPLY TO THIS DRAWING WHERE INDICATED):

- CONNECT TO CONTROL EXISTING LOBBY LIGHTING FIXTURES.
- (2) CONNECT TO EXISTING LOBBY LIGHTING CIRCUIT INDICATED.
- (3) CONNECT TO EXISTING LT OFFICE'S LIGHTING CIRCUIT INDICATED.
- 4 CONNECT TO EXISTING SGTS OFFICE'S LIGHTING CIRCUIT INDICATED.
- CONNECT TO EXISTING RADIO ROOM'S LIGHTING CIRCUIT INDICATED.
- PROVIDE LIGHT SWITCH AND CONNECT TO EXISTING CIRCUIT WIRING.
- PROVIDE DOUBLE GANG WALL PLATE FOR NEW DIMMER AND EXISTING LIGHT SWITCH.

	LIGHTING FIXTURE SCHEDULE										
TYPE	DESCRIPTION	VOLTS	LAMP TYPE	WATTS	LUMENS	KELVIN	MOUNTING	MANUFACTURER	MODEL SERIES	REMARKS/ACCESSORIES	
А	2' X 4' LED CENTER RECTANGULAR BASKET, 80+ CRI, 0-10V DIMMING, IC/PLENUM/AIR RETURN RATED	UNV 120-277	LED	36.2	4276	3500	RECESSED	DAYBRITE	FG FLUXGRID SERIES	PROVIDE COMPATIBLE DIMMERS.	
В	2' X 4' FLAT PANEL LED, 80+ CRI, 0-10V DIMMING, IC/PLENUM/AIR RETURN RATED	UNV 120-277	LED	38	4118	3500	RECESSED	LITHONIA OR DAYRITE	EPANL LED SERIES OR FXP FLUXPANEL LED SERIES		
DL	6" ROUND LED DOWNLIGHT, SPECULAR REFLECTOR, WHITE FLANGE, 0-10V DIMMING, IC/PLENUM/AIR RETURN RATED	UNV 120-277	LED	21	2000	3500	RECESSED	LIGHTOLIER	LYTEPROFILE SERIES		
X1	LED COMBO EXIT SIGN WITH DUAL HEADS, SINGLE-FACE, NI-CAD BATTERY, SELF-DIAGNOSTICS, CHEVRONS	120	LED	4.3	-	-	WALL SURFACE	LITHONIA	LHQM LED SERIES		
X2	LED COMBO EXIT SIGN WITH DUAL HEADS, DOUBLE-FACE, NI-CAD BATTERY, SELF-DIAGNOSTICS, CHEVRONS	120	LED	4.3	-	-	CEILING SURFACE	LITHONIA	LHQM LED SERIES		

LIGHTING FIXTURE SCHEDULE GENERAL NOTES:

- 1. LETTER AT LIGHTING FIXTURE IS THE FIXTURE TYPE. NL = NIGHT LIGHT THAT CONNECTED AHEAD OF SWITCHING DEVICES.
- 2. ALL LIGHTING FIXTURES SHALL BE INSTALLED IN ACCORDANCE WITH LOCAL JURISDICTION REQUIREMENTS, IN STRICT ACCORDANCE WITH NEC ARTICLE 410, AND SHALL PROPERLY AND SUITABLY SUPPORT THE WEIGHT OF ANY FIXTURE INSTALLED.
- 3. MANUFACTURERS LISTED ARE BASIS OF DESIGN. IF OTHER THAN BASIS OF DESIGN MANUFACTURERS ARE SUBMITTED, PROVIDE FIXTURE CUTSHEETS AND EXPLANATION OF DIFFERENCES BETWEEN BASIS OF DESIGN AND PROPOSED ALTERNATE FIXTURE. ALL NON BASIS OF DESIGN SUBMITTED FIXTURES ARE SUBJECT TO REVIEW AND APPROVAL BY THE ENGINEER.



ROJECT AREA





DELAWARE RIVER AND BAY AUTHORITY

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CONTRACT NO. CMLF—C19—06
TERMINAL POLICE AND ADMINISTRATION
BUILDING — DISPATCH CENTER REHAB

SCALE: AS NOTED

KY RING	LIGHTING	PLAN	
PLANNERS			

DATE: MAY 2022

E-101

SHEET NO. 21

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0 1 2 4 8 12

GRAPHIC SCALE

1/4" = 1'-0"

WEST VESTIBULE

LT OFFICE 155

LOBBY


STORAGE 160


LIGHTING PLAN
SCALE: 1/4" = 1'-0"

INTERROGATION 162


DRAWING NOTES:

- 1. REFER TO PHASE 1 AND PHASE 2 PLANS FOR SPECIFIC NOTES.
- 2. REFER TO E-105 FOR SECURITY ACCESS SYSTEM REQUIREMENTS.

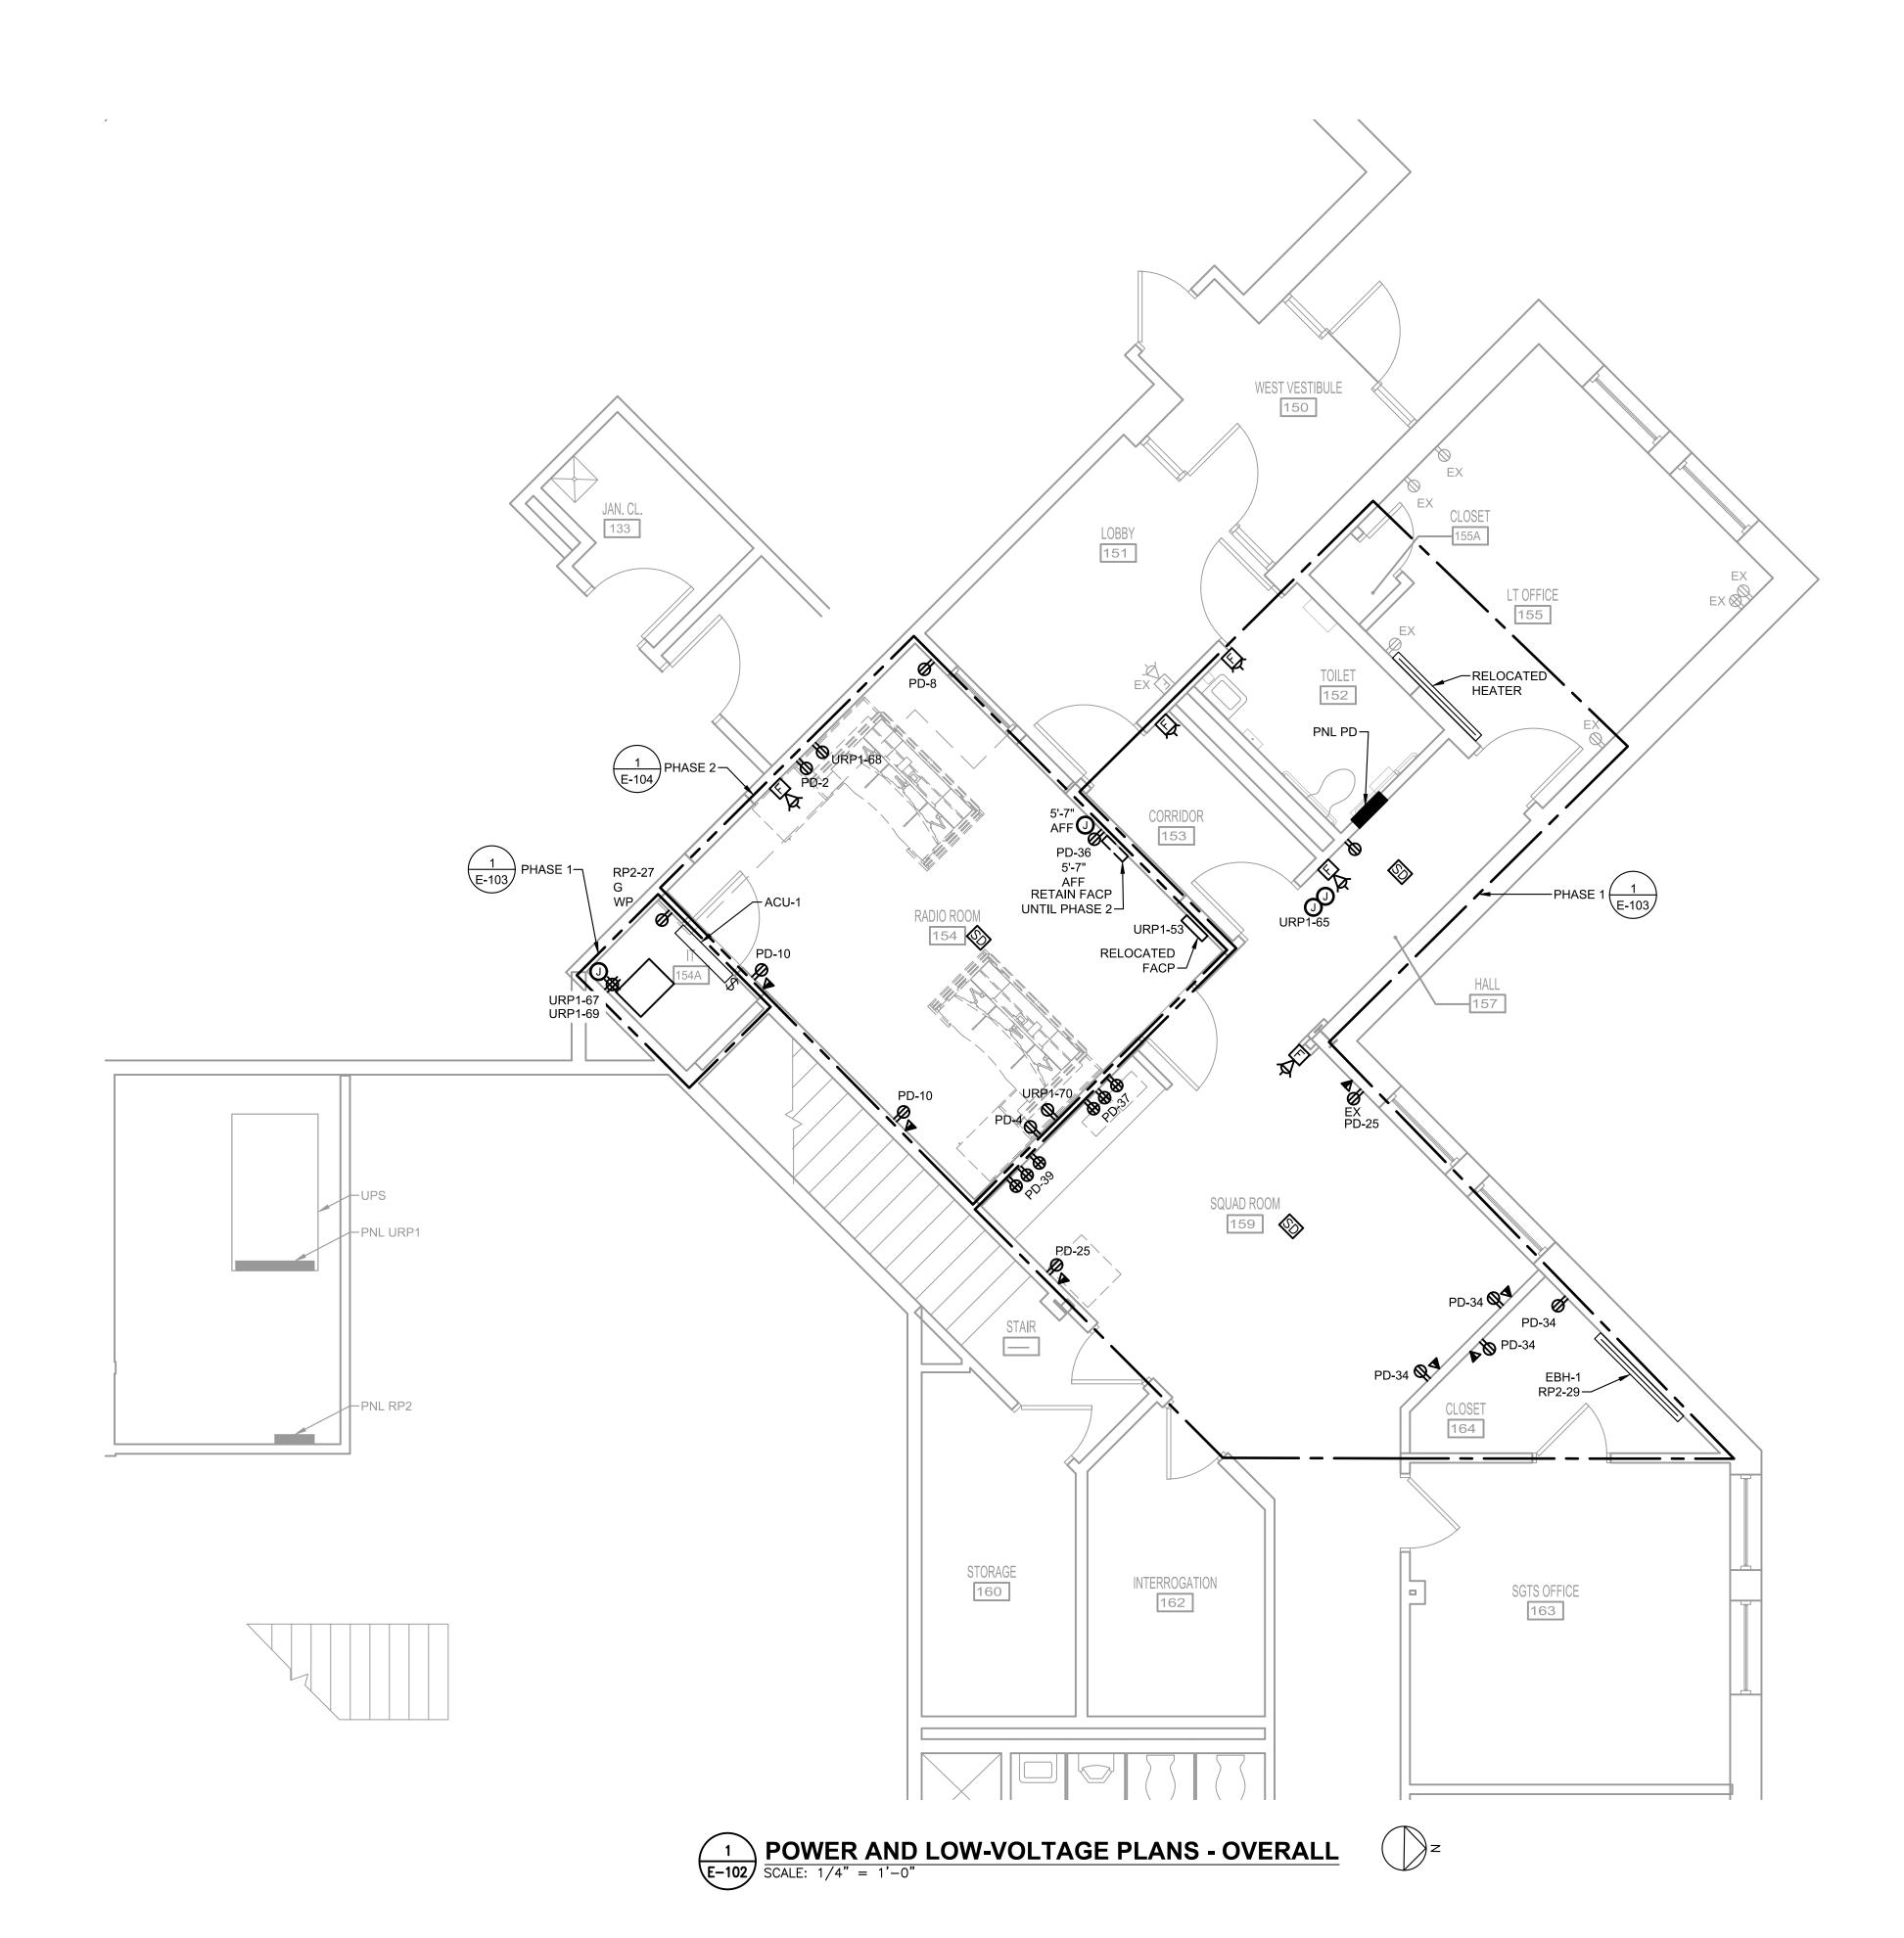

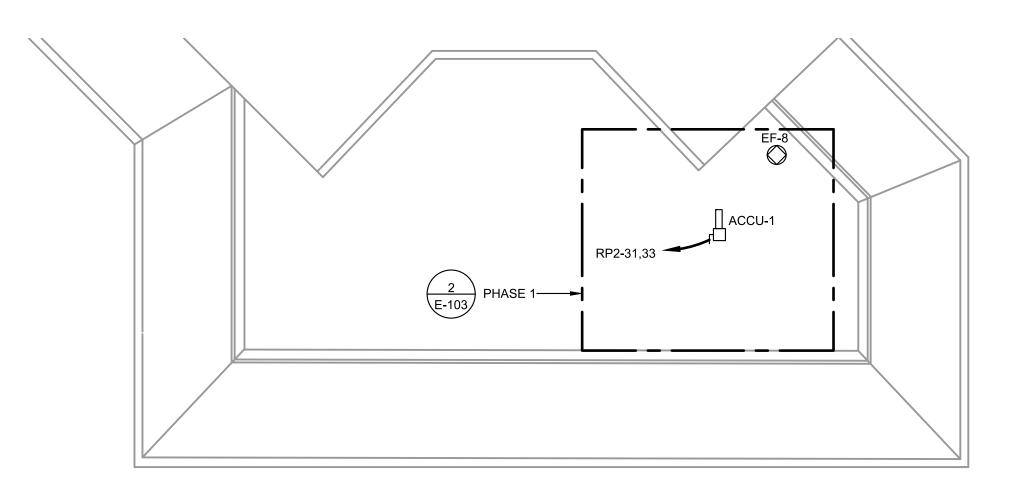



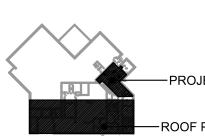





SHEET NO.

E-102


DELAWARE RIVER AND BAY AUTHORITY CAPE MAY - LEWES FERRY


> CONTRACT NO. CMLF-C19-06 TERMINAL POLICE AND ADMINISTRATION BUILDING - DISPATCH CENTER REHAB


POWER AND LOW-VOLTAGE PLANS -OVERALL

DATE: MAY 2022

SCALE: AS NOTED

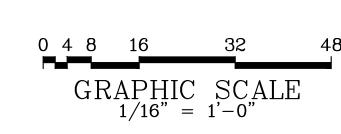

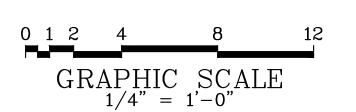

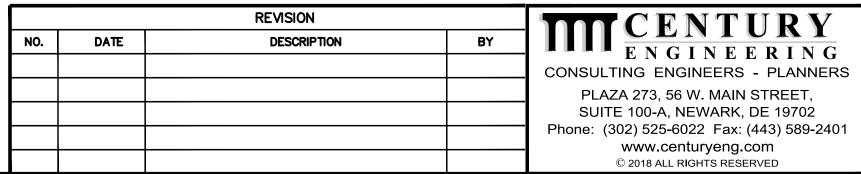


SPECIFIC NOTES (APPLY TO THIS DRAWING WHERE INDICATED):

- TRANSFER ALL EXISTING CIRCUITS TO THIS PANEL PRIOR TO REMOVING EXISTING PANEL. INTERCEPT EXISTING FEEDER AND BRANCH CIRCUITS WITH JUNCTION BOXES ABOVE ACCESSIBLE CEILING. PROVIDE WIRING AND CONDUITS TO EXTEND CIRCUITS TO THIS PANEL. COORDINATE WITH DUCTWORK AND PIPING INSTALLATIONS.
- RECESSED BOX WITH CABLE-THROUGH COVER PLATE FOR WALL-MOUNTED DISPLAY. FIELD VERIFIED AND COORDINATE EXACT LOCATION AND MOUNTING HEIGHT WITH DISPATCH EQUIPMENT VENDOR (ACTIVU).
- REPLACE RECEPTACLE AND COVER PLATE.
- CONNECT TO EXISTING RECEPTACLE CIRCUIT SERVING THE AREA. EXTEND EXISTING CIRCUIT WIRING AS REQUIRED.
- 5 PROVIDE PULL BOX FOR DATA CABLING.

UPDATE CIRCUIT DIRECTORY.

- PROVIDE POWER AND SECURITY BOXES ABOVE ACCESSIBLE CEILING FOR DOOR SECURITY SYSTEM CONNECTIONS (CORRIDOR 153 DOORS, RADIO ROOM 154 DOOR, AND CLOSET 164 DOOR).
- UTILIZE EXITING RECEPTACLES FOR TEMPORARY WORKSTATION AND WALL-MOUNTED DISPLAYS. WORKSTATION AND WALL-MOUNTED DISPLAYS SHALL BE RELOCATED TO RADIO ROOM IN PHASE 2. COORDINATE ALL WORKS WITH AUTHORITY AND DISPATCH EQUIPMENT VENDOR.
- ALL CABLING SHALL BE PROVIDED BY DISPATCH EQUIPMENT VENDOR.
- CONNECT INDOOR UNIT TO OUTDOOR UNIT WITH 3#12, 1#12G IN3/4"C VIA
- CONNECT DISPATCH EQUIPMENT RACK'S RECEPTACLES AND DOOR SECURITY EQUIPMENT TO EXISTING 20A/1P CIRCUIT BREAKERS INDICATED.
- CONNECT CONDENSATE PUMP RECEPTACLE AND EBH-1 TO EXISTING 20A/1P CIRCUIT BREAKERS INDICATED. PROVIDE 30A/2P CIRCUIT BREAKER IN AVAILABLE SLOTS FOR OUTDOOR UNIT ACCU-1. UPDATE CIRCUIT
- TEMPORARILY MAINTAIN EXISTING WORKSTATION AND WALL-MOUNTED DISPLAYS OPERATIONAL UNTIL CUTOVER.
- DISCONNECT EXISTING TO ALLOW FOR FAN REPLACEMENT. REPLACE EXISTING WIRING BACK TO PANEL P IN ELECTRICAL ROOM BELOW. WIRING SHALL BE 3#12, 1#12G IN EXISTING 3/4" CONDUIT. CONNECT TO MECHANICAL PROVIDED DISCONNECT AND DRIVE IN ACCORDANCE WITH MANUFACTURER'S INSTRUCTIONS.
- EXTEND EXISTING CIRCUIT IN JUNCTION BOX TO RELOCATED ELECTRIC BASEBOARD HEATER WITH 2#12, 1#12G IN METAL SURFACE RACEWAY.
- PROVIDE TEMPORARY 20A POWER STRIP WITH (6) RECEPTACLES FOR RADIO CHARGERS. COORDINATE WITH OWNER FOR EXACT LOCATION.
- REINSTALLATION OF FIRE ALARM DEVICE / APPLIANCE AND ASSOCIATED
- CABLING BY OTHERS.
- FIRE ALARM DEVICE AND ASSOCIATED CABLING BY OTHERS.
- 18 FIRE ALARM STROBE AND ASSOCIATED CABLING BY OTHERS.
- COORDINATE WITH DISPATCH EQUIPMENT VENDOR TO REQUIRE 36" CLEARANCE FROM FRONT AND 24" CLEARANCE ON ON SIDE.

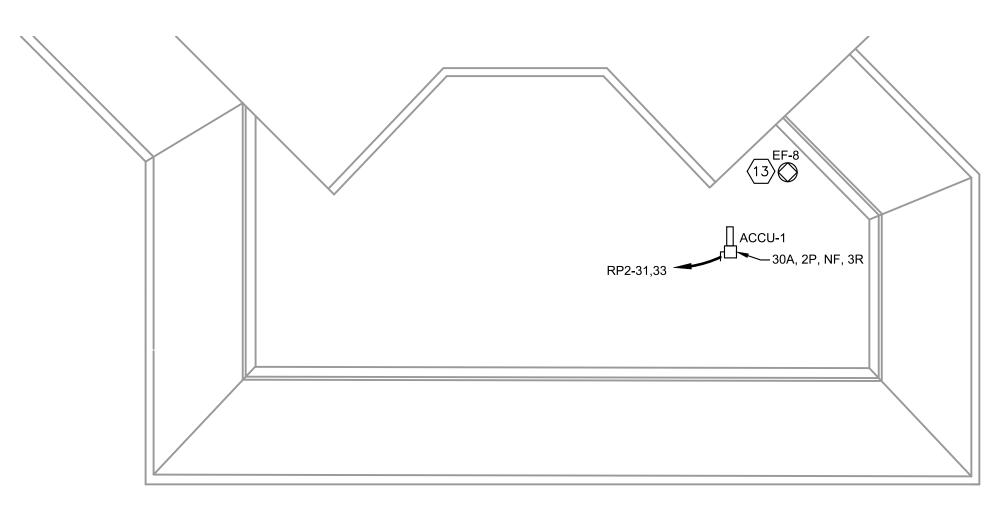






SHEET NO.

E-103

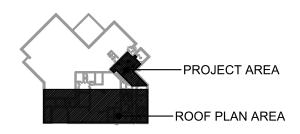



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CONTRACT NO. CMLF-C19-06
TERMINAL POLICE AND ADMINISTRATION
BUILDING - DISPATCH CENTER REHAB

SCALE: AS NOTED

	POWER AND	
5	LOW-VOLTAGE PLANS -	
	PHASE 1	
1		

DATE: MAY 2022

4_8	16	<u>3</u> 2	48	0_1_2	4	8	1,2
GR	APHIC 1/16" =	SCAL	E	GR.		C SCAL = 1'-0"	E

WEST VESTIBULE

EX 🛞

-RELOCATED $\langle 14 \rangle$

TEMPORARY WORKSTATION $\langle 7 \rangle$

RP2-29-

CLOSET 164

TEMPORARY
WALL-MOUNTED
DISPLAYS—

8 TEMPORARY ROUTING
FOR DISPATCH
EQUIPMENT CIRCUITS

INTERROGATION 162

POWER AND LOW-VOLTAGE PLANS - PHASE 1

| E-103 | SCALE: 1/4" = 1'-0"

HEATER

151

RETAIN FACP

UNTIL PHASE 2

STORAGE 160

19 DISPATCH EQUIP. RACK

-PNL URP1 (10)

-PNL RP2 (11)

URP1-69

PREFERRED FRONT

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WORK SHALL BE DONE IN PHASES. COORDINATE ALL WORK WITH OTHER


INSTALLATIONS.

SPECIFIC NOTES: (APPLY TO THIS DRAWING WHERE INDICATED):

- INSTALL RECEPTACLES FOR THIS WORKSTATION PRIOR TO REMOVING EXISTING WORKSTATION.
- RECESSED BOX WITH CABLE-THROUGH COVER PLATE FOR WALL-MOUNTED DISPLAY. FIELD VERIFIED AND COORDINATE EXACT LOCATION AND
- MOUNTING HEIGHT WITH DISPATCH EQUIPMENT VENDOR. ONCE EXISTING WORKSTATION REMOVED, INSTALL RECEPTACLES FOR THIS
- CONNECT WORKSTATION'S RECEPTACLES TO EXISTING 20A/1P CIRCUIT BREAKERS INDICATED. UPDATE CIRCUIT DIRECTORY.
- 5 RELOCATE TEMPORARY WORKSTATION TO RADIO ROOM.

RELOCATED WORKSTATION FROM SQUAD ROOM.

- (6) RELOCATE DISPLAYS TO RADIO ROOM.
- 7 REMOVE TEMPORARY CABLING.
- RELOCATION WORK FOR FIRE ALARM CONTROL PANEL AND ASSOCIATED CABLING BY OTHERS.

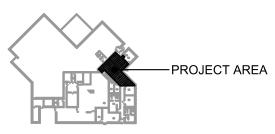

REVISION

DESCRIPTION

DATE

GRAPHIC SCALE 1/4" = 1'-0"



CONTRACT NO. CMLF-C19-06 TERMINAL POLICE AND ADMINISTRATION BUILDING - DISPATCH CENTER REHAB

POWER AND	
LOW-VOLTAGE PLAN	_
DUACE 2	

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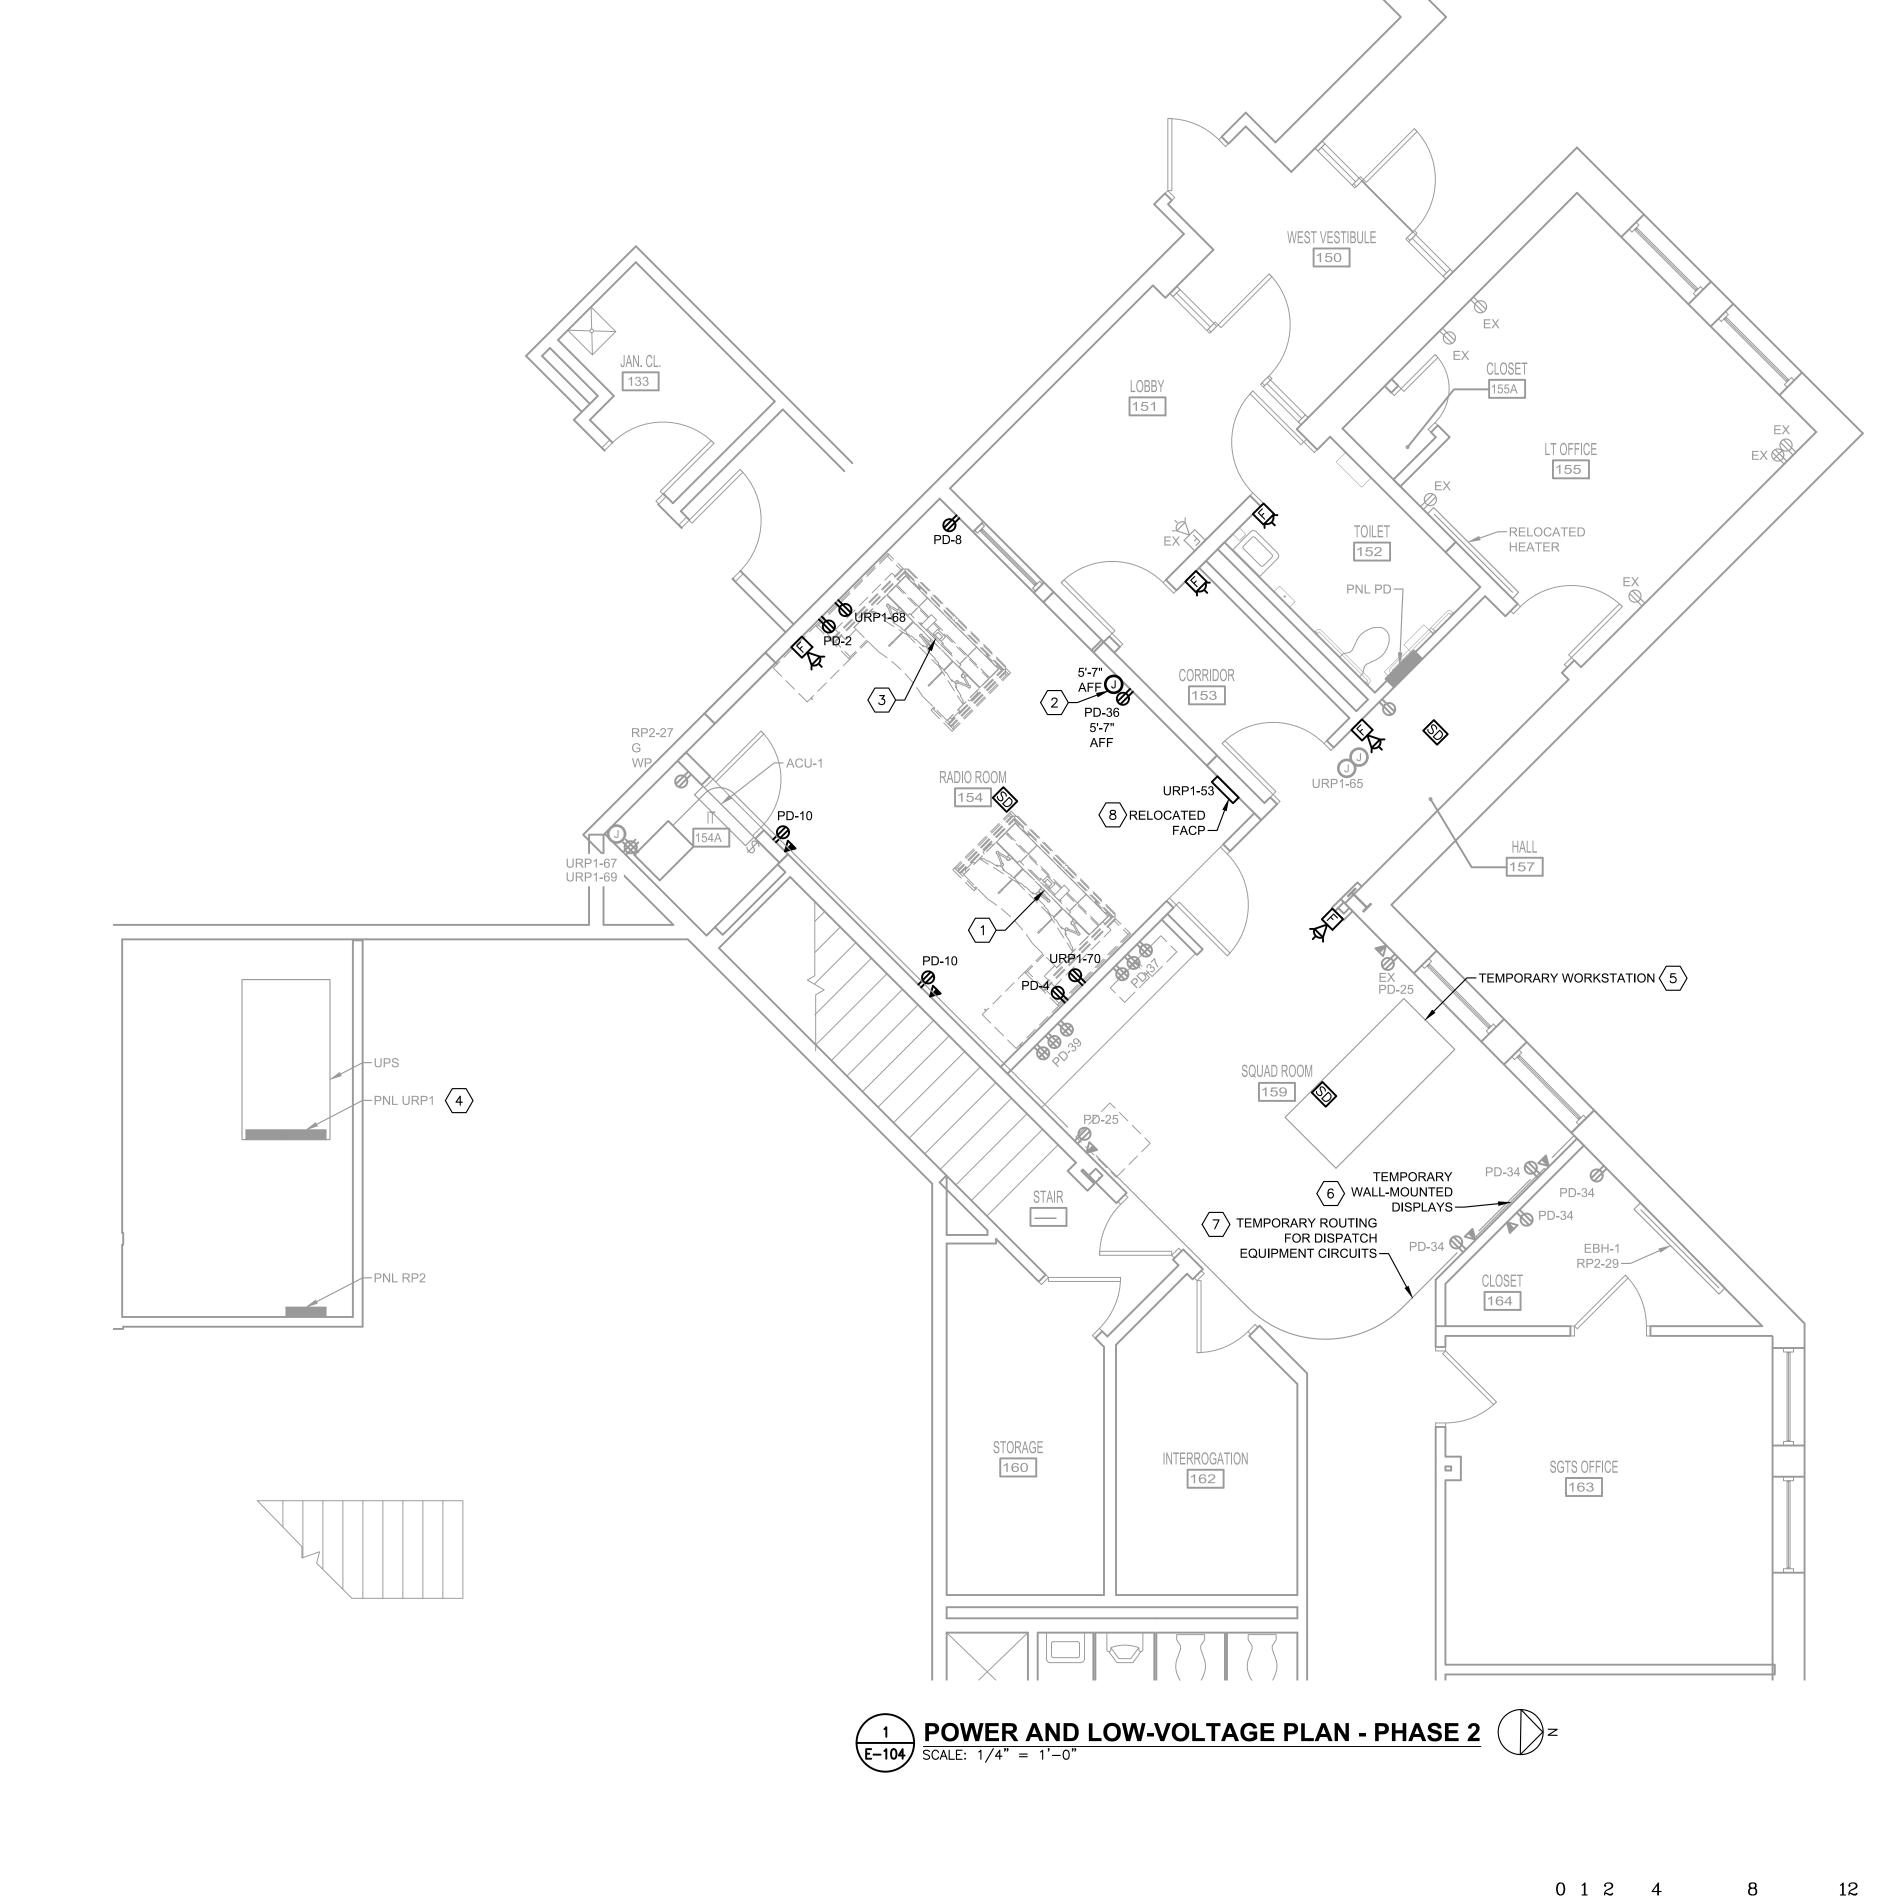
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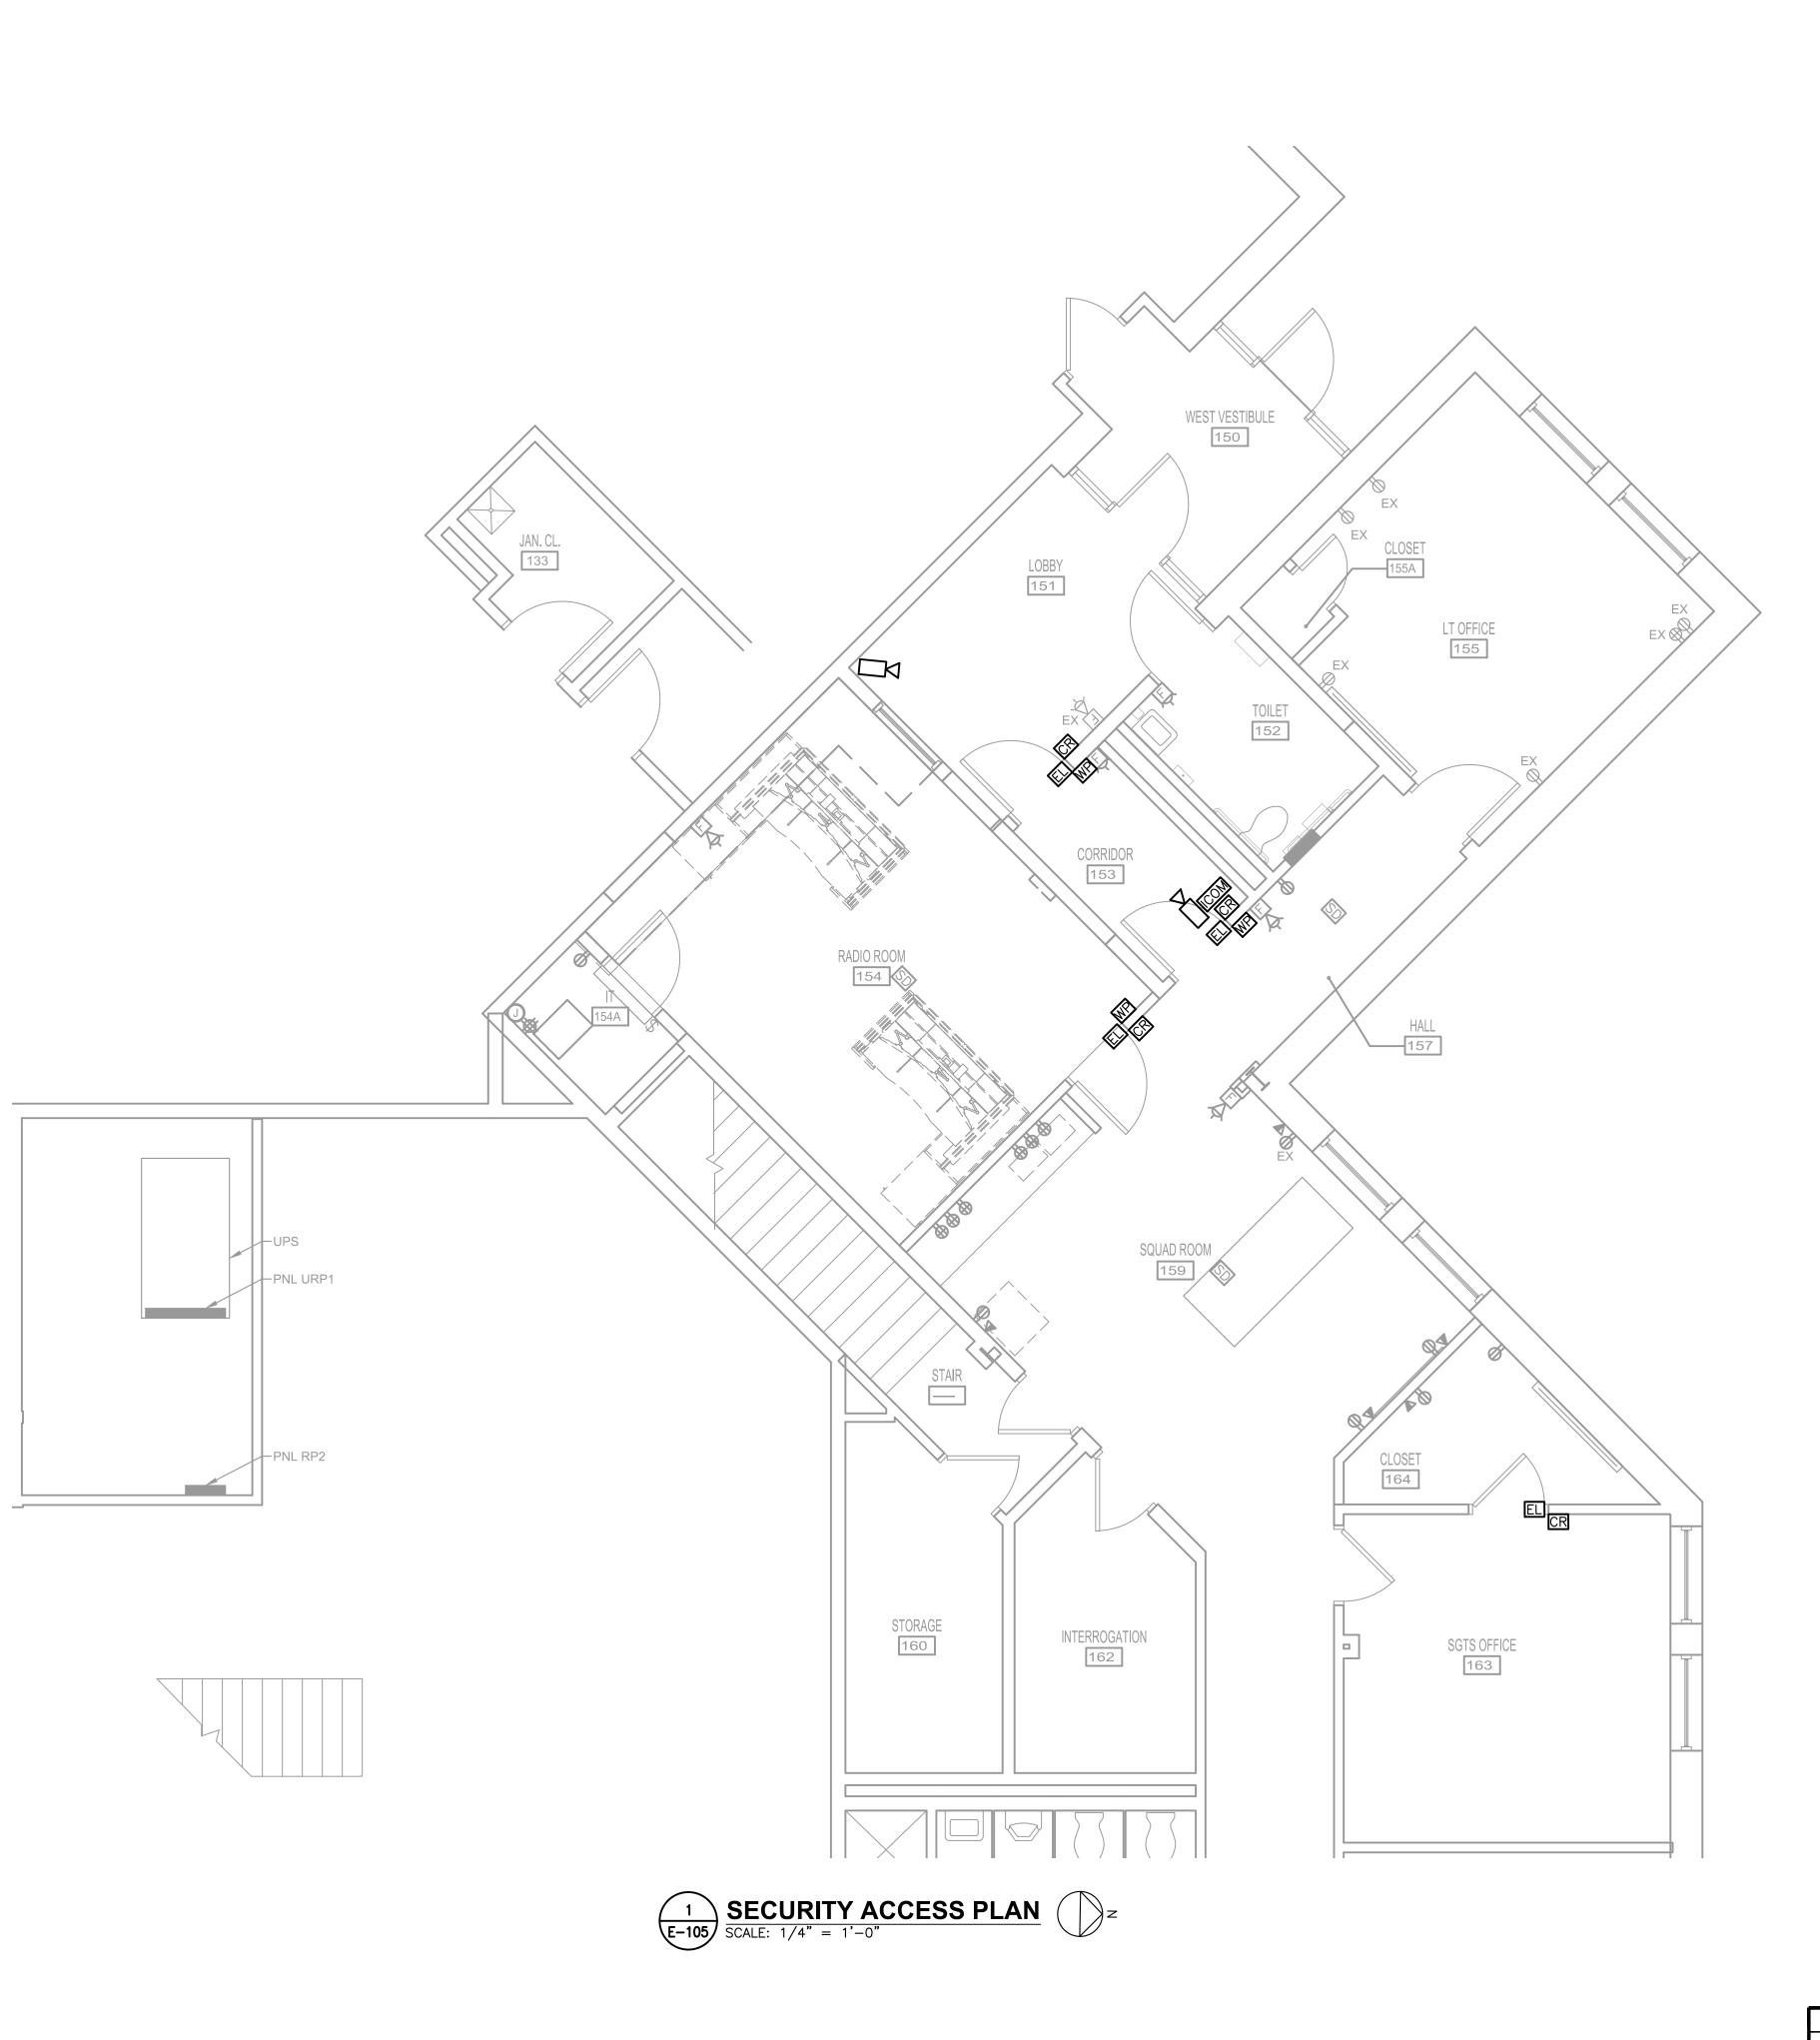
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E-104 SCALE: AS NOTED SHEET NO.











CARD READER


WAVE PLATE

ELECTRIC LOCK / STRIKE


VIDEO INTERCOM SYSTEM WITH CAMERA, MICROPHONE AND SPEAKER

☐☐☐☐ IP CAMERA, DOME TYPE

SECURITY ACCESS SYSTEM COMPONENTS, RELATED CABLING AND CONDUITS ARE BY OTHERS.

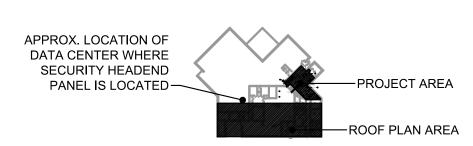



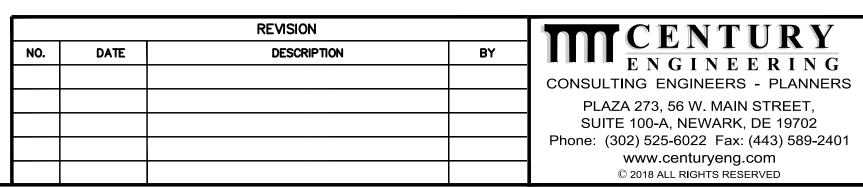



CONTRACT NO. CMLF-C19-06 TERMINAL POLICE AND ADMINISTRATION BUILDING — DISPATCH CENTER REHAB

SECURITY ACCESS PLAN

E-105

DATE: MAY 2022 SCALE: AS NOTED SHEET NO. 25

