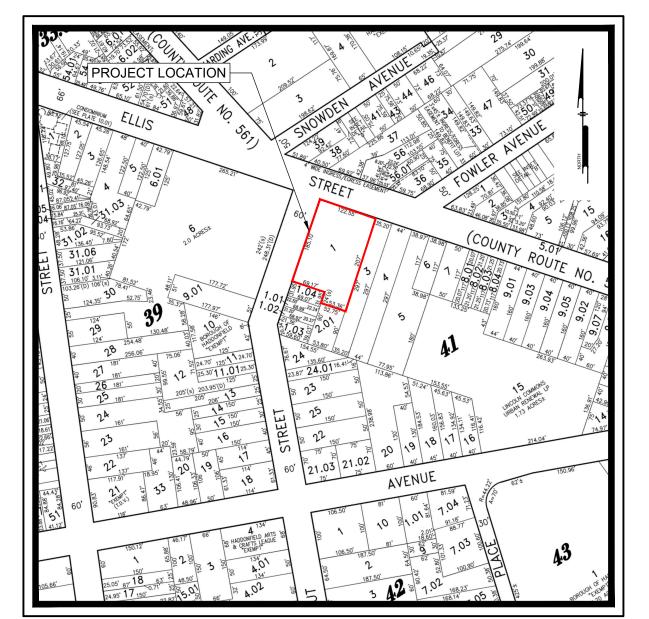
APPROVED BY PLANNIN OF HADDONFIELD	<u>G BOARD OF THE BOROU</u>
APPLICATION #:	RESOLUTION ADOPTED:
BOARD CHAIRMAN	DATE
BOARD SECRETARY	DATE
BOROUGH ENGINEER	DATE
I HEREBY CERTIFY THAT ALL REQUI INSTALLED OR THAT A PERFORMAN ACCORDANCE WITH THE TOWNSHIP	CE BOND HAS BEEN POSTED IN
	DATE

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SOILS MAP Scale: 1" = 200'

NEW JERSEY

NE CAL

CALL BEFORE YOU DIG 1-800-272-1000

CONTRACTOR SHALL BE RESPONSIBLE TO COMPLY WITH THE REQUIREMENTS OF THE NEW JERSEY ONE-CALL DAMAGE PREVENTION SYSTEM AS STATED IN THE "UNDERGROUND FACILITY PROTECTION ACT". TICKET NUMBER(S):

COIETI E ARCHITECTI IRAL CROLID INC CODVRIGHT @ 2022


HADDONFIELD POLICE COMPLEX


PRELIMINARY AND FINAL SITE PLAN

BLOCK 41, LOT 1 CAMDEN COUNTY, NEW JERSEY FEBRUARY 23, 2024

PREPARED FOR: OWNER/DEVELOPER BOROUGH OF HADDONFIELD

242 KINGS HIGHWAY EAST HADDONFIELD, NEW JERSEY 08033

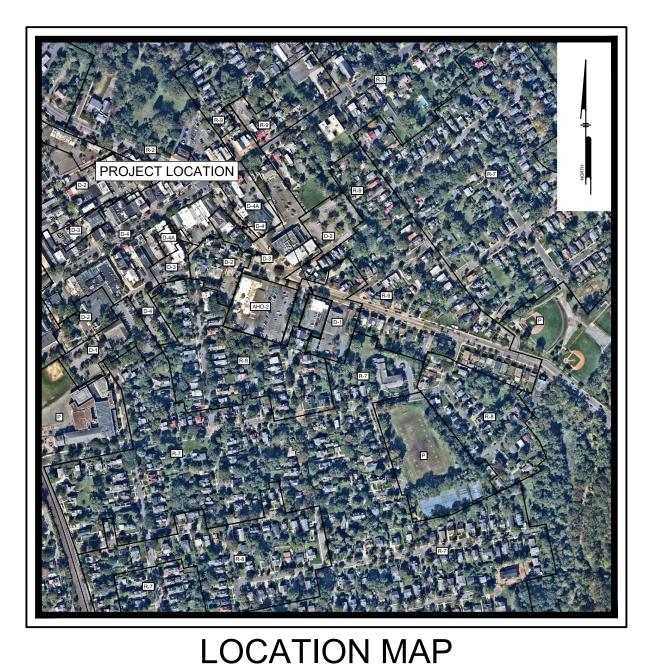

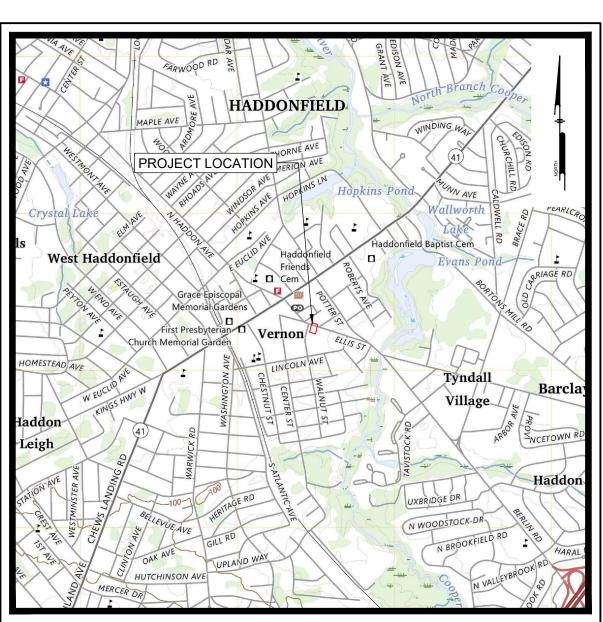



Scale: 1" = 500'



515 Grove Street, Suite 1B Haddon Heights, NJ 08035 **T** 856.547.0505 **F** 856.547.9174

NJ CERTIFICATE OF AUTHORIZATION NO. GA28033300

Sheet List Table				
Sheet No.	Drawing Number	Sheet Title	Drawing Date	Last Revise Date
1	CS0001	COVER SHEET	2024-02-23	2024-05-24
2	CS0002	INFORMATION SHEET	2024-02-23	2024-05-24
3	CS0501	DEMOLITION PLAN- BASE BID	2024-02-23	2024-05-2
4	CS0502	DEMOLITION PLAN- ADD ALT AND BASE BID	2024-02-23	2024-05-2
5	CS1001	SITE PLAN- BASE BID	2024-02-23	2024-05-2
6	CS1002	SITE PLAN- ADD ALT AND BASE BID	2024-02-23	2024-05-2
7	CS1501	GRADING AND UTILITY PLAN- BASE BID	2024-02-23	2024-05-2
8	CS1502	GRADING AND UTILITY PLAN- ADD ALT AND BASE BID	2024-05-24	
9	CS2001	LANDSCAPE PLAN	2024-02-23	2024-05-2
10	CS2201	LIGHTING PLAN	2024-02-23	2024-05-2
11	CS6001	CONSTRUCTION DETAILS	2024-02-23	2024-05-2
12	CS6002	COUNTY CONSTRUCTION DETAILS	2024-02-23	2024-05-2
13	CS6003	CONSTRUCTION DETAILS	2024-05-24	
14	CS8001	SOIL EROSION AND SEDIMENT CONTROL PLAN	2024-02-23	2024-05-2
15	CS8501	SOIL EROSION AND SEDIMENT CONTROL NOTES	2024-02-23	2024-05-2
16	CS8502	SOIL EROSION AND SEDIMENT CONTROL DETAILS	2024-02-23	2024-05-2

USGS MAP Scale: 1" = 2000'

l r	CERTIFICATE:
	spieze
	SPIEZLE ARCHITECTURAL GROUP INC. 121 MARKET STREET CAMDEN, NJ 08102 PHONE: (866) 974 7666
	SIGNATURE:THOMAS S. PERRINO21AI01505400SCOTT E. DOWNIE21AI01674400STEVEN LEONE21AI01170100STEVEN G. SIEGEL21AI01564200ANGELO ALBERTO21AI0164700JOHN F. WRIGHT21AI01784200SPIEZLE ARCHITECTURAL GROUP, INC.21AC00063000
	SEAL: JACQUELINE R BERENATO PROFESSIONAL ENGINEER NEW JERSEY LICENSE NO. GE 56282
	Jacqueline Berenato 2/23/24
	FOR BID 06/25/2024
*0	PROJECT: HADDONFIELD POLICE STATION
	1 WALNUT STREET HADDONFIELD, NEW JERSEY 08033
	FOR CAMDEN COUNTY IMPROVEMENT
	AUTHORITY 520 MARKET STREET, 6TH FLOOR CAMDEN, NEW JERSEY 08102
	FOR CODE REVIEW: 02/23/24 REVISIONS:
	REVISION NAME DATE
	FOR BID: 05/30/24
	DRAWING TITLE:
	COVER SHEET
	COMMISSION NUMBER: 23M014
ALL DIMENSIONS MUST BE VERIFIED BY CONTRACTOR IND OWNER MUST BE NOTIFIED OF ANY DISCREPANCIES BEFORE PROCEEDING WITH WORK ALL DOCUMENTS PREPARED BY PENNONI ASSOCIATES ARE INSTRUMENTS OF SERVICE IN RESPECT OF THE	DRAWING NUMBER:
PROJECT. THEY ARE NOT INTENDED OR REPRESENTED TO BE SUITABLE FOR REUSE BY OWNER OR OTHERS ON THE EXTENSIONS OF THE PROJECT OR ON ANY OTHER PROJECT. ANY REUSE WITHOUT WRITTEN VERIFICATION OR ADAPTATION BY PENNONI ASSOCIATES FOR THE SPECIFIC PURPOSE INTENDED WILL BE AT OWNERS SOLE RISK AND WITHOUT LIABILITY OR LEGAL EXPOSURE TO PENNONI ASSOCIATE; AND OWNER SHALL INDEMNIFY AND HOLD HARMLESS PENNONI ASSOCIATES FROM ALL CLAIMS, DAMAGES, LOSSES AND EXPENSES ARISING OUT OF OR RESULTING THEREFROM.	CS0001

CODE REVIEW

GENERAL NOTES

2

- G-1. THE LOCATION, ELEVATION AND SIZE OF EXISTING UTILITIES SHOWN ON THE CONTRACT DRAWINGS ARE APPROXIMATE AND ARE BASED UPON BEST AVAILABLE INFORMATION PROVIDED TO THE ENGINEER. THE FOLLOWING SHALL BE PERFORMED:
 - A) VERIFY THE LOCATION OF EXISTING UNDERGROUND UTILITIES WITHIN THE WORK AREA PRIOR TO CONSTRUCTION.
- B) EXERCISE EXTREME CAUTION WHEN WORKING TO EXISTING POWER, COMMUNICATIONS, WATER OR GAS LINES TO PREVENT DAMAGE TO THESE LINES.
- C) IMMEDIATELY REPAIR ANY DAMAGE TO EXISTING UTILITIES IN A MANNER APPROVED BY THE ENGINEER, AT NO ADDITIONAL COST TO THE OWNER.
- G-2. IT IS THE OBLIGATION OF THE CONTRACTOR AT HIS COST TO MAKE HIS OWN SITE EXAMINATION AND DETERMINE THE ACTUAL NATURE AND EXTENT OF EXISTING CONDITIONS PRIOR TO UNDERTAKING WORK, ALL DIMENSIONS, QUANTITIES AND EXISTING PHYSICAL CHARACTERISTICS OF THE WORK AREA SHALL BE REVIEWED AND FIELD VERIFIED BY THE CONTRACTOR PRIOR TO SUBMITTING A BID. MATERIAL ORDERING OR FABRICATION OF ANY PART OF THE WORK. ANY DISCREPANCIES SHALL BE IMMEDIATELY BROUGHT TO THE ATTENTION OF THE ENGINEER.
- G-3. THE CONTRACTOR SHALL IMMEDIATELY INFORM THE OWNER AND OWNER'S REPRESENTATIVE OF ANY DISCREPANCIES OR ERRORS HE DISCOVERS ON THE PLAN. APPARENT CONTRADICTIONS IN CONTRACT DOCUMENTS SHALL BE RESOLVED WITH THE OWNER AND ENGINEER BEFORE AFFECTED WORK PROCEEDS.
- G-4. DEVIATION FROM THESE PLANS AND NOTES WITHOUT THE PRIOR CONSENT OF THE OWNER, OWNER'S REPRESENTATIVE AND/OR THE DESIGN ENGINEER MAY BE CAUSE FOR THE WORK TO BE UNACCEPTABLE.
- G-5. ALL TOPSOIL SHALL BE STRIPPED, STOCKPILED AND REUSED ON SITE AND MAY NOT BE TRANSPORTED OFF-SITE WITHOUT WRITTEN REQUEST AND RESPONSE FROM THE OWNER AUTHORIZING SAME.
- G-6. EXISTING SANITARY SEWERS THAT ARE TO REMAIN IN SERVICE SHALL REMAIN IN ACTIVE OPERATION AT ALL TIMES. EXISTING WATER MAINS SHALL REMAIN IN ACTIVE OPERATION EXCEPT AS NECESSARY FOR CONNECTIONS. PROVIDE A MINIMUM OF TWO WEEKS NOTICE TO THE ENGINEER AND OWNER PRIOR TO SERVICE DISRUPTIONS.
- G-7. UTILIZE A MOBILE SWEEPER AND WATER TRUCK DAILY FOR DUST CONTROL ALONG HAUL ROUTES AND IN AREAS MADE AVAILABLE FOR CONSTRUCTION.
- G-8. PREVENT WATER PONDING RESULTING FROM CONSTRUCTION OPERATIONS. PROMPTLY REMOVE ANY PONDED WATER TO THE SATISFACTION OF THE ENGINEER.
- G-9. CONTRACTOR SHALL WORK TO MINIMIZE EXCESS SOIL GENERATED. IF IT IS NECESSARY TO REMOVE SOIL FROM THE SITE, IT SHOULD BE DISPOSED OF AT A PERMITTED DISPOSAL FACILITY. PROVIDE THE NAME OF THE DISPOSAL FACILITY AND SOIL SAMPLE RESULTS 7 DAYS PRIOR TO HAULING SOIL. COPIES OF ALL BILLS-OF-LADING SHALL BE PROVIDED TO THE ENGINEER WITHIN 24 HOURS OF SOIL LEAVING THE SITE. CONTRACTOR SHALL ASSUME OWNERSHIP/RESPONSIBILITY OF EARTH OR CONCRETE SPOILS AND/OR DEBRIS GENERATED DURING CONSTRUCTION.
- G-10. ALL AREAS OUTSIDE THE LIMITS OF CONSTRUCTION WHICH ARE DAMAGED BY THE CONTRACTOR SHALL BE RESTORED TO THEIR ORIGINAL CONDITION TO THE SATISFACTION OF THE ENGINEER AND OWNER AT NO ADDITIONAL COST TO THE OWNER.
- G-11. AN INDEPENDENT GEOTECHNICAL ENGINEER RETAINED BY THE CONTRACTOR IS REQUIRED TO INSPECT, TEST, AND CERTIFY TO THE COMPACTION OF ALL LOAD BEARING FILLS.
- G-12. THE CONTRACTOR WILL INSURE THAT POSITIVE AND ADEQUATE DRAINAGE IS MAINTAINED AT ALL TIMES WITHIN THE PROJECT LIMITS. THIS MAY INCLUDE. BUT NOT BE LIMITED TO. REPLACEMENT OR RECONSTRUCTION OF EXISTING DRAINAGE STRUCTURES THAT HAVE BEEN DAMAGED OR REMOVED, OR REGRADING AS REQUIRED BY THE ENGINEER, EXCEPT FOR THOSE DRAINAGE ITEMS SHOWN AT SPECIFIC LOCATIONS AND HAVING SPECIFIC PAY ITEMS IN THE DETAILED ESTIMATE. NO SEPARATE PAYMENT WILL BE MADE FOR ANY COSTS INCURRED TO COMPLY WITH THIS REQUIREMENT.
- G-13. THE CONTRACTOR SHALL PROVIDE ANY AND ALL EXCAVATION AND MATERIAL SAMPLES NECESSARY TO CONDUCT REQUIRED SOIL TESTS. ALL ARRANGEMENTS AND SCHEDULING FOR THE TESTING SHALL BE THE CONTRACTOR'S RESPONSIBILITY.
- G-14. AN INDEPENDENT GEOTECHNICAL ENGINEER RETAINED BY THE CONTRACTOR IS REQUIRED TO INSPECT, TEST, AND CERTIFY TO THE COMPACTION OF ALL LOAD BEARING FILLS. THE SOILS ENGINEER SHALL PROVIDE COPIES OF TEST REPORTS TO THE CONTRACTOR, AND THE CONSTRUCTION MANAGER, AND SHALL PROMPTLY NOTIFY THE CONSTRUCTION MANAGER AND THE CONTRACTOR SHOULD WORK PERFORMED BY THE CONTRACTOR FAIL TO MEET THESE SPECIFICATIONS.
- G-15. CONTRACTOR SHALL FURNISH AND MAINTAIN ALL NECESSARY BARRICADES AROUND THE WORK AREA AND SHALL PROVIDE PROTECTION AGAINST WATER DAMAGE AND SOIL EROSION.
- G-16. ALL TRAFFIC CONTROL DEVICES TO BE CONSTRUCTED AND INSTALLED IN ACCORDANCE WITH "THE MANUAL ON UNIFORM TRAFFIC CONTROL DEVICES", LATEST EDITION, SIGN POSTS SHALL BE GALVANIZED STEEL AND ALL SIGN MATERIALS SHALL BE MADE OF REFLECTIVE SHEETING ON ALUMINUM BLANKS IN ACCORDANCE WITH NJDOT STANDARD SPECIFICATIONS.
- G-17. ALL DIMENSIONING IS TO CURB OR BUILDING FACE, UNLESS OTHERWISE NOTED.
- G-18. UNLESS OTHERWISE INDICATED, ALL MATERIALS AND METHODS OF CONSTRUCTION SHALL CONFORM TO THE NEW JERSEY DEPARTMENT OF TRANSPORTATION STANDARD SPECIFICATION FOR ROAD AND BRIDGE CONSTRUCTION, 2007, AS AMENDED AND SUPPLEMENTED TO DATE.
- G-19. ALL CONCRETE SHALL HAVE A MINIMUM 28-DAY COMPRESSIVE STRENGTH OF 4,000 PSI, UNLESS OTHERWISE NOTED.
- G-20. ALL NEW CONCRETE PAVING AND CURBING SHALL MEET FLUSH WITH EXISTING.
- G-21. SHOP DRAWINGS FOR PROPOSED CAST-IN-PLACE AND/OR PRECAST CONCRETE STRUCTURES SHALL BE SUBMITTED TO THE ENGINEER FOR REVIEW PRIOR TO FABRICATION OR PROCUREMENT.
- G-22. ALL UTILITIES TO BE INSTALLED UNDERGROUND EXCEPT WHERE NOTED.
- G-23. THE CONTRACTOR SHALL NOTIFY THE CAMDEN COUNTY SOIL CONSERVATION DISTRICT A MINIMUM OF 72 HOURS BEFORE THE BEGINNING OF CONSTRUCTION.
- G-24. ALL WORK SHALL COMPLY WITH APPLICABLE STATE, FEDERAL, AND LOCAL CODES, AND ALL NECESSARY LICENSES AND PERMITS SHALL BE OBTAINED BY THE CONTRACTOR AT HIS EXPENSE UNLESS PREVIOUSLY OBTAINED BY THE OWNER/DEVELOPER.
- G-25. UPON COMPLETION OF THE WORK, REMOVE ALL DEBRIS, EQUIPMENT AND UNUSED MATERIALS FROM OWNER PROPERTY AND RESTORE THE AREAS TO THEIR ORIGINAL CONDITION, AS APPROVED BY THE ENGINEER.
- G-26. ADA ACCESSIBLE PARKING SPACES SHALL HAVE A MAXIMUM 2% SLOPE IN ALL DIRECTIONS. ALL ADA ACCESSIBLE SIDEWALKS SHALL HAVE 2% MAX. CROSS SLOPE AND 5% MAX. LONGITUDINAL SLOPE.
- G-28. ALL AREAS TO RECEIVE PERMANENT BITUMINOUS PAVEMENT SHALL BE PROOF-ROLLED AND TESTED FOR 95% COMPACTION.
- G-30. TRAFFIC MARKINGS SHALL BE LONG-LIFE THERMOPLASTIC.

ENVIRONMENTAL NOTES:

SDIEZI E ARCHITECTURAL GROUD INC. CODVRIGHT @ 2023

- E-1. ALL MATERIAL BROUGHT ON SITE SHALL BE CLEAN FILL, SAMPLED, AND ANALYZED IN ACCORDANCE WITH STANDARD NJDEP QUALITY ASSURANCE STANDARDS AND PRACTICES AT A MINIMUM, AS SPECIFIED IN N.J.A.C. 7:26E, TO FULLY CHARACTERIZE THE CONTAMINANTS IN THE LATEST SOIL CLEANUP CRITERIA (SCC). THE CONTRACTOR SHALL SUBMIT TO THE OWNER WRITTEN DOCUMENTATION FROM A LABORATORY CERTIFIED IN NEW JERSEY ENVIRONMENTAL LABORATORY CERTIFICATION PROGRAM (ELCP) AND IN ACCORDANCE WITH N.J.A.C. 7:18 PRIOR TO PLACEMENT OF THE MATERIAL ON SITE. THE MATERIAL MUST NOT CONTAIN CONTAMINANTS ABOVE THE MOST RESTRICTIVE DIRECT CONTACT OR IMPACT TO GROUNDWATER (IGW) SCC.
- E-2. ALL HAZARDOUS OR REGULATED MATERIALS SHOULD BE DISPOSED OF IN ACCORDANCE WITH THE USEPA'S RESOURCE CONSERVATION AND RECOVERY ACT (RCRA) AND TRANSPORTED IN ACCORDANCE WITH ALL FEDERAL, STATE, AND LOCAL REGULATIONS.

DEMOLITION NOTES

- AND OSHA STANDARDS.
- D-2. ALL HOLES AND TRENCH AREAS REMAINING AFTER DEMOLITION SHALL BE SPECIFICATIONS.

- TO LOCATIONS SHOWN ON THE CONTRACT DRAWINGS.
- D-6. CONTRACTOR SHALL NOTIFY OWNER AND THE ENGINEER 72 HRS. PRIOR TO INITIATING UTILITY ABANDONMENT.
- FACILITY.
- APPROVALS ASSOCIATED WITH SAME.
- D-11. WHILE CONSTRUCTION ACTIVITIES ARE IN PROGRESS, AT LEAST FOUR(4) INSTRUCTED IN THE USE OF THE FIRE EXTINGUISHERS PROVIDED.
- NEAREST CONTROL JOINT.

UTILITY NOTES

- THE CONTRACTOR.
- MARKOUT CALL 1-800-272-1000.
- SUITABLE PROTECTION SHALL BE PROVIDED.
- PROPERLY CONSTRUCT THE WORK.
- OF APPROVAL WILL BE THE RESPONSIBILITY OF THE CONTRACTOR.
- OPEN EXCAVATION.
- APPROVED CONTROLLED LOW STRENGTH MATERIAL (CLSM).
- OTHERWISE NOTED.

D-1. ALL DEMOLITION WORK SHALL BE PERFORMED IN ACCORDANCE WITH NFPA 241

BACKFILLED TO MATCH EXISTING GRADE IN ACCORDANCE WITH APPLICABLE

D-3. WHERE A PIPE BEING REMOVED IS CONNECTED TO AN EXISTING STRUCTURE, EITHER REMOVE THE PIPE AND FILL THE WALL OPENING WITH CONCRETE, OR CUT THE PIPE WITHOUT PERCUSSION NOT MORE THAN 6" FROM THE OUTSIDE FACE OF THE STRUCTURE AND FILL THE REMAINING LENGTH OF PIPE WITH CONCRETE.

D-4. THE REMOVAL OF ANY EXISTING BOLLARDS. GUIDE RAIL POSTS & FOOTINGS SHALL INCLUDE THE PIPE/ POST AND CONCRETE FOOTING IN ITS ENTIRETY.

D-5. ALL EXISTING CATCH BASINS AND MANHOLES SHALL BE FIELD LOCATED PRIOR TO WORK AND THE ENGINEER SHALL BE NOTIFIED OF ANY DISCREPANCIES PERTAINING

D-7. ALL UTILITIES SHALL BE REMOVED TO A MINIMUM OF FOUR (4) FT BELOW EXISTING GROUND SURFACE. DEMOLISH FIRE HYDRANT THRUST BLOCKS IF ENCOUNTERED.

D-8. ELECTRICAL UTILITIES SHALL BE DISCONNECTED PRIOR TO BEGINNING ANY DEMOLITION WORK. DEMOLITION SHALL INCLUDE THE REMOVAL OF BURIED AND EXPOSED CONDUIT IN THE AREA DESIGNATED FOR DEMOLITION, SEALING ENDS OF ALL BURIED CONDUIT ABANDONED IN PLACE AND REMOVING ALL POWER AND CONTROL WIRING BETWEEN THE DEMOLISHED FACILITY AND THE TERMINAL JUNCTION BOX, CIRCUIT BREAKER, OR METER CONTROL CENTER SUPPLYING POWER TO THE

D-9. CONTRACTOR SHALL BE RESPONSIBLE FOR COORDINATING THE DISCONNECTION AND/OR REMOVAL OF ANY SERVICE UTILITIES ATTACHED/CONNECTED/RECIEVING/ SUPPLYING, ETC. TO ANY BUILDING AND/OR STRUCTURE NOTED HEREIN TO BE DEMOLISHED. CONTRACTOR SHALL OBTAIN ANY NECESSARY PERMITS OR

D-10. ALL ACTIVE CONSTRUCTION SITES AND LOCATIONS SHALL BE PROVIDED WITH NON-COMBUSTIBLE REFUSE CONTAINER(S) IN SUCH NUMBERS AS SHALL BE NECESSARY TO CONTAIN ALL COMBUSTIBLE REFUSE GENERATED BY THE CONSTRUCTION ACTIVITIES. ALL COMBUSTIBLE REFUSE, RUBBISH AND DEBRIS SHALL BE COLLECTED UP AND DEPOSITED IN THE CONTAINER(S) ON A DAILY BASIS. REFUSE CONTAINER(S) SHALL BE LOCATED A MINIMUM OF 20 FEET AWAY FROM ANY BUILDING. STRUCTURE, LOT LINE OR COMBUSTIBLE MATERIAL STORAGE LOCATION.

PORTABLE FIRE EXTINGUISHERS HAVING A RATING OF AT LEAST 10-A, 60-BC SHALL BE PROVIDED, AND SHALL BE MAINTAINED IN A LOCATION APPROVED BY THE FIRE OFFICIAL. PERSONNEL NORMALLY ON THE CONSTRUCTION SITE SHALL BE

D-12. CONTRACTOR IS RESPONSIBLE FOR MAINTAINING AND PROTECTING EXISTING STRUCTURES AS IDENTIFIED ON THE DEMOLITION PLAN, CS0501. THE CONTRACTOR MUST NOTIFY THE ENGINEER IF ANY DAMAGE OCCURS TO THESE ITEMS. THE ENGINEER/ OWNER WILL DETERMINE WHETHER THE DAMAGED ITEMS CAN BE REPAIRED, OR SHALL BE REPLACED AT NO ADDITIONAL COST TO THE OWNER.

D-13. PRIOR TO REMOVAL OF EXISTING FULL-DEPTH ASPHALTIC AND/OR CONCRETE PAVEMENT, CONTRACTOR SHALL SAWCUT TO FULL DEPTH TO PROVIDE A CLEAN STRAIGHT EDGE. CONCRETE SIDEWALK AND/OR CURB SHALL BE REMOVED TO THE

C-1. BEFORE STARTING WORK. CONTRACTOR SHALL FURNISH A CONSTRUCTION SCHEDULE TO THE BOROUGH OF HADDONFIELD, ALL UTILITY COMPANIES AND INTERESTED PARTIES AND THE OWNER PRIOR TO CONSTRUCTION. SCHEDULE SHALL DETAIL ALL ITEMS ASSOCIATED WITH CARRYING OUT CONTRACT, ON A DAILY BASIS. CONSTRUCTION SHALL BE SEQUENCED SUCH THAT NOT MORE THAN ONE HYDRANT IS OUT OF SERVICE AT ANY GIVEN TIME. CONTRACTOR SHALL COORDINATE DIRECTLY WITH FIRE MARSHALL WITH REGARD TO HYDRANT SERVICE INTERRUPTIONS NOT LESS THAN 3 DAYS PRIOR TO INTERRUPTION.

C-2. IT IS THE RESPONSIBILITY OF THE CONTRACTOR TO DETERMINE THE LOCATION OF ALL EXISTING UNDERGROUND UTILITIES AND TO TAKE WHATEVER STEPS NECESSARY TO PROVIDE FOR THEIR PROTECTION. THE ENGINEER HAS DILIGENTLY ATTEMPTED TO LOCATE AND INDICATE EXISTING FACILITIES ON THESE PLANS; HOWEVER, THIS INFORMATION IS SHOWN FOR THE CONTRACTOR'S CONVENIENCE ONLY. THE ENGINEER ASSUMES NO RESPONSIBILITY FOR THE LOCATIONS OF UTILITIES SHOWN OR NOT SHOWN. THE CONTRACTOR SHALL CONTACT THE UTILITY COMPANIES FOR EXACT LOCATION OF THEIR UTILITIES PRIOR TO STARTING CONSTRUCTION. IT SHALL BE THE SOLE RESPONSIBILITY OF THE CONTRACTOR TO REPAIR AND REPLACE ANY AND ALL DAMAGE MADE TO UTILITIES BY

C-3. BEFORE EXCAVATING THE PROJECT AREA THE CONTRACTOR IS TO VERIFY THE LOCATION OF ANY UNDERGROUND UTILITY (GAS MAINS, WATER MAINS, SEWER LINES, TELEPHONE LINES, ETC.). SHOULD ANY UNDERGROUND UTILITY INTERFERE WITH PROJECT CONSTRUCTION THE ENGINEER SHALL BE NOTIFIED BEFORE PROCEEDING WITH WORK. CONTRACTOR SHALL NOTIFY ALL UTILITY COMPANIES THREE (3) DAYS PRIOR TO COMMENCEMENT OF ANY EXCAVATION FOR ACCURATE FIELD LOCATIONS. FOR UTILITY

C-4. SEWERS AND WATER MAINS GENERALLY SHALL BE SEPARATED A DISTANCE OF AT LEAST 10 FEET HORIZONTALLY. IF SUCH LATERAL SEPARATION IS NOT POSSIBLE, THE PIPE SHALL BE IN SEPARATE TRENCHES WITH THE SEWER AT LEAST 18 INCHES BELOW THE BOTTOM OF THE WATER MAIN: OR SUCH OTHER SEPARATION AS APPROVED BY DEPARTMENT SHALL BE MADE. IN GENERAL, THE VERTICAL SEPARATION AT A CROSSING OF SEWER AND WATER LINE SHALL SHALL BE AT LEAST 18 INCHES. WHERE THIS IS NOT POSSIBLE, THE SEWER SHALL BE CONSTRUCTED OF DUCTILE IRON PIPE USING MECHANICAL OR SLIP-ON JOINTS FOR A DISTANCE OF AT LEAST 10FT ON EITHER SIDE OF THE CROSSING OR OTHER

C-5. PIPE BEDDING REQUIREMENTS SPECIFIED HEREIN ARE TO BE CONSIDERED AS MINIMUMS FOR RELATIVELY DRY, STABLE EARTH CONDITIONS. ADDITIONAL BEDDING SHALL BE REQUIRED FOR ROCK TRENCHES AND WET AREAS. CONTRACTOR SHALL HAVE THE RESPONSIBILITY TO PROVIDE SUCH ADDITIONAL BEDDING AS MAY BE REQUIRED TO

C-6. BACKFILL IN THE TRENCHES SHALL BE COMPACTED TO THE DENSITY OF 95% OF THEORETICAL MAXIMUM DRY DENSITY (ASTM D698). BACKFILL MATERIAL SHALL BE FREE FROM ROOTS, STUMPS, OR OTHER FOREIGN DEBRIS AND SHALL BE PLACED IN LIFTS NOT TO EXCEED 6 INCHES IN COMPACTED FILL THICKNESS. A REPORT FROM A GEOTECHNICAL ENGINEER RETAINED BY THE CONTRACTOR MAY BE REQUIRED BY THE TOWNSHIP INSPECTOR. CORRECTION OF ANY TRENCH SETTLEMENT WITHIN A YEAR FROM THE DATE

C-7. CONTRACTOR SHALL EXCAVATE ONLY ENOUGH TRENCH TO INSTALL NEW UTILITY AND BACKFILL BY THE END OF EACH WORK DAY. OPEN TRENCH SHALL NOT BE PERMITTED AT ANY TIME CONTRACTOR IS NOT ACTIVELY WORKING ON PORTION OF UTILITY REQUIRING

C-8. EXISTING MAINS TO BE ABANDONED IN PLACE SHALL BE CAPPED AND FILLED WITH AN

C-9. ALL SANITARY SEWER FORCEMAIN PIPING SHALL BE PVC CLASS 150 (DR18) AWWA C900 UNLESS OTHERWISE NOTED. ALL GRAVITY SANITARY SEWER SHALL BE SDR 26 UNLESS

- C-10. TRENCH DETAILS ARE INTENDED TO PROVIDE INFORMATION REGARDING BACKFILLING MATERIALS AND GENERAL MATERIAL DEPTHS AND PAVEMENT LIMITS ONLY. THE CONTRACTOR SHALL BE RESPONSIBLE FOR THE MEANS AND METHODS OF CONSTRUCTION AND SHALL PROVIDE APPROPRIATE SAFETY MEASURES, SHEETING, AND BRACING AS MAY BE REQUIRED DUE TO FIELD CONDITIONS. THE CONTRACTOR SHALL COMPLY WITH ALL APPLICABLE OSHA STANDARDS AND DETAILS FOR TRENCH EXCAVATION. THE DESIGN ENGINEER ASSUMES NO RESPONSIBILITY OR LIABILITY FOR FIELD CONDITIONS, TRENCHING OR BACKFILLING OPERATIONS DURING CONSTRUCTION.
- C-11. THE CONTRACTOR SHALL BE RESPONSIBLE FOR DEWATERING AND PRECLUDING ANY PONDING OF WATER IN ALL AREAS.
- C-12. CONTRACTOR MUST APPLY FOR ALL UTILITY CONNECTION APPLICATIONS. CONTRACTOR IS RESPONSIBLE FOR ALL UTILITY CONNECTION FEES FOR CONSTRUCTION.
- C-13. GAS, ELECTRIC, TELEPHONE AND CABLE TV LINES MAY BE INSTALLED BY THE RESPECTIVE UTILITY. THE EXACT LOCATION OF EACH MAIN SHALL BE COORDINATED BY THE GENERAL CONTRACTOR AND SUBMITTED TO THE DESIGN ENGINEER FOR REVIEW PRIOR TO INSTALLATION.
- C-14. EXISTING STREET SURFACES AND OTHER SURFACES DISTURBED BY THE CONSTRUCTION OF FACILITIES FOR THIS PROJECT SHALL BE RESTORED BY THE CONTRACTOR IN ACCORDANCE WITH THE REQUIREMENTS OF THE COUNTY ENGINEER.
- C-15. RESET ALL WATER VALVES BOXES, SANITARY CLEANOUTS OR VENTS, GAS VALVES, SANITARY RIMS, INLET GRATES AND ALL OTHER UTILITY BOXES OR RIMS TO NEW GRADES AS REQUIRED.
- C-16. NEW JERSEY AMERICAN WATER (NJAW) MUST BE GIVEN 48 HOURS ADVANCE NOTICE OF SANITARY SEWER/WATERMAIN WORK AND THE REPRESENTATIVES MUST WITNESS THE WORK/CONNECTION.

WATER SERVICE NOTES

- 1. ALL WATER MAIN CONNECTIONS, SERVICE LINES, AND HYDRANTS SHALL BE IN CONFORMANCE WITH STANDARDS SET FORTH BY NEW JERSEY AMERICAN WATER (NJAW). CONTRACTOR MUST CONTACT NJAW PRIOR TO ANY WATER MAIN CONSTRUCTION OR CONNECTIONS.
- 2. ALL WATER MAINS SHALL BE CEMENT-LINED DUCTILE IRON PIPE CONFORMING TO ANSI A.21.51 (AWWA C151), CLASS 52 WITH EITHER MECHANICAL OR PUSH-ON JOINTS. RETAINER GLANDS AND CONCRETE THRUST BLOCKS OR TIE RODS AND CONCRETE THRUST BLOCKS SHALL BE USED AT ALL LOCATIONS WHERE RESTRAINTS ARE REQUIRED. ALL MAINS/SERVICES LESS THAN 3" SHALL BE TYPE "K" SOFT COPPER
- 3. A MINIMUM OF FOUR (4) FEET OF COVER SHALL BE PROVIDED OVER WATER LINES. IF THIS COVER CANNOT BE MAINTAINED, THE LINES SHALL BE ENCASED IN CONCRETE UNTIL FOUR (4) FEET OF COVER OBTAINED.
- ALL FITTINGS SHALL HAVE MECHANICAL JOINTS AND RETAINER GLANDS.
- 5. APPLICANT TO COORDINATE WATER SERVICE AND CONSTRUCTION WITH NJAW.
- 6. WATER AND SEWER SERVICES WILL BE SUBJECT TO THE APPLICABLE DISINFECTION AND PRESSURE TESTING REQUIREMENTS OF NJAW AND AWWA.
- 7. THRUST BLOCKS AND RESTRAINTS SHALL BE INSTALLED AT ALL BENDS AND FITTINGS. THRUST BLOCKS SHALL HAVE TWENTY-EIGHT (28) DAY STRENGTH OF 4,000 P.S.I.

8. TREES SHALL BE PLANTED A MIN. OF 10' FROM FIRE HYDRANTS AND WATER LINES. HIGH-VOLTAGE PROXIMITY ACT

THE CONTRACTOR IS NOTIFIED THAT ALL PROVISIONS OF THE HIGH-VOLTAGE PROXIMITY ACT, P.L. 1948, c. 249 AS AMENDED THROUGH MAY 20, 1987 SHALL BE STRICTLY ADHERED TO. THE CONTRACTOR SHALL ALSO ADHERE TO ALL PROVISIONS OF PART 1926.550, SUBPART N OF THE FEDERAL OCCUPATIONAL SAFETY AND HEALTH ACT OF DECEMBER, 1970. PARTICULAR ATTENTION IS DIRECTED TO THE PROVISIONS OF THE ABOVE ACT REQUIRED WARNING SIGNS, NOTIFICATION TO POWER COMPANY AND RESPONSIBILITY FOR SAFEGUARDS AND ALSO PROHIBITED ACTIVITY.

A COPY OF THE HIGH-VOLTAGE PROXIMITY ACT IS AVAILABLE IN THE OFFICE OF THE COUNTY ENGINEER OR MAY BE OBTAINED FROM THE NEW JERSEY DEPARTMENT OF LABOR, DIVISION OF WORKPLACE STANDARDS, OFFICE OF SAFETY COMPLIANCE, TRENTON, NJ 08625

SITE SAFETY

PURSUANT TO NJAC 5:23-2.21(e) OF THE NEW JERSEY UNIFORM CONSTRUCTION CODE AND CFR 1926.32 (f) (OSHA COMPETENT PERSON), THE GENERAL CONTRACTOR IS DESIGNATED AS THE "RESPONSIBLE PERSON IN CHARGE OF CONSTRUCTION" AND THE SITE SUPERVISOR RESPONSIBLE FOR CONSTRUCTION SITE SAFETY DURING THE COURSE OF SITE IMPROVEMENTS.

SITE/SURVEY NOTES:

- A FIELD SURVEY OF THE SITE WAS PERFORMED BY PENNONI ASSOCIATES IN 11/17/2023
- LOCATIONS OF ON AND OFF SITE UTILITIES AS SHOWN ARE APPROXIMATE AND MAY OR MAY 2. NOT BE COMPLETE. THE NATURE AND EXACT LOCATION OF EXISTING UTILITIES SHOULD BE VERIFIED PRIOR TO INITIATING ANY ACTIVITY THAT MAY AFFECT THEIR USE OR LOCATION. ALL LOCATIONS ILLUSTRATED ARE BASED UPON UTILITY MARKOUT AND ABOVE GROUND STRUCTURES THAT WERE VISIBLE AND ACCESSIBLE IN THE FIELD. THE STATE OF NEW JERSEY REQUIRES NOTIFICATION PRIOR TO ANY EXCAVATION BY UTILIZING THE NEW JERSEY ONE-CALL SYSTEM (1-800-272-1000).
- VERTICAL DATUM, IS NORTH AMERICAN VERTICAL DATUM 1988 (NAVD 88) (GEOID 18).
- 4. HORIZONTAL COORDINATE DATUM IS IN NEW JERSEY STATE PLANE COORDINATE SYSTEM NORTH AMERICAN DATUM 1983 (NJSPCS NAD 83) (2011).

APPLICANT/ OWNER:

BOROUGH OF HADDONFIELD 242 KINGS HIGHWAY EAST HADDONFIELD, NJ 08033

UTILITIES LIST

ALL DESIGNERS AND CONTRACTORS UTILIZING THIS PLAN AND THE INFORMATION CONTAINED THEREON ARE CAUTIONED TO COMPLY WITH THE REQUIREMENTS OF NEW JERSEY ACT 287, AMENDED BY ACT 187 ENTITLED "UNDERGROUND" UTILITY LINE PROTECTION".

PSE&G **2 RIVERSIDE DRIVE** ONE PORT CENTER SUITE 110 CAMDEN, NJ 08103 (800) 553-7734

COMCAST CABLE COMPANY 1250 HADDONFIELD-BERLIN ROAD CHERRY HILL, NJ 08034 (856) 893-2900

NEW JERSEY AMERICAN WATER (WATER AND SEWER) 131 WOODCREST ROAD CHERRY HILL, NJ 08003-3620 (856) 310-2206

VERIZON 713 MARSHA AVENUE WILLIAMSTOWN, NJ 08094 (856) 728-9988

AND OWNER MUST BE NOTIFIED OF ANY DISCREPANCIES BEFORE PROCEEDING WITH WORK ALL DOCUMENTS PREPARED BY PENNONI ASSOCIATES ARE INSTRUMENTS OF SERVICE IN RESPECT OF THE PROJECT. THEY ARE NOT INTENDED OR REPRESENTED. TO BE SUITABLE FOR REUSE BY OWNER OR OTHERS ON THE EXTENSIONS OF THE PROJECT OR ON ANY OTHER PROJECT. ANY REUSE WITHOUT WRITTEN VERIFICATION OR ADAPTATION BY PENNONI ASSOCIATES FOR THE SPECIFIC PURPOSE INTENDED WILL BE AT OWNERS SOLE RISK AND WITHOUT LIABILITY OR LEGAL EXPOSURE TO PENNONI ASSOCIATES; AND OWNER SHALL INDEMNIFY AND HOLD HARMLESS PENNON ASSOCIATES FROM ALL CLAIMS, DAMAGES, LOSSES AND EXPENSES ARISING OUT OF OR RESULTING THEREFROM

ALL DIMENSIONS MUST BE VERIFIED BY CONTRACTOR

	LEGEND		CODE REVIEW:
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D D OE OE	STORM SEWER OVERHEAD ELECTRIC	D D	SPIEZLE ARCHITECTURAL GROUP INC. 121 MARKET STREET
UE UE	UNDERGROUND ELECTRIC	ОЕ ОЕ Е Е	CAMDEN, NJ 08102 PHONE: (866) 974 7666
OTOT	OVERHEAD TELEPHONE	то то	SIGNATURE:
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TVB	CABLE TV JUNCTION BOX		STEVEN G. SIEGEL 21AI01564200 ANGELO ALBERTO 21AI01046700 JOHN F. WRIGHT 21AI01784200 SPIEZLE ARCHITECTURAL GROUP, INC. 21AC00063000
(VI)	CABLE TV MANHOLE	(V)	SEAL:
\odot	COMMUNICATIONS MANHOLE	\bigcirc	JACQUELINE R BERENATO
	COMMUNICATIONS HANDHOLE		PROFESSIONAL ENGINEER NEW JERSEY LICENSE NO. GE 56282
	GAS VALVE		
Ē	ELECTRICAL HANDHOLE	Ē	Jacqueline Berenato 2/23/24
$\langle \rangle$	ELECTRICAL METER	Í	
EPB	ELECTRICAL PANEL BOX	EPB	FOR BID 06/25/2024
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(\mathbb{W})	WATER MANHOLE	(W)	CAMDEN, NEW JERSEY 08102
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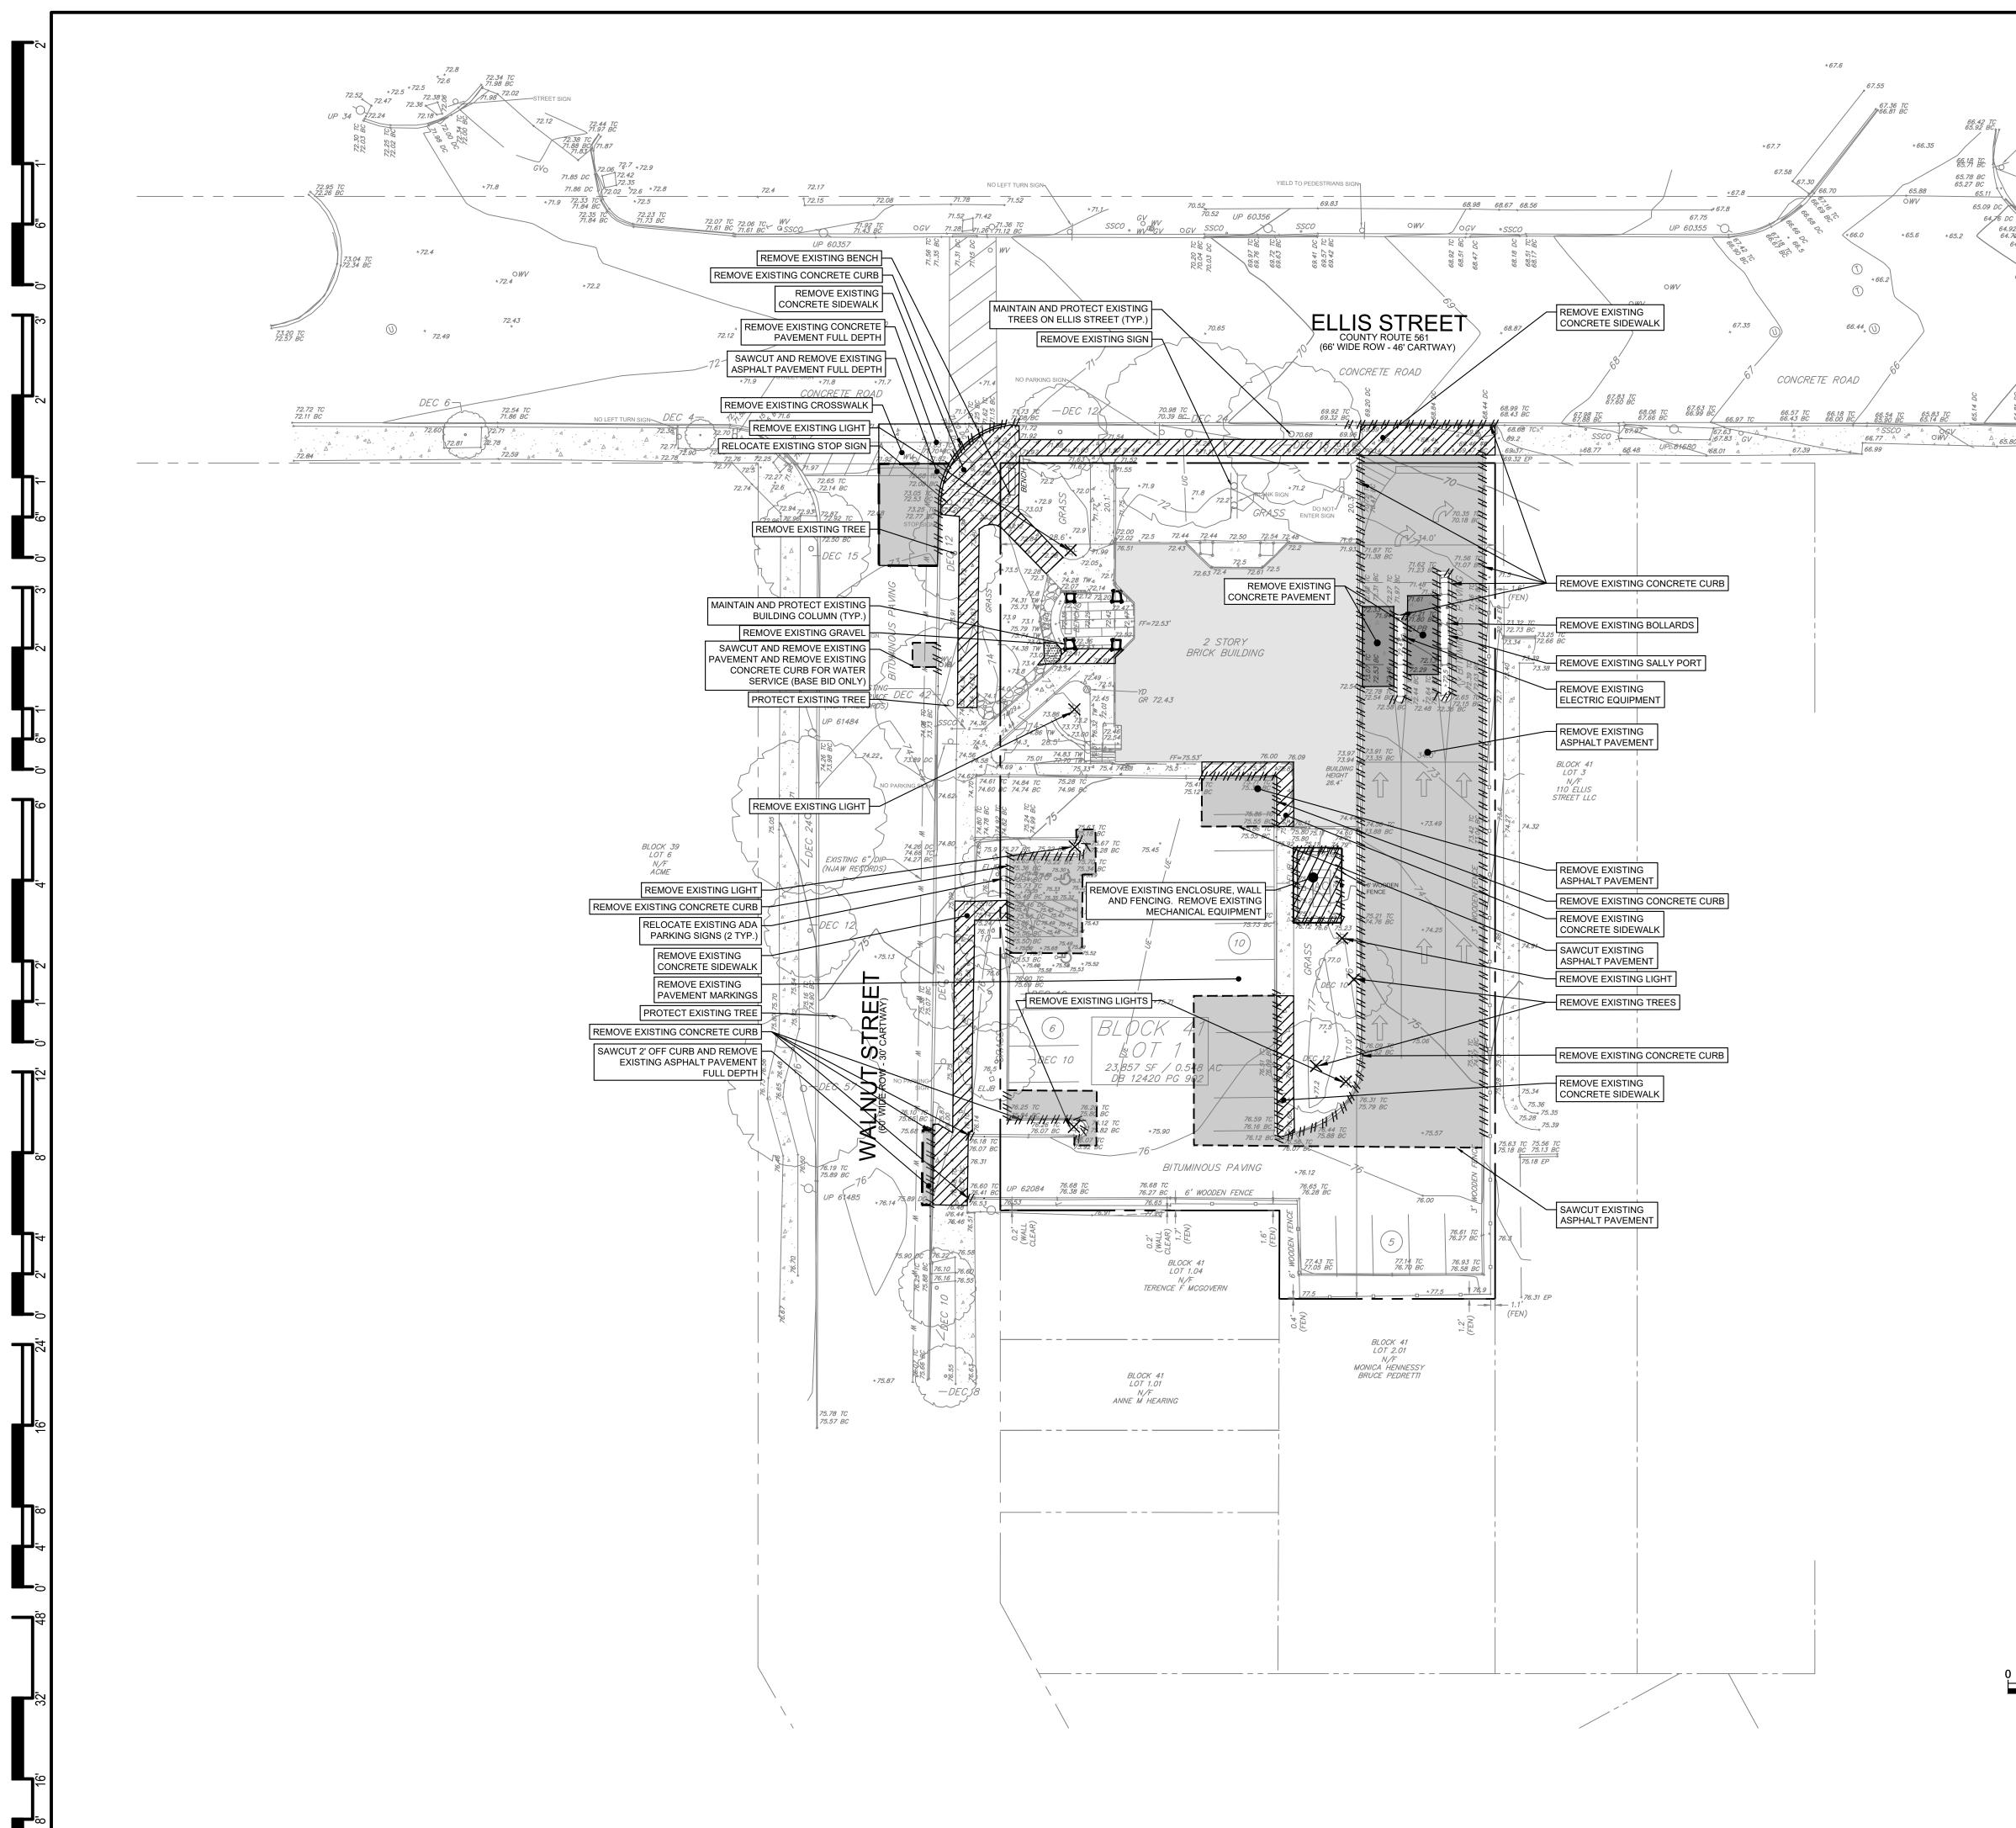
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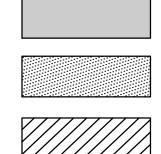
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SPIEZLE ARCHITECTURAL GROUP INC. 121 MARKET STREET CAMDEN, NJ 08102 PHONE: (866) 974 7666	
SIGNATURE: THOMAS S. PERRINO 21AI01505400 SCOTT E. DOWNIE 21AI01674400 STEVEN LEONE 21AI0167400 STEVEN G. SIEGEL 21AI01564200 ANGELO ALBERTO 21AI01046700 JOHN F. WRIGHT 21AI01784200 SPIEZLE ARCHITECTURAL GROUP, INC. 21AC00063000	,
SEAL: JACQUELINE R BERENATO PROFESSIONAL ENGINEER NEW JERSEY LICENSE NO. GE 56282)
Gacqueline Berenato 2/23/24	
FOR BID 06/25/2024	
PROJECT: HADDONFIELD POLICE STATION	
1 WALNUT STREET HADDONFIELD, NEW JERSEY 08033 FOR	
CAMDEN COUNTY IMPROVEMENT AUTHORITY	
520 MARKET STREET, 6TH FLOOR CAMDEN, NEW JERSEY 08102	
FOR CODE REVIEW: 02/23/24 REVISIONS:	
REVISION NAME DATE FOR BID: 05/30/24	
DRAWING TITLE:	
COMMISSION NUMBER: 23M014	I
DRAWING NUMBER:	
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CODE REVIEW:

DEMOLITION LEGEND



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REMOVE EXISTING CONCRETE PAVEMENT

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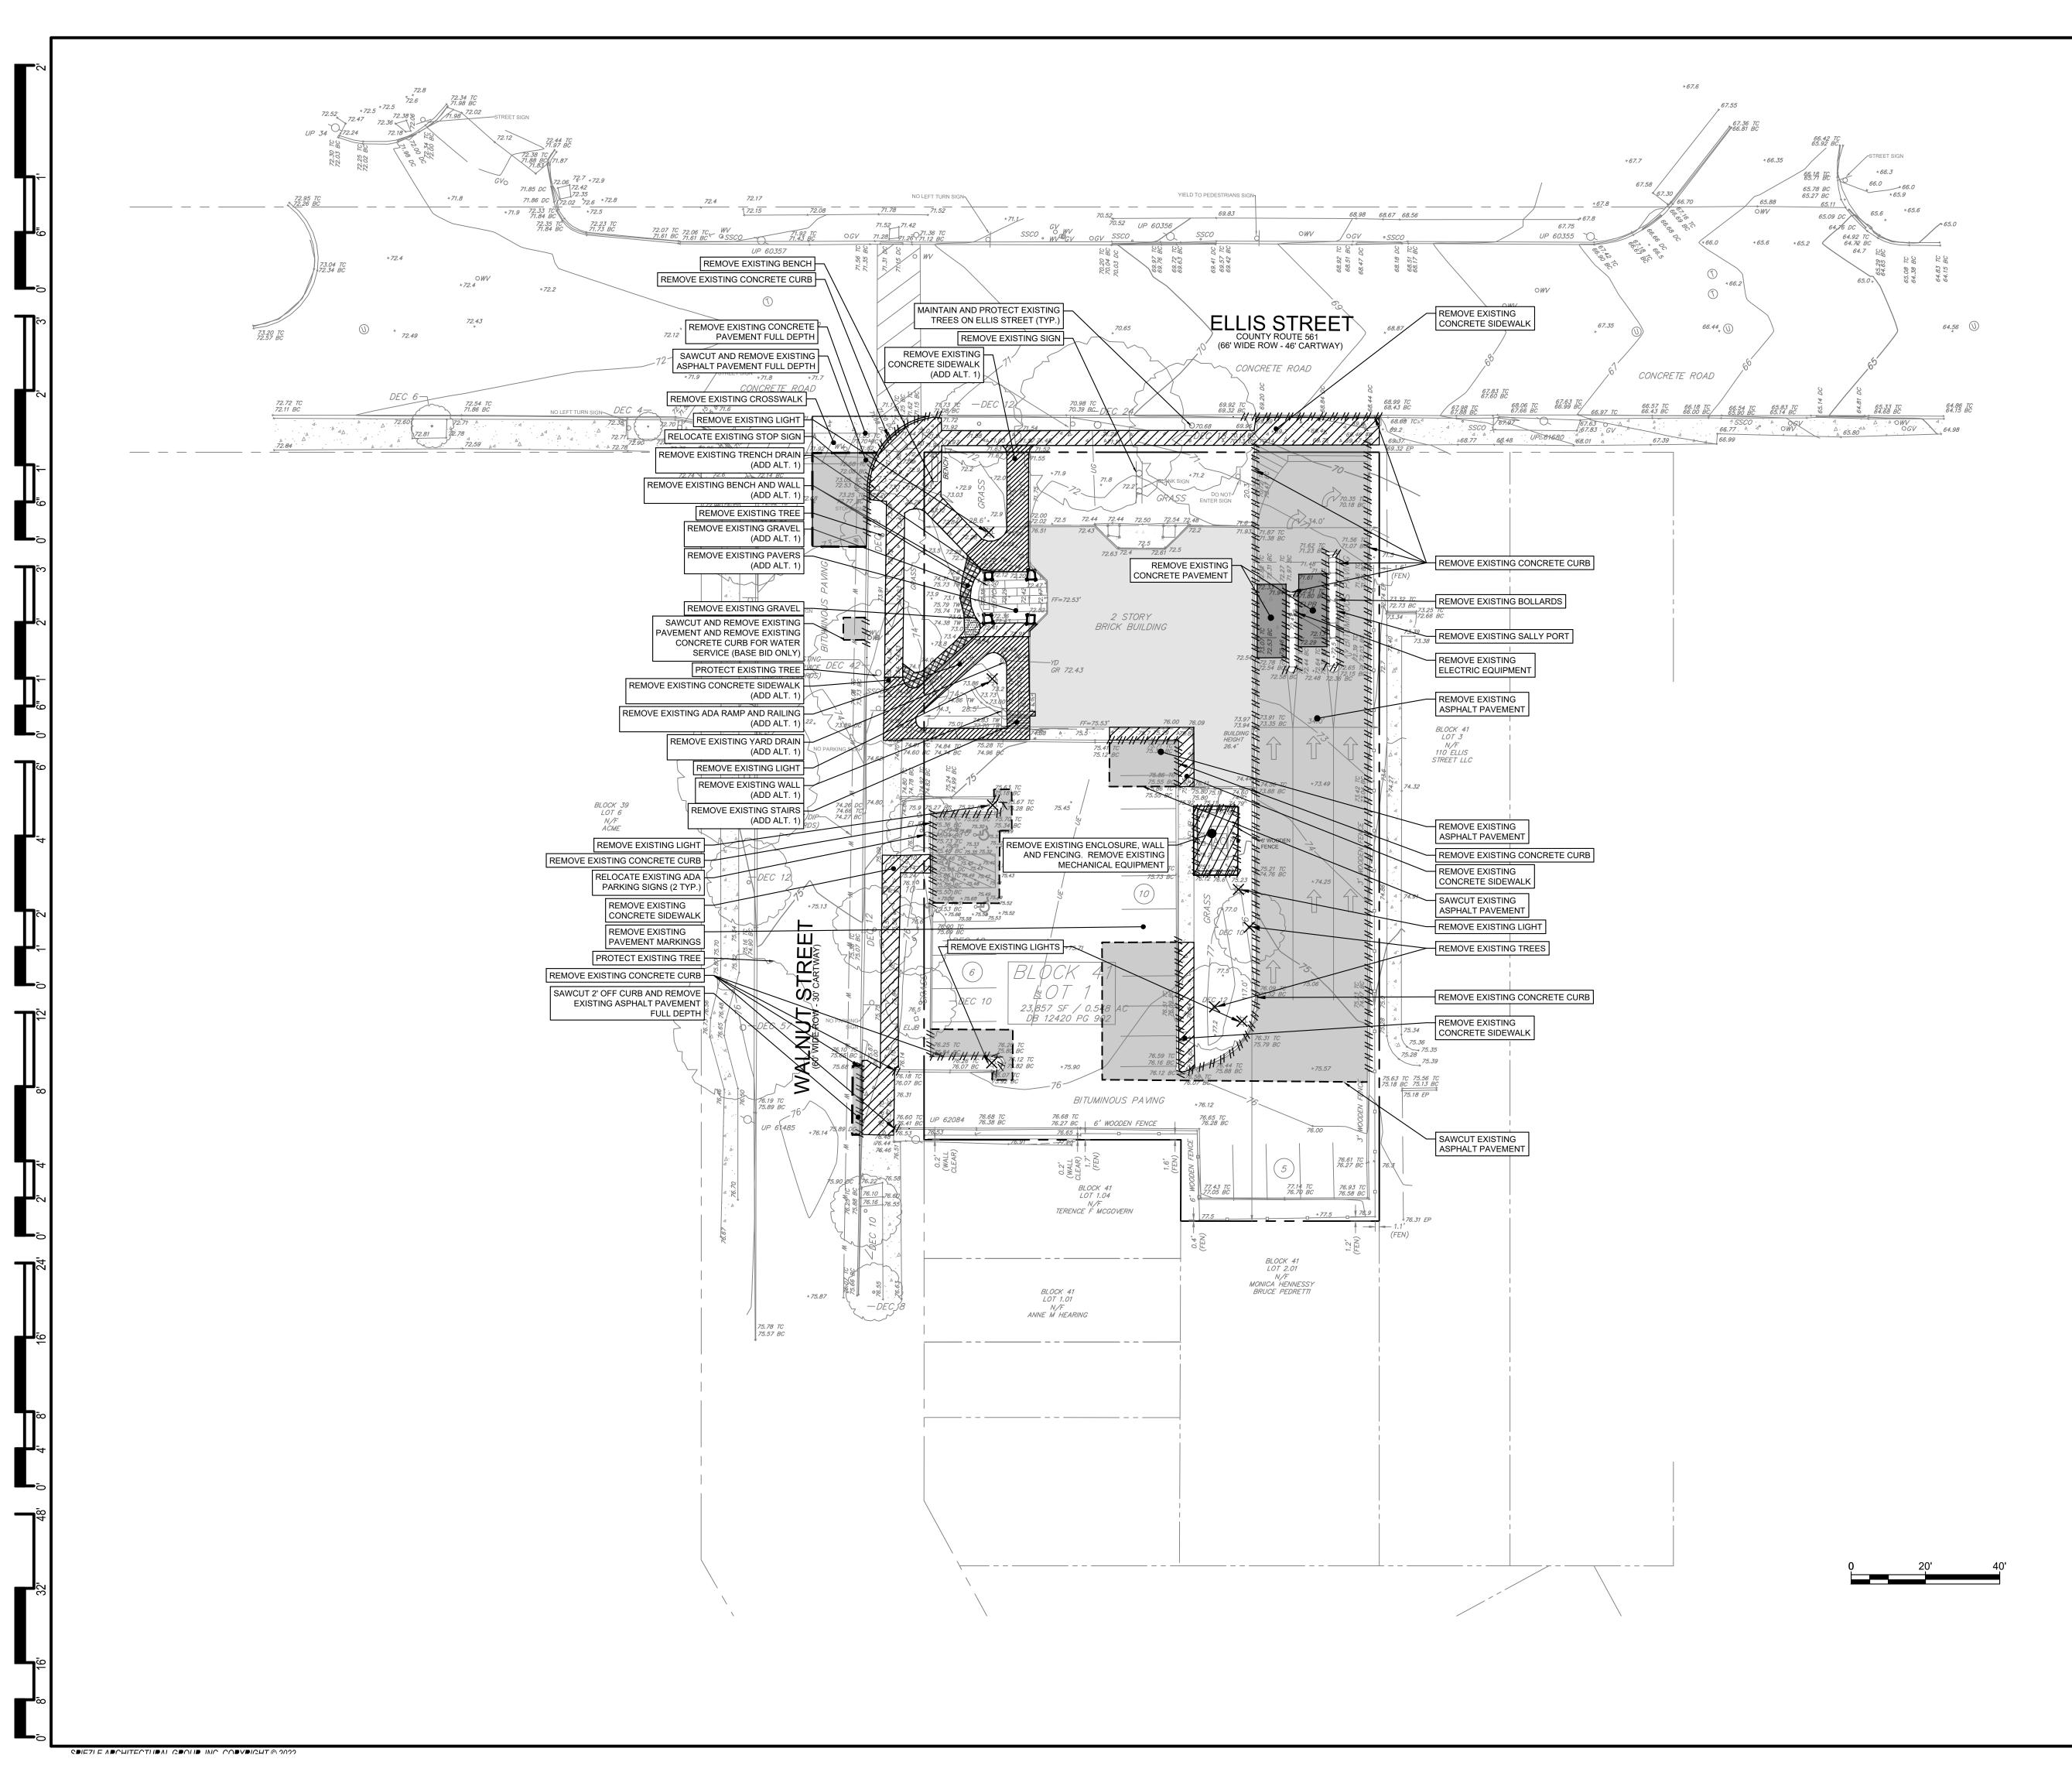
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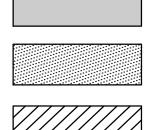
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CERTIFICATE:
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SPIEZLE ARCHITECTURAL GROUP INC. 121 MARKET STREET CAMDEN, NJ 08102 PHONE: (866) 974 7666
SIGNATURE:THOMAS S. PERRINO21AI01505400SCOTT E. DOWNIE21AI01674400STEVEN LEONE21AI01564200STEVEN G. SIEGEL21AI01564200ANGELO ALBERTO21AI01784200JOHN F. WRIGHT21AI01784200SPIEZLE ARCHITECTURAL GROUP, INC.21AC00063000
SEAL: JACQUELINE R BERENATO PROFESSIONAL ENGINEER NEW JERSEY LICENSE NO. GE 56282
Jacqueline Berenato 2/23/24
FOR BID 06/25/2024
PROJECT: HADDONFIELD POLICE STATION
1 WALNUT STREET HADDONFIELD, NEW JERSEY 08033
FOR CAMDEN COUNTY IMPROVEMENT AUTHORITY
520 MARKET STREET, 6TH FLOOR CAMDEN, NEW JERSEY 08102
FOR CODE REVIEW: 02/23/24 REVISIONS:
REVISION NAME DATE
FOR BID: 05/30/24 DRAWING TITLE:
DEMOLITION PLAN- ADD ALT AND BASE BID
COMMISSION NUMBER: 23M014
DRAWING NUMBER:
CS0502

CODE REVIEW:

DEMOLITION LEGEND



REMOVE EXISTING GRAVEL

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ASPHALT PAVEMENT

REMOVE EXISTING CONCRETE PAVEMENT


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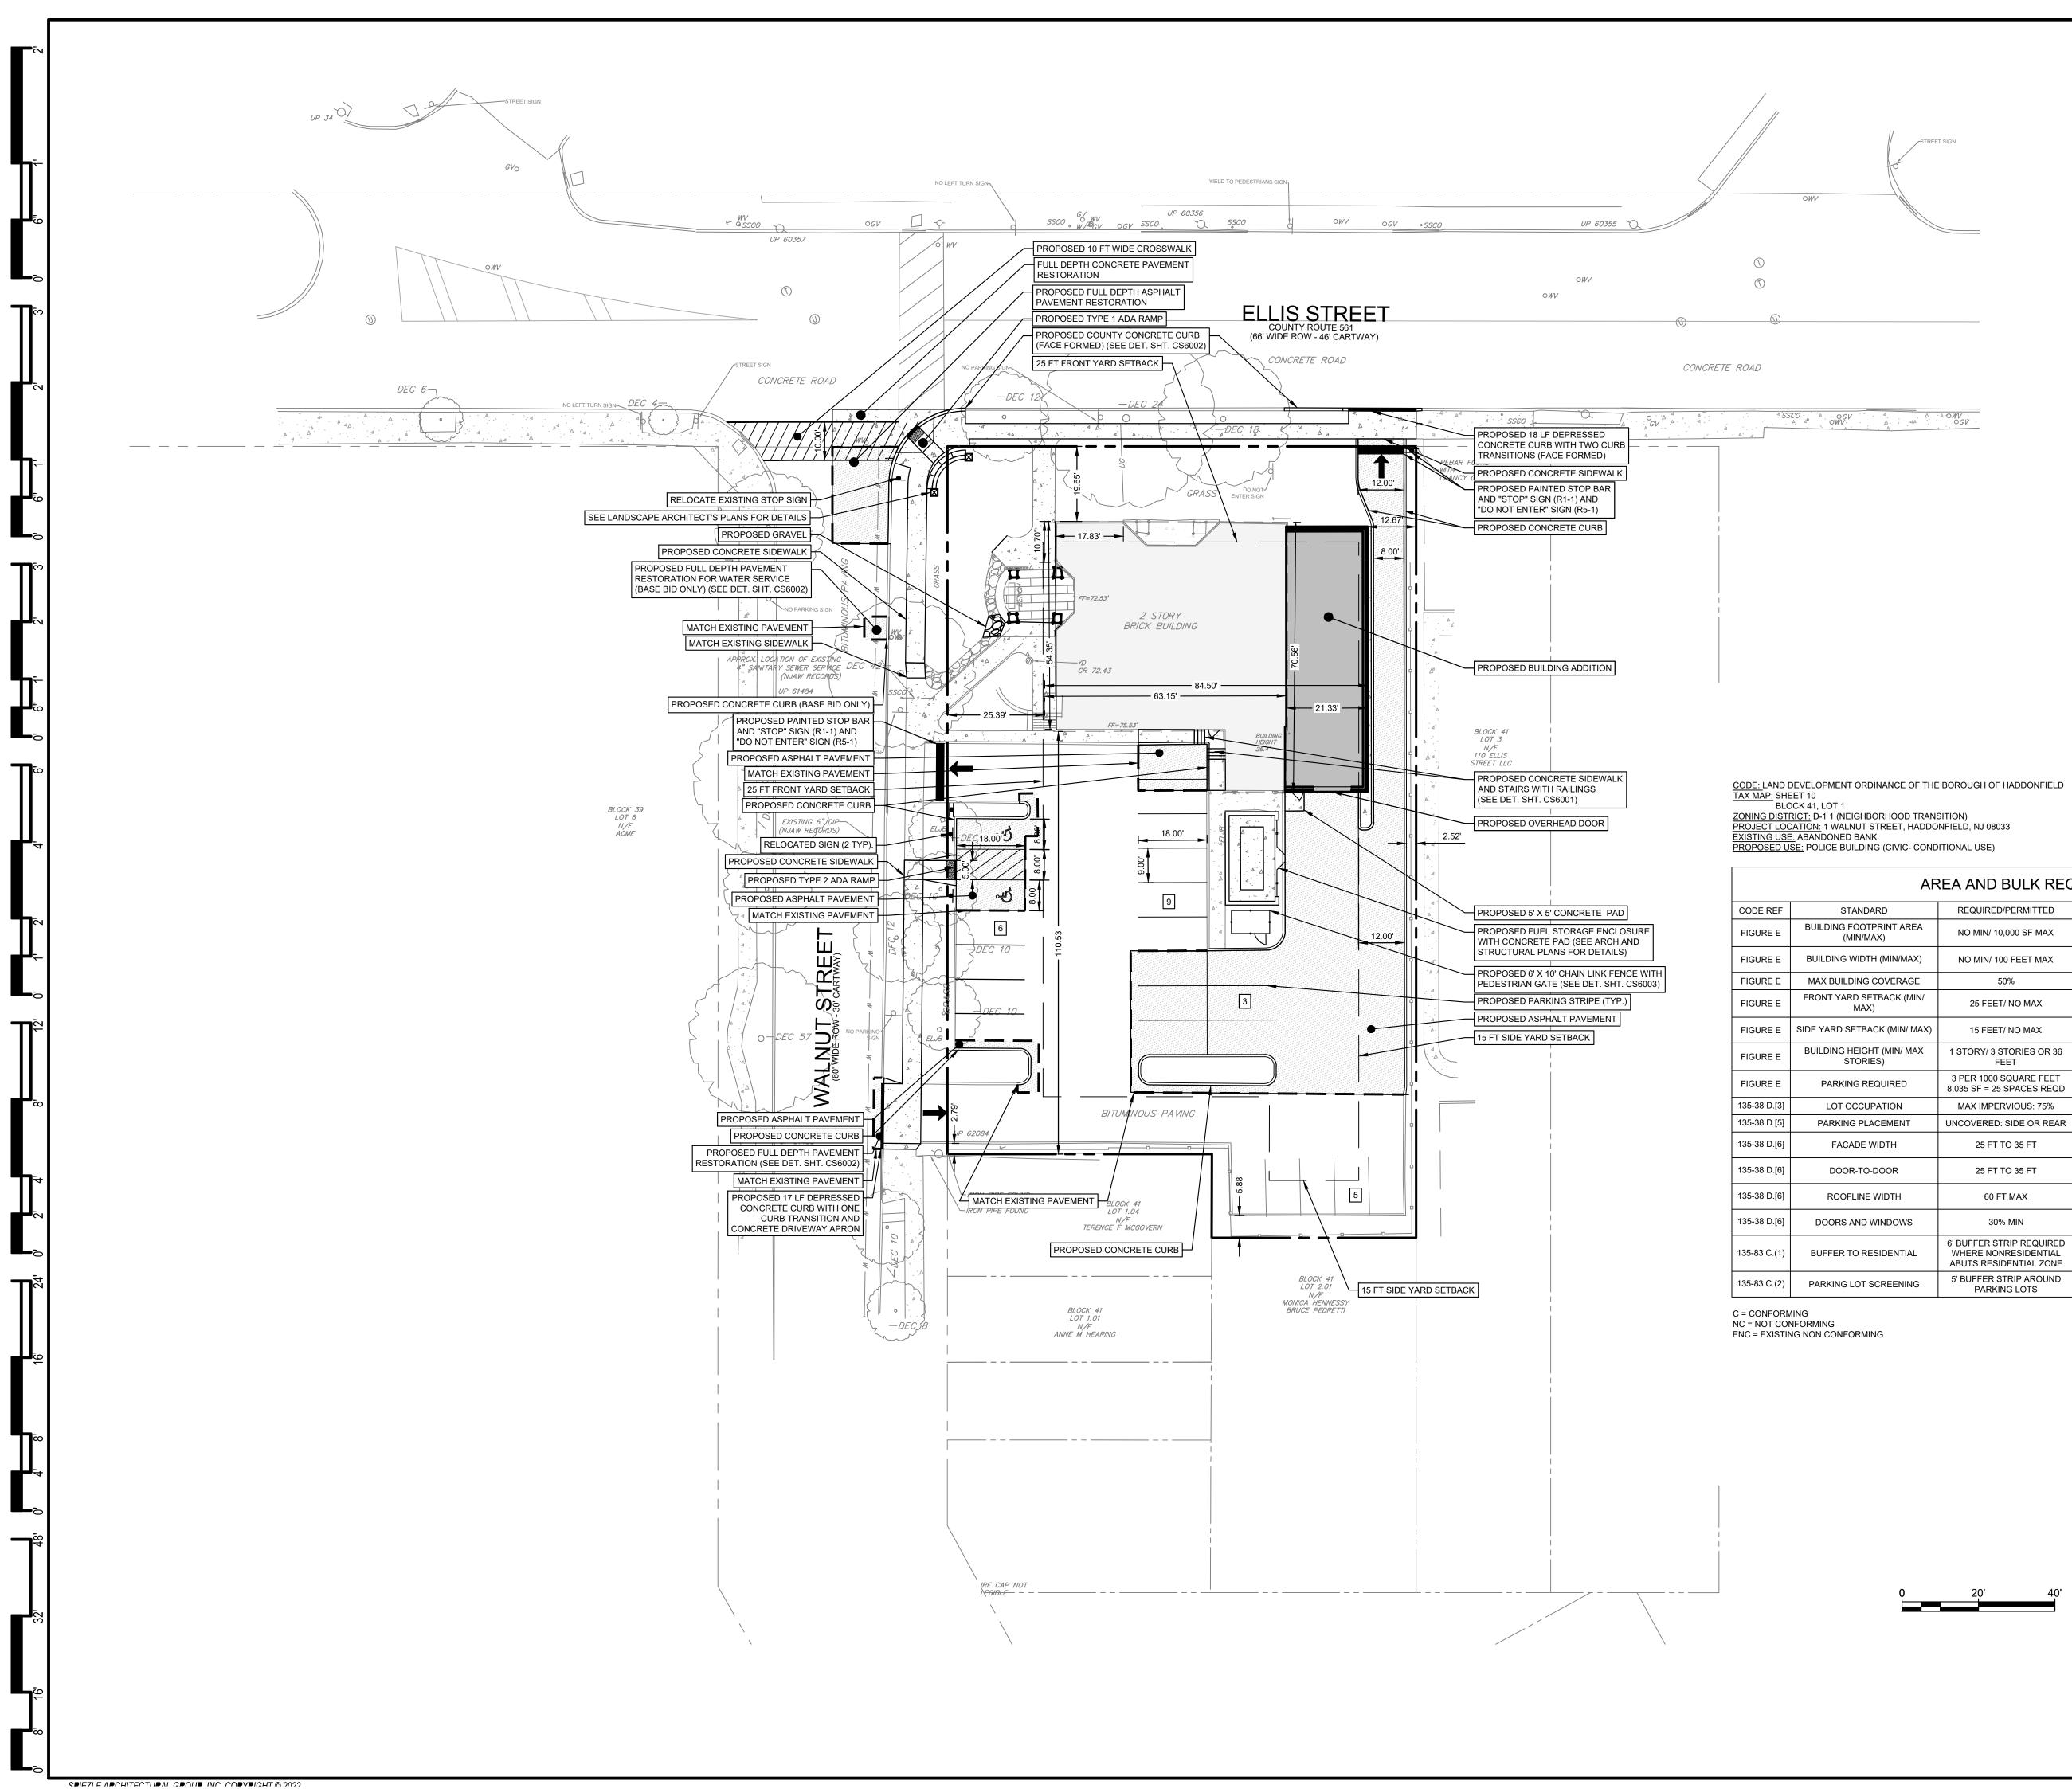
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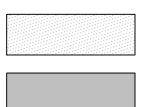


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AREA AND BULK REQUIREMENTS

	REQUIRED/PERMITTED	EXISTING	PROPOSED	CONFORMANCE
REA	NO MIN/ 10,000 SF MAX	3,574 SF	5,066 SF	С
ЛАХ)	NO MIN/ 100 FEET MAX	63.15 FT - ELLIS 70.56 FT - WALNUT	84.50 FT - ELLIS 70.56 FT - WALNUT	С
AGE	50%	15.0%	21.2%	С
(MIN/	25 FEET/ NO MAX	19.65 FT- ELLIS 25.39 FT- WALNUT	19.65 FT- ELLIS 25.39 FT- WALNUT	ENC - ELLIS
I/ MAX)	15 FEET/ NO MAX	11.56 FT- EAST 110.53 FT- SOUTH	12.67 FT- EAST 110.53 FT- SOUTH	ENC-EAST
MAX	1 STORY/ 3 STORIES OR 36 FEET	2 STORIES	2 STORIES	С
C	3 PER 1000 SQUARE FEET 8,035 SF = 25 SPACES REQD	21 SPACES	23 SPACES	NC
	MAX IMPERVIOUS: 75%	82.2%	82.2%	ENC
IT	UNCOVERED: SIDE OR REAR	FRONT AND SIDE	FRONT AND SIDE	ENC
	25 FT TO 35 FT	17.83 FT - ELLIS 10.70 FT- WALNUT	17.83 FT - ELLIS 10.70 FT - WALNUT	ENC
	25 FT TO 35 FT	NO DOORS - ELLIS 1 DOOR - WALNUT	NO DOORS - ELLIS 1 DOOR - WALNUT	ENC
	60 FT MAX	63.15 FT - ELLIS 54.35 FT - WALNUT	63.15 FT - ELLIS 54.35 FT - WALNUT	ENC
VS	30% MIN	10.73% - ELLIS 16% - WALNUT	9.01% - ELLIS 16% - WALNUT	NC
IAL	6' BUFFER STRIP REQUIRED WHERE NONRESIDENTIAL ABUTS RESIDENTIAL ZONE	2.79'	2.79'	ENC
ling	5' BUFFER STRIP AROUND PARKING LOTS	2.79'	2.79'	ENC


SITE PLAN LEGEND

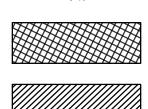

PROPOSED ASPHALT PAVEMENT


PROPOSED BUILDING ADDITION

ODE REVIEW:
CERTIFICATE:
SPIEZLE ARCHITECTURAL GROUP INC.
121 MARKET STREET CAMDEN, NJ 08102
PHONE: (866) 974 7666
SIGNATURE:
THOMAS S. PERRINO 21AI01505400 SCOTT E. DOWNIE 21AI01674400
STEVEN LEONE 21AI01170100 STEVEN G. SIEGEL 21AI01564200 ANGELO ALBERTO 21AI01046700
JOHN F. WRIGHT 21AI01784200 SPIEZLE ARCHITECTURAL GROUP, INC. 21AC00063000
SEAL:
JACQUELINE R BERENATO
NEW JERSEY LICENSE NO. GE 56282
<i>, ,</i>
Jacqueline Berenato 2/23/24
FOR BID
06/25/2024
PROJECT:
HADDONFIELD POLICE
HADDONFIELD POLICE STATION 1 WALNUT STREET
HADDONFIELD POLICE STATION
HADDONFIELD POLICE STATION 1 WALNUT STREET
HADDONFIELD POLICE STATION 1 WALNUT STREET HADDONFIELD, NEW JERSEY 08033 FOR
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	SPIEZLE ARCHITECTURAL GROUP INC.
	121 MARKET STREET CAMDEN, NJ 08102
	PHONE: (866) 974 7666
	SIGNATURE:
	THOMAS S. PERRINO 21AI01505400 SCOTT E. DOWNIE 21AI01674400 STEVEN LEONE 21AI01170100
	STEVEN G. SIEGEL 21AI01564200 ANGELO ALBERTO 21AI01046700 JOHN F. WRIGHT 21AI01784200 STEVEN F. MERGET 21400782000
	SPIEZLE ARCHITECTURAL GROUP, INC. 21AC00063000
	JACQUELINE R BERENATO PROFESSIONAL ENGINEER
	NEW JERSEY LICENSE NO. GE 56282
	a l'a tralada
	Jacqueline Berenato 2/23/24
	FOR BID
	06/25/2024
	PROJECT:
	HADDONFIELD POLICE
	STATION
	1 WALNUT STREET
	HADDONFIELD, NEW JERSEY 08033
	FOR
	CAMDEN COUNTY
	IMPROVEMENT
	AUTHORITY
	520 MARKET STREET, 6TH FLOOR
	CAMDEN, NEW JERSEY 08102
	FOR CODE REVIEW: 02/23/24
	REVISIONS:
	REVISION NAME DATE
	FOR BID: 05/30/24
	DRAWING TITLE:
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	SITE PLAN- ADD ALT AND
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	COMMISSION NUMBER:
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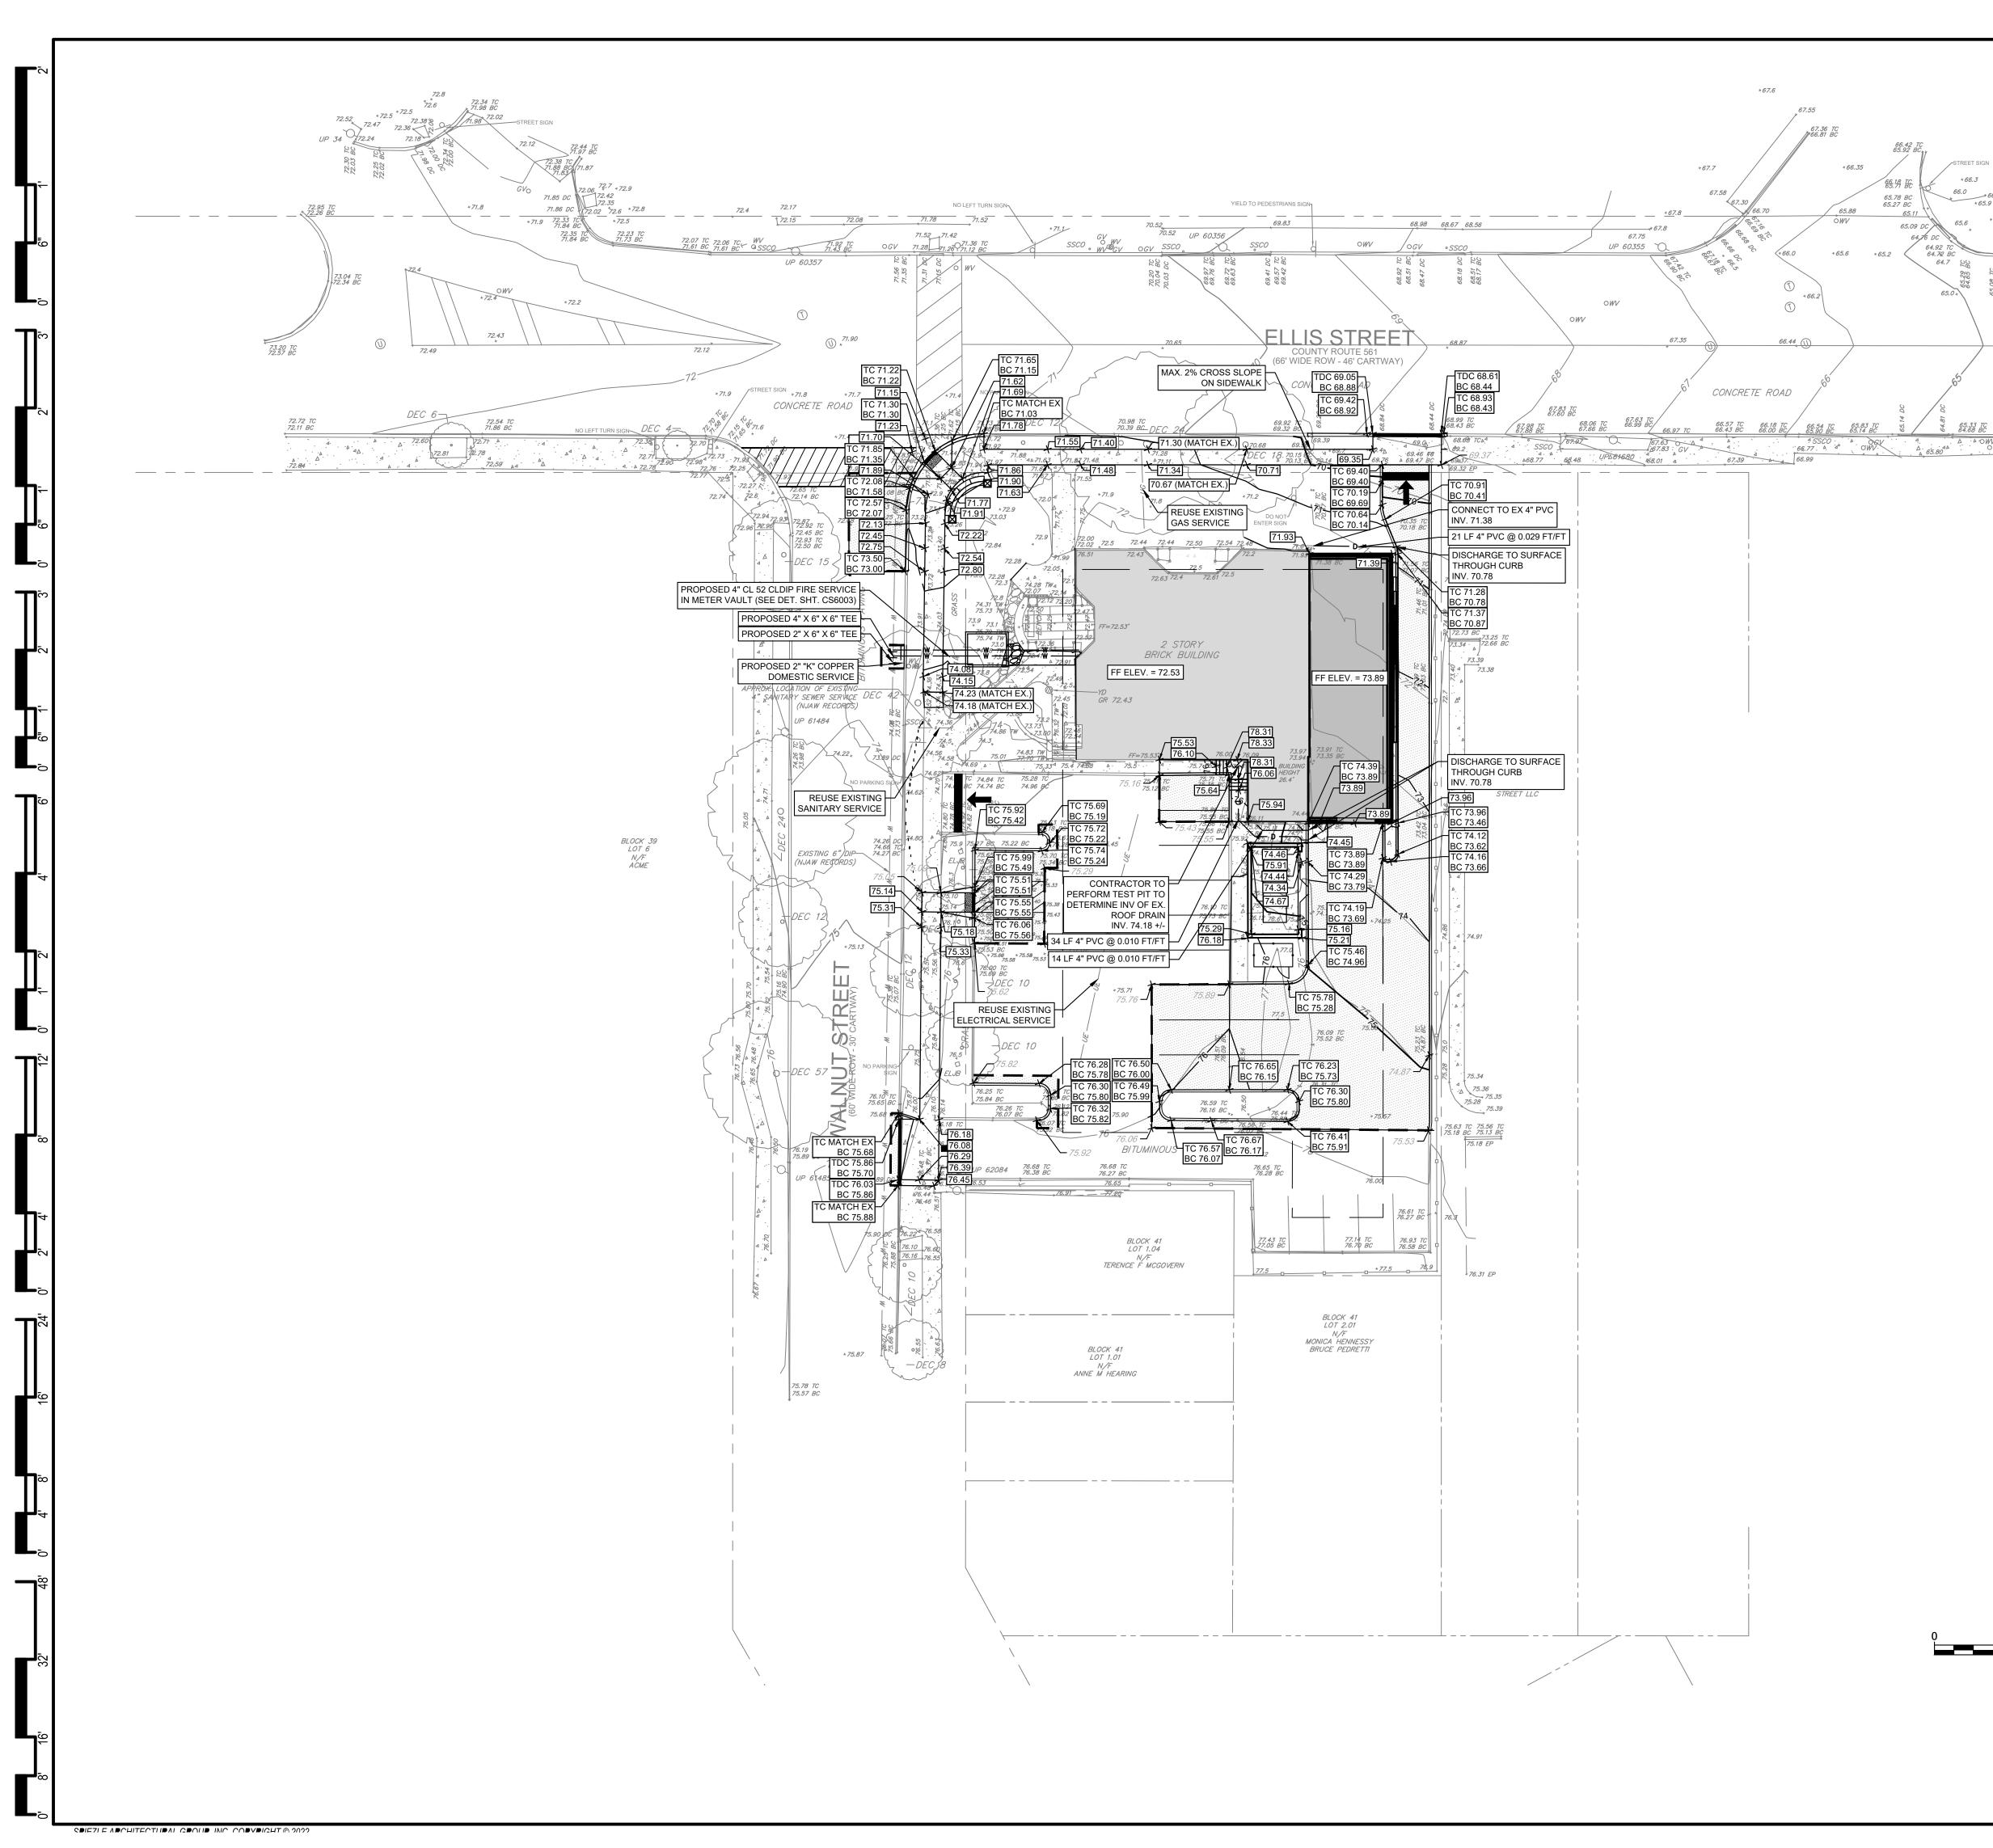
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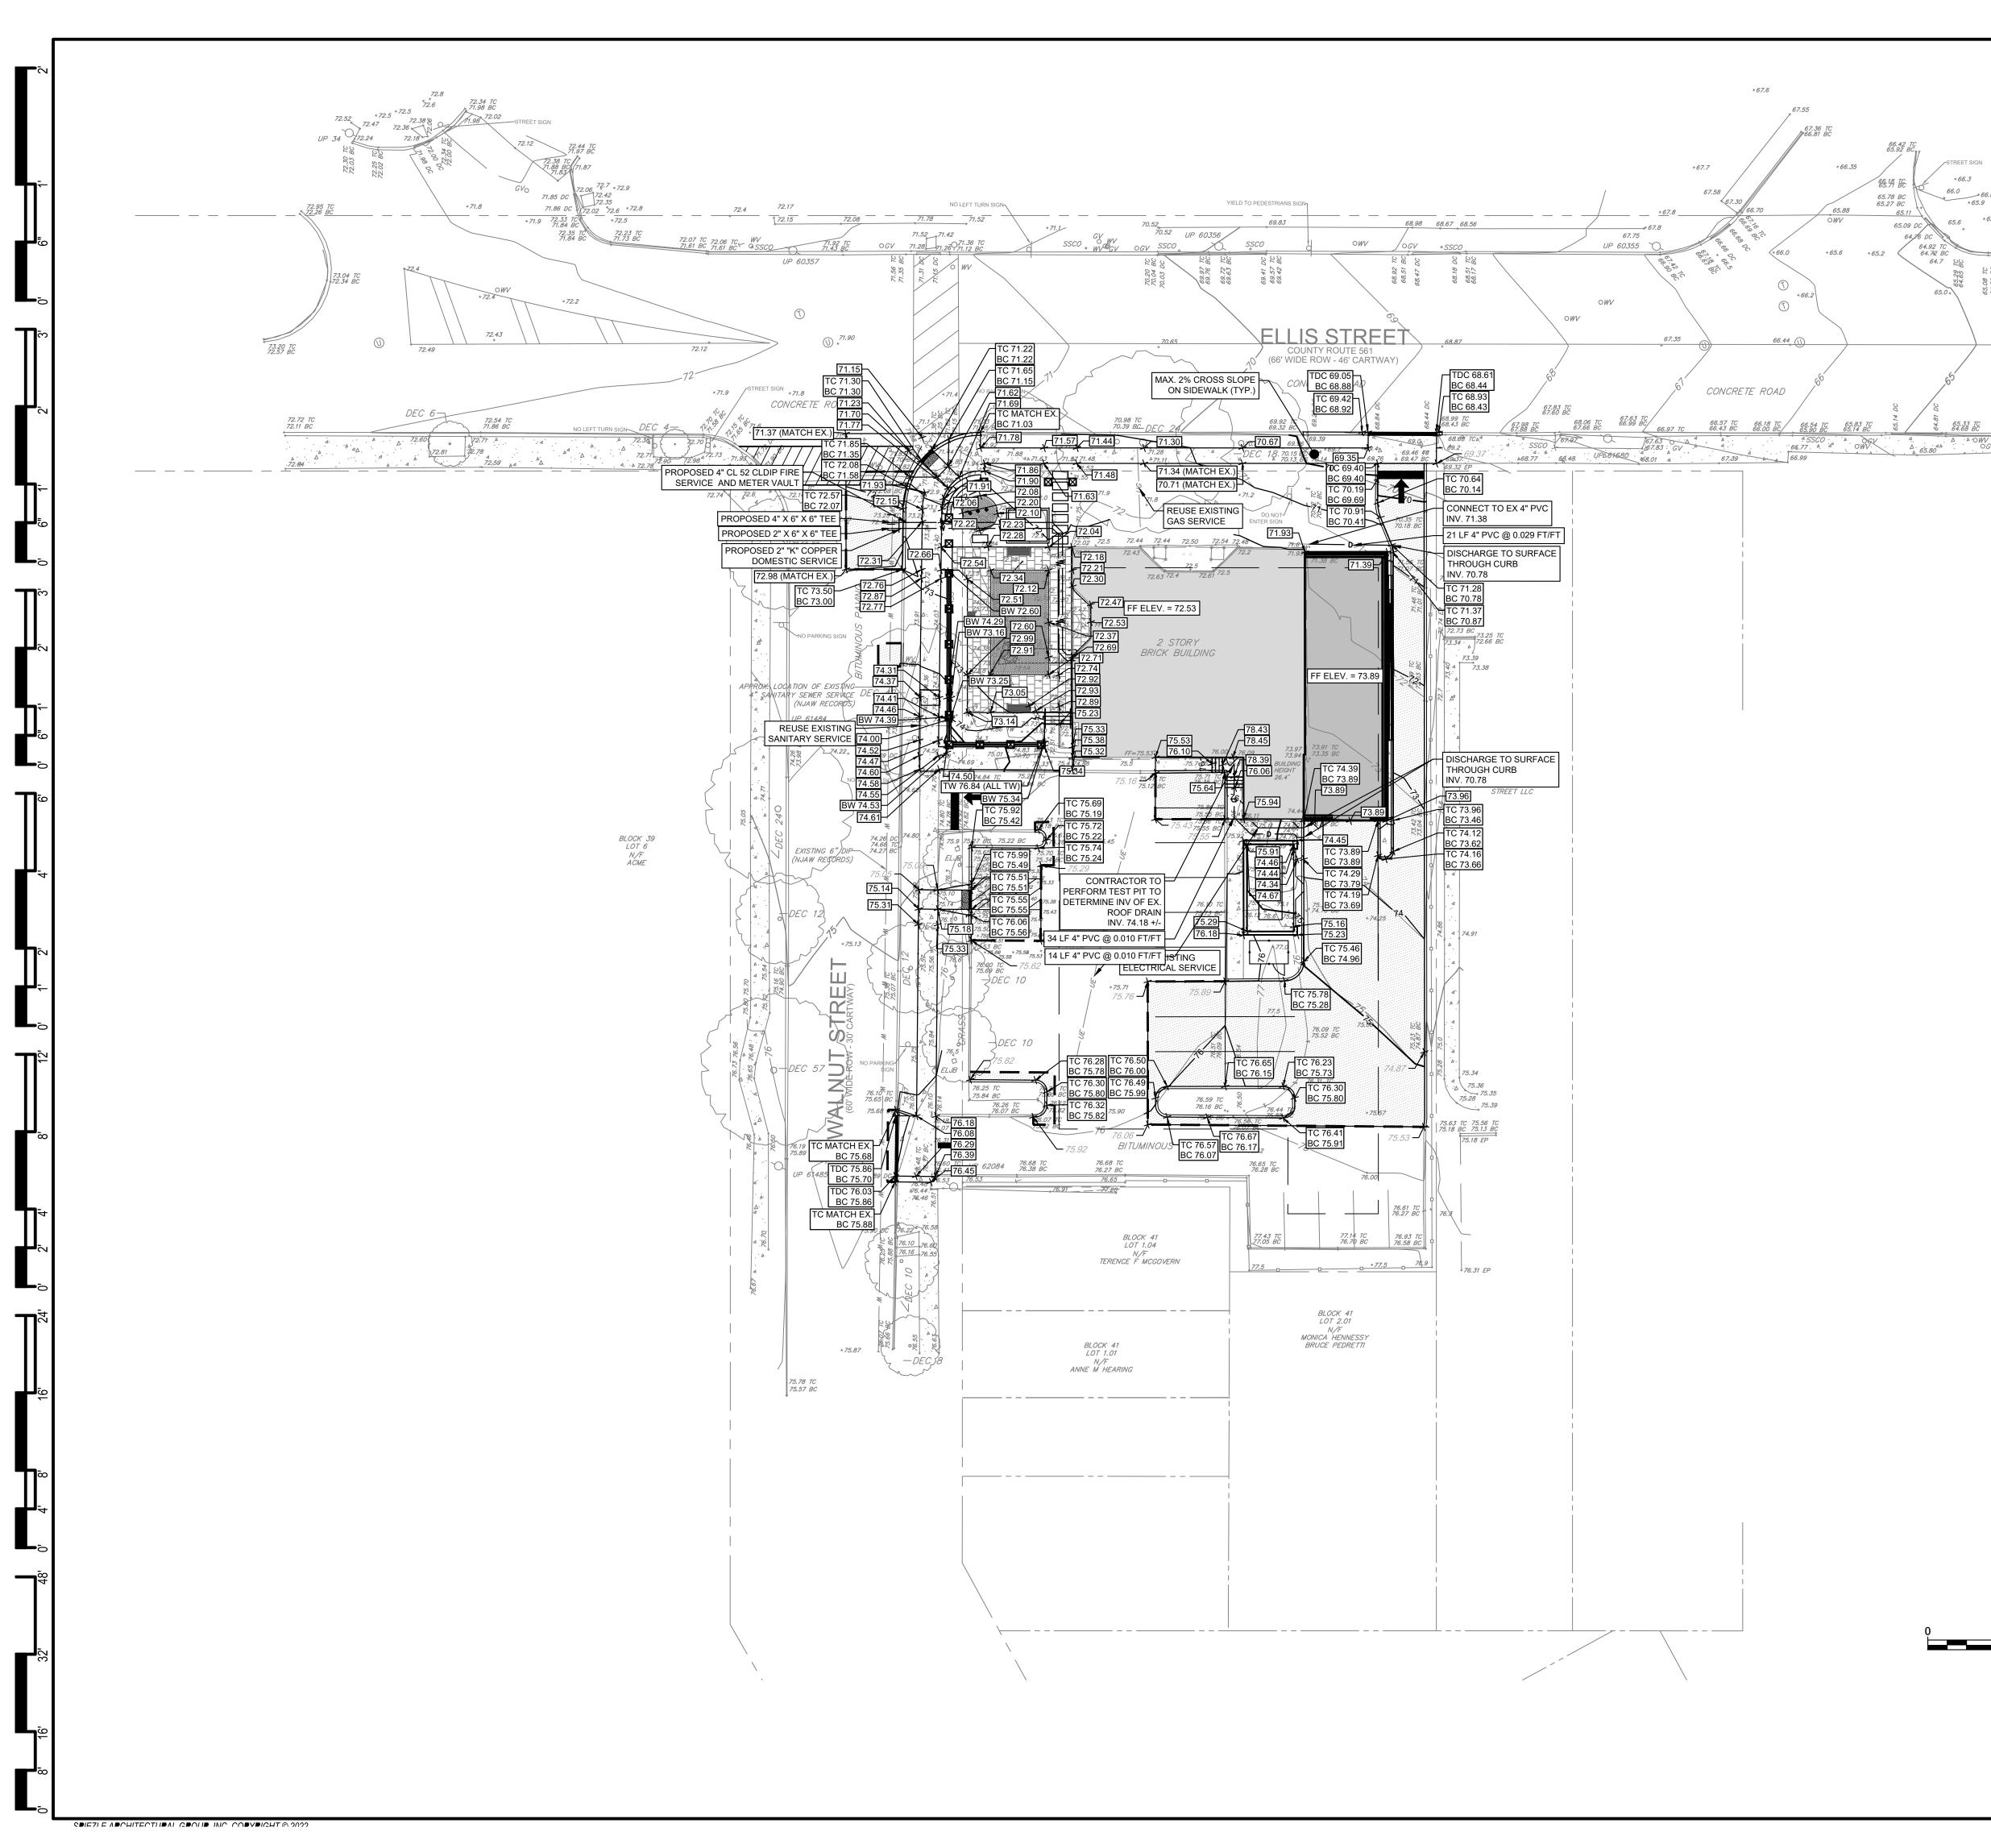
PROPOSED ASPHALT PAVEMENT

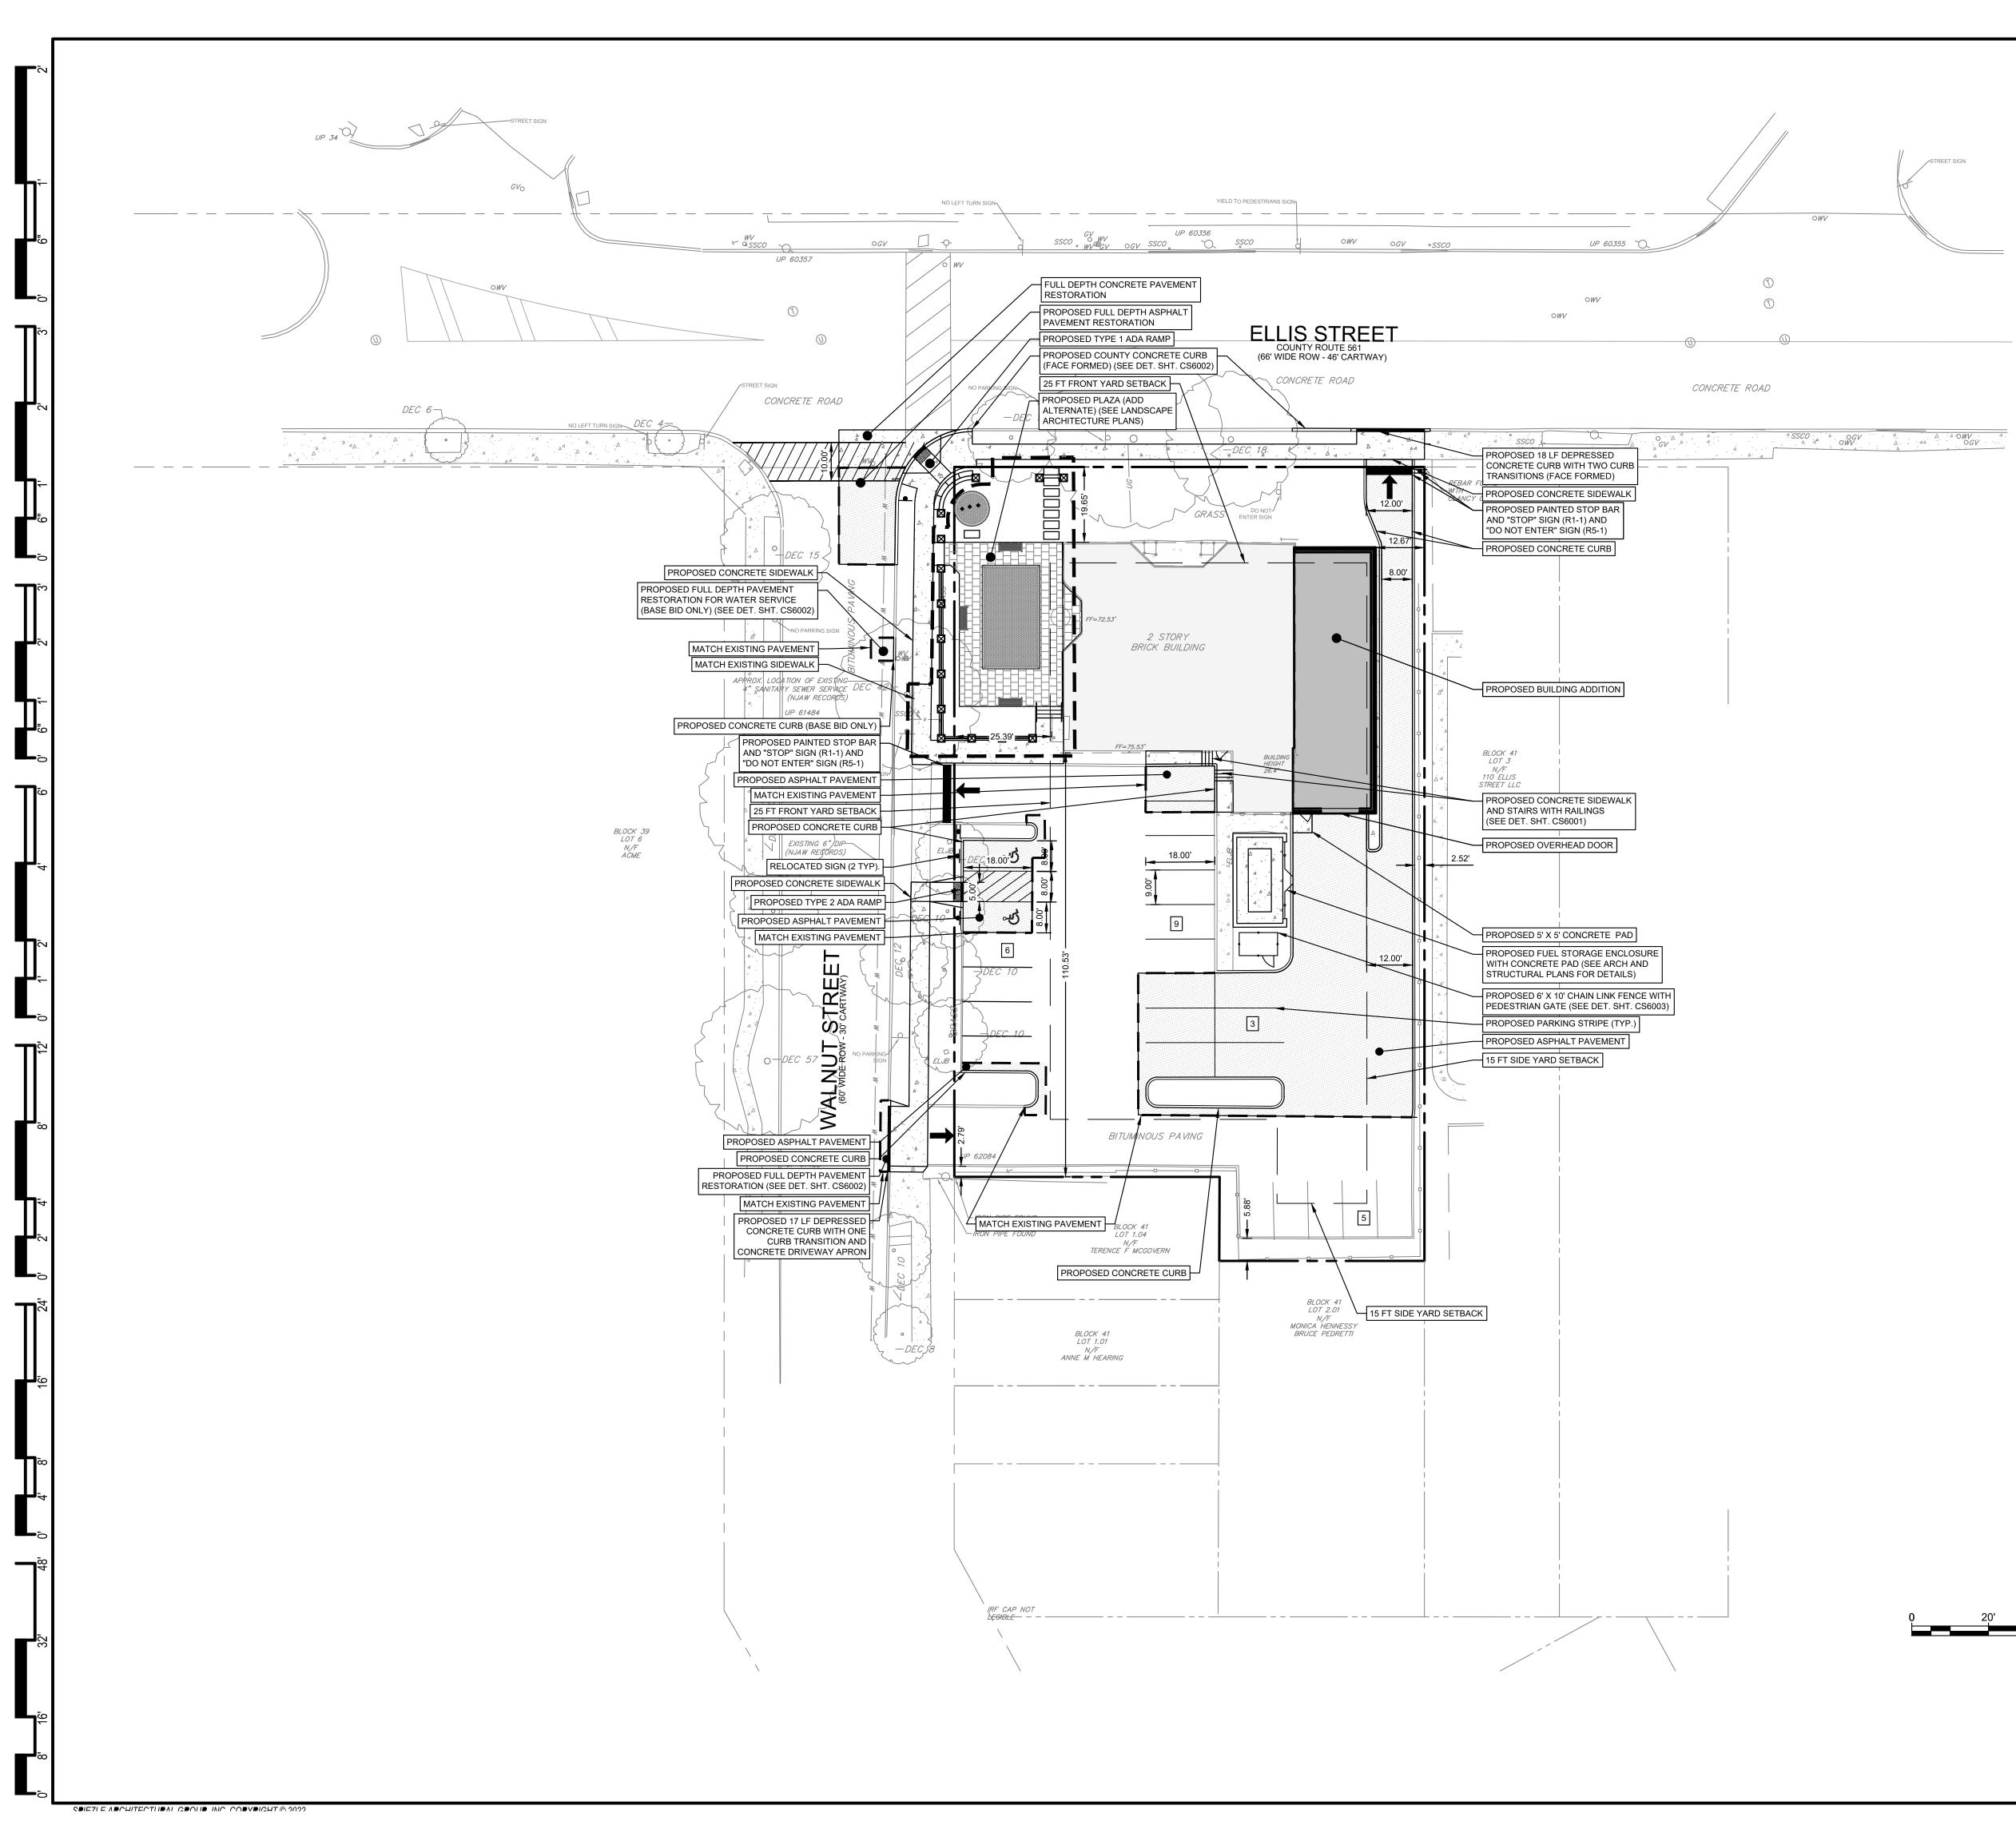PROPOSED BUILDING

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		STEVEN G. SIEGEL21AI01564200ANGELO ALBERTO21AI01046700JOHN F. WRIGHT21AI01784200SPIEZLE ARCHITECTURAL GROUP, INC.21AC00063000
		SEAL:
		JACQUELINE R BERENATO
		PROFESSIONAL ENGINEER NEW JERSEY LICENSE NO. GE 56282
		FOR BID
		06/25/2024 PROJECT:
		HADDONFIELD POLICE STATION
		1 WALNUT STREET
		HADDONFIELD, NEW JERSEY 08033
		FOR
		CAMDEN COUNTY
		IMPROVEMENT AUTHORITY
		520 MARKET STREET, 6TH FLOOR
		CAMDEN, NEW JERSEY 08102
		FOR CODE REVIEW: 02/23/24 REVISIONS:
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	JOHN F. WRIGHT 21	AI01784200 AC00063000
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	JACQUELINE R BERENA PROFESSIONAL ENGINEER	AIU
	NEW JERSEY LICENSE NO. GE 56282	
	FOR BID	
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	PROJECT:	
	HADDONFIELD POLICE	
	STATION	
	1 WALNUT STREET HADDONFIELD, NEW JERSEY 0803	3
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	CAMDEN COUNTY	
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PLANTING NOTES

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- ALL PLANT LOCATIONS SHALL BE STAKED IN THE FIELD AND LOCATIONS APPROVED BY LANDSCAPE ARCHITECT PRIOR TO PLANTING.
- 2. TOPSOIL WITH A QUALITY ORGANIC SOIL AMENDMENT SHALL BE USED FOR ALL PLANTING AND SEEDING OPERATIONS.
- INSTALL 12" MINIMUM TOPSOIL MIXTURE IN GROUNDCOVER BEDS AND 24" IN SHRUB BEDS AND ISLANDS. 6" OF TOPSOIL ARE TO REMAIN ON ALL DISTURBED AREAS TO RECEIVE SOD OR SEED.
- 4. NOTIFY ALL UTILITY COMPANIES AND LOCATE ALL UTILITIES PRIOR TO EXCAVATING PLANT PITS. PLANT LOCATIONS MAY BE ADJUSTED IN THE FIELD TO AVOID INTERFERENCE WITH UNDERGROUND UTILITIES.
- 5. SHOULD ANY DISCREPANCY ARISE BETWEEN THE PLANTING PLAN AND THE PLANTING SCHEDULE, THE DEVELOPER IS RESPONSIBLE FOR THE QUANTITIES SHOWN ON THE LANDSCAPE PLAN.
- 6. ALL PLANT MATERIAL SHALL BE OF NURSERY STOCK QUALITY AS DEFINED BY THE AMERICAN ASSOCIATION OF NURSERYMAN STANDARDS AND SHALL BE FIRST QUALITY NURSERY GROWN STOCK FREE OF DISEASE AND OBJECTIONABLE DISFIGUREMENTS AND PLANTED IN CONFORMANCE WITH SOUND NURSERY PRACTICE AND APPLICABLE CITY STANDARDS.
- 7. ALL NON-BIODEGRADABLE ROOT WRAPPING TO BE REMOVED COMPLETELY BEFORE PLANTING.
- 8. ALL TREES SHALL BE BALLED AND BULLAPED, NURSERY GROWN STOCK.
- 9. ALL PLANT MATERIAL AND LAWNS SHALL BE PLANTED WITHIN THE RECOMMENDED SEASONAL TIME PERIODS A S PRESCRIBED BY ACCEPTED HORTICULTURAL PRACTICE. RECOMMENDED PLANTING TIMES ARE BETWEEN APRIL 15TH THRU MAY 31ST OR AUGUST 17TH THRU OCTOBER 15TH. FALL DIGGING AND TRANSPLANT HAZARD TREE SPECIES (OAKS, ETC.) SHALL BE ONLY BE DUG AND PLANTED IN SPRING.
- 10. ALL PLANT MATERIAL SHALL BE APPROVED UPON ARRIVAL TO THE SITE, UNLESS OTHERWISE NOTIFIED.
- 11. PROPOSED PLANT MATERIAL MAY BE SUBSTITUTED BY SIMILAR PLANTS PRIOR TO INSTALLATION, SUBJECT TO APPROVAL BY THE CITY ENGINEER.
- 12. A TEMPORARY FENCE, SUCH AS SNOW FENCE, SHALL BE ERECTED AT THE PERIMETER OF THE DRIPLINE OF ALL EXISTING VEGETATION INDICATED TO REMAIN. PRIOR TO EXCAVATION, CONSTRUCTION OR SITE WORK. THIS FENCE SHALL BE REMOVED ONLY AT THE TIME OF COMPLETION OF ALL CONSTRUCTION AND FINAL GRADING.
- 13. EXISTING TREES TO BE RELOCATED SHALL BE HANDLED ACCORDING TO ACCEPTABLE HORTICULTURE PRACTICE.
- 14. ALL DISTURBED AREAS NOT SHOWN AS PLANTED OR LAWN SHALL BE TOPSOILED AND SEEDED OR RETURNED TO THEIR ORIGINAL STATE BEFORE DISTURBANCE AS DIRECTED BY THE CITY ENGINEER.
- 15. ALL AREAS NOT RELATED TO HE PROPOSED DEVELOPMENT SHALL REMAIN IN THEIR NATURAL STATE. DISTURBANCE OF EXISTING VEGETATION SHALL BE LIMITED TO WORK AREA AND AS DEFINED ON DWGS. CS0501-04 AND CS8001.
- 16. ADDITIONAL LANDSCAPING APPROVED BY THE CITY ENGINEER SHALL BE PROVIDED BY THE APPLICANT TO REPALCE ANY VEGETATION IN ADVERTENTLY REMOVED OUTSIDE THE LIMIT OF DISTURBANCE LINE AS SHOWN ON THE APPROVED GRADING PLAN DURING CONSTRUCTION.

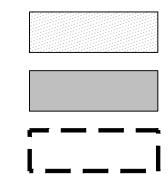BLOCK 39 LOT 6 N/F ACME

- 17. PROPOSED TREES SHALL NOT BE PLANTED WITHIN EASEMENTS, DRIVEWAYS AND SITE TRIANGLES. THEREFORE, THE TREE LOCATIONS SHALL BE APPROXIMATE AND SHALL BE ADJUSTED IN THE FIELD AS REQUIRED.
- 18. ALL SHADE TREES IN PEDESTRIAN WALKS AREAS SHALL HAVE AN INITIAL LIMBS PRUNED STARTING AT A MINIMUM OF 7 FT. ABOVE FINISHED GRADE.
- 19. ALL TREES SHALL BE MULCHED WITH A THREE INCH (3") MINIMUM DEPTH OF SHREDDED HARDWOOD BARK.
- 20. PLANTS ARRANGED IN CONTINUOUS GROUPINGS SHALL BE SET IN MULCHED BEDS.
- 21. PLANTING DEBRIS SHALL BE REMOVED FROM THE PROPERTY.
- 22. ANY LIVE TREE WHICH IS SUBSTANTIALLY DAMAGED AS A RESULT FO GRADING OR GENERAL CONSTRUCTION MUST BE REMOVED AND REPLACED WITH ANOTHER TREE OR TREES AS APPROVED BY THE CITY ENGINEER.
- 23. TREE REMOVAL FROM ANY SLOPE OR ENVIRONMENTALLY SENSITIVE AREA IS PROHIBITED IF IT WILL CONTRIBUTE, IN THE OPINION OF THE CITY ENGINEER. TO EXTRA RUNOFF OF SURFACE WATER ONTO ADJOINING PROPERTY AND EROSION AND SILTING, UNLESS OTHER MEANS APPROVED BY THE CITY ENGINEER ARE PROVIDED TO PREVENT RUNOFF AND EROSION.
- 24. NO HEALTHY TREE THAT IS SPECIAL BY VIRTUE OF HISTORY, UNUSUAL SIZE, OR AGE OR OF RAE SPECIES, SHALL BE REMOVED EXCEPT AS MAY BE REQUIRED FOR PROTECTION OF PUBLIC HEALTH, SAFETY AND WELFARE.
- 25. SELECTED EXISTING HEALTHY TREES SIX (6) INCHES IN CALIPER OR LESS MEASURED FOUR (4) FEET ABOVE THE GROUND SHALL BE RELOCATED ON-SITE UNDER THE DIRECTION AND APPROVAL OF THE CITY ENGINEER.
- 26. NEWLY INSTALLED PLANT MATERIAL SHALL BE WATERED AT THE TIME OF PLANTING. REGULAR WATERING SHALL BE PROVIDED TO ENSURE THE ESTABLISHMENT AND REGULAR GROWTH OF PLANTS.
- 27. ALL SHRUBS SPACED 7 FT. O.C. OR CLOSER SHALL BE IN CONTINUOUS MULCHED BEDS.
- 28. SEED ALL DISTURBED AREAS WITH REQUIRED SEED MIX (SEE DWG. CS8501 FOR SEEDING MIX SCHEDULE).
- 29. TREES SHOULD BE PLANTED A MIN. OF FIVE (5) FEET FROM SIDEWALKS UNLESS IN TREE PITS.
- 30. GUY WIRES AND STAKES WILL ONLY BE UTILIZED IF CONDITIONS MERIT AND WILL BE REMOVED BY THE DEVELOPER AT THE END OF THE GUARANTEE PERIOD.

LANDSCAPE MAINTENANCE NOTES

PLANT MATERIAL GUARANTEE

ALL PLANT MATERIAL SHALL BE GUARANTEED FOR ONE (1) YEAR BY THE CONTRACTOR TO BE IN HEALTHY AND VIGOROUS CONDITION FROM THE DATE OF ACCEPTANCE LANDSCAPE ARCHITECT, OWNER AND CITY INSPECTOR. ANY AND ALL PLANT MATERIAL THAT DIES OR FAILS TO THRIVE SHALL BE IMMEDIATELY REPLACED WITH LIKE SPECIES. IT IS UNDERSTOOD THAT THE CONTRACTOR WILL PROVIDE ADEQUATE AND TIMELY CARE DURING THE GUARANTEE PERIOD TO THE HIGHEST HORTICULTURAL STANDARDS.

MAINTENANCE


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THE CONTRACTOR SHALL BE RESPONSIBLE FOR MAINTENANCE OF SITE VEGETATION DURING THE GUARANTEE PERIOD TO INCLUDE BUT NOT BE LIMITED TO:


- 1. FERTILIZER: SPRING AND FALL FERTILIZER APPLICATIONS.
- 2. PRUNING: PRUNING SHALL BE LIMITED OR REMOVAL OF DEAD WOOD OR BRANCHES FOR TREES OR FOR SIGHT DIFFERENCES/SAFETY REASONS. PRUNING OF SHRUBS AND TREES SHALL BE LIMITED TO THE PRUNING NECESSARY TO MAINTAIN THE NATURAL SHAPE OF THE PLANT EXCEPT FOR SHEARED HEDGES.
- 3. PEST CONTROL: PRE-EMERGENT WEED CONTROL FOR MOWN LAWNS AND SHRUB BEDS MAY BE APPLIED IN FEBRUARY. CHEMICAL TREATMENT FOR INSECT INFESTATION AND DISEASE MAY BE APPLIED AND SHALL BE SPECIFIC TO THE PROBLEM.
- 4. MULCHING: MULCHING SHALL BE MAINTAINED AT A DEPTH OF 3" IN PLANT BEDS AND AROUND BASE OF TREES.
- 5. MOWING: MOWN LAWN SEED MIX SHALL BE MOWN AT REGULAR INTERVALS THROUGHOUT THE GROWING SEASON. GRASS HEIGHT SHOULD NOT EXCEED 4 INCHES BEFORE CUTTING. MOWER BLADES SHALL BE SET AT 3 INCHES UNLESS OTHERWISE DIRECTED.
- 6. PLANT PROTECTION: AVOID EXCESS INTRUSION INTO THE ROOT ZONE AREA OF ESTABLISHED PLANTINGS.
- 7. WATERING: UNLESS STATED OTHERWISE IN THESE DOCUMENTS, PROVIDE APPROXIMATELY 1-INCH OF RAINFALL/WATER PER WEEK THROUGHOUT THE GROWING SEASON DURING THE GUARANTEE PERIOD. AN IRRIGATION SYSTEM SHALL BE INSTALLED BY THE OWNER FOR ALL PROPOSED LANDSCAPING. SEE DRAWING CS2001 FOR AREAS TO BE IRRIGATED.

PERENNIAL AND GROUNDCOVER MAINTENANCE

- 1. WEED CONTROL CAN BE A PROBLEM UNTIL THE GROUNDCOVERS/ PERENNIALS HAVE SPREAD AND FILLED IN THE AREA. CONTROL OF PERSISTENT, PERENNIAL WEEDS, SUCH AS BERMUDAGRASS AND NUTGRASS SHOULD BE ACHIEVED BEFORE PLANTING. USE A NONSELECTIVE HERBICIDE, SUCH AS ROUNDUP. A MULCH APPLIED AFTER PLANTING AND REPLENISHED AS NEEDED TO MAINTAIN A DEPTH OF 3 INCHES WILL REDUCE THE NEED TO WEED BY HAND. PRE-EMERGENCE HERBICIDES CAN BE USED ON MANY TYPES OF GROUNDCOVER TO AID WEED CONTROL; READ THE LABEL CAREFULLY BEFORE APPLYING. AS THE GROUNDCOVER FILLS IN WEEDS WILL BECOME LESS OF A PROBLEM BECAUSE OF THE SHADED SOIL. SOME HAND WEEDING WILL MOST LIKELY BE NEEDED.
- 2. FERTILIZER MOST GROUNDCOVERS WILL BENEFIT FROM AN APPLICATION OF FERTILIZER IN LATE WINTER TO EARLY SPRING. USE 2 TO 4 POUNDS OF A COMPLETE FERTILIZER PER 1,000 SQUARE FEET. WATER OR BRUSH FERTILIZER OFF THE FOLIAGE AFTER BROADCASTING.

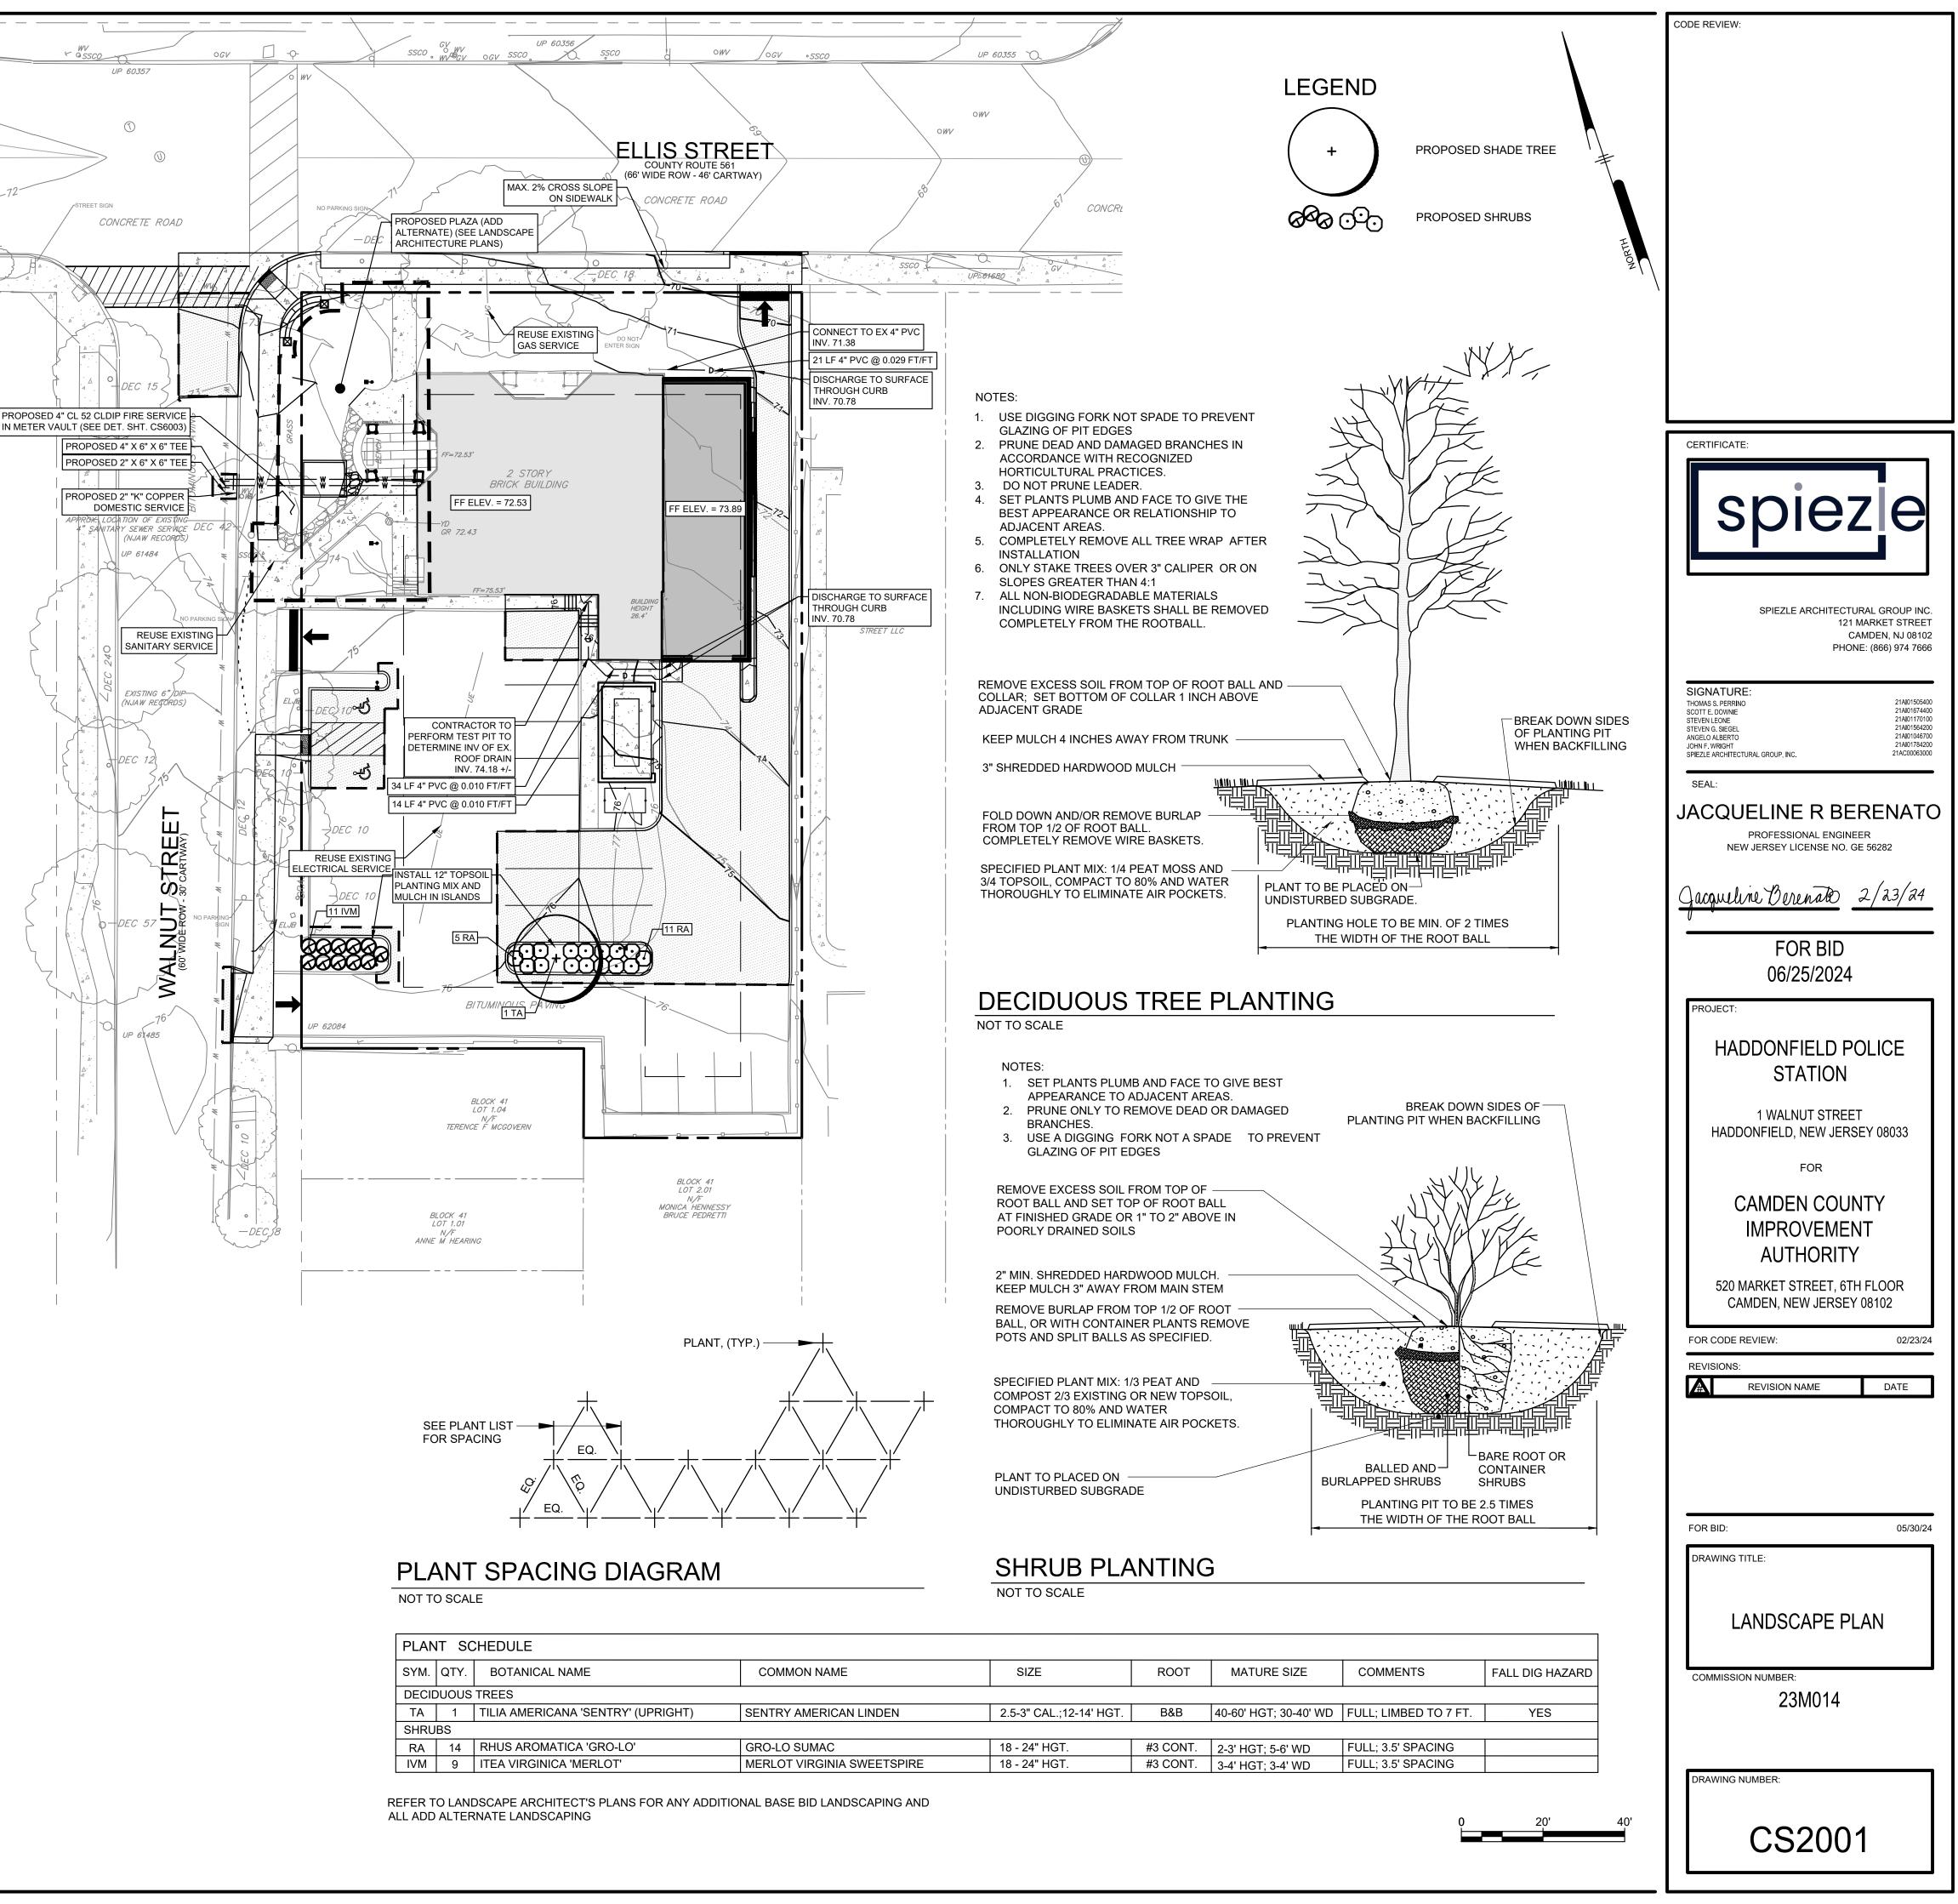

PLANT SCHEDULE					
QTY.	BOTANICAL NAME	COMMON NAME	SIZE		
DECIDUOUS TREES					
1	TILIA AMERICANA 'SENTRY' (UPRIGHT) SENTRY AMERICAN LINDEN 2.5-3" CAL.;12-14' HG				
SHRUBS					
14	RHUS AROMATICA 'GRO-LO'	GRO-LO SUMAC	18 - 24" HGT.		
9	ITEA VIRGINICA 'MERLOT'	MERLOT VIRGINIA SWEETSPIRE	18 - 24" HGT.		
	QTY. JOUS 1 S 14	QTY. BOTANICAL NAME JOUS TREES 1 1 TILIA AMERICANA 'SENTRY' (UPRIGHT) S 14 14 RHUS AROMATICA 'GRO-LO'	QTY. BOTANICAL NAME COMMON NAME JOUS TREES JOUS TREES 1 TILIA AMERICANA 'SENTRY' (UPRIGHT) SENTRY AMERICAN LINDEN S JA 14 RHUS AROMATICA 'GRO-LO' GRO-LO SUMAC		

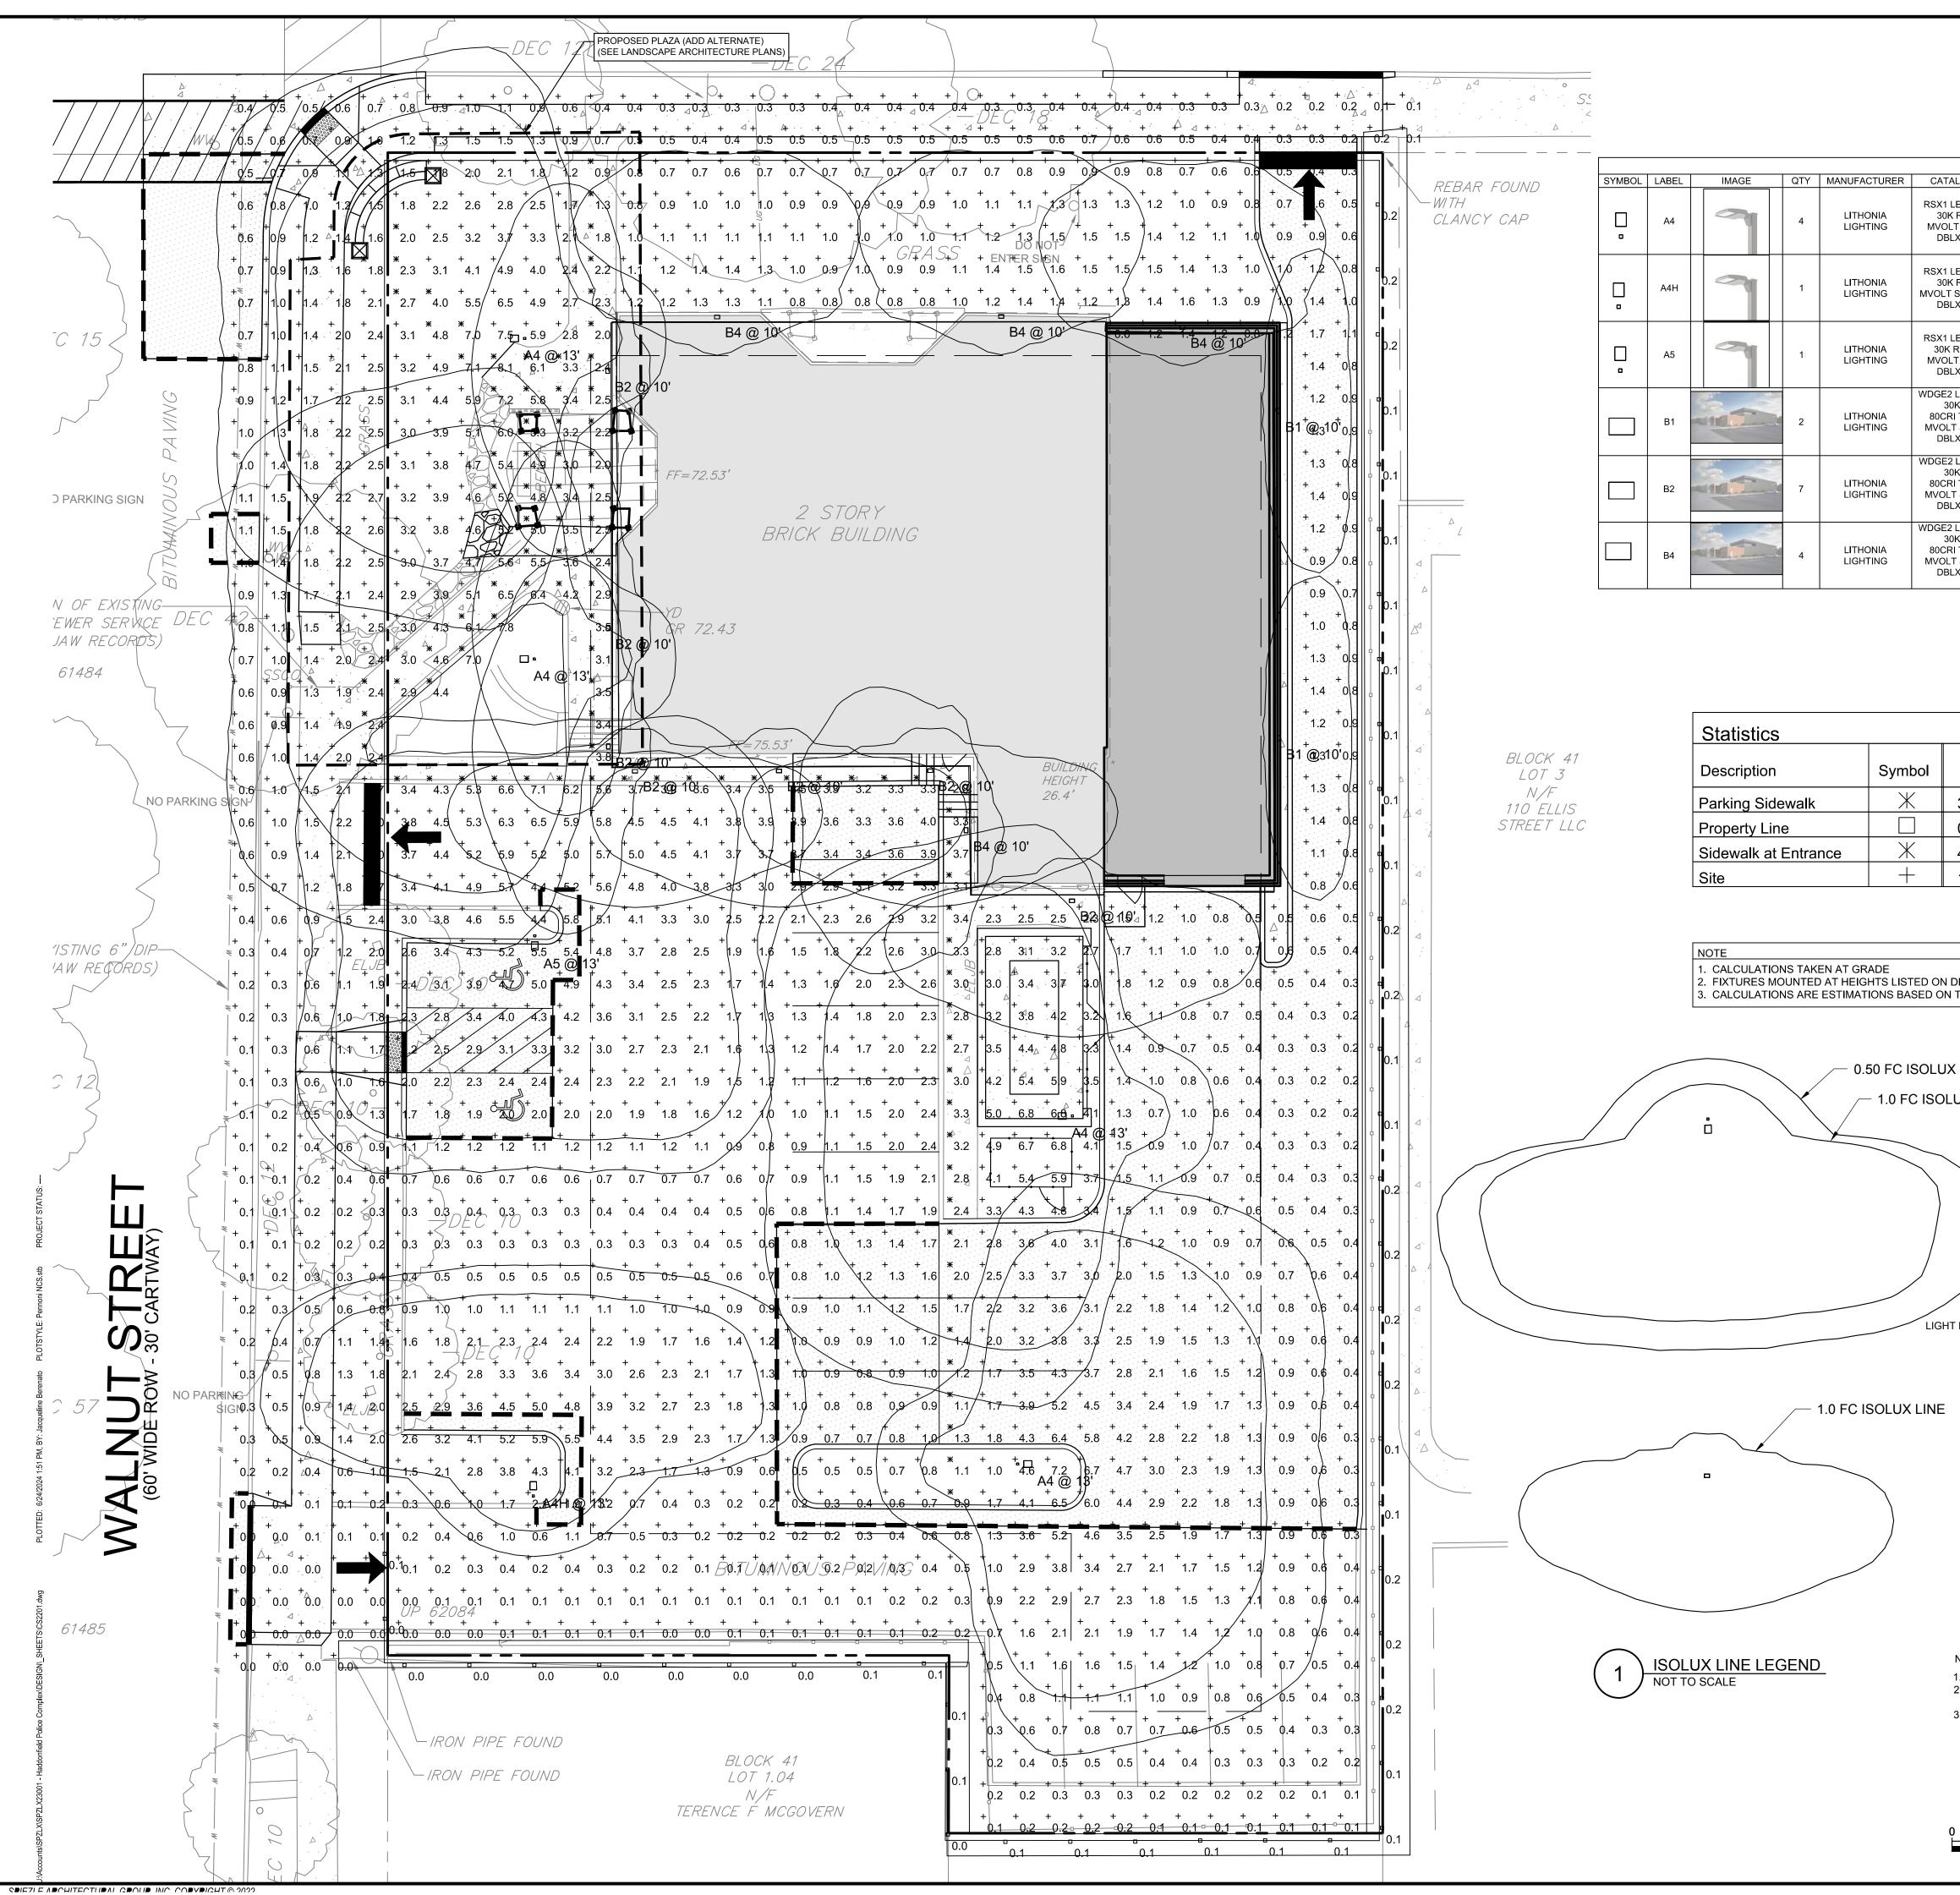



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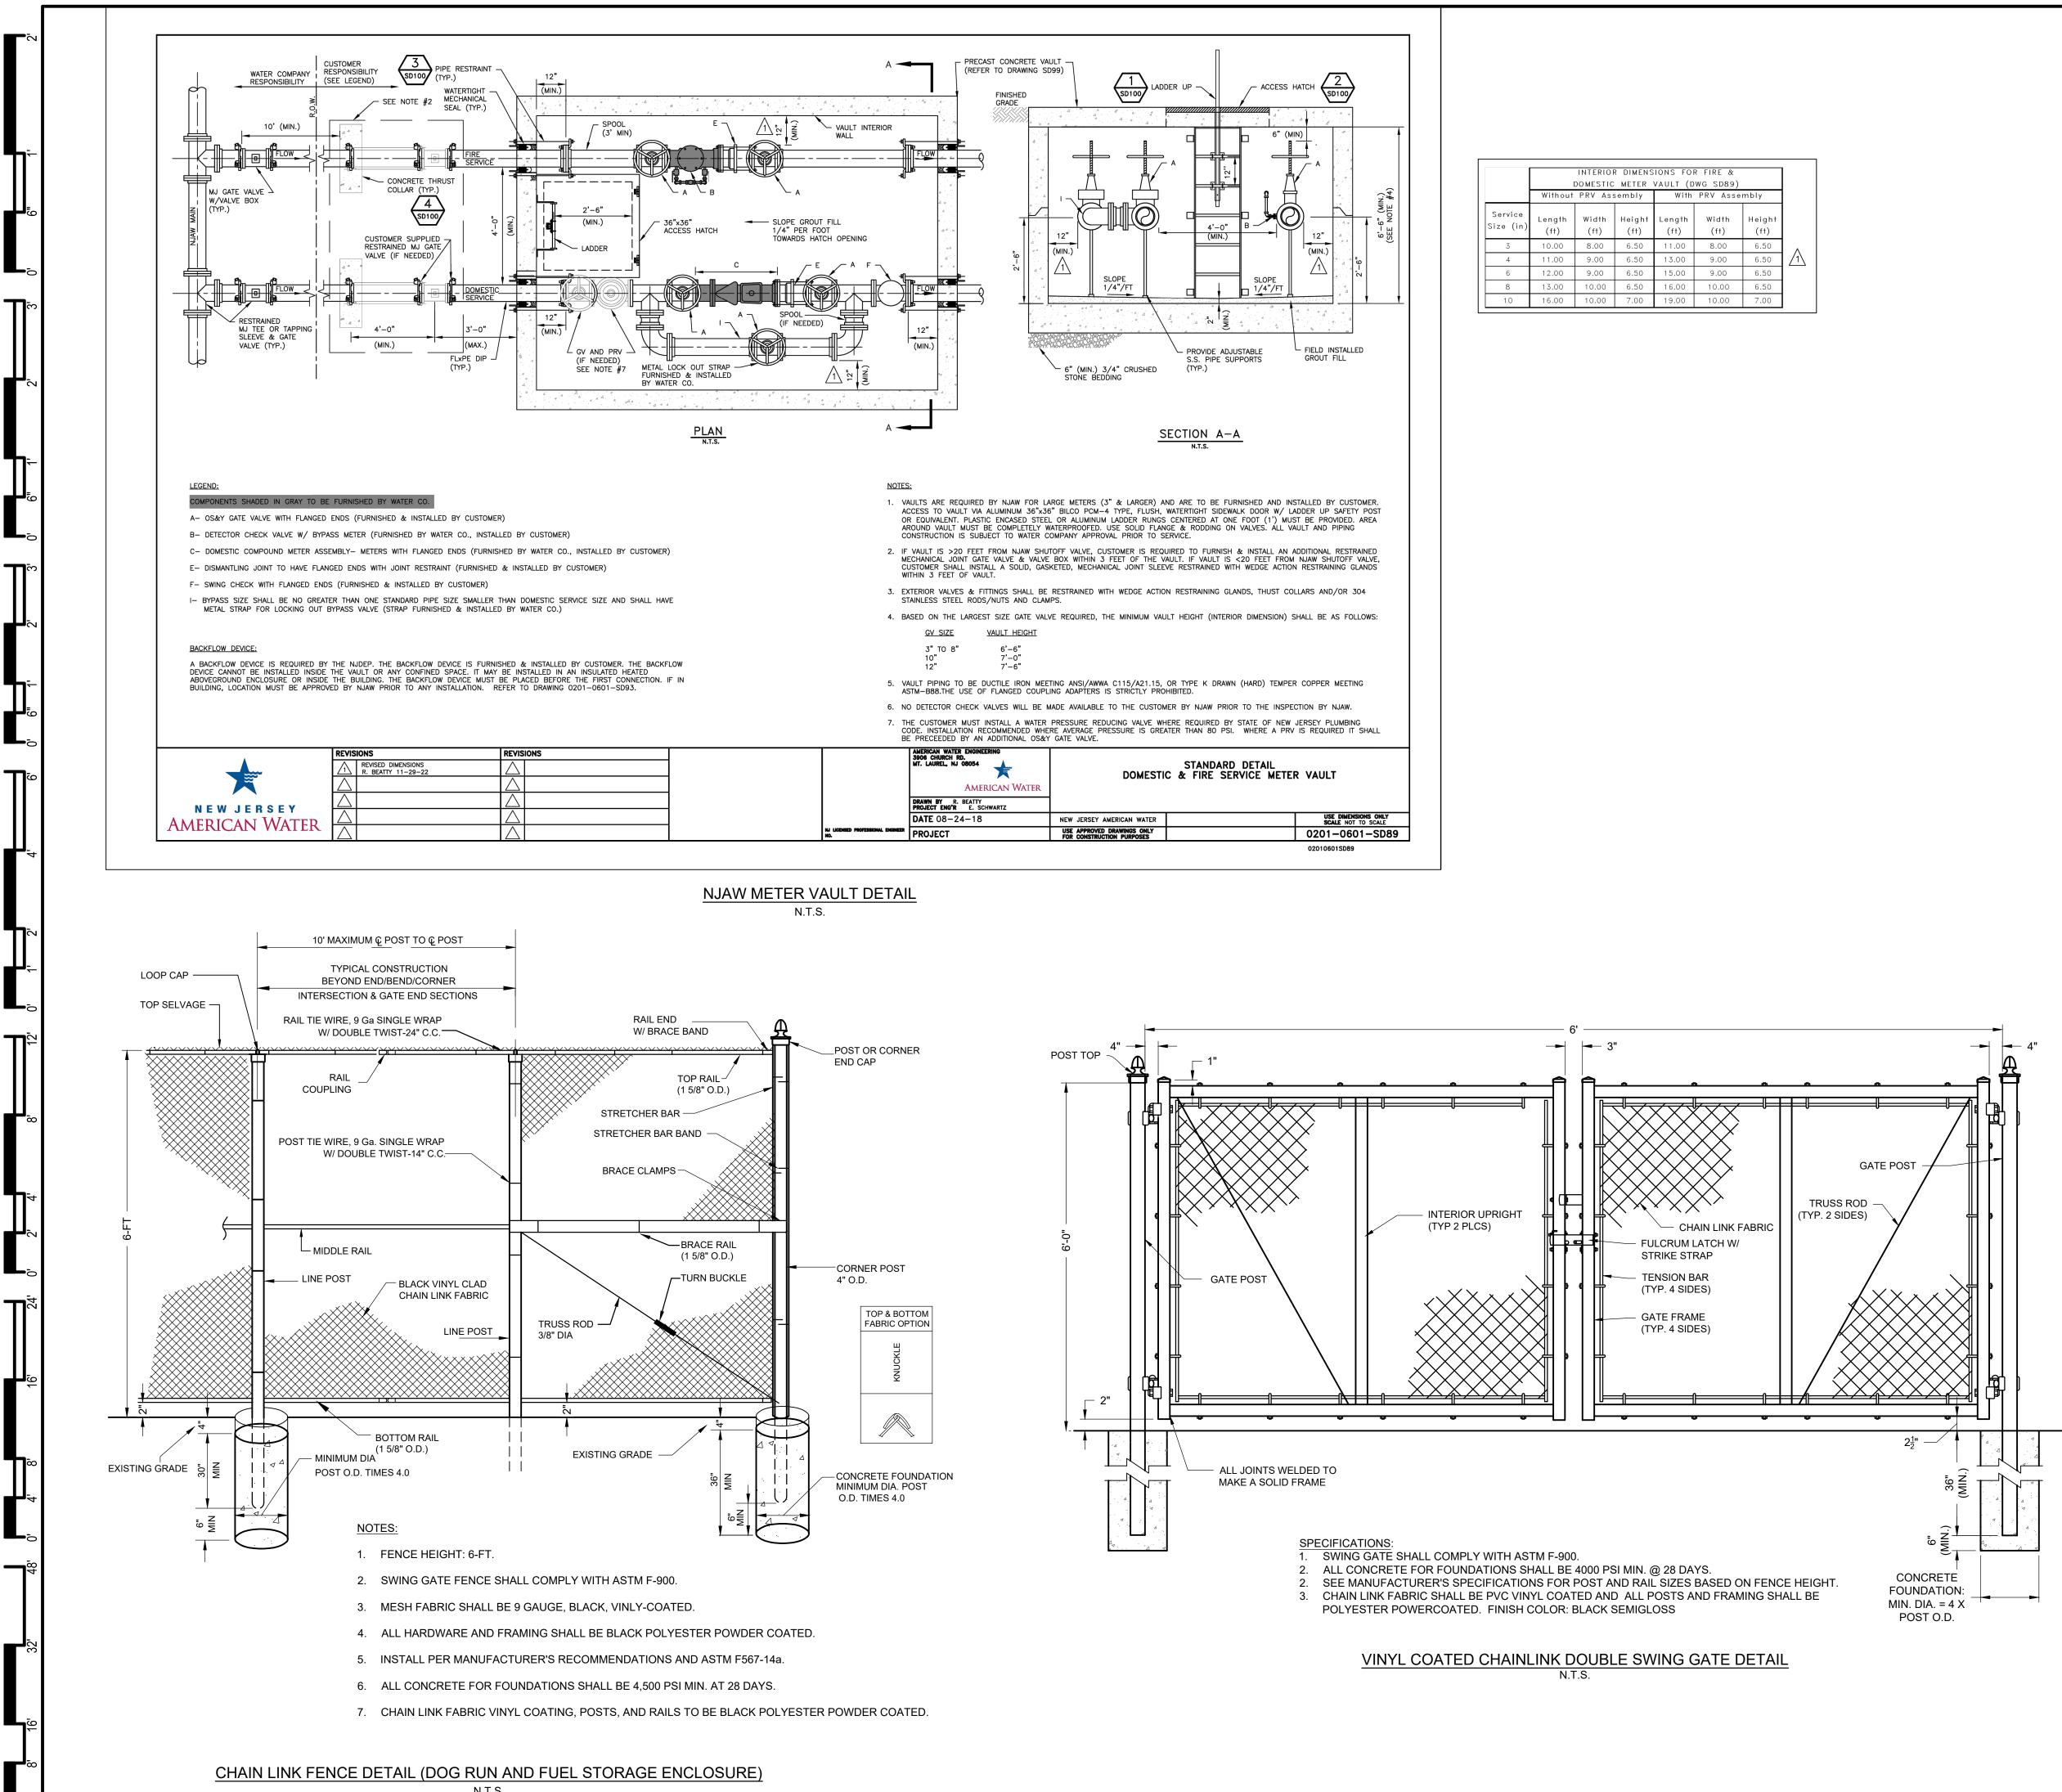
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							Max: 816cd	
								SPIEZLE ARCHITECTURAL GROUP INC. 121 MARKET STREET
								CAMDEN, NJ 08102 PHONE: (866) 974 7666
								SIGNATURE:
								THOMAS S. PERRINO 21AI01505400 SCOTT E. DOWNIE 21AI01674400 STEVEN LEONE 21AI01170100
								STEVEN G. SIEGEL 21AI01564200 ANGELO ALBERTO 21AI01046700 JOHN F. WRIGHT 21AI01784200
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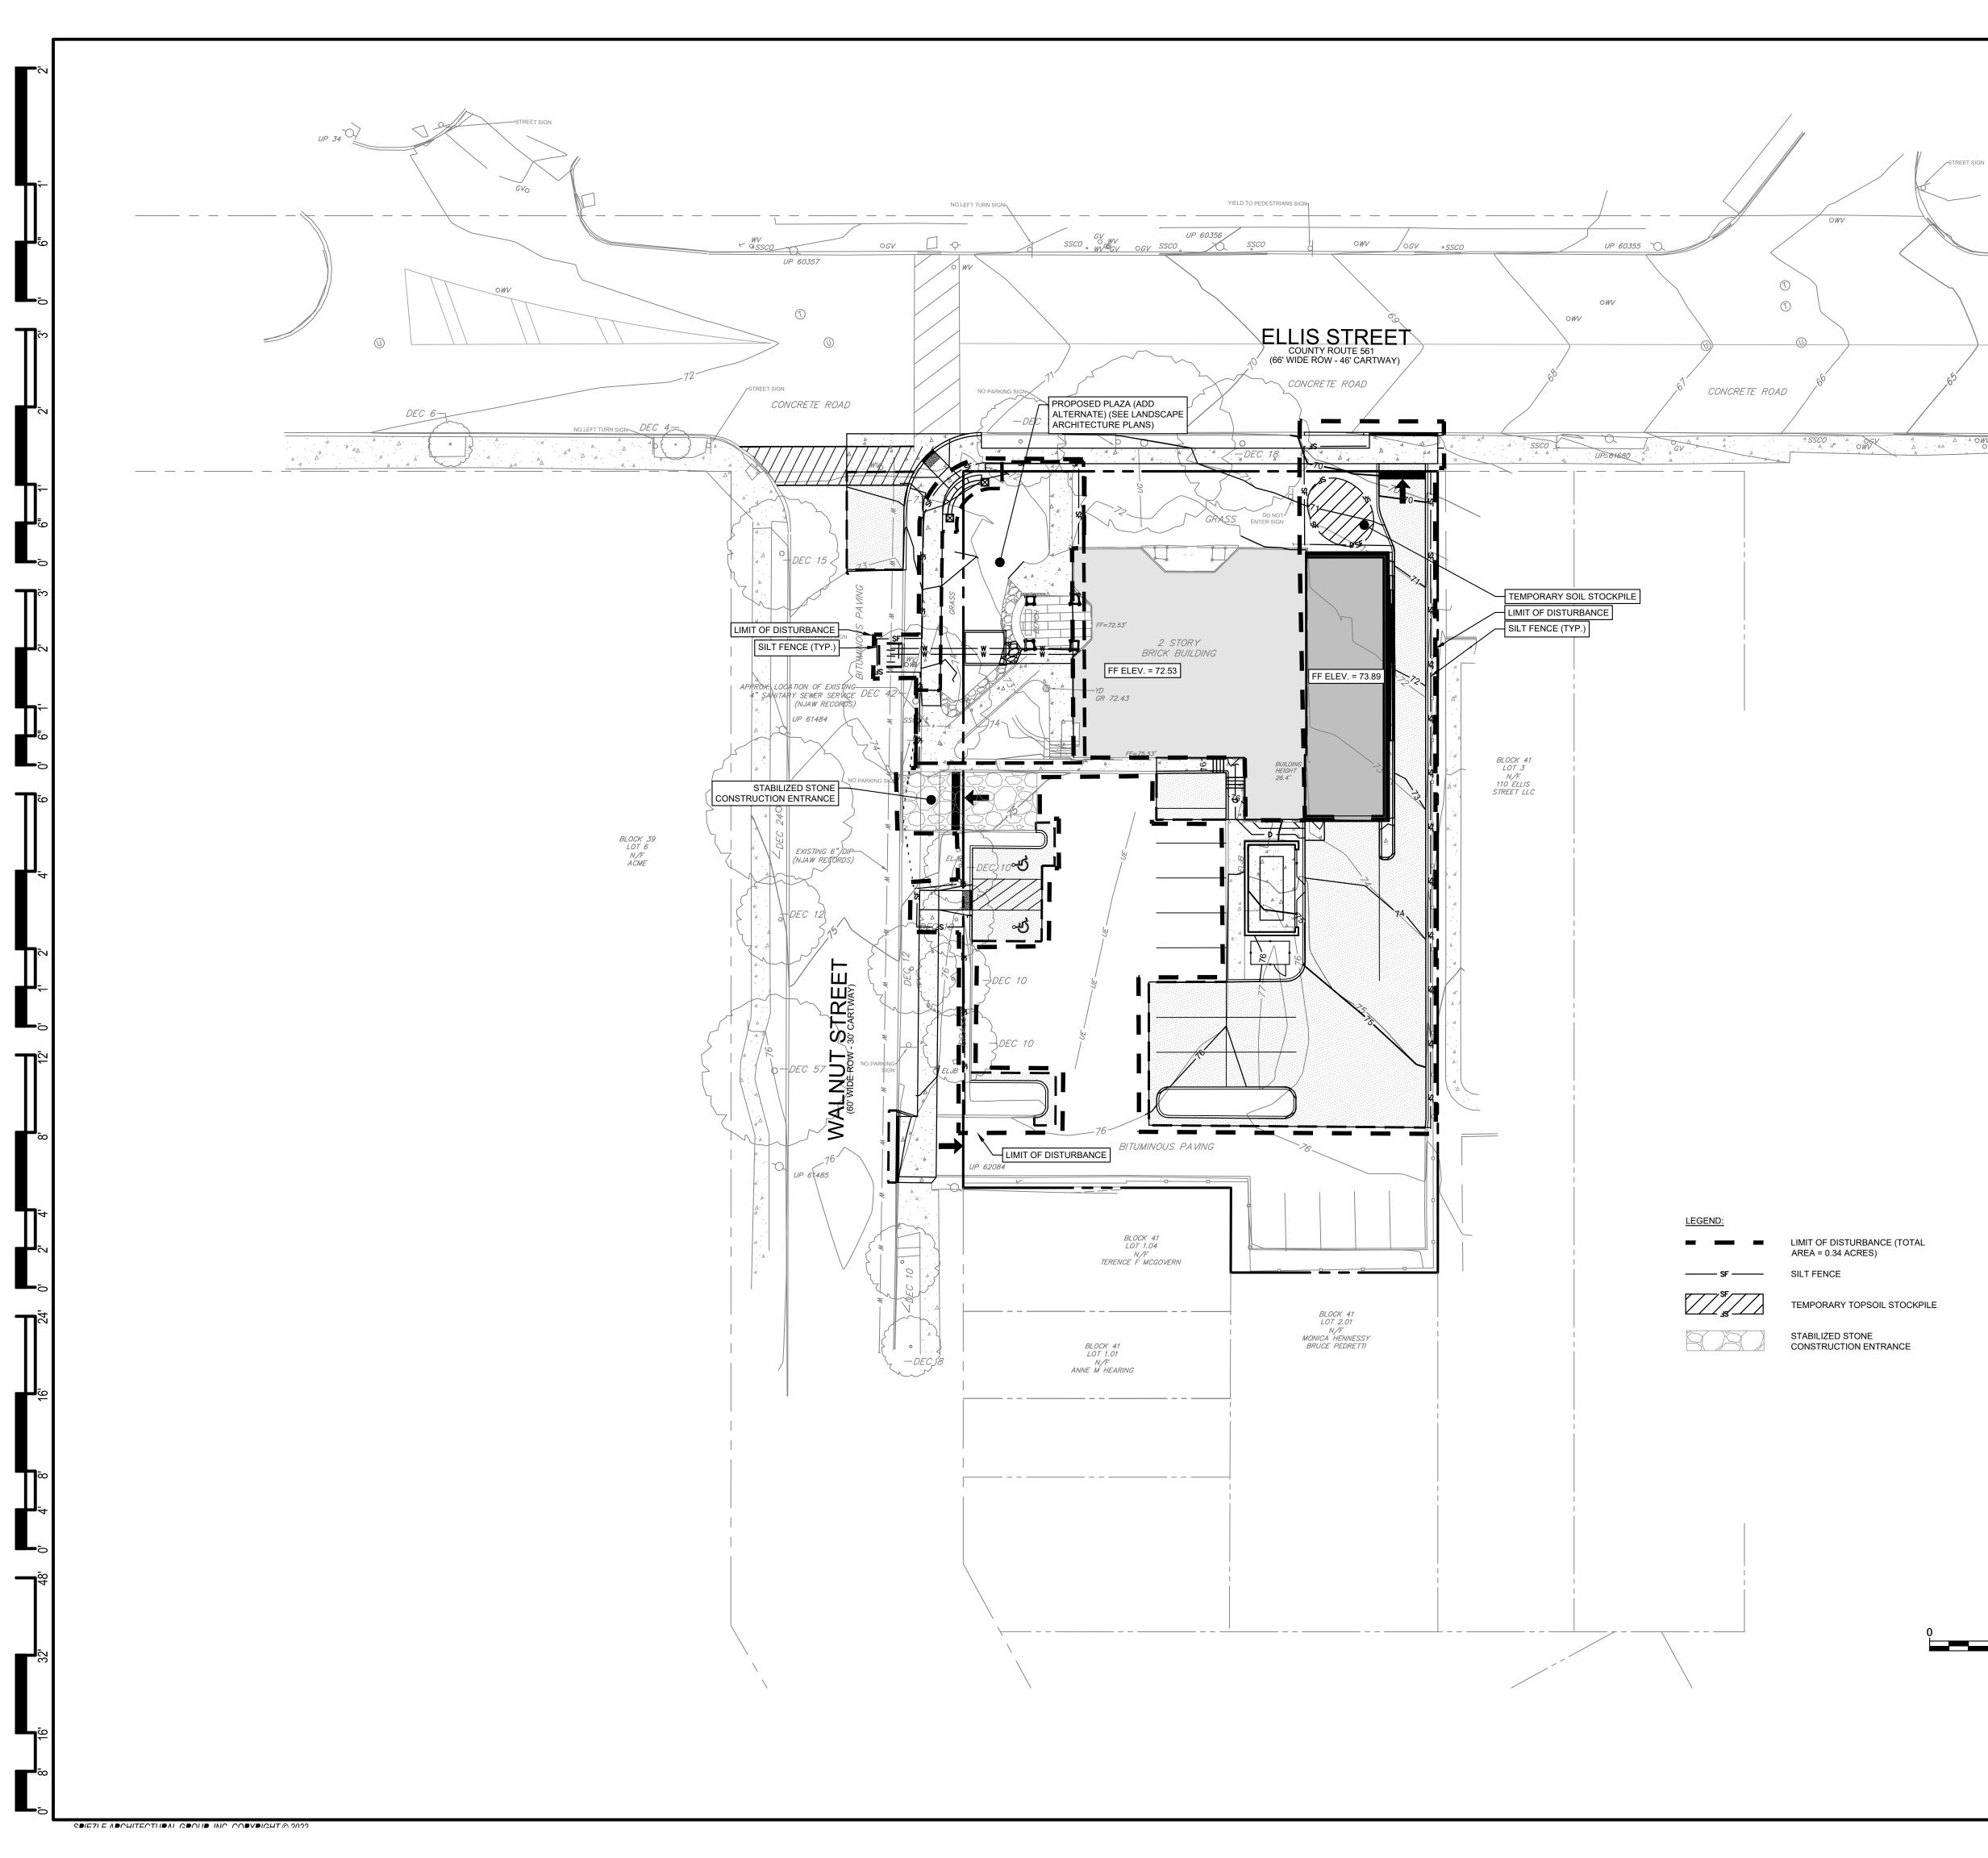


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	INTERIOR DIMENSIONS FOR FIRE & DOMESTIC METER VAULT (DWG SD89) Without PRV Assembly With PRV Assembly							
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3	10.00	8.00	6.50	11.00	8.00	6.50		
4	11.00	9.00	6.50	13.00	9.00	6.50		
6	12.00	9.00	6.50	15.00	9.00	6.50	1	
8	13.00	10.00	6.50	16.00	10.00	6.50]	
10	16.00	10.00	7.00	19.00	10.00	7.00]	

CERTIFICATE:
SPIEZLE ARCHITECTURAL GROUP INC.
121 MARKET STREET CAMDEN, NJ 08102
CAMDEN, NJ 08102 PHONE: (866) 974 7666
SIGNATURE: THOMAS S. PERRINO 21AI01505400
SCOTT E. DOWNIE 21AI01674400 STEVEN LEONE 21A01170100
STEVEN G. SIEGEL 21AI01564200 ANGELO ALBERTO 21AI01046700 JOHN F. WRIGHT 21AI01784200
SPIEZLE ARCHITECTURAL GROUP, INC. 21AC00063000
SEAL:
JACQUELINE R BERENATO
PROFESSIONAL ENGINEER
NEW JERSEY LICENSE NO. GE 56282
Jacqueline Berenato 2/23/24
FOR BID
06/25/2024
PROJECT:
HADDONFIELD POLICE
STATION
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HADDONFIELD, NEW JERSEY 08033
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FOR
CAMDEN COUNTY
IMPROVEMENT
AUTHORITY
520 MARKET STREET, 6TH FLOOR CAMDEN, NEW JERSEY 08102
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	Jacqueline Berenato 2/23/24
	FOR BID
	06/25/2024
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	1 WALNUT STREET HADDONFIELD, NEW JERSEY 08033
	FOR
	CAMDEN COUNTY
	IMPROVEMENT
	AUTHORITY 520 MARKET STREET, 6TH FLOOR
	CAMDEN, NEW JERSEY 08102
	FOR CODE REVIEW: 02/23/24
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	FOR BID: 05/30/24
	DRAWING TITLE:
	SOIL EROSION AND SEDIMENT CONTROL PLAN
	COMMISSION NUMBER:
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SOIL EROSION AND SEDIMENTATION CONTROL NOTES:

- 1. ALL APPLICABLE EROSION AND SEDIMENT CONTROL PRACTICES SHALL BE IN PLACE PRIOR TO ANY GRADING OPERATION AND/OR INSTALLATION OF PROPOSED STRUCTURES OR UTILITIES.
- 2. SOIL EROSION AND SEDIMENT CONTROL PRACTICES ON THIS PLAN SHALL BE CONSTRUCTED IN ACCORDANCE WITH THE STANDARDS FOR SOIL EROSION AND SEDIMENT CONTROL IN NEW JERSEY.
- APPLICABLE EROSION AND SEDIMENT CONTROL PRACTICES SHALL BE LEFT IN PLACE UNTIL CONSTRUCTION IS COMPLETED AND/OR THE AREA IS STABILIZED.
- 4. THE CONTRACTOR SHALL PERFORM ALL WORK, FURNISH ALL MATERIALS AND INSTALL ALL MEASURES REQUIRED TO REASONABLY CONTROL SOIL EROSION RESULTING FROM CONSTRUCTION OPERATIONS AND PREVENT EXCESSIVE FLOW OF SEDIMENT FROM THE CONSTRUCTION SITE.
- ANY DISTURBED AREA THAT IS TO BE LEFT EXPOSED FOR MORE THAN THIRTY (30) DAYS AND NOT SUBJECT TO CONSTRUCTION TRAFFIC SHALL IMMEDIATELY RECEIVE A TEMPORARY SEEDING AND FERTILIZATION IN ACCORDANCE WITH THE NEW JERSEY STANDARDS AND THEIR RATES SHOULD BE INCLUDED IN THE NARRATIVE. IF THE SEASON PROHIBITS TEMPORARY SEEDING, THE DISTURBED AREAS WILL BE MULCHED WITH SALT HAY OR EQUIVALENT AND ANCHORED IN ACCORDANCE WITH THE NEW JERSEY STANDARDS (I.E. PEG AND TWINE, MULCH NETTING OR LIQUID MULCH BINDER).
- 6. IT SHALL BE THE RESPONSIBILITY OF THE CONTRACTOR TO PROVIDE CONFIRMATION OF LIME, FERTILIZER AND SEED APPLICATION AND RATES OF APPLICATION AT THE REQUEST OF THE CAMDEN SOIL CONSERVATION DISTRICT.
- ALL CRITICAL AREAS SUBJECT TO EROSION WILL RECEIVE A TEMPORARY SEEDING IN COMBINATION WITH STRAW MULCH AT A RATE OF 2 TONS PER ACRE ACCORDING TO THE NEW JERSEY STANDARDS IMMEDIATELY FOLLOWING ROUGH GRADING.
- 8. THE SITE SHALL AT ALL TIMES BE GRADED AND MAINTAINED SUCH THAT ALL STORMWATER RUNOFF IS DIVERTED TO SOIL EROSION AND SEDIMENT CONTROL FACILITIES.
- 9. ALL SEDIMENTATION STRUCTURES WILL BE INSPECTED AND MAINTAINED ON A REGULAR BASIS AND AFTER EVERY STORM EVENT.
- 10. A CRUSHED STONE, TIRE CLEANING PAD WILL BE INSTALLED WHEREVER A CONSTRUCTION ACCESS EXISTS. THE STABILIZED PAD WILL BE INSTALLED ACCORDING TO THE STANDARD FOR STABILIZED CONSTRUCTION ACCESS.
- 11. ALL DRIVEWAYS MUST BE STABILIZED WITH 2-1/2" CRUSHED STONE OR SUBBASE RIOR TO INDIVIDUAL LOT CONSTRUCTION.
- 12. PAVED AREAS MUST BE KEPT CLEAN AT ALL TIMES.
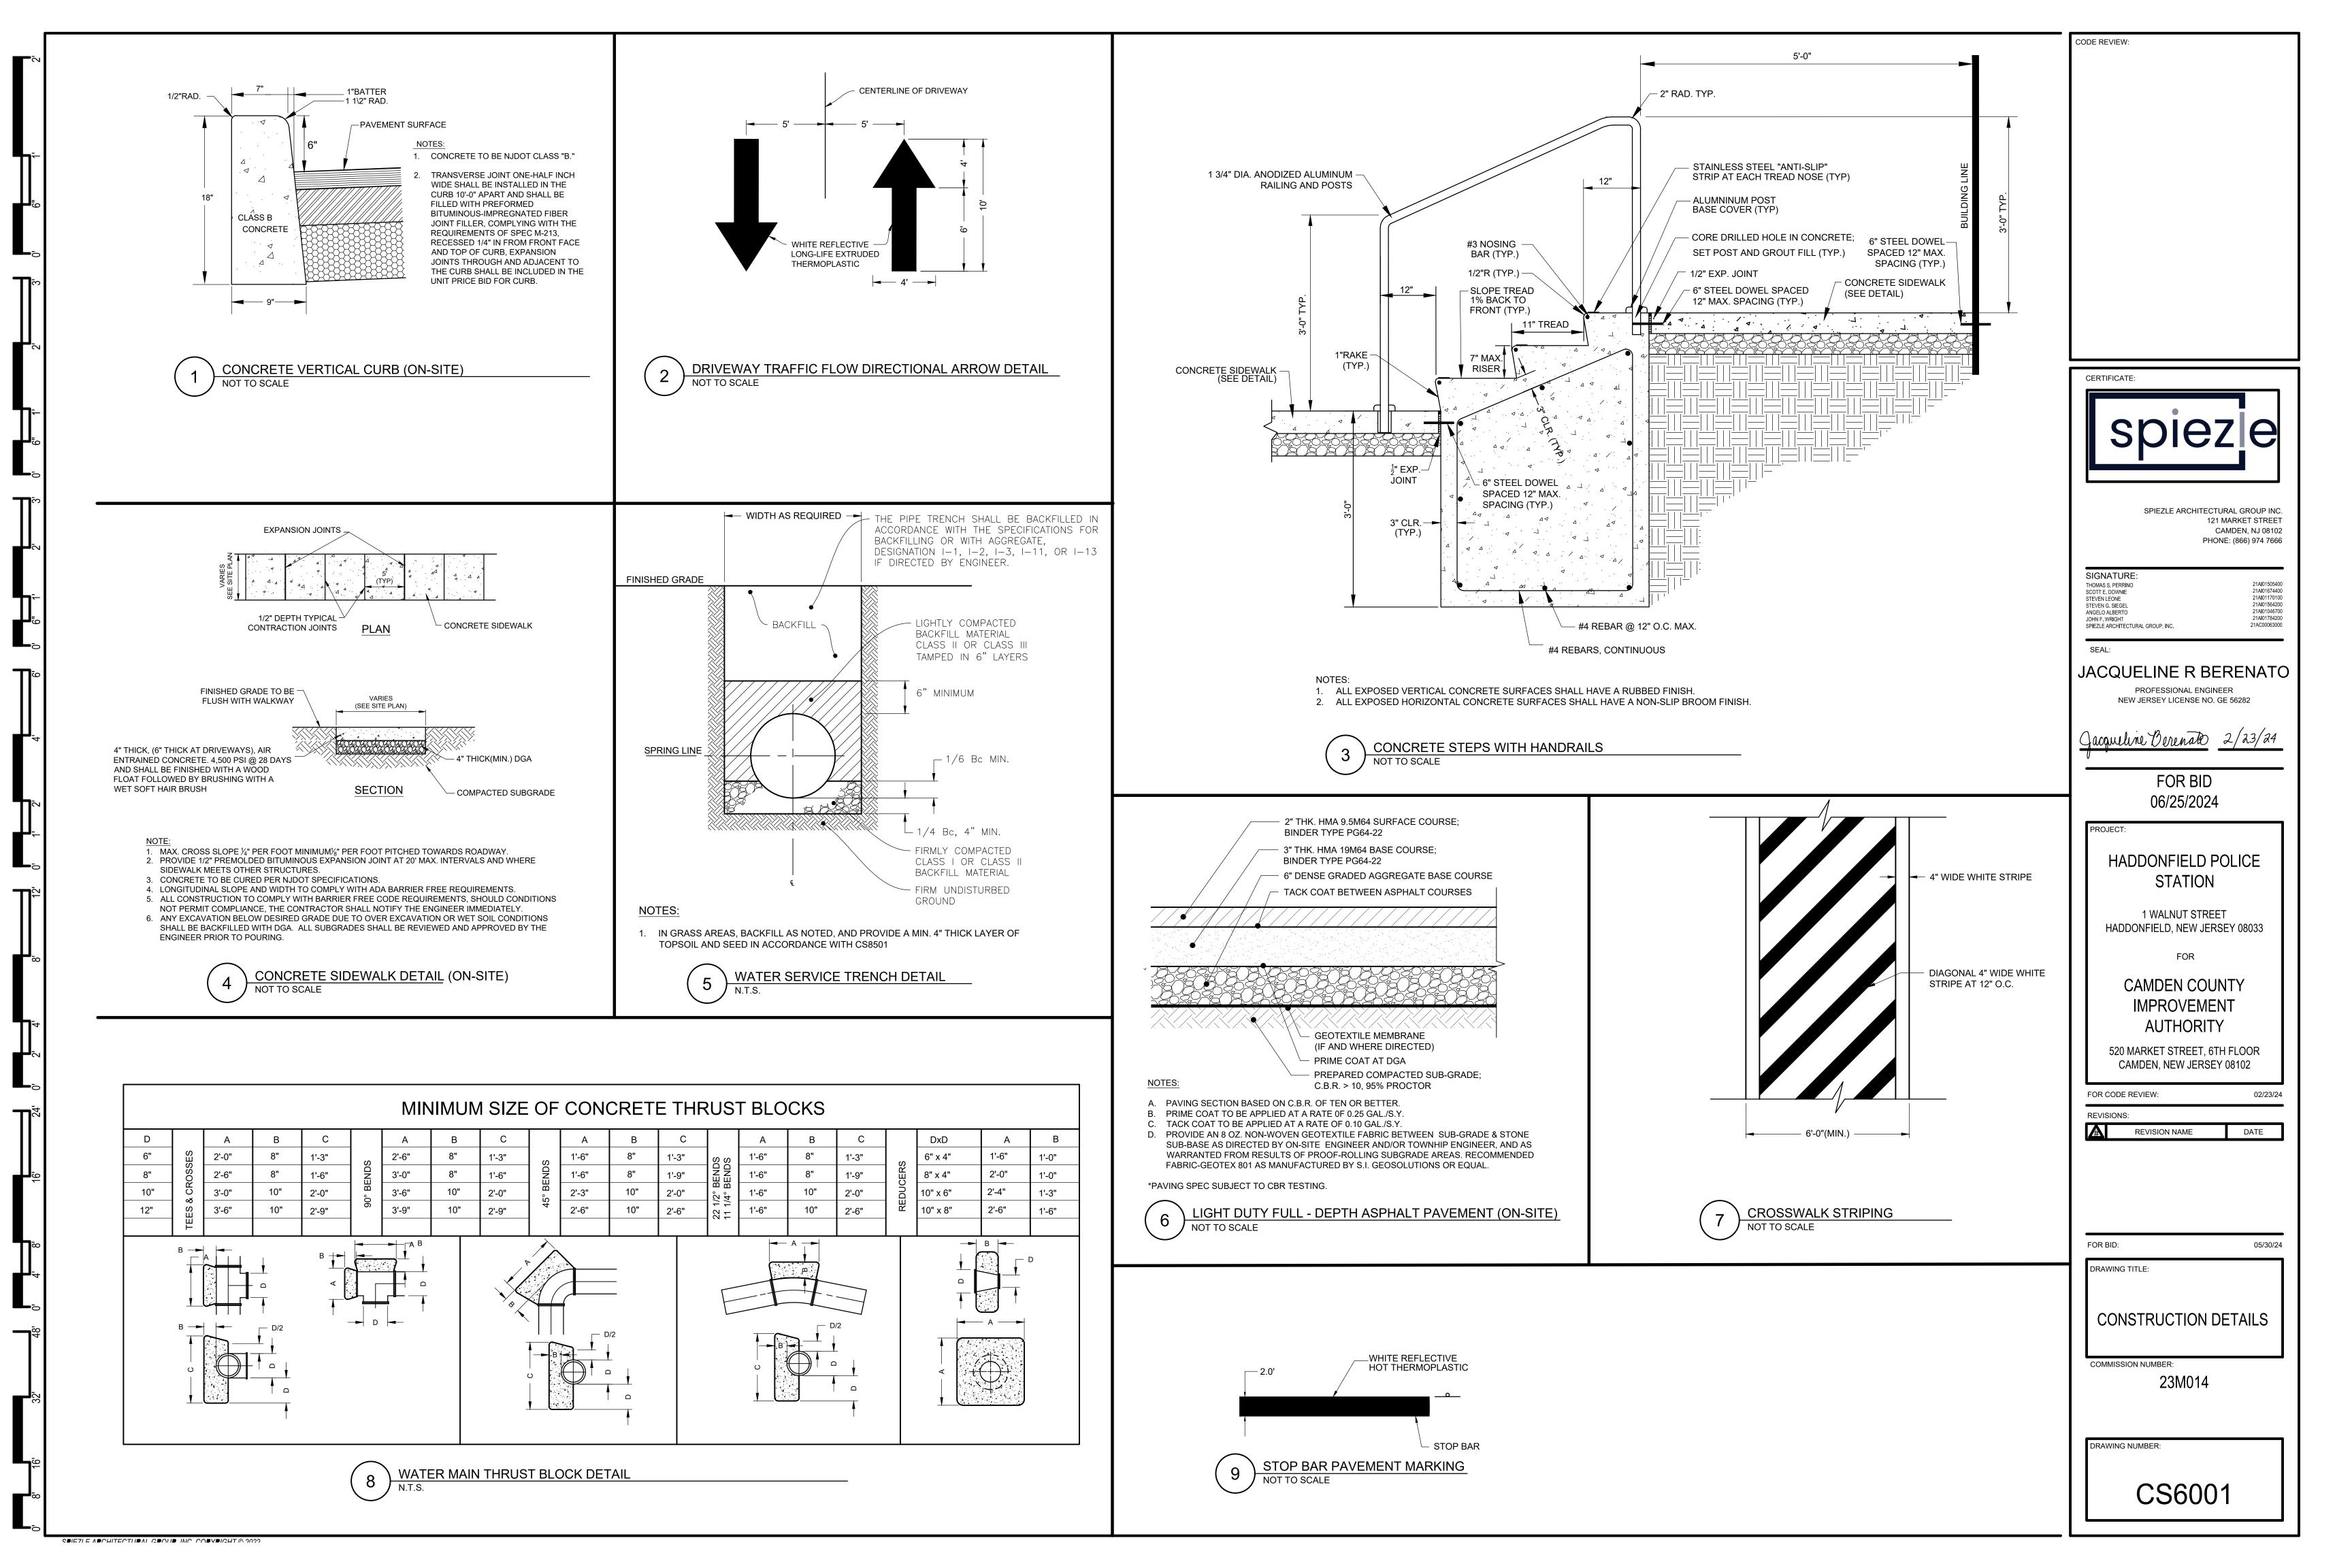
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- 13. ALL CATCH BASIN INLETS WILL BE PROTECTED ACCORDING TO THE CERTIFIED PLAN. 14. ALL STORM DRAINAGE OUTLETS WILL BE STABILIZED, AS REQUIRED BEFORE THE DISCHARGE POINTS BECOME OPERATIONAL.
- 15. ALL DEWATERING OPERATIONS MUST DISCHARGE DIRECTLY INTO A SEDIMENT FILTER AREA. THE SEDIMENT FILTER SHOULD BE COMPOSED OF A SUITABABLE SEDIMENT FILTER FABRIC. (SEE DETAIL). THE BASIN MUST BE DEWATERED TO NORMAL POOL WITHIN 10 DAYS OF THE DESIGN STORM.
- 16. NJSA 4:24-39, ET SEQ. REQUIRES THAT NO CERTIFICATE OF OCCUPANCY BE ISSUED BEFORE ALL PROVISIONS OF THE CERTIFIED SOIL EROSION AND SEDIMENT CONTROL PLAN HAVE BEEN COMPLIED WITH FOR PERMANENT MEASURES ALL SITE WORK FOR THE PROJECT MUST BE COMPLETED PRIOR TO THE DISTRICT ISSUING A REPORT OF COMPLIANCE A PREREQUISITE TO THE ISSUANCE OF A CERTIFICATE OF OCCUPANCY BY THE MUNICIPALITY.
- 17. MULCHING IS REQUIRED ON ALL SEEDED AREAS TO INSURE AGAINST EROSION BEFORE GRASS IS ESTABLISHED TO PROMOTE EARLIER VEGETATION COVER.
- 18. OFFSITE SEDIMENT DISTURBANCE MAY REQUIRE ADDITIONAL CONTROL MEASURES TO BE DETERMINED BY THE EROSION CONTROL INSPECTOR.
- 19. A COPY OF THE CERTIFIED SOIL EROSION AND SEDIMENT CONTROL PLAN MUST BE MAINTAINED ON THE PROJECT SITE DURING CONSTRUCTION.
- 20. THE CAMDEN COUNTY SOIL CONSERVATION DISTRICT SHALL BE NOTIFIED 72 HOURS PRIOR TO ANY LAND DISTURBANCE.
- 21. ANY CONVEYANCE OF THIS PROJECT PRIOR TO ITS COMPLETION WILL TRANSFER FULL RESPONSIBLITY FOR COMPLIANCE WITH THE CERTIFIED PLAN TO ANY SUBSEQUENT OWNERS.
- 22. IMMEDIATELY AFTER THE COMPLETION OF STRIPPING AND STOCKPILING OF TOPSOIL. THE STOCKPILE MUST BE STABILIZED ACCORDING TO THE STANDARD FOR TEMPORARY VEGETATIVE COVER. STABILIZE TOPSOIL STOCKPILE WITH STRAW MULCH FOR PROTECTION IF THE SEASON DOES NOT PERMIT THE APPLICATION AND ESTABLISHMENT OF TEMPORARY SEEDING. ALL SOIL STOCKPILES ARE NOT TO BE LOCATED WITHIN FIFTY (50) FEET OF A FLOODPLAIN, SLOPE, ROADWAY OR DRAINAGE FACILITY AND THE BASE MUST BE PROTECTED WITH A SEDIMENT BARRIER.
- 23. ANY CHANGES TO THE SITE PLAN WILL REQUIRE THE SUBMISSION OF A REVISED SOIL FROSION AND SEDIMENT CONTROL PLAN TO THE CAMDEN COUNTY SOIL CONSERVATION DISTRICT. THE REVISED PLAN MUST BE IN ACCORDANCE WITH THE CURRENT NEW JERSEY STANDARDS FOR SOIL EROSION AND SEDIMENT CONTROL.
- 24. METHODS FOR THE MANAGEMENT OF HIGH ACID PRODUCING SOILS SHALL BE IN ACCORDANCE WITH THE STANDARDS. HIGH ACID PRODUCING SOILS ARE THOSE FOUND TO CONTAIN IRON SULFIDES OR HAVE A PH OF 4 OR LESS.
- 25. TEMPORARY AND PERMANENT SEEDING MEASURES MUST BE APPLIED ACCORDING TO THE NEW JERSEY STANDARDS, AND MULCHED WITH SALT HAY OR EQUIVALENT AND ANCHORED IN ACCORDANCE WITH THE NEW JERSEY STANDARDS (I.E. PEG AND TWINE, MULCH NETTING OR LIQUID MULCH BINDER).
- 26 MAXIMUM SIDE SLOPES OF ALL EXPOSED SURFACES SHALL NOT BE CONSTRUCTED STEEPER THAN 3:1 UNLESS OTHERWISE APPROVED BY THE DISTRICT.
- 27. DUST IS TO BE CONTROLLED BY AN APPROVED METHOD ACCORDING TO THE NEW JERSEY STANDARDS AND MAY INCLUDE WATERING WITH A SOLUTION OF CALCIUM CHLORIDE AND WATER.
- 28. ADJOINING PROPERTIES SHALL BE PROTECTED FROM EXCAVATION AND FILLING OPERATIONS ON THE PROPOSED SITE.
- 29. USE STAGED CONSTRUCTION METHODS TO MINIMIZE EXPOSED SURFACES WHERE APPLICABLE.
- 30. ALL VEGETATIVE MATERIAL SHALL BE SELECTED IN ACCORDANCE WITH AMERICAN STANDARDS FOR NURSERY STOCK OF THE AMERICAN ASSOCIATION OF THE NURSERYMAN AND IN ACCORDANCE WITH THE NEW JERSEY STANDARDS.
- 31. NATURAL VEGETATION AND SPECIES SHALL BE RETAINED WHERE SPECIFIED ON THE I ANDSCAPING PLAN
- 32. THE SOIL EROSION INSPECTOR MAY REQUIRE ADDITIONAL SOIL EROSION MEASURES TO BE INSTALLED, AS DIRECTED BY THE DISTRICT INSPECTOR.

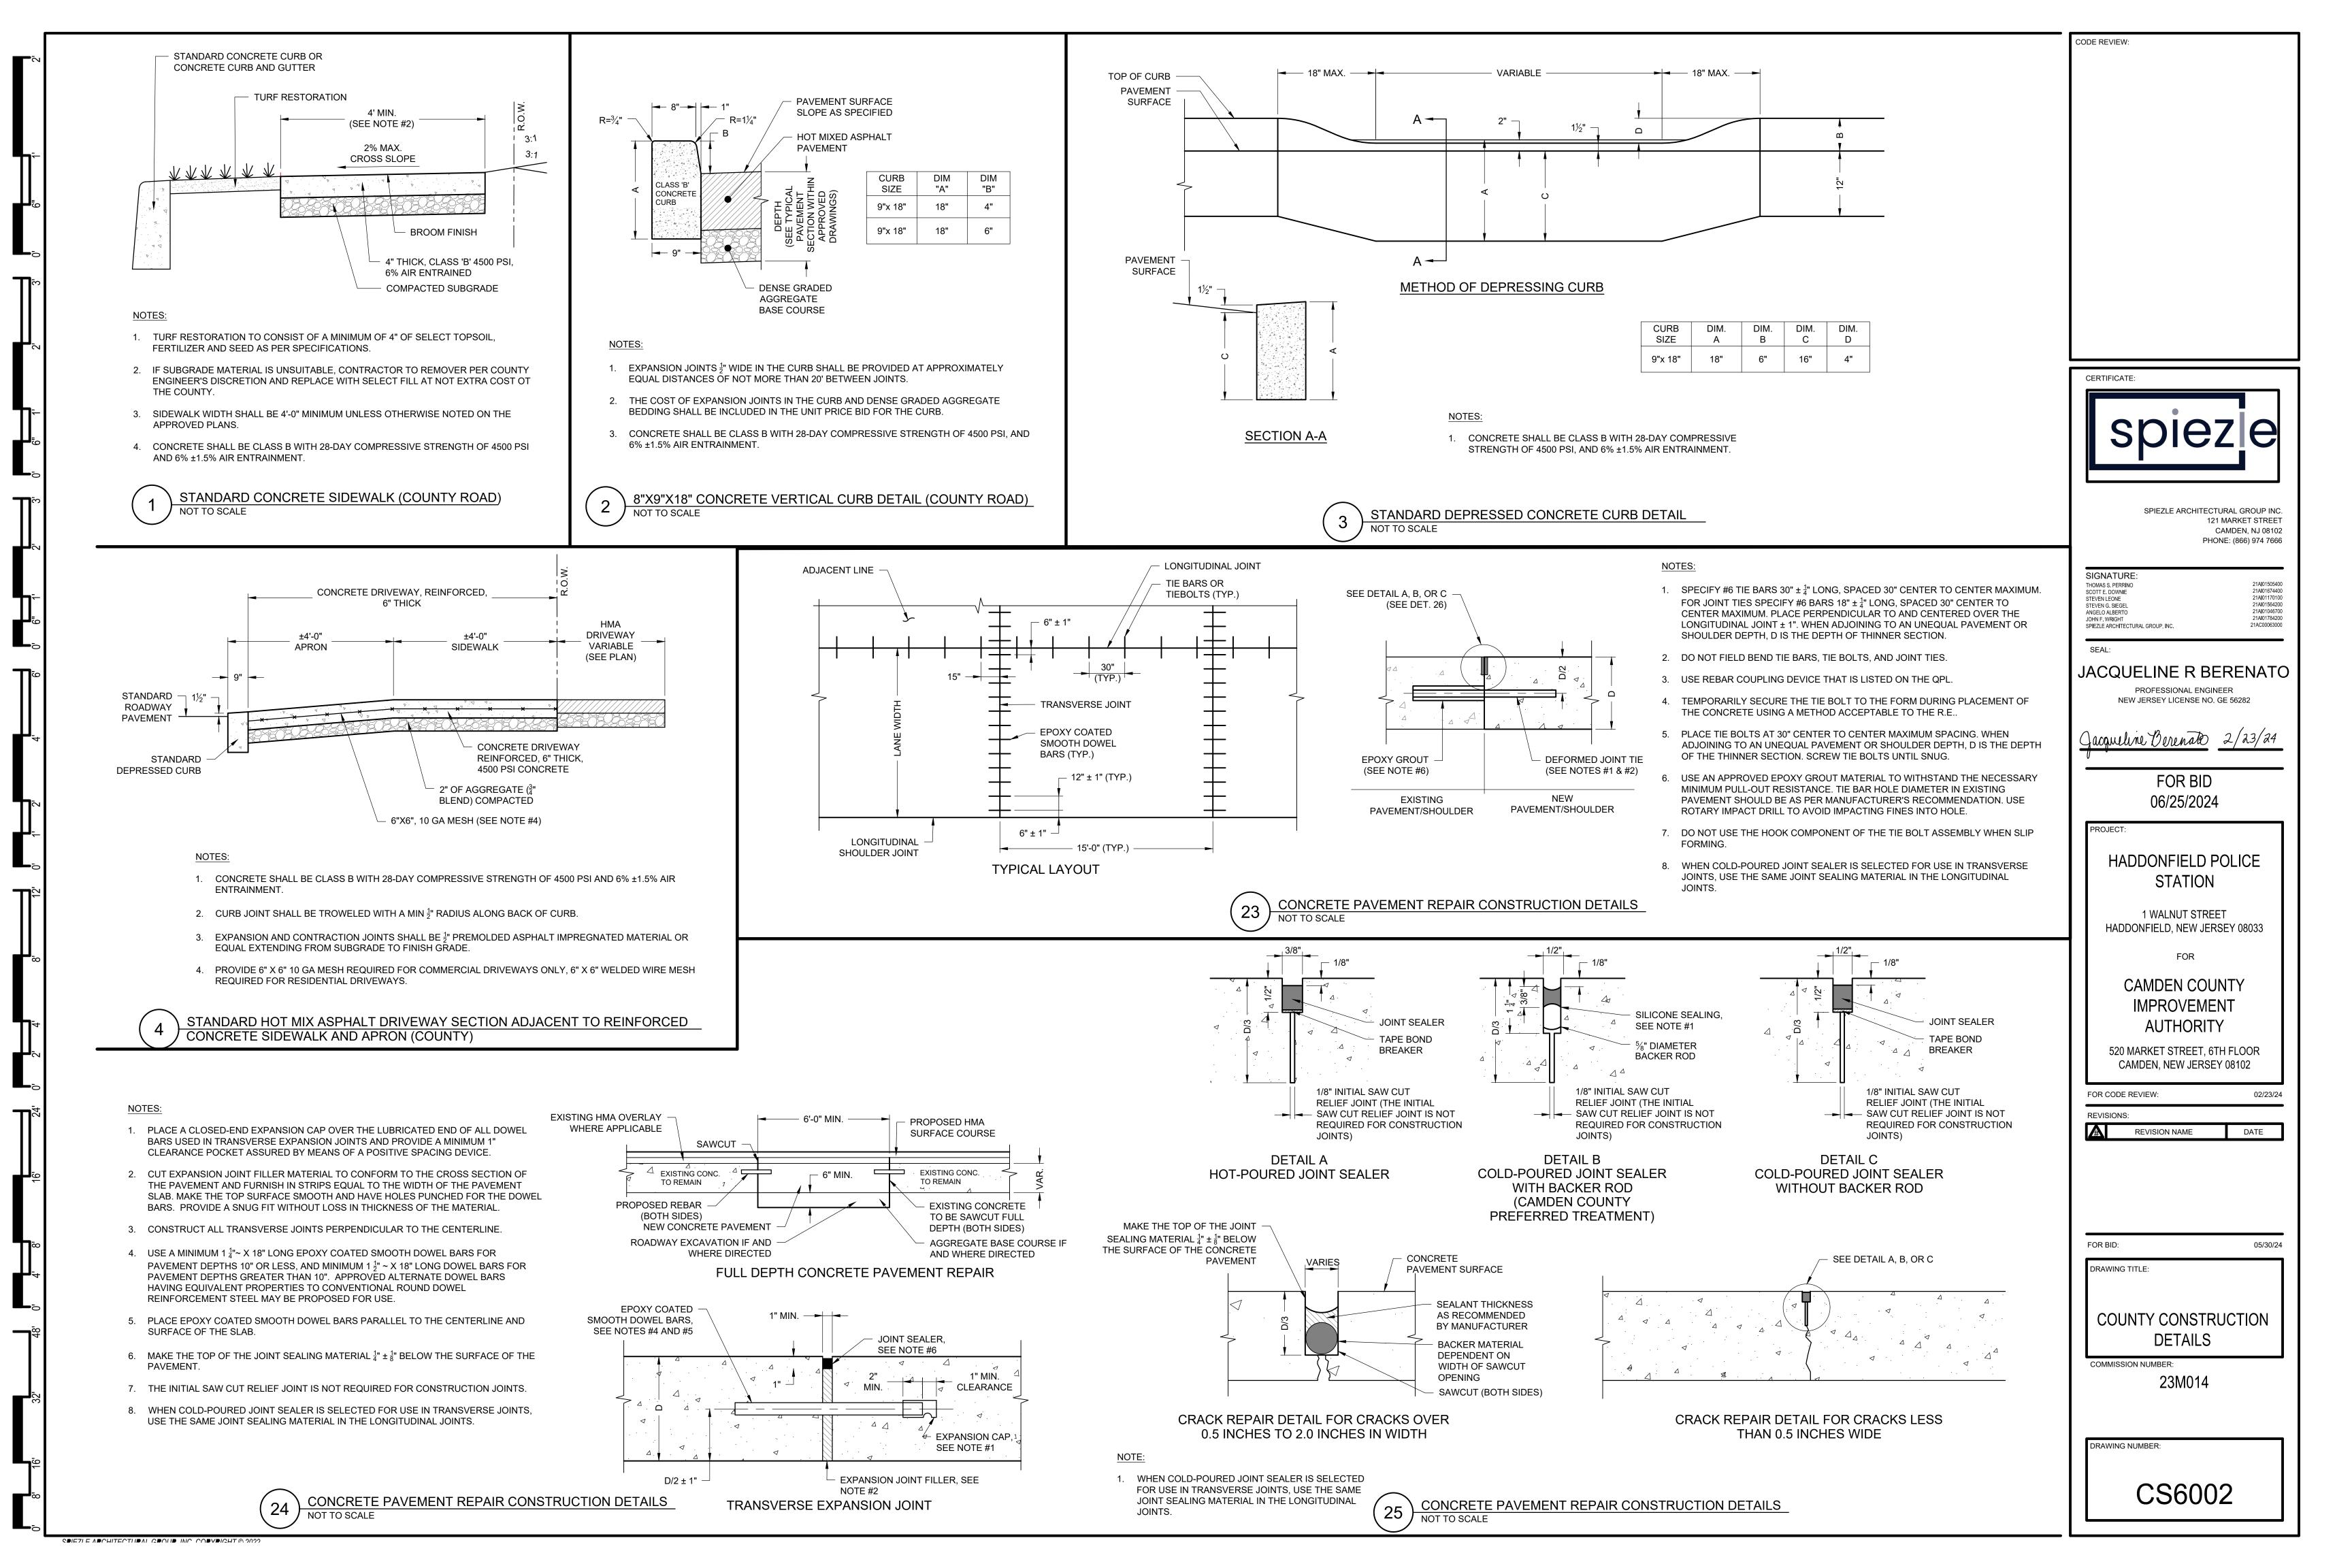STANDARD FOR TEMPORARY VEGETATIVE COVER FOR SOIL STABILIZATION:

DEFINITION

ESTABLISHMENT OF TEMPORARY VEGETATIVE COVER ON SOILS EXPOSED FOR PERIODS OF TWO TO 6 MONTHS WHICH ARE NOT BEING GRADED, NOT UNDER ACTIVE CONSTRUCTION OR NOT SCHEDULED FOR PERMANENT SEEDING WITHIN 60 DAYS.

PURPOSE TO TEMPORARILY STABILIZE THE SOIL AND REDUCE DAMAGE FROM WIND AND WATER

EROSION UNTIL PERMANENT STABILIZATION IS ACCOMPLISHED. WATER QUALITY ENHANCEMENT

PROVIDES TEMPORARY PROTECTION AGAINST THE IMPACTS OF WIND AND RAIN, SLOWS THE OVERLAND MOVEMENT OF STORMWATER RUNOFF. INCREASES INFILTRATION AND RETAINS SOIL AND NUTRIENTS ON SITE, PROTECTING STREAMS OR OTHER STORMWATER CONVEYANCES.

WHERE APPLICABLE

ON EXPOSED SOILS THAT HAVE THE POTENTIAL FOR CAUSING OFF-SITE ENVIRONMENTAL DAMAGE.

METHODS AND MATERIALS

SITE PREPARATION

- GRADE AS NEEDED AND FEASIBLE TO PERMIT THE USE OF CONVENTIONAL EQUIPMENT FOR SEEDBED PREPARATION, SEEDING, MULCH APPLICATION, AND MULCH ANCHORING. ALL GRADING SHOULD BE DONE IN ACCORDANCE WITH STANDARDS FOR LAND GRADING, P. 19-1.
- INSTALL NEEDED EROSION CONTROL PRACTICES OR FACILITIES SUCH AS DIVERSIONS, GRADE STABILIZATION STRUCTURES, CHANNEL STABILIZATION MEASURES, SEDIMENT BASINS, AND WATERWAYS, SEE STANDARDS 11 THROUGH 42
- C. IMMEDIATELY PRIOR TO SEEDING, THE SURFACE SHOULD BE SCARIFIED 6" TO 12" WHERE THERE HAS BEEN SOIL COMPACTION. THIS PRACTICE IS PERMISSIBLE ONLY WHERE THERE IS NO DANGER TO UNDERGROUND UTILITIES (CABLES, IRRIGATION SYSTEMS, ETC.).

2. SEED BED PREPARATION

A. APPLY GROUND LIMESTONE AND FERTILIZER ACCORDING TO SOIL TEST RECOMMENDATIONS SUCH AS THOSE OFFERED BY RUTGERS CO-OPERATIVE EXTENSION. SOIL SAMPLE MAILERS ARE AVAILABLE FROM THE LOCAL RUTGERS CO-OPERATIVE EXTENSION OFFICES. FERTILIZER SHALL BE APPLIED AT THE RATE OF 500 PONDS PER ACRE OR 11 POUNDS PER 1.000 SQUARE FEET OF 10-20-10 OR EQUIVALENT WITH 50% WATER INSOLUABLE NITROGEN UNLESS A SOIL TEST INDICATES OTHERWISE, APPLY LIMESTONE AT THE RATE OF 2 TONS/ACRE UNLESS SOIL TEST INDICATES OTHERWISE. CALCIUM CARBONATE IS THE EQUIVALENT AND STANDARD FOR MEASURING THE ABILITY OF LIMING MATERIALS TO NEUTRALIZE SOIL ACIDITY AND SUPPLY CALCIUM AND MAGNESIUM TO GRASSES AND LEGUMES. TABLE BELOW IS A GENERAL GUIDELINE FOR LIMESTONE APPLICATION

SOIL TEXTURE	TONS/ACRE	LBS./1,000 S.F.
CLAY, CLAY LOAM, AND HIGH ORGANIC SOIL	3	135
SANDY LOAM, LOAM, SILT LOAM	2	90
LOAMY SAND, SAND	1	45

PULVERIZED DOLOMITIC LIMESTONE IS PREFERRED FOR MOST SOILS SOUTH OF THE NEW BRUNSWICK-TRENTON LINE.

- B. WORK LIME AND FERTILIZER INTO THE SOIL AS NEARLY AS PRACTICAL TO A DEPTH OF 4 INCHES WITH A DISC. SPRINGTOOTH HARROW, OR OTHER SUITABLE EQUIPMENT. THE FINAL HARROWING OR DISCING OPERATION SHOULD BE ON THE GENERAL CONTOUR. CONTINUE TILLAGE UNTIL A REASONABLY UNIFORM SEEDBED IS PREPARED.
- C. INSPECT SEEDBED JUST BEFORE SEEDING. IF TRAFFIC HAS LEFT THE SOIL COMPACTED, THE AREA MUST BE RETILLED AS ABOVE.
- D. SOILS HIGH ON SULFIDES OR HAVING A PH OF 4 OR LESS REFER TO STANDARD FOR MANAGEMENT OF HIGH ACID PRODUCING SOILS, PG. 1-1 OF THE STANDARDS FOR SOIL FROSION AND SEDIMENT CONTROL IN NEW JERSEY

SEEDING

Α.	SELECT SEED FROM RECOMMENDATIONS IN TABL

		NG RATES 1* OUNDS)	OPTIMUM SEEDING DATE 2* BASED ON PLANT HARDINESS ZON			
SEED TYPES	PER ACRE	PER 1,000 SQ. FT.	ZONE 5	ZONE 6	zo	
COOL SEASON GRASSES						
PERENNIAL RYEGRASS	170	4.0	3/15 - 6/1 & 8/1 - 9/15	3/1 - 5/15 & 8/15 - 10/1	2/15 - 5/ 8/15 - 10	
SPRING OATS	86	2.0	3/15 - 6/1 & 8/1 - 9/15	3/1 - 5/15 & 8/15 - 10/1	2/15 - 5/ 8/15 - 10	
WINTER BARLEY	96	2.2	8/1 - 9/15	8/15 - 10/1	8/15 - 10	
WINTER CEREAL RYE	112	2.8	8/1 - 11/1	8/1 - 11/15	8/1 - 12/	
WARM SEASON GRASSES						
PEARL MILLET	20	0.5	6/1 - 8/1	5/15 - 8/15	5/1 - 9/1	
MILLET (GERMAN OR HUNGARIAN	30	0.7	6/1 - 8/1	5/15 - 8/15	5/1 - 9/1	
WEEPING LOVEGRASS	5	0.2	6/1 - 8/1	5/15 - 8/15	5/1 - 9/1	

- SEEDING RATE FOR WARM SEASON GRASS, SHALL BE ADJUSTED TO REFLECT THE AMOUNT OF PURE LINE SEED (PLS) AS DETERMINED BY A GERMINATION TEST RESULT. NO ADJUSTMENT IS REQUIRED FOR COOL SEASON GRASSES.
- MAY BE PLANTED THROUGHOUT SUMMER IF SOIL MOISTURE IS ADEQUATE OR CAN BE IRRIGATED
- 3* PLANT HARDINESS ZONE (SEE BELOW) 4* TWICE THE DEPTH FOR SANDY SOILS

ZONE 5B (-10 TO -15 PORTIONS OF SUSSEX AND WARREN COUNTIES

PORTIONS OF SUSSEX, WARREN, PASSAIC, MORRIS, SOMERSET AND HUNTERDON COUNTIES.

PORTIONS OR BERGEN, CAMDEN, ESSEX AND GLOUCESTER, HUNTERDON, MERCER, MIDDLESEX, HUDSON, MONMOUTH,

OCEAN, BURLINGTON, MORRIS, PASSAIC, SOMERSET, UNION, ATLANTIC, CUMBERLAND, AND CAPE MAY COUNTIES. 70NF 7A (5 TO 0

PORTIONS OF CAMDEN, GLOUCESTER, SALEM, CUMBERLAND, CAPE MAY, ATLANTIC, BURLINGTON, OCEAN, AND MONMOUTH COUNTIES. ZONE 7B (10 TO 5) PORTIONS OF CAPEMAY, ATLANTIC, OCEAN AND MONMOUTH COUNTIES.

- B. CONVENTIONAL SEEDING APPLY SEED UNIFORMLY BY HAND, CYCLONE (CENTRIFUGAL) SEEDER, DROP SEEDER, DRILL OR CULTIPACKER SEEDER. EXCEPT FOR DRILLED, HYDROSEEDED OR CULTIPACKED SEEDINGS SEED SHALL BE INCORPORATED INTO THE SOIL, TO A DEPTH OF 1/4 TO 1/2 INCH, BY RAKING OR DRAGGING, DEPTH OF SEED PLACEMENT MAY BE 1/4 INCH DEEPER ON COARSE TEXTURED SOIL.
- HYDROSEEDING IS A BROADCAST SEEDING METHOD USUALLY INVOLVING A TRUCK OR TRAILER MOUNTED TANK, WITH AN AGITATION SYSTEM AND HYDRAULIC PUMP FOR MIXING SEED, WATER AND FERTILIZER AND SPRAYING THE MIX ONTO THE PREPARED SEEDBED. MULCH SHALL NOT BE INCLUDED IN THE TANK WITH SEED. SHORT FIBERED MULCH MAY BE APPLIED WITH A HYDROSEEDER FOLLOWING SEEDING. HYDROSEEDING IS NOT A PREFERRED SEEDING METHOD BECAUSE SEED AND FERTILIZER ARE APPLIED TO THE SURFACE AND NOT INCORPORATED INTO THE SOIL. POOR SEED TO SOIL CONTACT OCCURS REDUCING SEED GERMINATION AND GROWTH. HYDROSEEDING MAY BE USED FOR AREAS TOO STEEP FOR CONVENTIONAL EQUIPMENT TO TRAVERSE OR TOO OBSTRUCTED WITH ROCKS, STUMPS, ETC.
- D. AFTER SEEDING, FIRMING THE SOIL WITH A CORRUGATED ROLLER WILL ASSURE GOOD SEED-TO-SOIL CONTACT, RESTORE CAPILLARITY, AND IMPROVE SEEDING EMERGENCE. THIS IS THE PREFERRED METHOD, WHEN PERFORMED ON THE CONTOUR, SHEET EROSION WILL BE MINIMIZED AND WATER CONSERVATION ON SITE WILL BE MAXIMIZED

INESS ZONE 3*

ZONE 7

2/15 - 5/1 &

8/15 - 10/15

2/15 - 5/1 &

8/15 - 10/15

8/15 - 10/15

8/1 - 12/15

MULCHING IS REQUIRED ON ALL SEEDING. MULCH WILL INSURE AGAINST EROSION BEFORE GRASS IS ESTABLISHED AND WILL PROMOTE FASTER AND EARLIER ESTABLISHMENT. (THE EXISTENCE OF VEGETATION SUFFICIENT TO CONTROL SOIL EROSION SHALL BE DEEMED COMPLIANCE WITH THIS MULCHING REQUIREMENT

A. STRAW OR HAY, UNROTTED SMALL GRAIN STRAW, HAY FREE OF SEEDS, OR SALT HAY TO BE APPLIED AT THE RATE OF 1-1/2 TO 2 TONS PER ACRE (70 TO 90 POUNDS PER 1.000 SQUARE FEET). EXCEPT THAT WHERE A CRIMPER IS USED INSTEAD OF LIQUID MULCH-BINDER (TACKIFYING OR ADHESIVE AGENT), THE RATE OF APPLICATION IS 3 TONS PER ACRE. MULCH CHOPPER-BLOWERS MUST NOT GRIND THE MULCH. HAY MULCH IS NOT RECOMMENDED FOR ESTABLISHING FINE TURF OR LAWNS DUE TO THE PRESENCE OF WEED SEED

APPLICATION SPREAD UNIFORMLY BY HAND MECHANICALLY SO THAT APPROXIMATELY 85% OF THE SOIL SURFACE WILL BE COVERED. FOR UNIFORM DISTRIBUTION OF HAND-SPREAD MULCH, DIVIDE AREA INTO APPROXIMATELY 1,000 SQUARE FEET SECTIONS AND DISTRIBUTE 70 TO 90 POUNDS WITHIN EACH SECTION

ANCHORING SHOULD BE ACCOMPLISHED IMMEDIATELY AFTER PLACEMENT TO MINIMIZE LOSS BY WIND OR WATER. THIS MAY BE DONE BY ONE OF THE FOLLOWING METHODS, DEPENDING UPON THE SIZE OF THE AREA, STEEPNESS OF SLOPES, AND COSTS

- PEG AND TWINE DRIVE 8 TO 10 INCH WOODEN PEGS TO WITHIN 2 TO 3 INCHES OF THE SOIL SURFACE EVERY 4 FEET IN ALL DIRECTIONS. STAKES MAY BE DRIVEN BEFORE OR AFTER APPLYING MULCH. SECURE MULCH TO SOIL SURFACE BY STRETCHING TWINE BETWEEN PEGS IN A CRISS-CROSS AND A SQUARE PATTERN. SECURE TWINE AROUND EACH PEG WITH TWO OR MORE ROUND TURNS.
- MULCH NETTINGS STAPLE PAPER, JUTE, COTTON, OR PLASTIC NETTINGS TO THE SOIL URFACE. USE A DEGRADABLE NETTING IN AREAS TO BE MOWED.
- CRIMPER (MULCH ANCHORING TOOL) A TRACTOR-DRAWN IMPLEMENT, SOMEWHAT IKE A DISC-HARROW, ESPECIALLY DESIGNED TO PUSH OR CUT SOME OF THE BROADCAST LONG FIBER MULCH 3 TO 4 INCHES INTO THE SOIL SO AS TO ANCHOR IT AND LEAVE PART STANDING UPRIGHT. THIS TECHNIQUE IS LIMITED TO AREAS TRAVERSABLE BY A TRACTOR, WHICH MUST OPERATE ON THE CONTOUR OF SLOPES. STRAW MULCH RATE MUST BE 3 TONS PER ACRE. NO TACKIFYING OR ADHESIVE AGENT IS REQUIRED
- 4. LIQUID MULCH-BINDERS MAY BE USED TO ANCHOR SALT HAY OR STRAW MULCHES.
- a. APPLICATIONS SHOULD BE HEAVIER AT EDGES WHERE WIND CATCHES THE MULCH, IN VALLEYS, AND AT CRESTS OF BANKS. REMAINDER OF AREA SHOULD BE UNIFORM IN APPEARANCE
- b. USE ONE OF THE FOLLOWING:
- (1) EMULSIFIED ASPHALT (SS-1, CSS-1, CMS-2, MS-2, RS-1, RS-2, CRS-1, AND CRS-2). APPLY 0.04 GAL/SQ. YD. OR 194 GAL/ACRE ON FLAT SLOPES LESS THAN 8 FEET HIGH. ON SLOPES 8 FEET OR MORE HIGH. USE 0.075 GAL/SQ. YD. OR 363 GAL./ACRE. THESE MATERIALS MAY BE DIFFICULT TO APPLY UNIFORMLY AND WILL DISCOLOR SURFACES.
- (2) ORGANIC AND VEGETABLE BASED BINDERS NATURALLY OCCURRING, POWDER BASED, HYDROPHILIC MATERIALS WHEN MIXED WITH WATER FORMULATES A GEL AND WHEN APPLIED TO MULCH UNDER SATISFACTORY CURING CONDITIONS WILL FORM MEMBRANED NETWORKS OF INSOLUBLE POLYMERS. THE VEGETABLE GEL SHALL BE PHYSIOLOGICALLY HARMLESS AND NOT RESULT IN A PHYTOTOXIC EFFECT OR IMPEDE GROWTH OF TURFGRASS. USE AT RATES AND WEATHER CONDITIONS AS RECOMMENDED BY THE MANUFACTURER TO ANCHOR MULCH MATERIALS. MANY NEW PRODUCTS ARE AVAILABLE, SOME OF WHICH MAY NEED FURTHER EVALUATION FOR USE IN THIS STATE
- (3) SYNTHETIC BINDERS HIGH POLYMER SYNTHETIC EMULSION, MISCIBLE WITH WATER WHEN DILUTED AND FOLLOWING APPLICATION TO MULCH, DRYING AND CURING SHALL NO LONGER BE SOLUBLE OR DISPERSIBLE IN WATER. IT SHALL BE APPLIED AT RATES RECOMMENDED BY THE MANUFACTURER AND REMAIN TACKY UNTIL GERMINATION OF GRASS.
- WOOD-FIBER OR PAPER-FIBER MULCH. SHALL BE MADE FROM WOOD, PLANT FIBERS OR PAPER CONTAINING NO GROWTH OR GERMINATION INHIBITING MATERIALS. USED AT THE RATE OF 1,500 POUNDS PER ACRE (OR AS RECOMMENDED BY THE PRODUCT MANUFACTURER) AND MAY BE APPLIED BY A HYDROSEEDER. THIS MULCH SHALL NOT BE MIXED IN THE TANK WITH THE SEED. USE IS LIMITED TO FLATTER SLOPES AND DURING OPTIMUM SEEDING PERIODS IN SPRING AND FALL

C. PELLETIZED MULCH. COMPRESSED AND EXTRUDED PAPER AND/OR WOOD FIBER PRODUCT, WHICH MAY CONTAIN CO-POLYMERS, TACKIFIERS, FERTILIZERS AND COLORING AGENTS. THE DRY PELLETS, WHEN APPLIED TO A SEEDED AREA AND WATERED, FORM A MULCH MAT. PELLETIZED MULCH SHALL BE APPLIED IN ACCORDANCE WITH THE MANUFACTURERS RECOMMENDATIONS. MULCH MAY BE APPLIED BY HAND OR MECHANICAL SPREADER AT THE RATE OF 60-75 LBS/1,000 SQUARE FEET AND ACTIVATED WITH 0.2 TO 0.4 INCHES OF WATER THIS MATERIAL HAS BEEN FOUND TO BE BENEFICIAL FOR USE ON SMALL LAWN OR RENOVATION AREAS. SEEDED AREAS WHERE WEED-SEED FREE MULCH IS DESIRED OR O SITES WHERE STRAW MULCH AND TACKIFIER AGENT ARE NOT PRACTICAL OR DESIRABLE

APPLYING THE FULL 0.2 TO 0.4 INCHES OF WATER AFTER SPREADING PELLETIZE MULCH ON THE SEED BED IS EXTREMELY IMPORTANT FOR SUFFICIENT ACTIVATION AND EXPANSION OF THE MULCH TO PROVIDE SOIL COVERAGE.

STANDARD FOR PERMANENT VEGETATIVE COVER FOR SOIL STABILIZATION:

DEFINITION

OPTIMUM SEED

DEPTH 4*

(INCHES)

0.5

1.0

1.0

1.0

1.0

1.0

0.25

ESTABLISHMENT OF PERMANENT VEGETATIVE COVER ON EXPOSED SOILS WHERE PERENNIAL VEGETATION IS NEEDED FOR LONG TERM PROTECTION.

PURPOSE TO PERMANENTLY STABILIZE THE SOIL, ASSURING CONSERVATION OF SOIL AND WATER, AND TO ENHANCE THE ENVIRONMENT.

WATER QUALITY ENHANCEMENT

SLOWS THE OVERLAND MOVEMENT OF STORMWATER RUNOFF, INCREASES INFILTRATION AND RETAINS SOIL AND NUTRIENTS ON SITE, PROTECTING STREAMS OR OTHER STORMWATER CONVEYANCES.

WHERE APPLICABLE

ON EXPOSED SOILS THAT HAVE A POTENTIAL FOR CAUSING OFF-SITE ENVIRONMENTAL DAMAGE.

METHODS AND MATERIALS

1. SITE PREPARATION

- GRADE AS NEEDED AND FEASIBLE TO PERMIT THE USE OF CONVENTIONAL EQUIPMENT FOR SEEDBED PREPARATION, SEEDING, MULCH APPLICATION, AND MULCH ANCHORING. ALL GRADING SHOULD BE DONE IN ACCORDANCE WITH STANDARDS FOR LAND GRADING, P. 19-1.
- INSTALL NEEDED EROSION CONTROL PRACTICES OR FACILITIES SUCH AS DIVERSIONS, GRADE STABILIZATION STRUCTURES, CHANNEL STABILIZATION MEASURES, SEDIMENT BASINS, AND WATERWAYS. SEE STANDARDS 11 THROUGH 42.
- IMMEDIATELY PRIOR TO SEEDING, THE SURFACE SHOULD BE SCARIFIED 6" TO 12" WHERE THERE HAS BEEN SOIL COMPACTION. THIS PRACTICE IS PERMISSIBLE ONLY WHERE THERE IS NO DANGER TO UNDERGROUND UTILITIES (CABLES, IRRIGATION SYSTEMS, ETC.).

2. SEED BED PREPARATION

APPLY GROUND LIMESTONE AND FERTILIZER ACCORDING TO SOIL TEST RECOMMENDATIONS SUCH AS THOSE OFFERED BY RUTGERS CO-OPERATIVE EXTENSION. SOIL SAMPLE MAILERS ARE AVAILABLE FROM THE LOCAL RUTGERS CO-OPERATIVE EXTENSION OFFICES. FERTILIZER SHALL BE APPLIED AT THE RATE OF 500 PONDS PER ACRE OR 11 POUNDS PER 1,000 SQUARE FEET OF 10-20-10 OR EQUIVALENT WITH 50% WATER INSOLUABLE NITROGEN UNLESS A SOIL TEST INDICATES OTHERWISE. APPLY LIMESTONE IN ACCORDANCE WITH THE TABLE BELOW AND THE RESULTS OF SOIL TESTING. CALCIUM CARBONATE IS THE EQUIVALENT AND STANDARD FOR MEASURING THE ABILITY OF LIMING MATERIALS TO NEUTRALIZE SOIL ACIDITY AND SUPPLY CALCIUM AND MAGNESIUM TO GRASSES AND LEGUMES. TABLE BELOW IS A GENERAL OUIDELINE FOR LIMESTONE APPLICATION RATES

BELOW IS A GENERAL GOIDELINE FOR EIMESTONE AFFLICATION RATES.					
SOIL TEXTURE	TONS/ACRE	LBS./1,000 S.F.			
CLAY, CLAY LOAM, AND HIGH ORGANIC SOIL	3	135			
SANDY LOAM, LOAM, SILT LOAM	2	90			
LOAMY SAND, SAND	1	45			

PULVERIZED DOLOMITIC LIMESTONE IS PREFERRED FOR MOST SOILS SOUTH OF THE NEW BRUNSWICK-TRENTON LINE

- HIGH ACID PRODUCING SOIL.

A. MATERIALS	TYPE
	50% CaO Mg0
STARTER FERTILIZER	P K N 10 10 10
SEED MIXES	
LAWN/SOD MIX	1) TURFTYPE TALL FESO (3 DARK GREEN SEE
	2) KENTUCKY BLUEGRA
	3) TURFTYPE PERENNIA RYEGRASS


- ROCKS, STUMPS, ETC.

4. MULCHING

CODE REVIEW: B. WORK LIME AND FERTILIZER INTO THE SOIL AS NEARLY AS PRACTICAL TO A DEPTH OF 4 INCHES WITH A DISC. SPRINGTOOTH HARROW, OR OTHER SUITABLE EQUIPMENT. THE FINAL HARROWING OR DISCING OPERATION SHOULD BE ON THE GENERAL CONTOUR. CONTINUE TILLAGE UNTIL A REASONABLY UNIFORM SEEDBED IS PREPARED. C. IMMEDIATELY PRIOR TO SEEDING, THE SURFACE SHOULD BE SCARIFIED 6" TO 12" WHERE THERE HAS BEEN SOIL COMPACTION. THIS PRACTICE IS PERMISSIBLE ONLY WHERE THERE IS NO DANGER TO UNDERGROUND UTILITIES (CABLES, IRRIGATION SYSTEMS, ETC.) SOILS HAVING A PH OF 4 OR LESS OR CONTAINING IRON SULFIDE SHALL BE COVERED WITH A MINIMUM OF 12 INCHES OF SOIL HAVING A PH 5 OR MORE BEFORE INITIATING SEEDBED PREPARATION. SEE STANDARD FOR MANAGEMENT OF HIGH ACID PRODUCING SOILS. APPLICATION RATES PER SOIL TESTING 80% BY WEIGHT 215 LB./ACRE ED VARIETIES MIN 10% BY WEIGHT 43 LB./ACRE 10% BY WEIGHT 43 LB./ACRE CONVENTIONAL SEEDING - APPLY SEED UNIFORMLY BY HAND, CYCLONE (CENTRIFUGAL) SEEDER, DROP SEEDER, DRILL OR CULTIPACKER SEEDER, EXCEPT FOR DRILLED. HYDROSEEDED OR CULTIPACKED SEEDINGS, SEED SHALL BE INCORPORATED INTO THE SOIL, TO A DEPTH OF 1/4 TO 1/2 INCH, BY RAKING OR DRAGGING. DEPTH OF SEED CERTIFICATE: PLACEMENT MAY BE 1/4 INCH DEEPER ON COARSE TEXTURED SOIL. HYDROSEEDING IS A BROADCAST SEEDING METHOD USUALLY INVOLVING A TRUCK OR TRAILER MOUNTED TANK. WITH AN AGITATION SYSTEM AND HYDRAULIC PUMP FOR MIXING SEED. WATER AND FERTILIZER AND SPRAYING THE MIX ONTO THE PREPARED SEEDBED. MULCH SHALL NOT BE INCLUDED IN THE TANK WITH SEED. SHORT FIBERED MULCH MAY BE APPLIED WITH A HYDROSEEDER FOLLOWING SEEDING. HYDROSEEDING IS NOT A PREFERRED SEEDING METHOD BECAUSE SEED AND FERTILIZER ARE APPLIED TO THE SURFACE AND NOT INCORPORATED INTO THE SOIL. POOR SEED TO SOIL CONTACT OCCURS REDUCING SEED GERMINATION AND GROWTH. HYDROSEEDING MAY BE USED FOR AREAS TOO STEEP FOR CONVENTIONAL EQUIPMENT TO TRAVERSE OR TOO OBSTRUCTED WITH AFTER SEEDING, FIRMING THE SOIL WITH A CORRUGATED ROLLER WILL ASSURE GOOD SEED-TO-SOIL CONTACT, RESTORE CAPILLARITY, AND IMPROVE SEEDING EMERGENCE, THIS SPIEZLE ARCHITECTURAL GROUP INC. IS THE PREFERRED METHOD. WHEN PERFORMED ON THE CONTOUR. SHEET EROSION WILL 121 MARKET STREET BE MINIMIZED AND WATER CONSERVATION ON SITE WILL BE MAXIMIZED. CAMDEN, NJ 08102 PHONE: (866) 974 7666 SIGNATURE 21AI0150540 THOMAS S. PERRIN 21AI0167440 SCOTT E. DOWNIE STEVEN LEONE 21AI01170100 21AI01564200 STEVEN G. SIEGE 21AI01046700 ANGELO ALBERTO 21AI01784200 JOHN F. WRIGHT SPIEZLE ARCHITECTURAL GROUP, INC. 21AC00063000 JACQUELINE R BERENATO PROFESSIONAL ENGINEER NEW JERSEY LICENSE NO. GE 56282 Gacqueline Derenato 2/23/24 FOR BID 06/25/2024 ROJECT HADDONFIELD POLICE STATION TURF GRASS SHALL BE MOWED TO A HEIGHT OF NOT LESS THAT 3" WITH NO MORE THAN ONE THIRD $\binom{1}{3}$ BLADE REMOVAL IN A SINGLE CUTTING. NATIVE GRASS AREAS AND WEED CONTROL: CUT THE GRASS WITH A "FLAIL" BLADE **1 WALNUT STREET** MOWER IN THE FIRST YEAR TO HEIGHT OF 6" EARLY IN THE SEASON AND 12" LATER IN HADDONFIELD, NEW JERSEY 08033 THE YEAR IF THE GRASSES GROW MORE THAN 6" HEIGHT. DO NOT ALLOW THE WEEDS TO GROW MORE THAN 12" HEIGHT BEFORE MOWING IN ORDER TO PREVENT SMOTHERING SMALL SEEDLINGS. IN THE SECOND YEAR MOW IN EARLY JUNE TO A HEIGHT OF 12". IF WEEDS CONTINUE TO BE A PROBLEM IN SECOND GROWING SEASON FOR MOW AGAIN JUST ABOVE THE TOP OF THE GRASSES. AFTER THE SECOND YEAR MOW IN MID SPRING TO THE GROUND LEVEL AND RAKE CUTTINGS CAMDEN COUNTY IMPROVEMENT AUTHORITY 520 MARKET STREET, 6TH FLOOR CAMDEN, NEW JERSEY 08102 DURATION 1 DAY WORK SHALL BE LIMITED TO AREAS SPECIFICALLY SHOWN ON PLANS. FOR CODE REVIEW: 02/23/24 1 DAY REVISIONS: 1 DAY REVISION NAME DATE APPROVED PLANS 3 WEEKS WILL NEED TO BE IMPLEMENTED AS SITE CONDITIONS WARRANT. 2 DAYS 3 DAYS DISTURBED AGAIN WITH TOPSOIL, PERMANENT SEEDING AND MULCH OR EROSION CONTROL BLANKETS PER PLANS. 2 WEEKS FOR BID: 05/30/24 APPROXIMATELY 4 MONTHS ONGOING THOUGHOUT 4 DAYS RAWING TITLE: 3 DAYS 3 DAYS SOIL EROSION AND 3 DAYS VEGETATIVE STABILIZATION OF ALL EXPOSED AREAS IN ACCORDANCE WITH SEDIMENT CONTROL NOTES SPECIFICATIONS HEREON. 1 DAY DISTRICT INSPECTOR, REMOVE TEMPORARY SOIL EROSION AND SEDIMENT CONTROL COMMISSION NUMBER: 23M014 RAWING NUMBER:

CS8501

3. PERMANENT SEEDING FOLLOW SAME STANDARDS AS LISTED UNDER TEMPORARY VEGETATIVE COVER FOR STABILIZATION. 5. IRRIGATION (WHERE FEASIBLE) IF SOIL MOISTURE IS DEFICIENT, AND MULCH IS NOT USED, SUPPLY NEW SEEDINGS WITH ADEQUATE WATER (A MINIMUM OF $\frac{1}{2}$ INCH TWICE A DAY UNTIL VEGETATION IS WELL ESTABLISHED) THIS IS ESPECIALLY TRUE WHEN SEEDINGS ARE MADE IN ABNORMALLY DRY OR HOT WEATHER OR ON DROUGHTY SITES. 6.TOPDRESSING SINCE SLOW RELEASE NITROGEN FERTILIZER (WATER INSOLUBLE IS PRESCRIBED IN SECTION II.A. SEEDBED PREPARATION IN THIS STANDARD. NO FOLLOW-UP OF TOPDRESSING IS MANDATORY, AN EXCEPTION MAY BE MADE WHERE GRASS NITROGEN DEFICIENCY EXISTS TO THE EXTENT THAT TURF FAILURE MAY DEVELOP. IN THAT INSTANCE, TOPDRESS WITH 10-10-0R EQUIVALENT AT 400 POUNDS PER 1,000 SQ. FT. 7. ESTABLISHING PERMANENT VEGETATIVE STABILIZATION THE QUALITY OF PERMANENT VEGETATION RESTS WITH THE CONTRACTOR. THE TIMING OF SEEDING, PREPARING THE SEEDBED, APPLYING NUTRIENTS, MULCH AND OTHER MANAGEMENT ARE ESSENTIAL. THE SEED APPLICATION RATE IS REQUIRED WHEN A REPORT OF COMPLIANCE IS REQUESTED PRIOR TO ACTUAL ESTABLISHMENT OF PERMANENT VEGETATION, UP TO 50% REDUCTION IN APPLICATION RATES MAY BE USED WHEN PERMANENT VEGETATION IS ESTABLISHED PRIOR TO REQUESTING A REPORT OF COMPLIANCE FROM THE DISTRICT. THIS RATE APPLIES TO ALL METHODS OF SEEDING. ESTABLISHING PERMANENT VEGETATION MEANS 80% VEGETATIVE COVER (OF THE SEEDED SPECIES) AND MOWED ONCE. 8. MAINTENANCE CONTRACTOR SHALL ALL BE RESPONSIBLE FOR MAINTAINING TURF GRASS AND NATIVE GRASS AREAS UNTIL 80% COVERAGE OF SEEDED SPECIES IS ESTABLISHED. THIS WILL INCLUDE RESEEDING, FERTILIZING, MULCHING AND APPLICATION OF POST-EMERGENT HERBICIDES AS REQUIRED FOR COMPLIANCE. SEQUENCE OF CONSTRUCTION: 1. MOBILIZE AND CLEARLY DEFINE LIMITS OF CLEARING AND DEMOLITION WITH FLAGGING. 2. INSTALL SILT FENCE DOWNSTREAM OF ALL DEMOLITION AND DISTURBANCE AREAS. 3. INSTALL ALL TEMPORARY SOIL EROSION AND SEDIMENT CONTROL BMP'S AS DETAILED ON 4. BEGIN SITE DEMOLITION AS SHOWN ON SHEET CS0501. THE USE OF TEMPORARY BMP'S 5. COMPLETE ALL SITE CLEARING AND STOCKPILE AND STABILIZATION OF TOPSOIL 6. PERFORM ROUGH GRADING. IMMEDIATELY STABILIZE GRADED AREAS THAT WILL NOT BE 7. CONSTRUCT CONCRETE CURBING, PADS AND SIDEWALKS. 8. BUILDING INTERIOR RETROFIT AND BUILDING ADDITION CONSTRUCTION. 9. INSTALL SITE LIGHTING CONCRETE BASES, CONDUIT, POLES AND FIXTURES. 10. INSTALL STONE BASE FOR ASPHALT PAVEMENT AND ASPHALT BASE COURSE. 11. INSTALL ASPHALT SURFACE COURSE AND PAVEMENT MARKINGS. 12. TOPSOIL, SOD, SEED AND INSTALL PLANT MATERIAL AND MULCH. PROVIDE PERMANENT 13. AFTER VEGETATIVE COVER HAS BEEN ESTABLISHED TO THE SATISFACTION OF THE

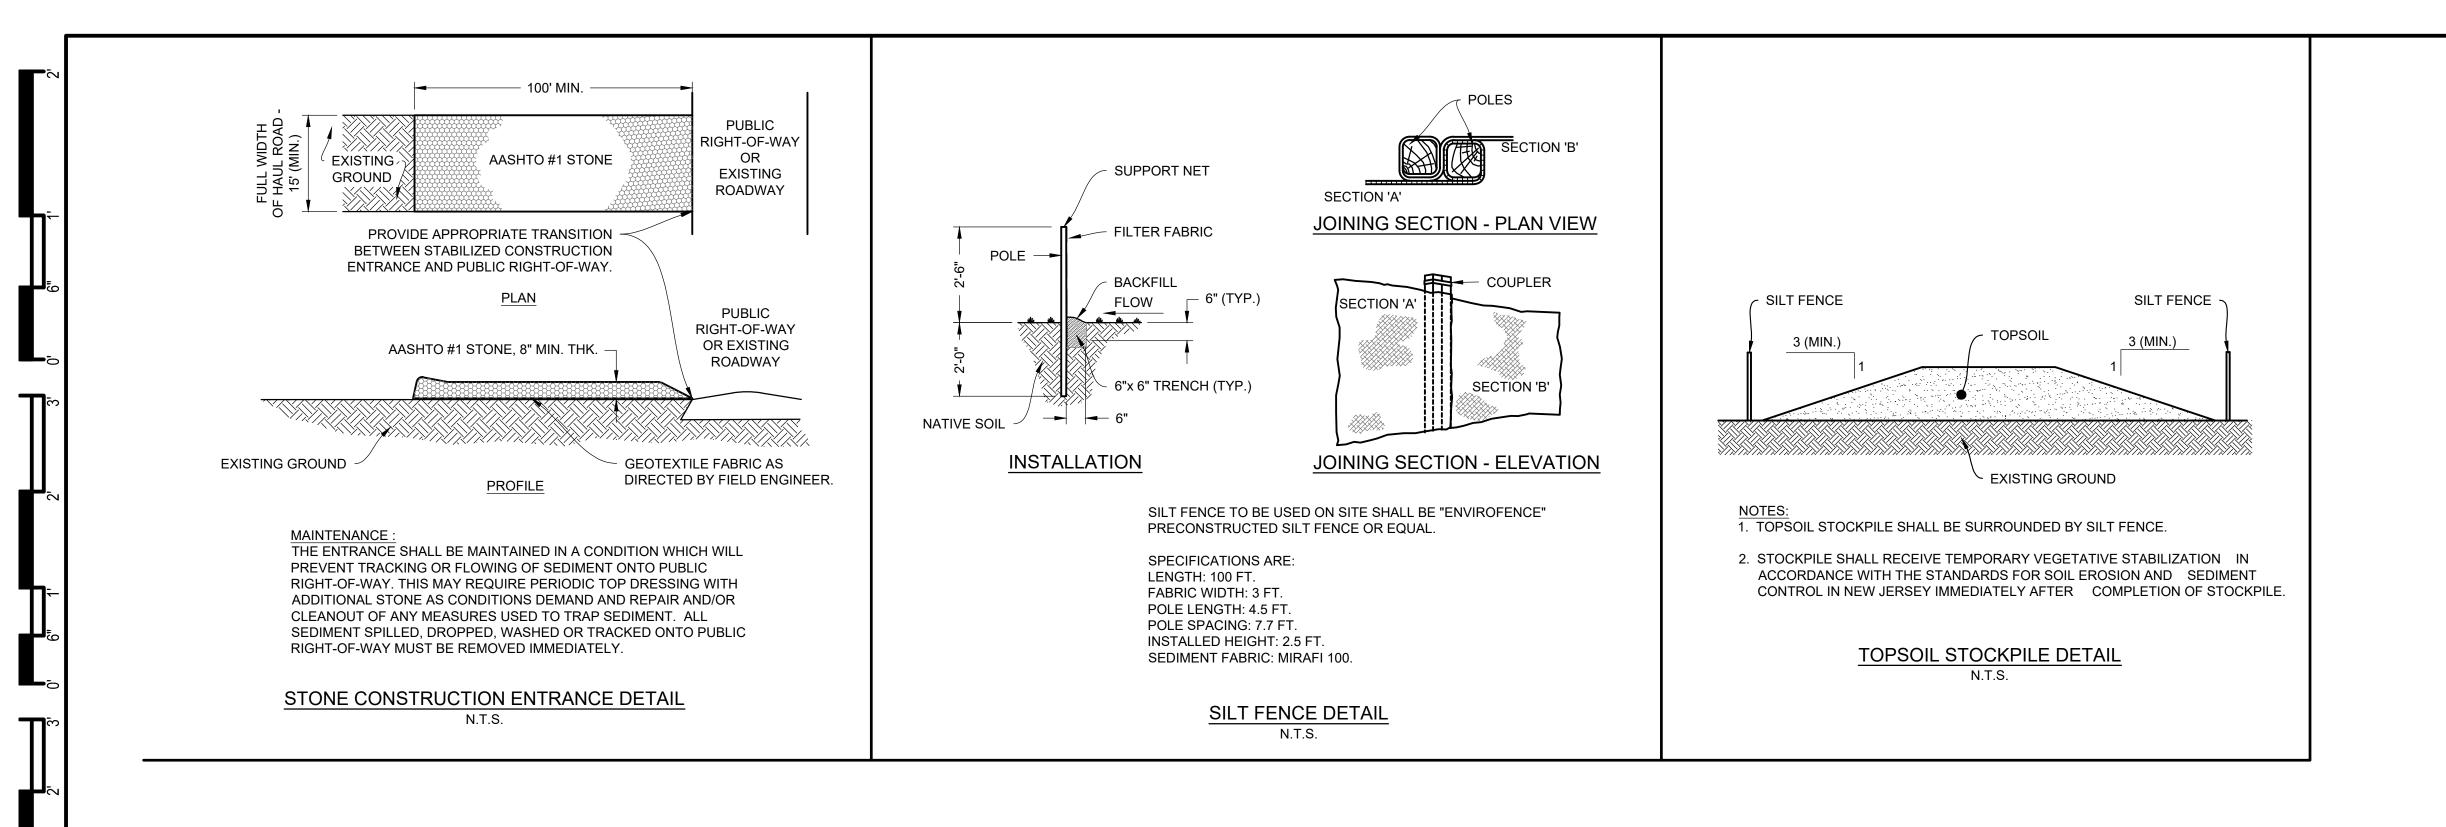

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SDIETIE ARCHITECTURAL CROUD INC CODVRIGHT @ 2022

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CAMDEN, NJ 08102 PHONE: (866) 974 7666
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STEVEN LEONE 21AI01170100 STEVEN G. SIEGEL 21AI01564200 ANGELO ALBERTO 21AI01046700
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SEAL:
JACQUELINE R BERENATO
NEW JERSEY LICENSE NO. GE 56282
Jacqueline Berenato 2/23/24
Guyndu'ne D'Oldhune a/ 100/ 11
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FOR CODE REVIEW: 02/23/24
REVISIONS:
FOR BID: 05/30/24
DRAWING TITLE:
SOIL EROSION AND
SEDIMENT CONTROL
DETAILS
COMMISSION NUMBER:
23M014
DRAWING NUMBER:
CS8502