# HADDONFIELD POLICE STATION 1 WALNUT STREET, HADDONFIELD, NJ 08033

# **CAMDEN COUNTY IMPROVEMENT AUTHORITY** 520 MARKET STREET, 6TH FLOOR, CAMDEN, NEW JERSEY 08102



AREA MAP

## STRUCTURAL CONSULTANT HARRISON HAMNETT

MEP CONSULTANT PMH ASSOCIATES

## CIVIL CONSULTANT PENNONI

## FOR THE



VICINITY MAP



SPIEZLE ARCHITECTURAL GROUP, INC 1395 YARDVILLE HAMILTON SQUARE ROAD SUITE 2A HAMILTON, NJ 08691 Phone: 609.695.7400 Fax: 609.394.2274 www.spiezle.com

**BID DATE:** 


06/25/2024

## LAW ENFORCEMENT TOM MILLS


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HADDONFIELD POLICE STATION 23M014 DRAWING NUMBER:


**CS.1** 

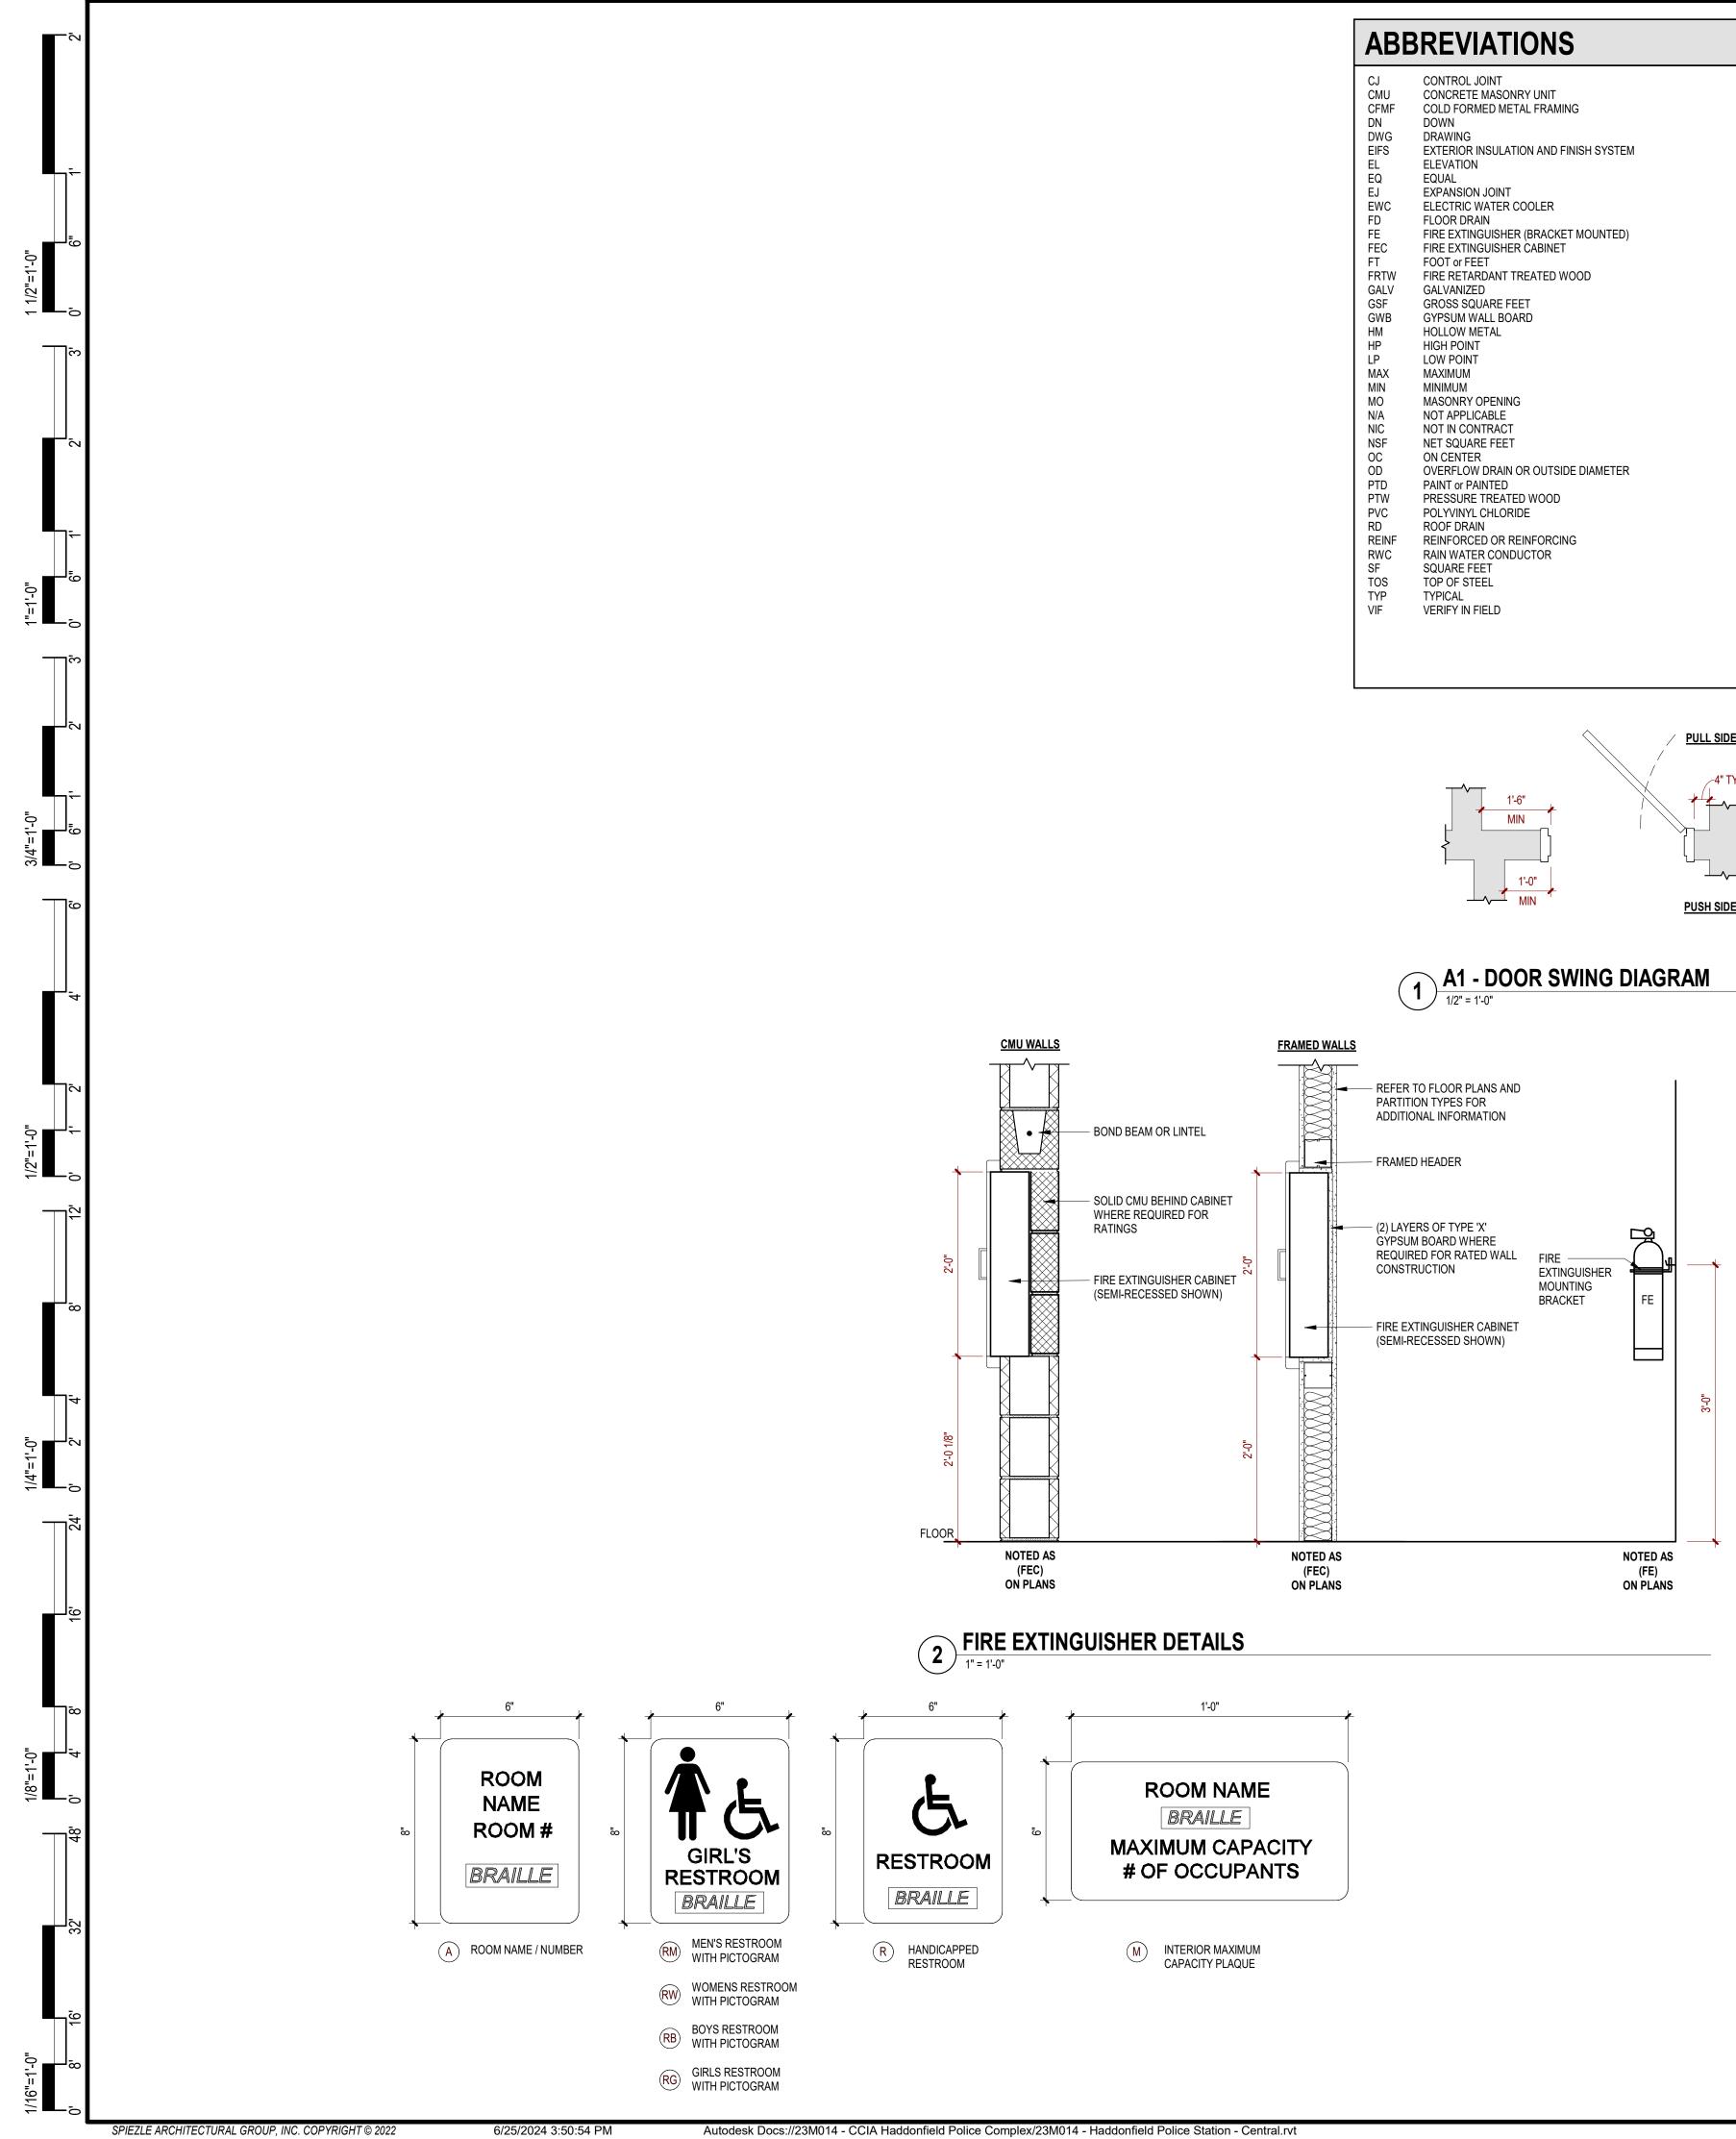


CJ CMU	CONTROL JOINT CONCRETE MASONRY UNIT
CMU	CONCRETE MASONRY UNIT
DN	DOWN
DWG	DRAWING
EIFS	EXTERIOR INSULATION AND FINISH SYSTEM
EL	ELEVATION
EQ	EQUAL
EJ	EXPANSION JOINT
EWC	ELECTRIC WATER COOLER
FD FE	
FEC	FIRE EXTINGUISHER (BRACKET MOUNTED) FIRE EXTINGUISHER CABINET
FT	FOOT or FEET
FRTW	
GALV	GALVANIZED
GSF	GROSS SQUARE FEET
GWB	GYPSUM WALL BOARD
HM	HOLLOW METAL
HP	HIGH POINT
LP MAX	LOW POINT MAXIMUM
MIN	MINIMUM
MO	MASONRY OPENING
N/A	NOT APPLICABLE
NIC	NOT IN CONTRACT
NSF	NET SQUARE FEET
00	ON CENTER
OD	OVERFLOW DRAIN OR OUTSIDE DIAMETER
PTD PTW	PAINT or PAINTED PRESSURE TREATED WOOD
PVC	POLYVINYL CHLORIDE
RD	ROOF DRAIN
REINF	REINFORCED OR REINFORCING
RWC	RAIN WATER CONDUCTOR
SF	SQUARE FEET
TOS	TOP OF STEEL
TYP	
VIF	VERIFY IN FIELD

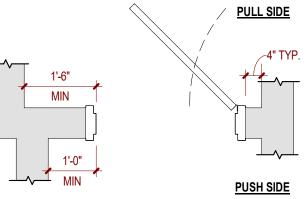


							CODE REVIEW:
LIST O	F DRAWINGS			LIST O	F DRAWINGS		
DWG. NO.	TITLE		CURRENT REVISION	DWG. NO.	TITLE	CURRENT REVISION	
	COVER			A9.4 A10.1	FURNITURE PLANS DOOR AND FRAME SCHEDULES		
CS.2 CIVIL	NOTES, ABBREVIATIONS AND LIST OF D	DRAWINGS		A10.2 STRUCTURAL	STOREFRONT AND WINDOW DETAILS		
	COVER SHEET INFORMATION SHEET			S1.1 S1.2	FOUNDATION PLAN GENERATOR PAD PLAN & DETAILS		
CS0501	DEMOLITION PLAN - BASE BID DEMOLITION PLAN - ADD ALT AND BASE	E BID		S2.1 S3.1	SECOND FLOOR FRAMING PLAN ROOF FRAMING PLAN		
	SITE PLAN - BASE BID SITE PLAN - ADD ALT AND BASE BID			S4.1 S4.2	SECTIONS SECTIONS		
	GRADING AND UTILITY PLAN - BASE BID GRADING AND UTILITY PLAN - ADD ALT			S5.1	TYPICAL DETAILS, GENERAL NOTES & SCHEDULES		
CS2201	LANDSCAPE PLAN LIGHTING PLAN			M0.1	ATION, AND AIR CONDITIONING MECHANICAL NOTES & SCHEDULES		
CS6002	CONSTRUCTION DETAILS COUNTY CONSTRUCTION DETAILS			M0.2 M0.3	MECHANICAL SCHEDULES MECHANICAL SCHEDULES		
CS8001	CONSTRUCTION DETAILS			M0.4 M0.5	MECHANICAL SCHEDULES MECHANICAL SCHEDULES		
	SOIL EROSION AND SEDIMENT CONTRO SOIL EROSION AND SEDIMENT CONTRO			M0.6 M1.0	MECHANICAL DETAILS FIRST FLOOR MECHANICAL PLAN SECOND FLOOD MECHANICAL PLAN		
LANDSCAPE ARC	 HITECTURE  LANDSCAPE AND LIGHTING COURTYAR			M1.1 M1.2 M1.3	SECOND FLOOR MECHANICAL PLAN MECHANICAL ROOF DEMOLITION PLAN MECHANICAL ROOF PLAN		CERTIFICATE:
L1.2 L2.1	IRRIGATION LAYOUT PLAN (ALTERNATE COURTYARD NOTES AND DETAILS			M2.0 M2.1	FIRST FLOOR MECHANICAL PIPING PLAN SECOND FLOOR MECHANICAL PIPING PLAN		
L2.2	COURTYARD DETAILS (ALTERNATE) COURTYARD LIGHTING DETAILS			PLUMBING			•
CODE PLANS				P0.1 P0.2	PLUMBING NOTES, LEGEND & SCHEDULES PLUMBING DETAILS		
	CODE PLANS CODE PLANS			P1.0 P1.1	FIRST FLOOR SANITARY PLAN SECOND FLOOR SANITARY PLAN		
DEMOLITION				P1.2 P2.0	ROOF PLUMBING PLAN FIRST FLOOR DOMESTIC & GAS PLUMBING PLAN		
D1.1	DEMOLITION PLANS DEMOLITION PLANS			P2.1 P3.0	PLUMBING FLOOR PLANS SECOND FLOOR COMESTIC WATER AND GAS PLAN PLUMBING ISOMETRIC & RISER DIAGRAMS		SPIEZLE ARCHITECTURAL GROUP INC. 121 MARKET STREET
ARCHITECTURAL				ELECTRICAL			CAMDEN, NJ 08102 PHONE: (866) 974 7666
A1.1	PARTITION TYPES AND DETAILS FIRST FLOOR PLAN			E0.1 E0.2	ELECTRICAL NOTES & SCHEDULES ELECTRICAL PANEL SCHEDULES		SIGNATURE:
A2.0	SECOND FLOOR PLAN TOILET ROOM PLANS AND ELEVATIONS			E0.3 E0.4	ELECTRICAL SITE PLAN COURTYARD LIGHTING PLAN ALTERNATE BID		THOMAS S. PERRINO         21AI01505400           SCOTT E. DOWNIE         21AI01674400           STEVEN LEONE         21AI01170100
	TOILET ROOM PLANS AND ELEVATIONS STAIR PLANS AND DETAILS	3		E1.0 E1.1	FIRST FLOOR POWER PLAN SECOND FLOOR POWER PLAN		STEVEN G. SIEGEL         21AI01564200           ANGELO ALBERTO         21AI01046700           JOHN F. WRIGHT         21AI01784200           SPIEZLE ARCHITECTURAL GROUP, INC.         21AC00063000
A2.3 A2.4	STAIR DETAILS ELEVATOR PLANS AND DETAILS			E1.2 E2.0	ROOF POWER PLAN FIRST FLOOR LIGHTING PLAN		SEAL:
A3.0	ENLARGED PLANS ROOF DEMOLITION PLANS			E2.1 E3.0	SECOND FLOOR LIGHTING PLAN FIRE ALARM NOTES		ULAL.
A3.2	ROOF PLANS AND DETAILS ROOF DETAILS ROOF DETAILS			E3.1 E3.2 E4.0	FIRST FLOOR FIRE ALARM PLAN SECOND FLOOR FIRE ALARM PLANS SPECIAL SYSTEMS FIRST FLOOR PLAN		
A4.1	REFLECTED CEILING PLANS AND DETAI REFLECTED CEILING PLANS	ILS		E4.0	SPECIAL SYSTEMS FIRST FLOOR FLAN SPECIAL SYSTEMS SECOND FLOOR PLAN		
A5.1	EXTERIOR ELEVATIONS			FIRE SUPPRESSI FP1.0	ON FIRE PROTECTION FIRST FLOOR PLANS		
	EXTERIOR ELEVATIONS AND BUILDING WALL SECTIONS	SECTIONS		FP1.1	FIRE PROTECTION SECOND FLOOR PLANS		
A6.2 A8.1	WALL SECTION DETAILS CASEWORK AND EQUIPMENT PLANS AN	ND DETAILS					BID SET - 06/25/2024
A8.2 A9.1	CASEWORK AND EQUIPMENT PLANS AN FINISH PLANS AND INTERIOR ELEVATION	DNS					
	FINISH PLANS AND INTERIOR ELEVATIC FURNITURE PLANS	JNS					PROJECT:
DRAW	ING SYMBOLS			MATE	RIAL SYMBOLS		HADDONFIELD POLICE
					$\sim$		STATION
SIM/OPP T/ DETAIL N		DETAIL IDENTIFICATION					1 WALNUT STREET, HADDONFIELD, NJ
DRAWING N SIM/OPP T/	$\bigcirc$				BRICK		08033 FOR
OPEN HE		BUILDING SECTION			CONCRETE		CAMDEN COUNTY
DRAWING N	10 (A1.1)				CONCRETE MASONRY UNIT (CMU)		IMPROVEMENT
SIM/OPP T/ CLOSED HE/		WALL SECTION					AUTHORITY
SECTION N DRAWING N		IDENTIFICATION					520 MARKET STREET, 6TH FLOOR, CAMDEN, NEW JERSEY 08102
EXTERIOR	INTERIOR				FIRE SAFING		FOR CODE REVIEW: 02/23/24
1 SIM	— DETAIL NO. — XX/A101	ELEVATION MARKS			GYPSUM WALL AND/OR CEILING BOARD		REVISIONS:
	- DRAWING NO				MORTAR NET		REVISION NAME DATE
	OOM NAME <b>ROOM NAME</b>				MORTAR / GROUT		
GROSS SQUARE NET SQUARE	E FOOTAGE - 150 NSF	ROOM TAG					
0	CCUPANTS	COLUMN NUMBER			PLYWOOD		
	10	REVISION NUMBER			POROUS FILL or SUB-SLAB AGGREGATE		FOR BID: 06/25/2024
	(101)	DOOR NUMBER			RIGID INSULATION		DRAWING TITLE:
	(1t)	WINDOW TYPE					NOTES, ABBREVIATIONS
	8A.1	PARTITION TYPE			SPRAY FOAM INSULATION		AND LIST OF DRAWINGS
	CW-XX	CURTAIN WALL or STOREFRONT TAG			STEEL		
		DATUM or ELEVATION MARK			STONE		
	Ę	CENTERLINE					23M014
	< <u>22A</u> > 1/A1.1	TOILET ACCESSORY TAG VIEW REFERENCE			CONTINUOUS WOOD BLOCKING		
					WOOD SHIM OR BLOCKING		DO NOT SCALE THE DRAWINGS DRAWING NUMBER:
							CS.2

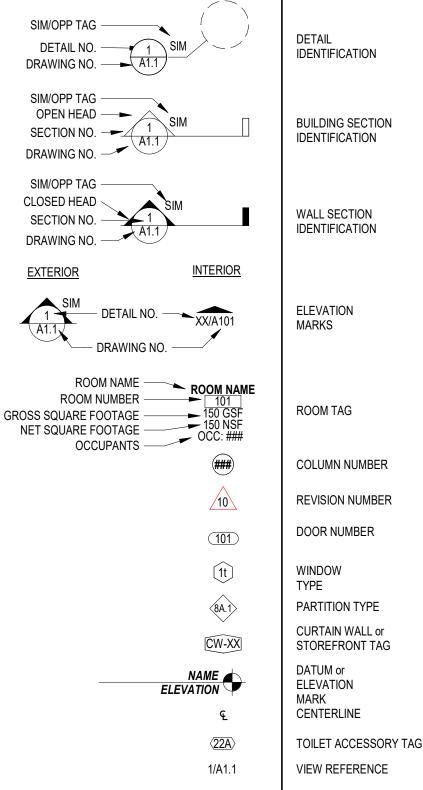

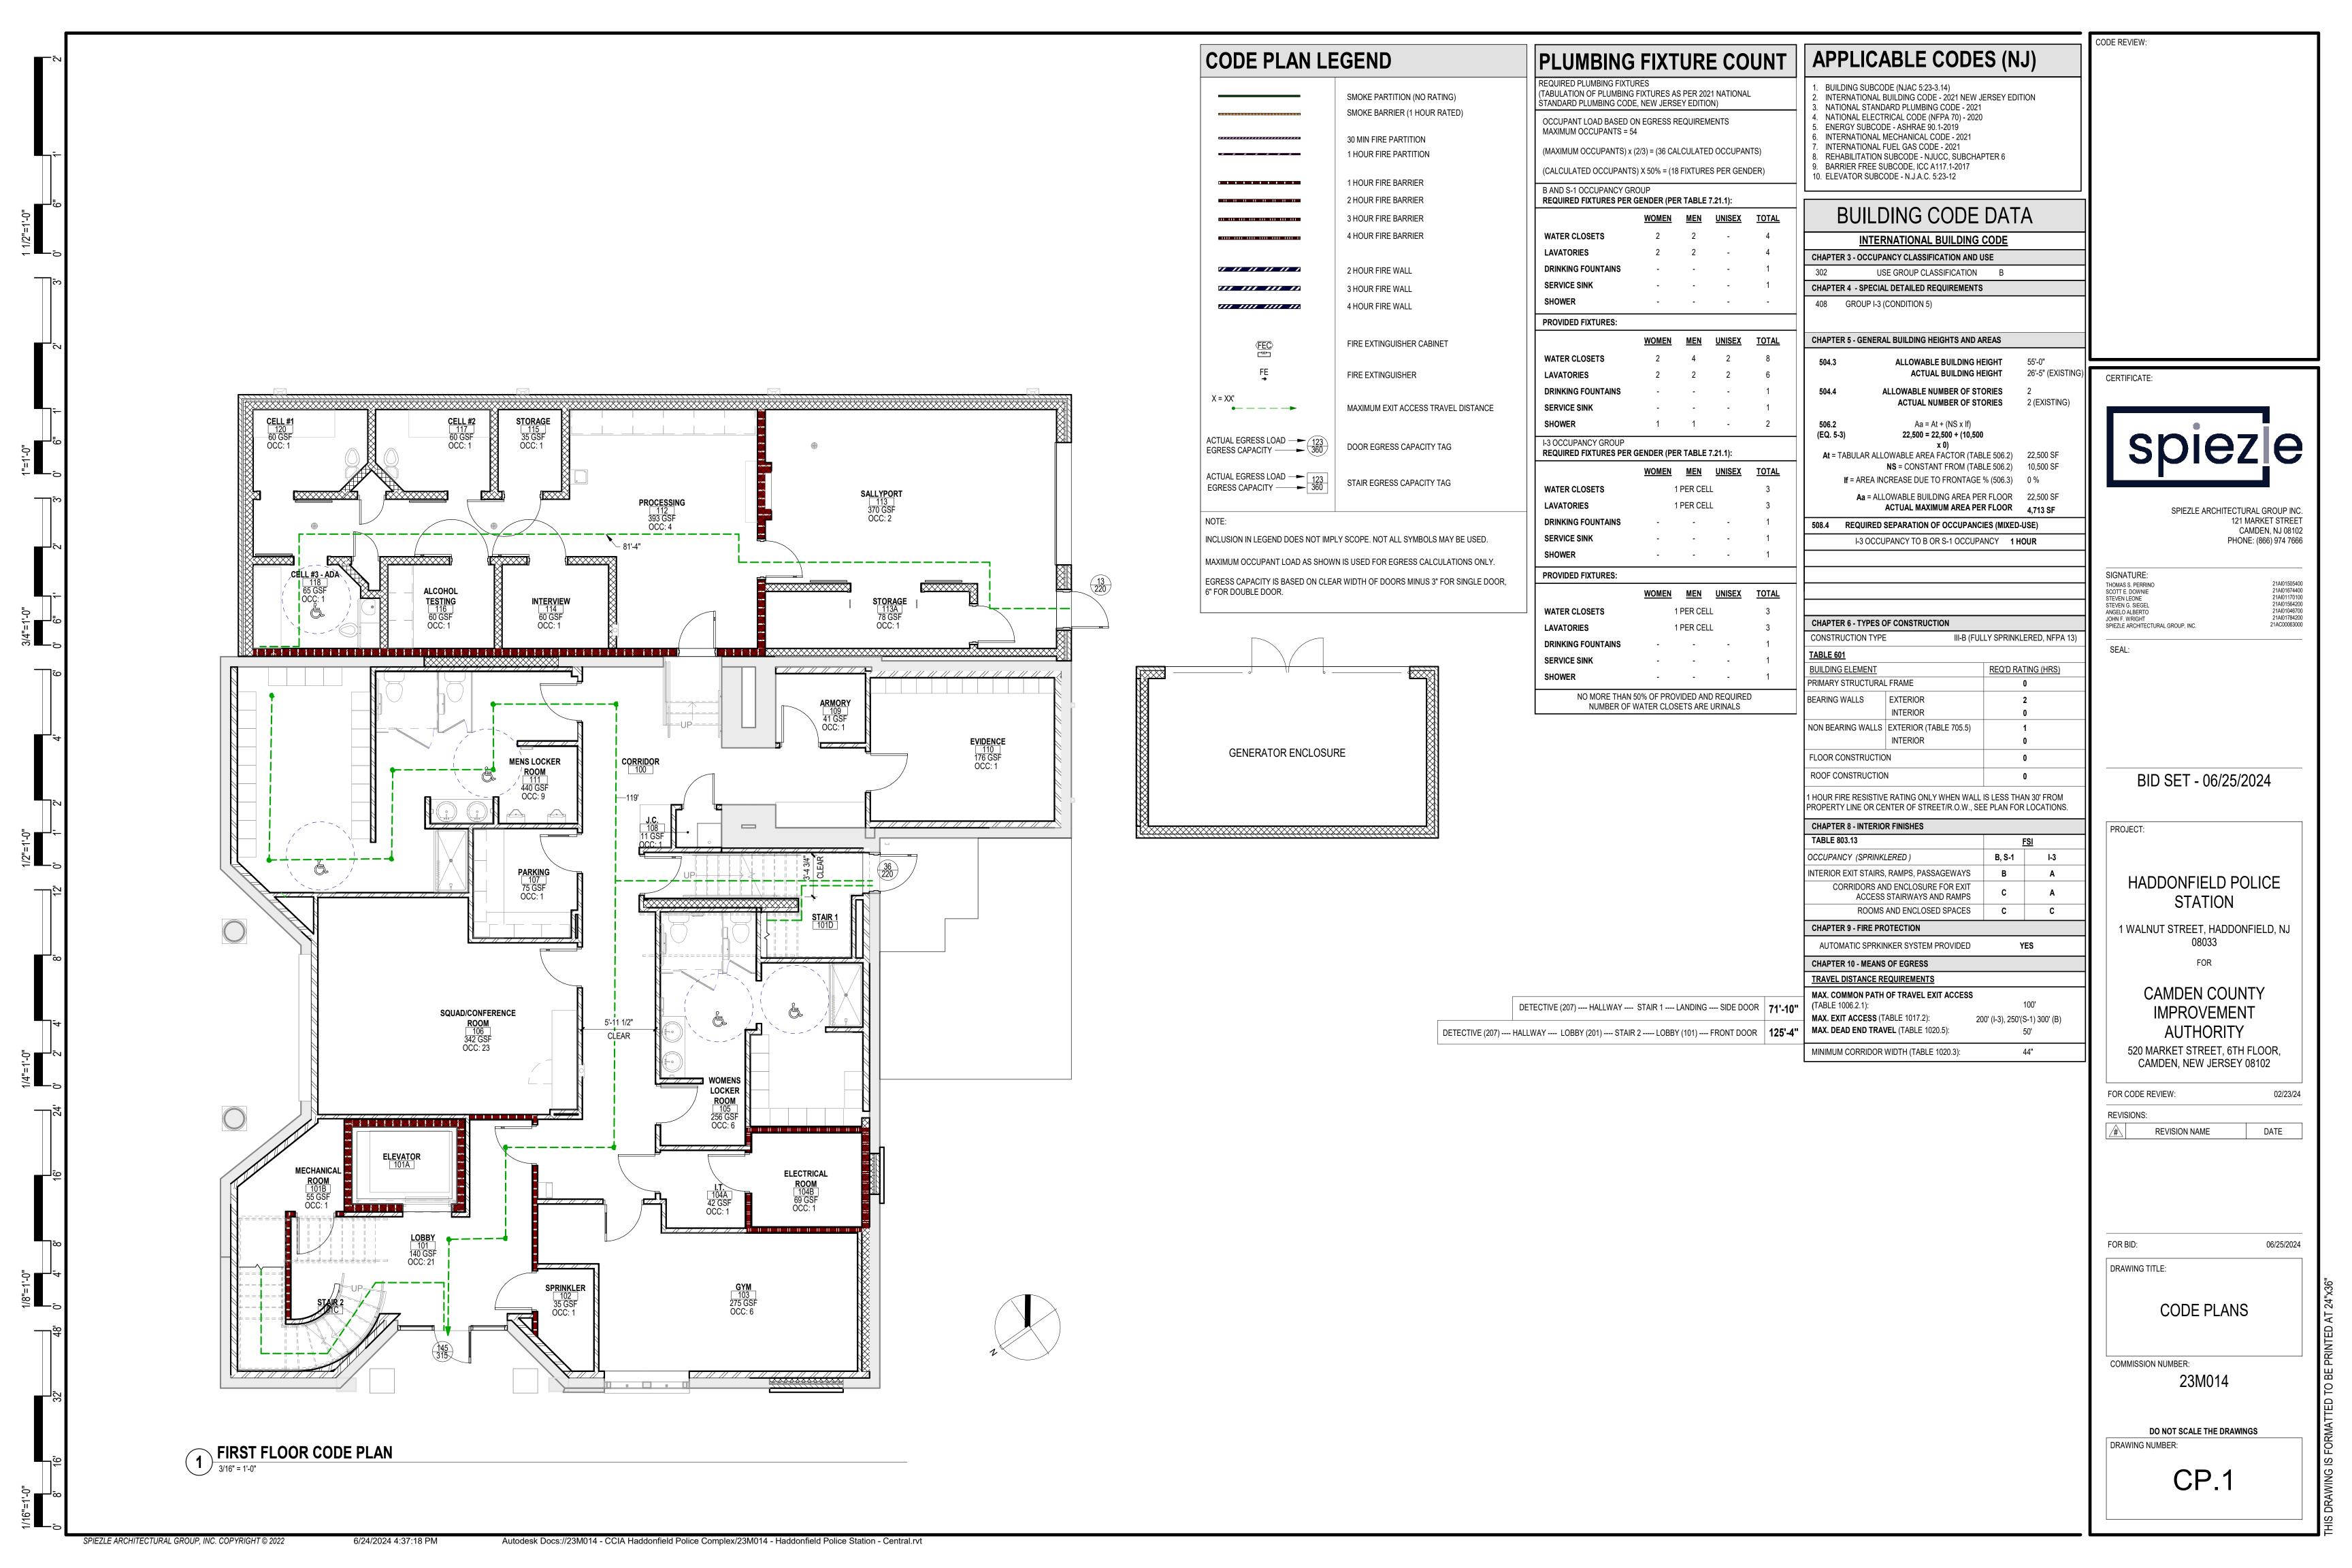




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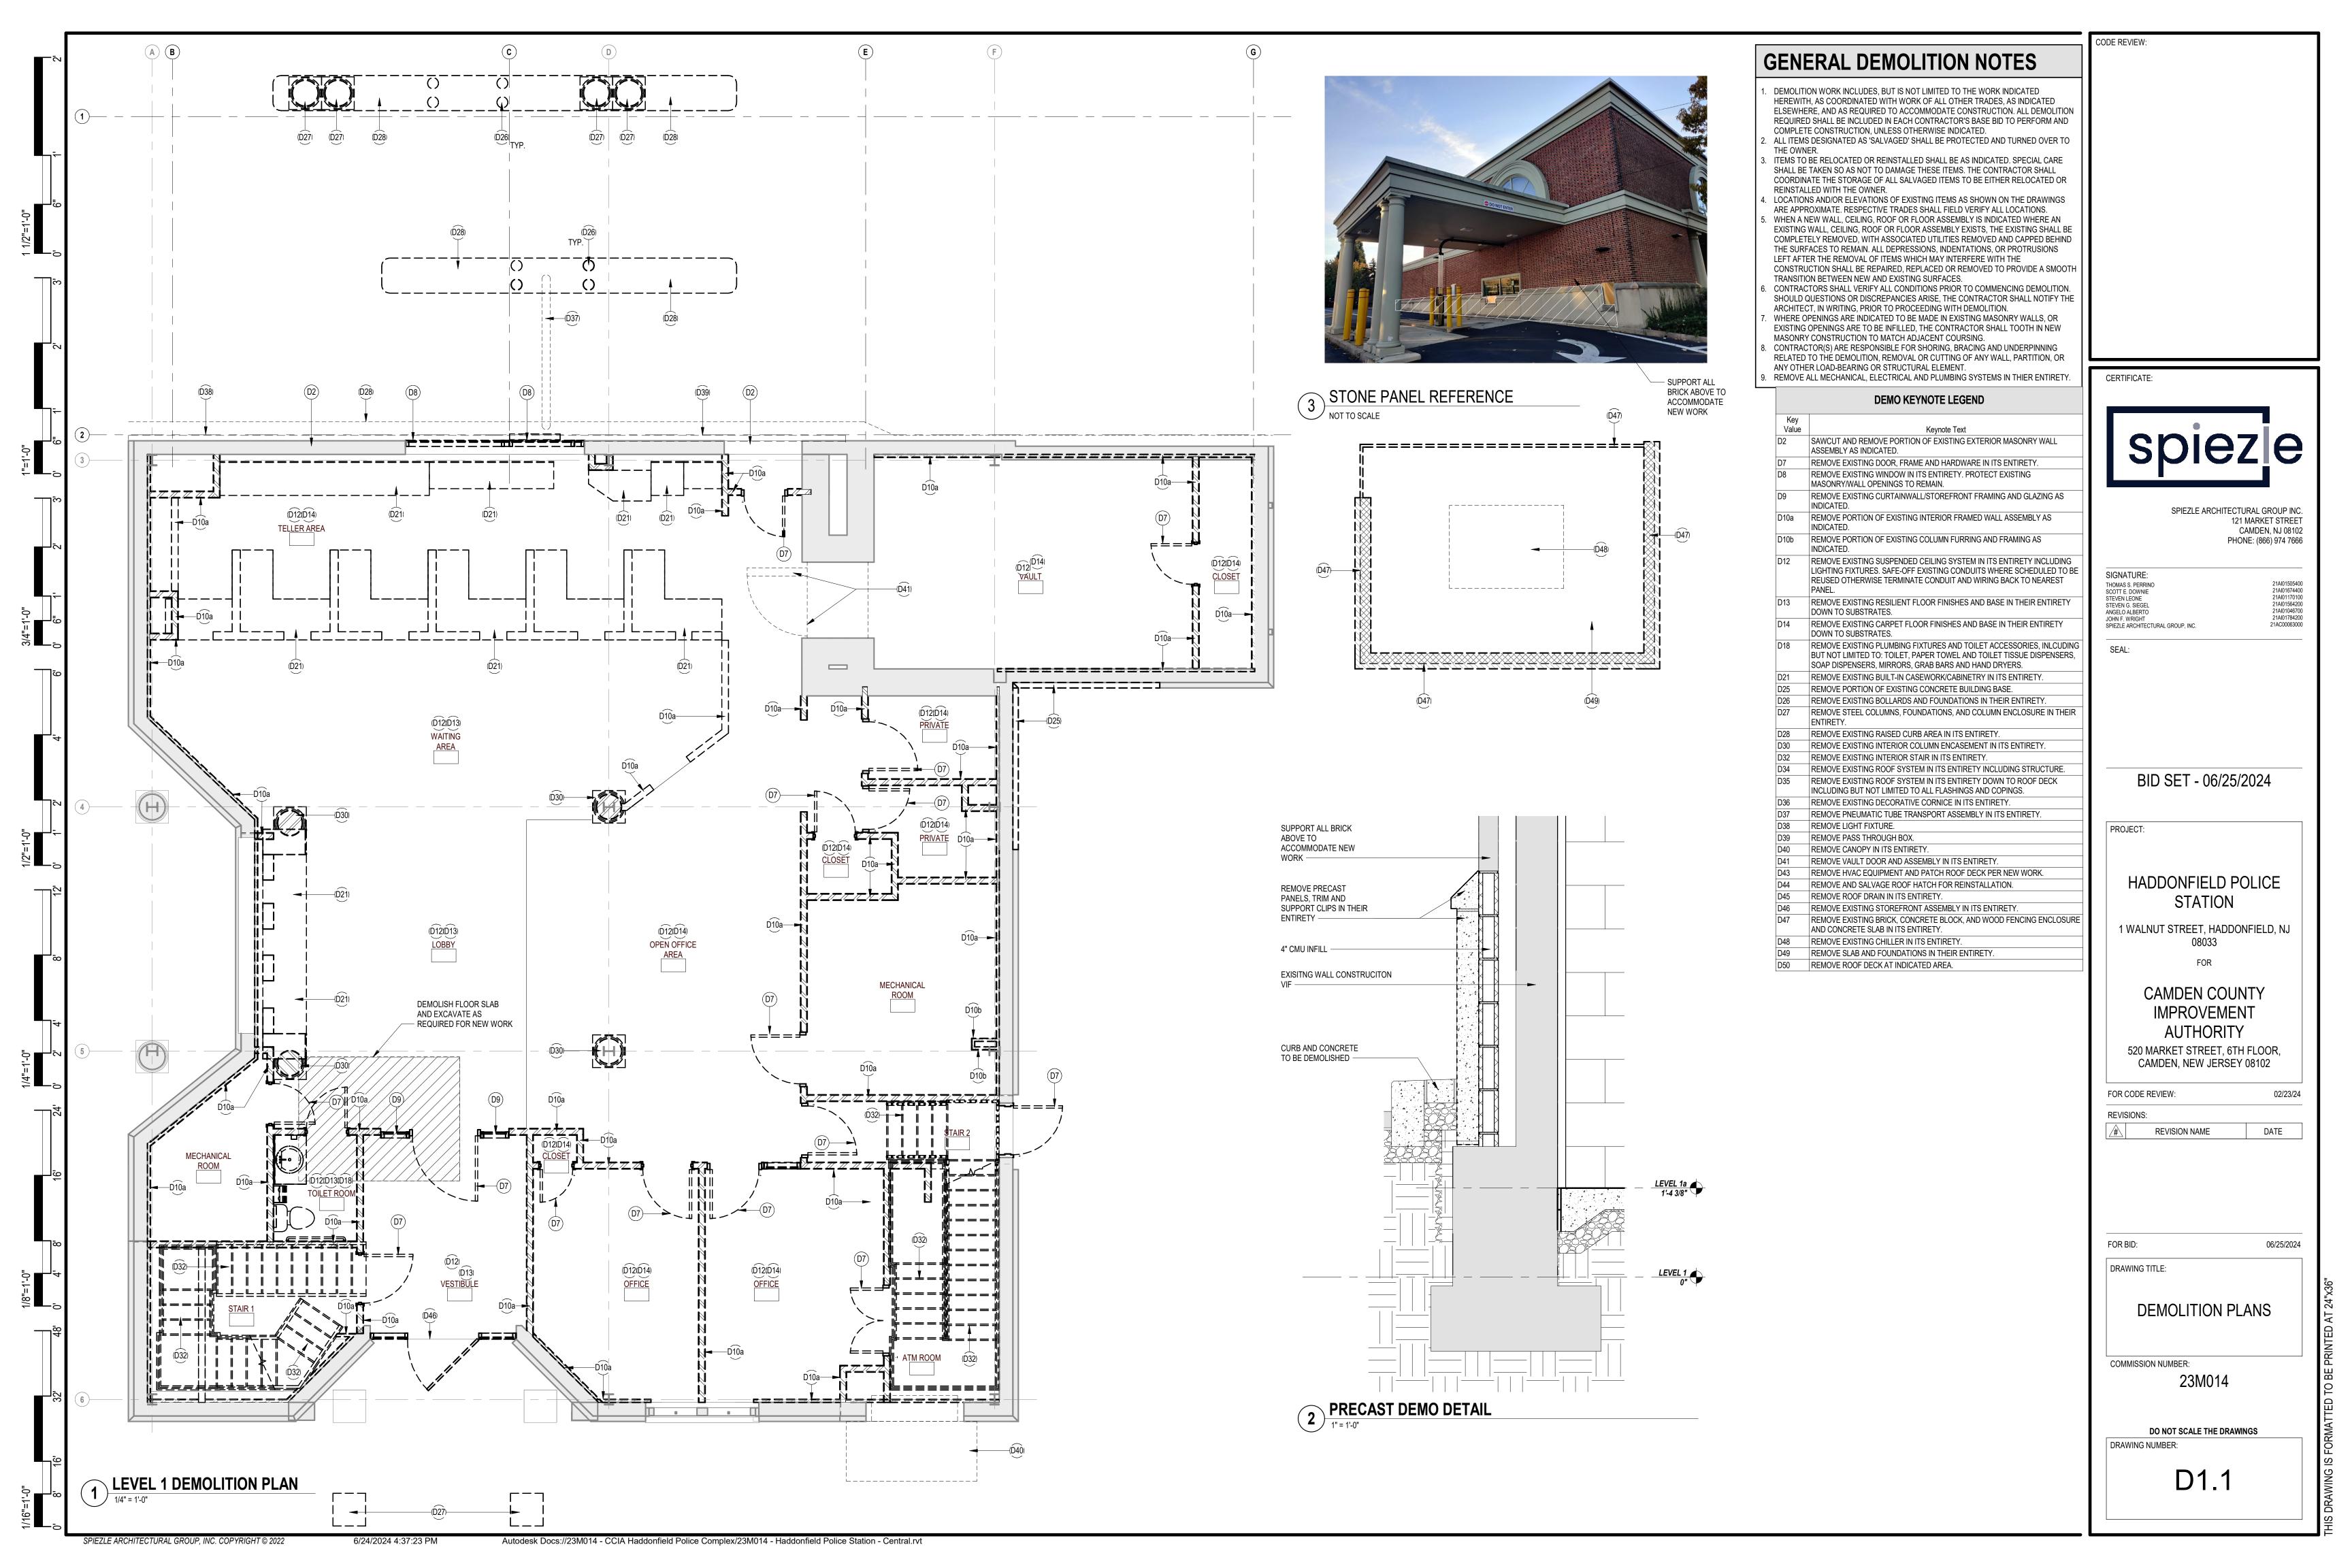


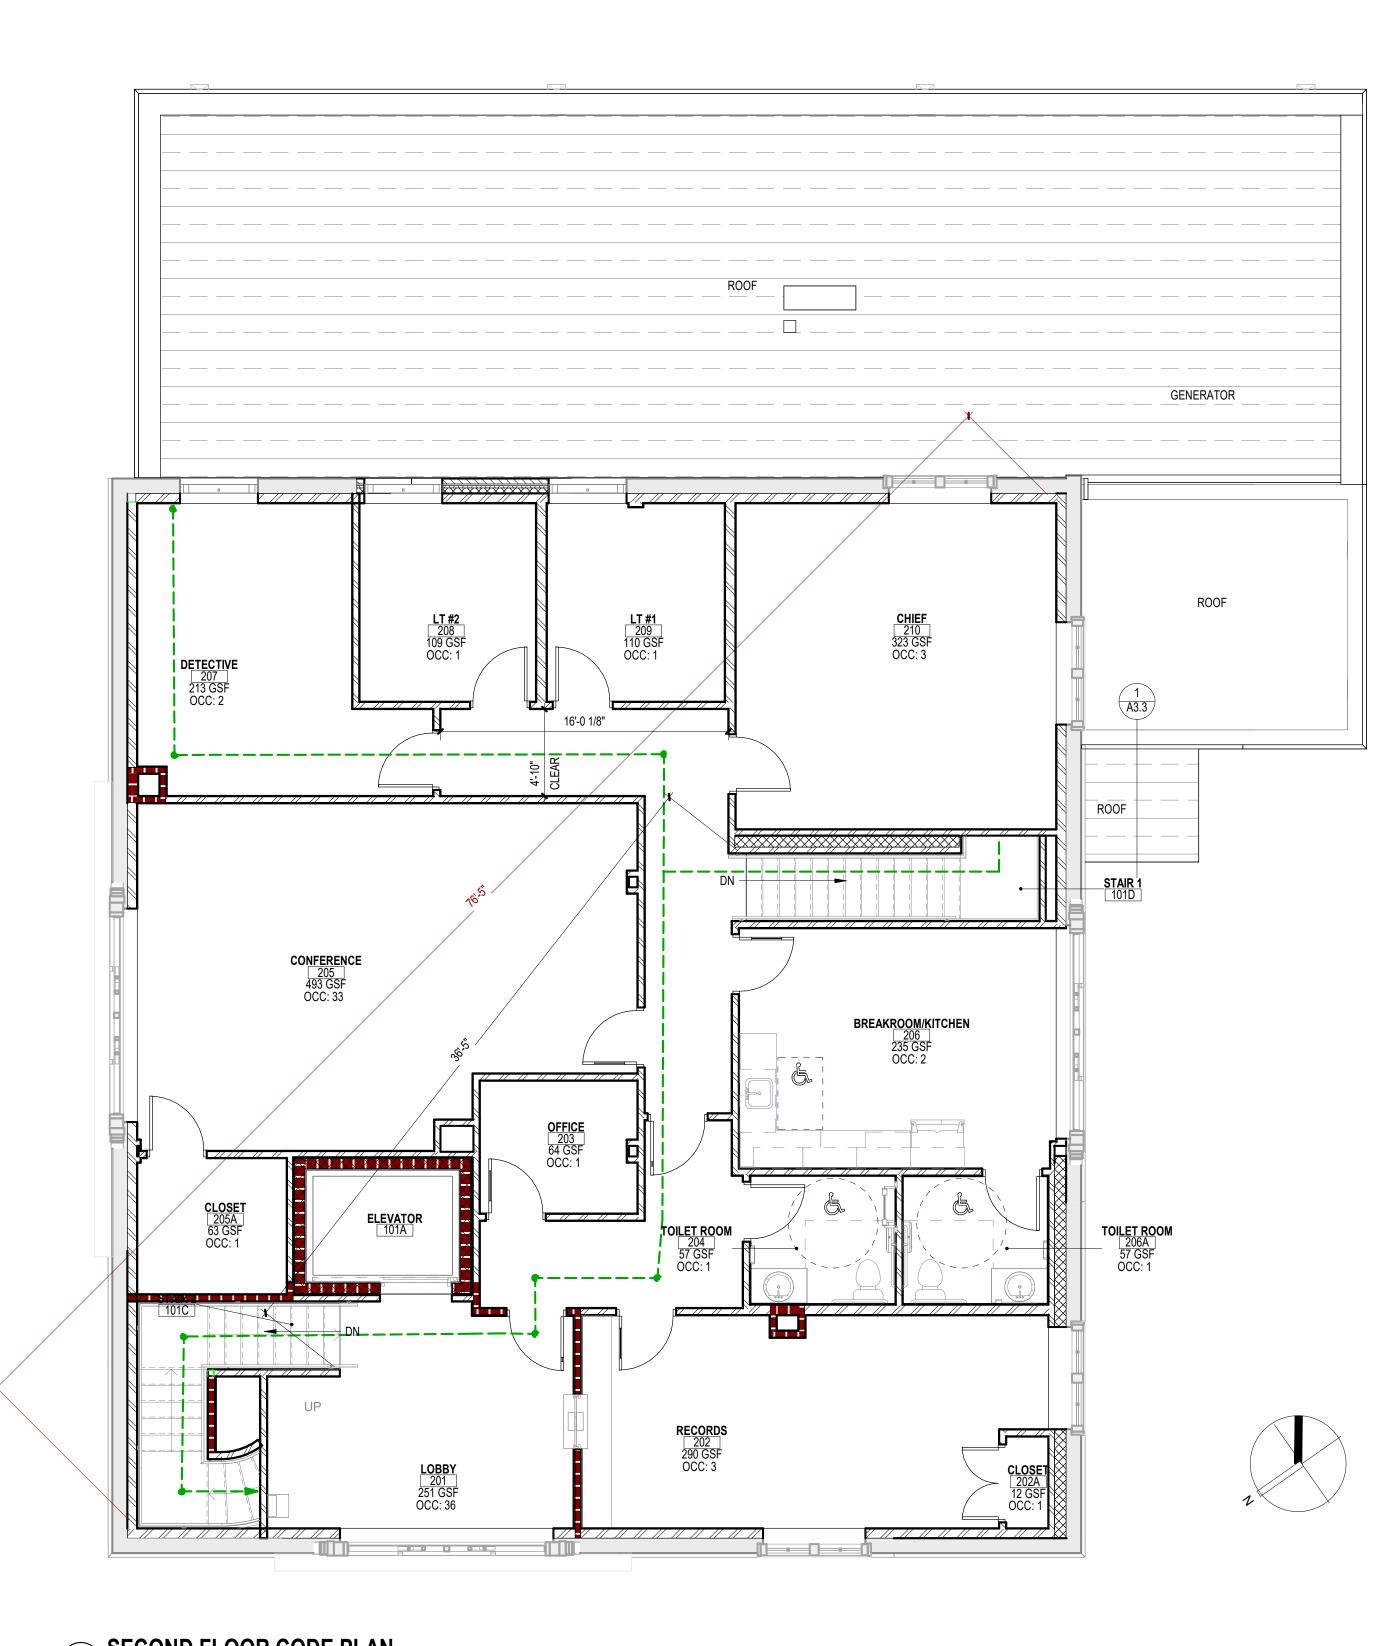
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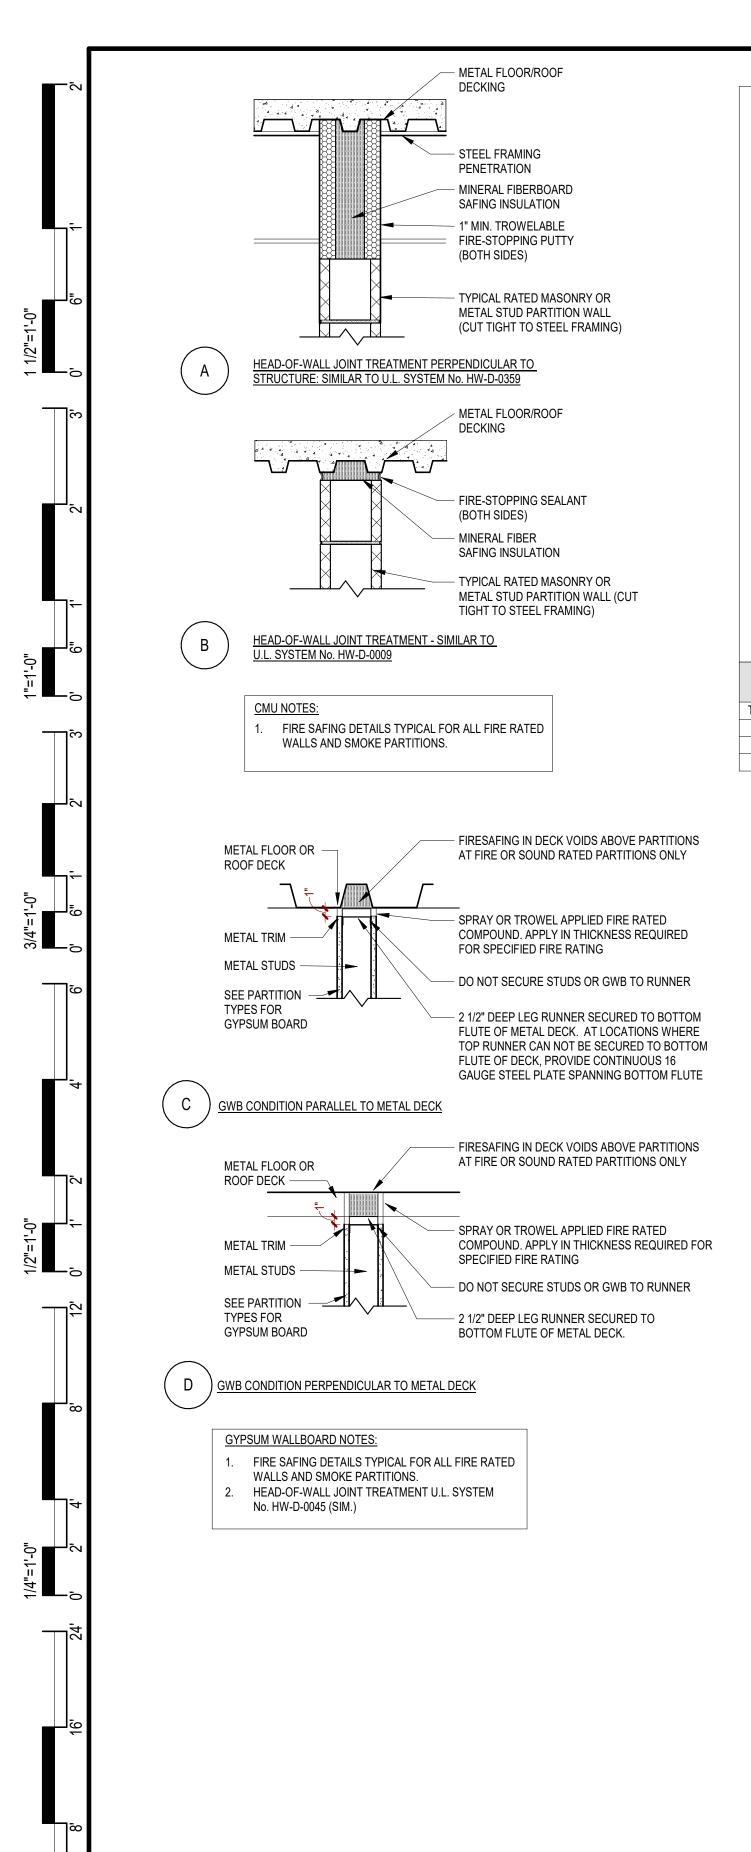
CODE REVIEW:	
CERTIFICATE:	
<b>Spiez</b>	
SPIEZLE ARCHITECTURAL GROUP INC.	
121 MARKET STREET CAMDEN, NJ 08102 PHONE: (866) 974 7666	
SIGNATURE:           THOMAS S. PERRINO         21AI01505400           SCOTT E. DOWNIE         21AI01674400           STEVENU FONE         21AI01170100	
STEVEN LEONE         214/01170100           STEVEN G. SIEGEL         214/01564200           ANGELO ALBERTO         21A/01046700           JOHN F. WRIGHT         21A/01784200           SPIEZIE ABCHITECTURAL GROUP, INC.         21A/00083000	
SPIEZLE ARCHITECTURAL GROUP, INC. 21AC00063000	
BID SET - 06/25/2024	
PROJECT:	
HADDONFIELD POLICE	
STATION	
1 WALNUT STREET, HADDONFIELD, NJ 08033	
FOR	
CAMDEN COUNTY	
IMPROVEMENT AUTHORITY	
520 MARKET STREET, 6TH FLOOR,	
CAMDEN, NEW JERSEY 08102	
FOR CODE REVIEW: 02/23/24 REVISIONS:	
REVISIONS.	
FOR BID: 06/25/2024	
DRAWING TITLE:	=
	THIS DRAWING IS FORMATTED TO BE PRINTED AT 24"x36"
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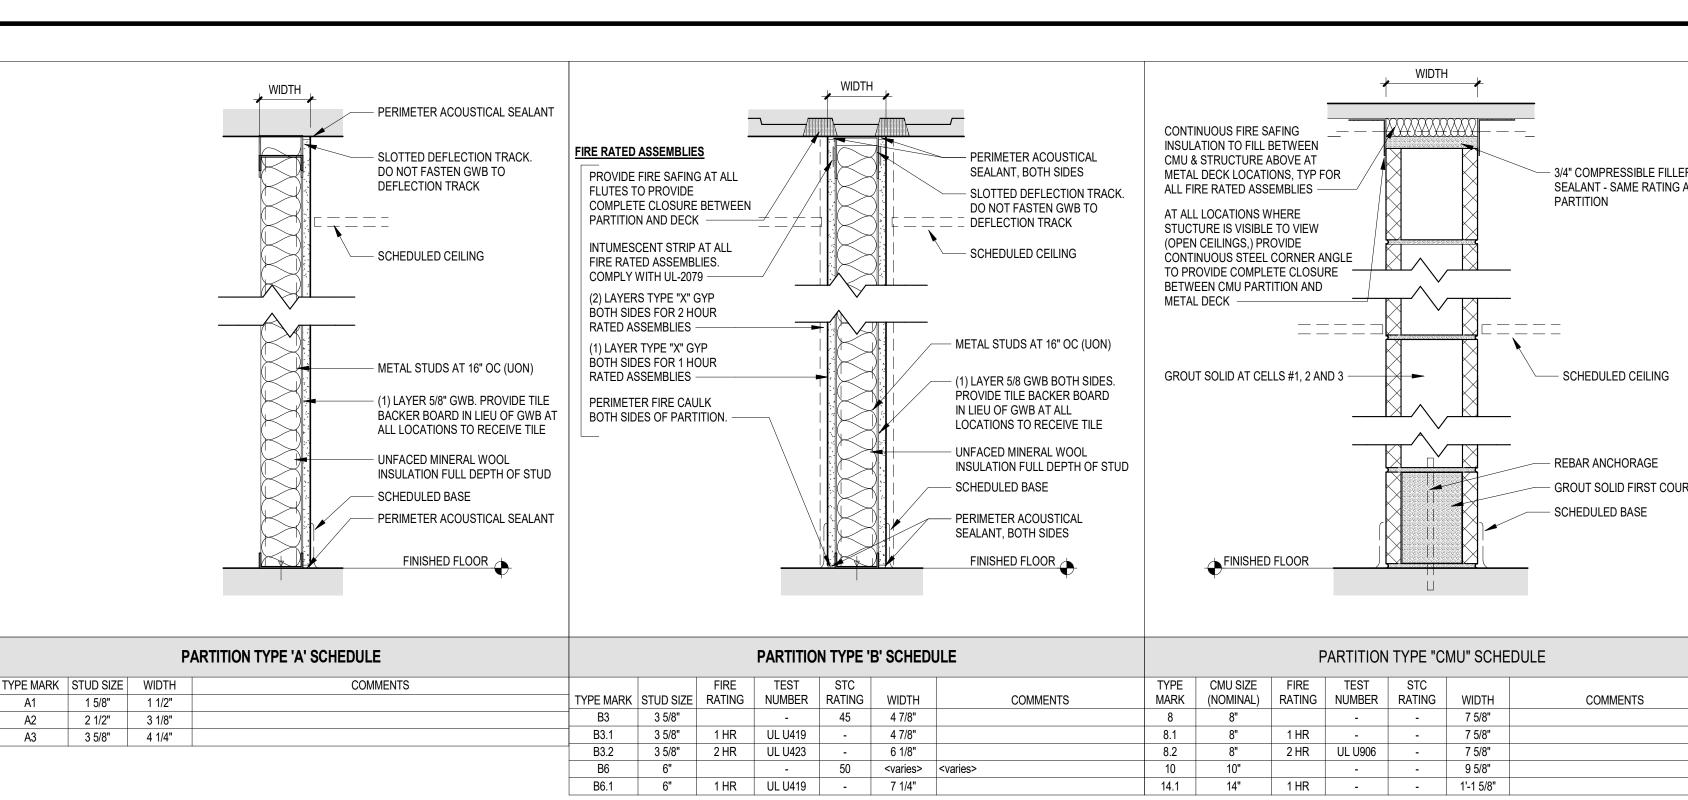
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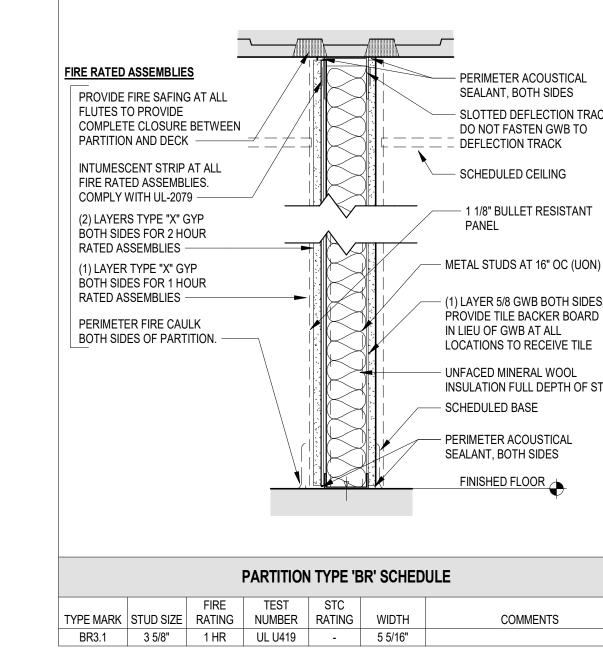


C	GEN	ERAL DEMOLITION NOTES	CODE REVIEW:
	HEREWIT	ION WORK INCLUDES, BUT IS NOT LIMITED TO THE WORK INDICATED TH, AS COORDINATED WITH WORK OF ALL OTHER TRADES, AS INDICATED	
	REQUIRE	ERE, AND AS REQUIRED TO ACCOMMODATE CONSTRUCTION. ALL DEMOLITION D SHALL BE INCLUDED IN EACH CONTRACTOR'S BASE BID TO PERFORM AND TE CONSTRUCTION, UNLESS OTHERWISE INDICATED.	
2.		S DESIGNATED AS 'SALVAGED' SHALL BE PROTECTED AND TURNED OVER TO	
	SHALL BE	BE RELOCATED OR REINSTALLED SHALL BE AS INDICATED. SPECIAL CARE TAKEN SO AS NOT TO DAMAGE THESE ITEMS. THE CONTRACTOR SHALL	
	REINSTAI	JATE THE STORAGE OF ALL SALVAGED ITEMS TO BE EITHER RELOCATED OR LLED WITH THE OWNER. NS AND/OR ELEVATIONS OF EXISTING ITEMS AS SHOWN ON THE DRAWINGS	
	ARE APPI	ROXIMATE. RESPECTIVE TRADES SHALL FIELD VERIFY ALL LOCATIONS. NEW WALL, CEILING, ROOF OR FLOOR ASSEMBLY IS INDICATED WHERE AN	
	EXISTING COMPLET	WALL, CEILING, ROOF OR FLOOR ASSEMBLY EXISTS, THE EXISTING SHALL BE TELY REMOVED, WITH ASSOCIATED UTILITIES REMOVED AND CAPPED BEHIND	
	LEFT AFT	FACES TO REMAIN. ALL DEPRESSIONS, INDENTATIONS, OR PROTRUSIONS TER THE REMOVAL OF ITEMS WHICH MAY INTERFERE WITH THE JCTION SHALL BE REPAIRED, REPLACED OR REMOVED TO PROVIDE A SMOOTH	
	TRANSITI	ION BETWEEN NEW AND EXISTING SURFACES. CTORS SHALL VERIFY ALL CONDITIONS PRIOR TO COMMENCING DEMOLITION.	
	ARCHITE	QUESTIONS OR DISCREPANCIES ARISE, THE CONTRACTOR SHALL NOTIFY THE CT, IN WRITING, PRIOR TO PROCEEDING WITH DEMOLITION.	
	EXISTING	OPENINGS ARE INDICATED TO BE MADE IN EXISTING MASONRY WALLS, OR GOPENINGS ARE TO BE INFILLED, THE CONTRACTOR SHALL TOOTH IN NEW Y CONSTRUCTION TO MATCH ADJACENT COURSING.	
8.	CONTRAC RELATED	CTOR(S) ARE RESPONSIBLE FOR SHORING, BRACING AND UNDERPINNING TO THE DEMOLITION, REMOVAL OR CUTTING OF ANY WALL, PARTITION, OR	
		ER LOAD-BEARING OR STRUCTURAL ELEMENT. ALL MECHANICAL, ELECTRICAL AND PLUMBING SYSTEMS IN THIER ENTIRETY.	CERTIFICATE:
		DEMO KEYNOTE LEGEND	
	Key Value	Keynote Text	
	D2	SAWCUT AND REMOVE PORTION OF EXISTING EXTERIOR MASONRY WALL ASSEMBLY AS INDICATED.	
	D7 D8	REMOVE EXISTING DOOR, FRAME AND HARDWARE IN ITS ENTIRETY. REMOVE EXISTING WINDOW IN ITS ENTIRETY. PROTECT EXISTING MASONRYAMALL OPENINGS TO REMAIN	
	D9	MASONRY/WALL OPENINGS TO REMAIN. REMOVE EXISTING CURTAINWALL/STOREFRONT FRAMING AND GLAZING AS INDICATED.	SPIEZLE ARCHITECTURAL GROUP II 121 MARKET STRE
	D10a	INDICATED. REMOVE PORTION OF EXISTING INTERIOR FRAMED WALL ASSEMBLY AS INDICATED.	CAMDEN, NJ 08 PHONE: (866) 974 70
	D10b	REMOVE PORTION OF EXISTING COLUMN FURRING AND FRAMING AS INDICATED.	
	D12	REMOVE EXISTING SUSPENDED CEILING SYSTEM IN ITS ENTIRETY INCLUDING LIGHTING FIXTURES. SAFE-OFF EXISTING CONDUITS WHERE SCHEDULED TO BE	SIGNATURE: THOMAS S. PERRINO 21AI0150 SCOTT E. DOWNIE 21AI0167 31AI0147
		REUSED OTHERWISE TERMINATE CONDUIT AND WIRING BACK TO NEAREST PANEL.	STEVEN LEONE         21AI017           STEVEN G. SIEGEL         21AI0156           ANGELO ALBERTO         21AI014           JOHN F. WRIGHT         21AI0178
	D13	REMOVE EXISTING RESILIENT FLOOR FINISHES AND BASE IN THEIR ENTIRETY DOWN TO SUBSTRATES.	JOHN F. WRIGHT 2 TAIO 178 SPIEZLE ARCHITECTURAL GROUP, INC. 21AC0006
	D14	REMOVE EXISTING CARPET FLOOR FINISHES AND BASE IN THEIR ENTIRETY DOWN TO SUBSTRATES.	SEAL:
	D18	REMOVE EXISTING PLUMBING FIXTURES AND TOILET ACCESSORIES, INLCUDING BUT NOT LIMITED TO: TOILET, PAPER TOWEL AND TOILET TISSUE DISPENSERS, SOAP DISPENSERS, MIRRORS, GRAB BARS AND HAND DRYERS.	
	D21 D25	REMOVE PORTION OF EXISTING CONCRETE BUILDING BASE.	
	D25 D26 D27	REMOVE PORTION OF EXISTING CONCRETE BUILDING BASE. REMOVE EXISTING BOLLARDS AND FOUNDATIONS IN THEIR ENTIRETY. REMOVE STEEL COLUMNS, FOUNDATIONS, AND COLUMN ENCLOSURE IN THEIR	
	D27	REMOVE STEEL COLUMNS, FOUNDATIONS, AND COLUMN ENCLOSURE IN THEIR ENTIRETY. REMOVE EXISTING RAISED CURB AREA IN ITS ENTIRETY.	
	D30 D32	REMOVE EXISTING INTERIOR COLUMN ENCASEMENT IN ITS ENTIRETY. REMOVE EXISTING INTERIOR STAIR IN ITS ENTIRETY.	BID SET - 06/25/2024
	D32 D34 D35	REMOVE EXISTING INTERIOR STAR IN ITS ENTIRE IT. REMOVE EXISTING ROOF SYSTEM IN ITS ENTIRETY INCLUDING STRUCTURE. REMOVE EXISTING ROOF SYSTEM IN ITS ENTIRETY DOWN TO ROOF DECK	י ז שנט אבו - 10/20/2024
	D35	INCLUDING BUT NOT LIMITED TO ALL FLASHINGS AND COPINGS.	
	D30 D37 D38	REMOVE EXISTING DECORATIVE CORNICE IN TIS ENTIRETY. REMOVE PNEUMATIC TUBE TRANSPORT ASSEMBLY IN ITS ENTIRETY. REMOVE LIGHT FIXTURE.	PROJECT:
	D39 D40	REMOVE LIGHT HATORE. REMOVE PASS THROUGH BOX. REMOVE CANOPY IN ITS ENTIRETY.	
	D40 D41 D43	REMOVE CANOF FINITS ENTIRET: REMOVE VAULT DOOR AND ASSEMBLY IN ITS ENTIRETY. REMOVE HVAC EQUIPMENT AND PATCH ROOF DECK PER NEW WORK.	HADDONFIELD POLICE
	D43 D44 D45	REMOVE AND SALVAGE ROOF HATCH FOR REINSTALLATION. REMOVE ROOF DRAIN IN ITS ENTIRETY.	STATION
	D46 D47	REMOVE EXISTING STOREFRONT ASSEMBLY IN ITS ENTIRETY. REMOVE EXISTING BRICK, CONCRETE BLOCK, AND WOOD FENCING ENCLOSURE	1 WALNUT STREET, HADDONFIELD, NJ 08033
	D48	AND CONCRETE SLAB IN ITS ENTIRETY. REMOVE EXISTING CHILLER IN ITS ENTIRETY.	FOR
	D49 D50	REMOVE SLAB AND FOUNDATIONS IN THEIR ENTIRETY. REMOVE ROOF DECK AT INDICATED AREA.	
			CAMDEN COUNTY IMPROVEMENT
			AUTHORITY
			520 MARKET STREET, 6TH FLOOR,
			CAMDEN, NEW JERSEY 08102
			FOR CODE REVIEW: 02/23
			REVISIONS:
			FOR BID: 06/25/20
			DRAWING TITLE:
			DEMOLITION PLANS
			COMMISSION NUMBER:
			23M014
			DO NOT SCALE THE DRAWINGS
			DRAWING NUMBER:
			D1.2

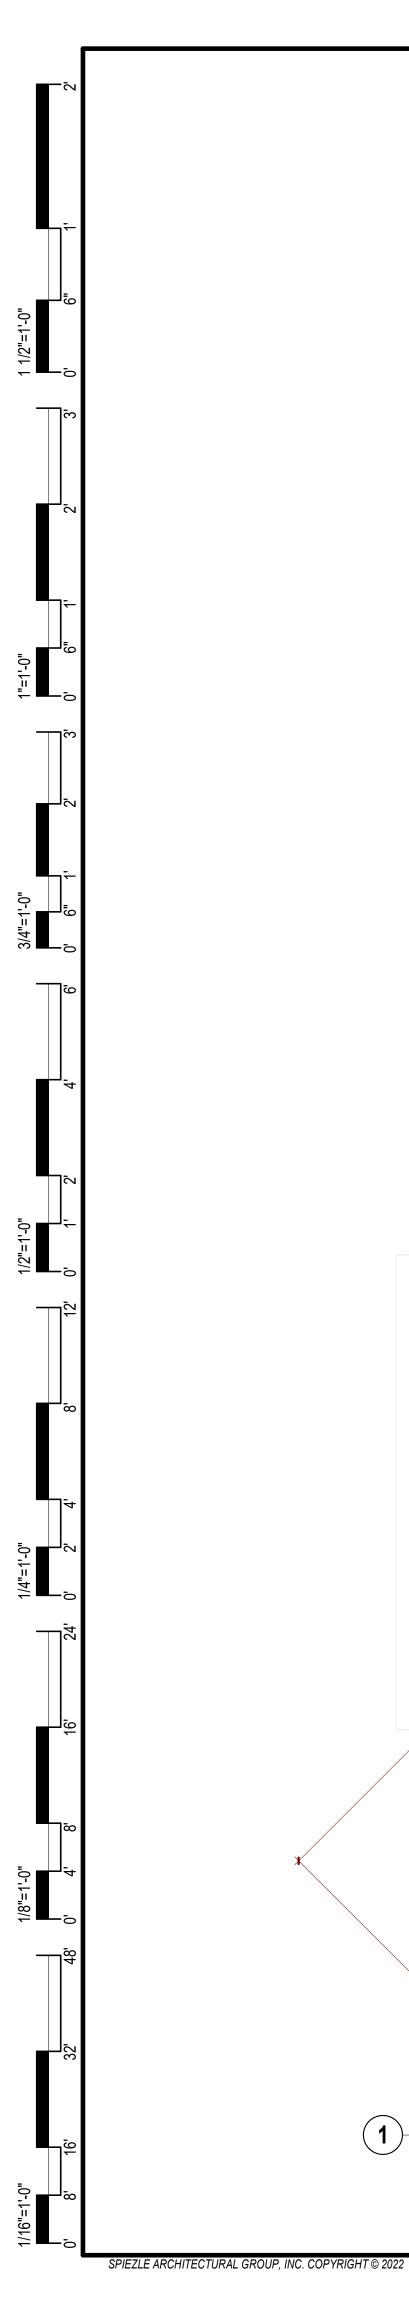




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	CERTIFICATE:
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	spieze
	SPIEZLE ARCHITECTURAL GROUP INC. 121 MARKET STREET CAMDEN, NJ 08102
	PHONE: (866) 974 7666
	SIGNATURE: THOMAS S. PERRINO 21AI01505400
	SCOTT E. DOWNIE         21AI01674400           STEVEN LEONE         21AI01170100           STEVEN G. SIEGEL         21AI01564200           ANGELO ALBERTO         21AI01046700
	JOHN F. WRIGHT 21AI01784200 SPIEZLE ARCHITECTURAL GROUP, INC. 21AC00063000
CK.	SEAL:
)	
S. ()	BID SET - 06/25/2024
	PROJECT:
TUD	
	HADDONFIELD POLICE
	STATION
	1 WALNUT STREET, HADDONFIELD, NJ
	08033 FOR
	CAMDEN COUNTY
	IMPROVEMENT
	520 MARKET STREET, 6TH FLOOR, CAMDEN, NEW JERSEY 08102
	FOR CODE REVIEW: 02/23/24
	REVISIONS:
	FOR BID: 06/25/2024 DRAWING TITLE:
	DETAILS
	23M014
	PARTITION TYPES AND DETAILS COMMISSION NUMBER: 23M014 DO NOT SCALE THE DRAWINGS DRAWING NUMBER: A1.0
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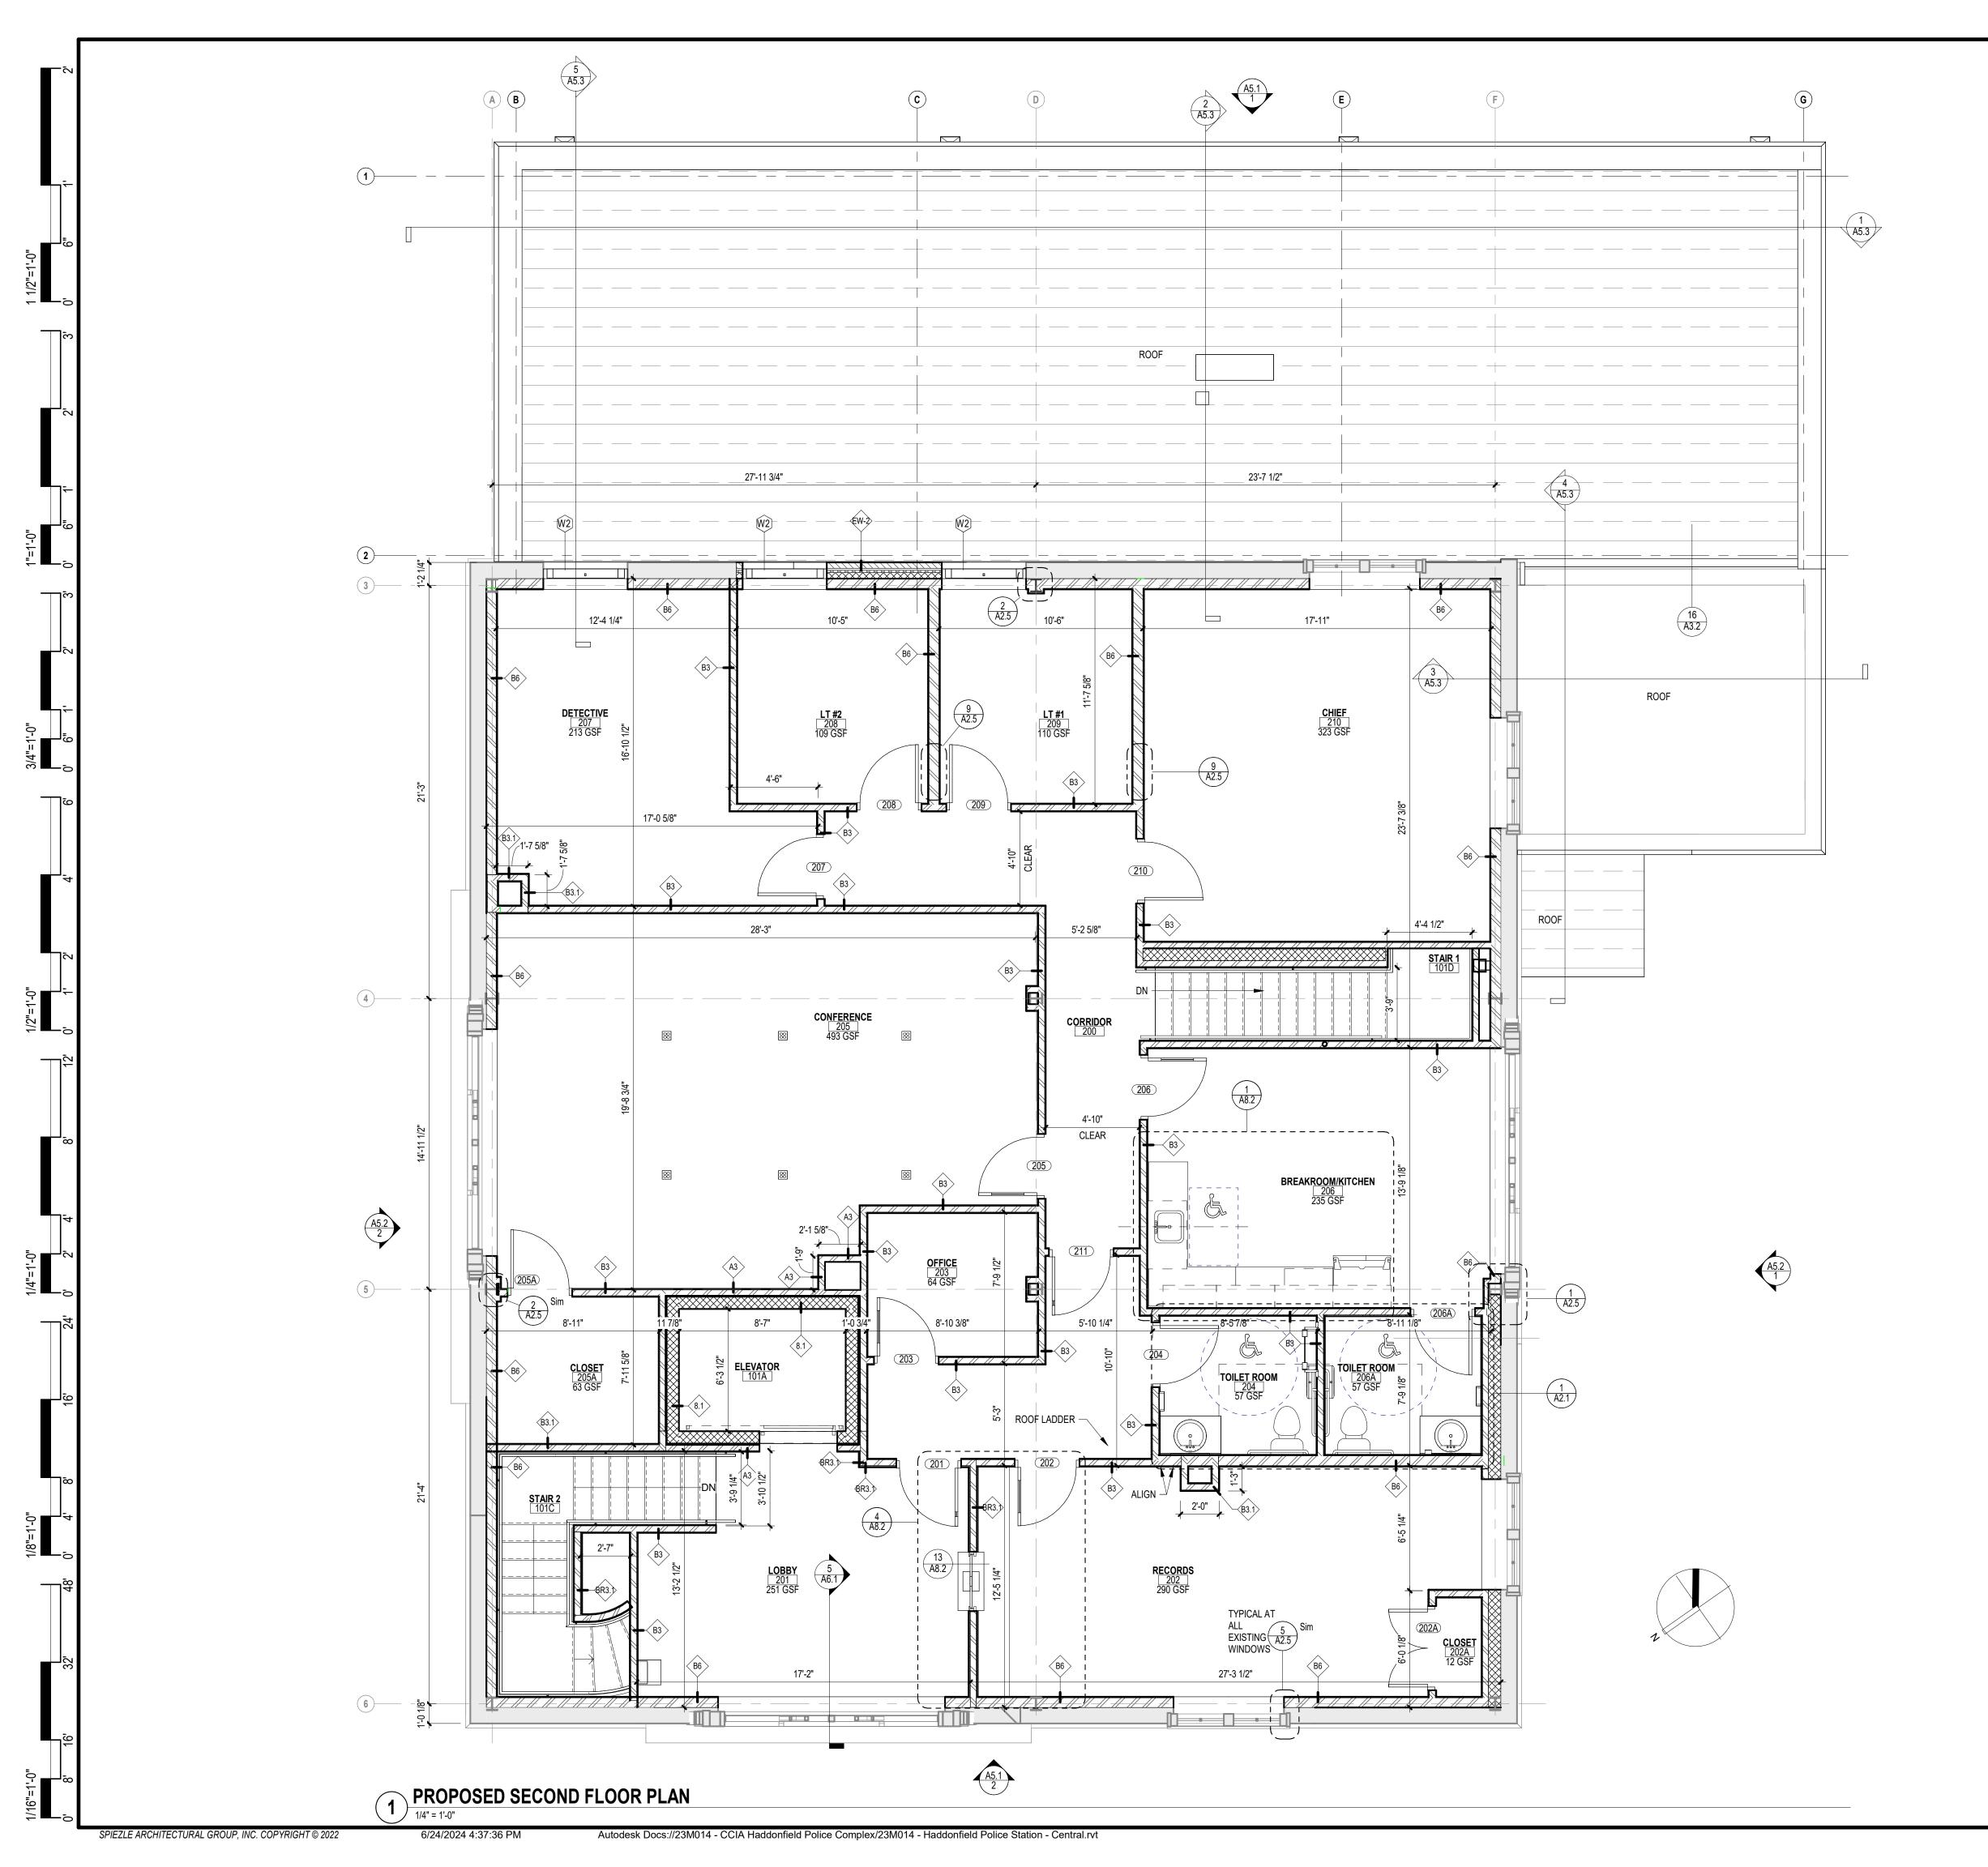
# PROPOSED METAL STUD WALL (SEE PARTITION TYPES) KXXXXXXXXXX PROPOSED CMU WALL (SEE PARTITION TYPES) EXISTING WALL TO REMAIN

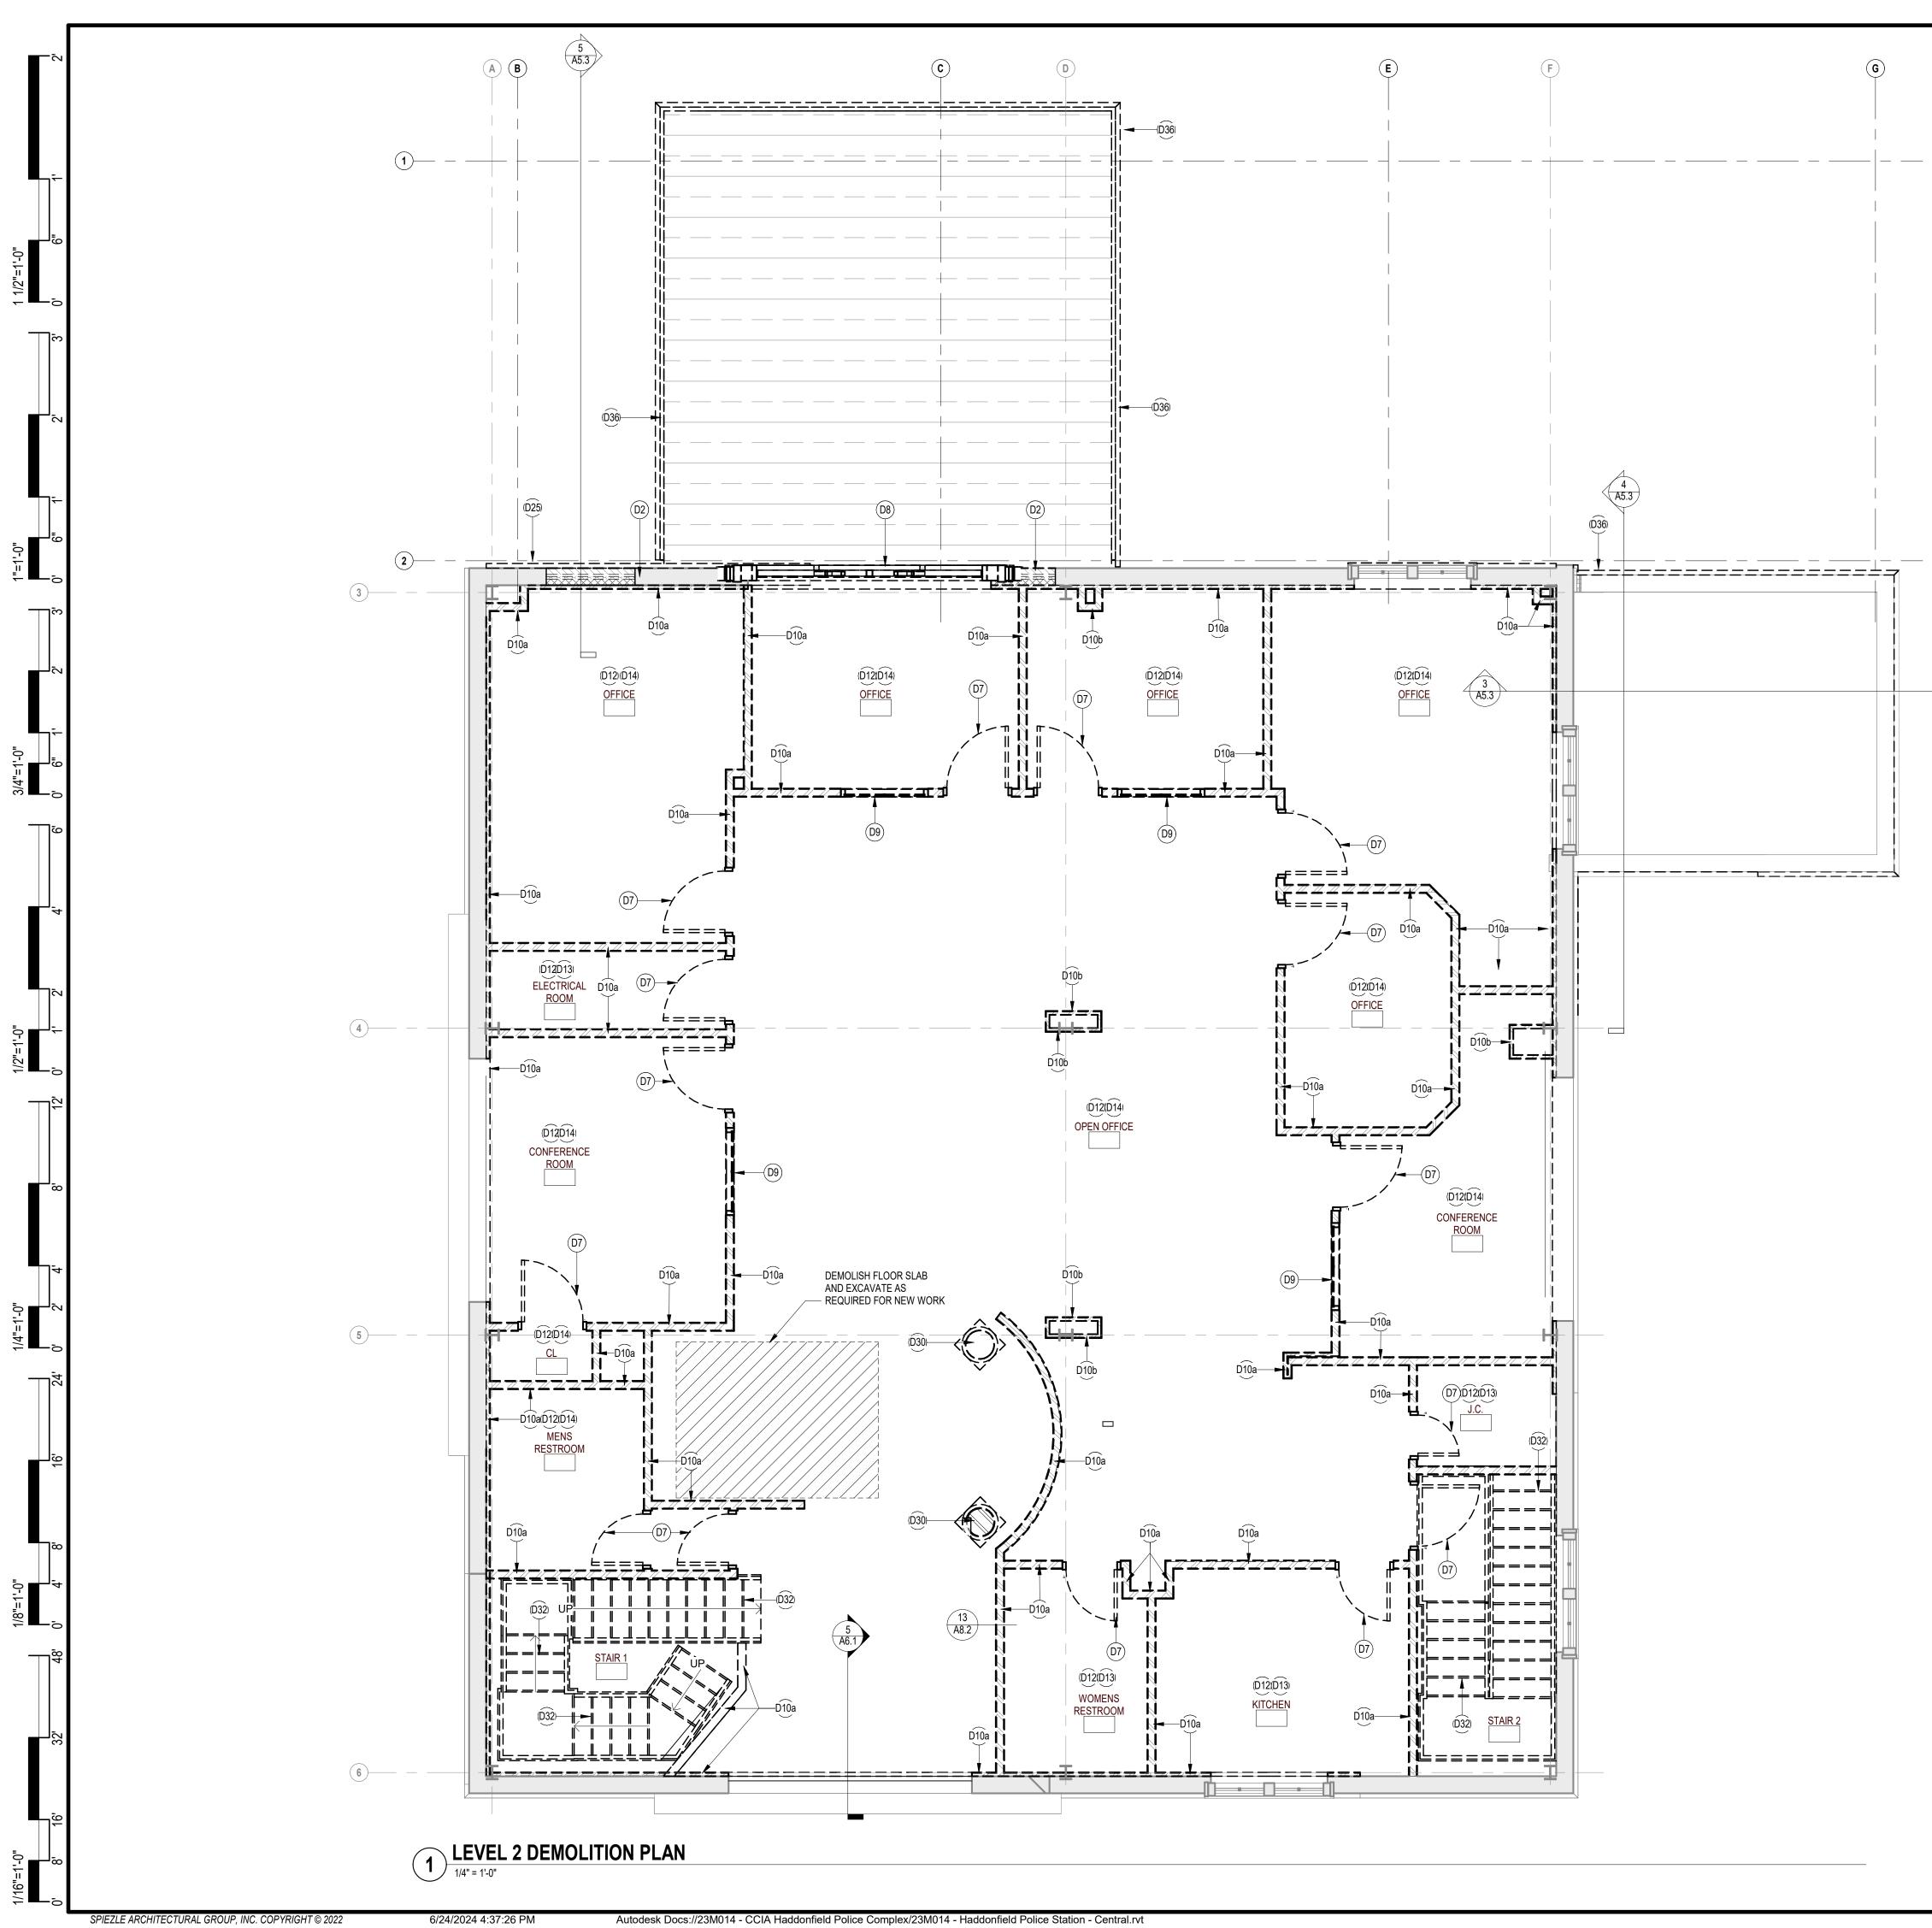EXISTING DOOR TO REMAIN


- ELEVATION AT TOP OF FINISHED FLOOR SLAB SHALL BE REFERENCED AS DATUM
- DO NOT SCALE THE DRAWINGS. IF A DIMENSION IS UNCLEAR OR A DISCREPANCY IS FOUND IT SHALL BE BROUGHT TO THE ATTENTION OF THE ARCHITECT. ALL DIMENSIONS SHALL BE FIELD VERIFIED PRIOR TO THE COMMENCEMENT OF WORK. WHERE FABRICATION IS REQUIRED, DIMENSIONS SHALL BE VERIFIED PRIOR TO THE
- CONTRACTOR SHALL COMPLY WITH ALL APPLICABLE CODES, STATUTES, AND
- REFER TO THE FIRE RESISTANCE DIRECTORY (LATEST EDITION) BY UNDERWRITER'S
- LABORATORIES FOR THE REQUIREMENTS OF ALL SPECIFIED FIRE RATED ASSEMBLIES. DETAILS AND SECTIONS ON THE DRAWINGS ARE SHOWN AT SPECIFIC LOCATIONS AND ARE INTENDED TO SHOW GENERAL REQUIREMENTS THROUGHOUT. CONDITIONS NOT SPECIFICALLY SHOWN SHALL BE CONSTRUCTED IN A SIMILAR MANNER OR BROUGHT TO THE ATTENTION OF THE ARCHITECT FOR CLARIFICATION. MODIFICATIONS MAY BE REQUIRED BY THE CONTRACTOR TO ACCOMMODATE FOR MINOR VARIATIONS IN THE
- THE CONTRACTOR SHALL BE RESPONSIBLE FOR COORDINATION AND INSTALLATION OF OWNER SUPPLIED EQUIPMENT AS IDENTIFIED IN THE DRAWINGS AND SPECIFICATIONS, INCLUDING THE RELOCATION OF EXISTING EQUIPMENT.
- THE CONTRACTOR IS RESPONSIBLE FOR LOCATING ALL EXISTING UNDERGROUND UTILITIES AND COORDINATING WITH NEW WORK. ADVISE ARCHITECT/ENGINEER OF CONFLICTS PRIOR TO COMMENCEMENT OF WORK.
- 10. PRIOR TO POURING OF CONCRETE FOOTINGS, THE CONCRETE REINFORCEMENT STEEL SHALL BE GROUNDED AND BONDED BY THE ELECTRICAL CONTRACTOR IN ACCORDANCE WITH THE NATIONAL ELECTRIC CODE (NEC) SECTION 250-50. A CONDUCTIVE REINFORCING BAR MEASURING AT LEAST 1/2" IN DIAMETER AND A MINIMUM OF 20 FEET IN LENGTH THAT IS ENCASED IN A MINIMUM OF 2" CONCRETE
- 1. THE GENERAL CONTRACTOR SHALL BE RESPONSIBLE FOR THE COORDINATION OF THE PROJECT AND SCHEDULING OF THE WORK CONDUCTED BY OTHER TRADES. 2. THE CONTRACTOR SHALL CONSTRUCT CHASES AND/OR RECESSES AS SHOWN, AND AS
- REQUIRED TO CONCEAL THE WORK OF OTHER TRADES AS DIRECTED BY THE ARCHITECT TO MATCH ADJACENT CONSTRUCTION, REGARDLESS IF SHOWN ON THE 13. THE CONTRACTOR SHALL INSTALL LOOSE LINTELS FOR ALL WALL PENETRATIONS
- WIDER THAN 6" AS A RESULT OF DUCT, PIPE OR OTHER EQUIPMENT INSTALLATIONS. 14. ALL WALL AND FLOOR PENETRATIONS SHALL BE PATCHED AND SEALED BY THEIR
- 15. ALL FLOOR PENETRATIONS FOR PIPING AND CONDUIT SHALL BE SLEEVED AND SEALED. 16. PARTITIONS SHALL BE LAID OUT STARTING FROM CONDITIONS WHERE ALIGNMENT WITH EXISTING CONSTRUCTION IS SHOWN. UNLESS OTHERWISE NOTED, DIMENSIONS ARE
- 7. DIMENSIONS TO MASONRY CONSTRUCTION ARE GIVEN TO THE NOMINAL FACE OF THE WALL. EXTERIOR MASONRY DIMENSIONS ARE TAKEN TO THE NOMINAL FACE OF THE WALL, UNLESS OTHERWISE NOTED. CLEAR DIMENSIONS SHALL BE TAKEN FROM THE
- 18. WALLS OVERLAPPING COLUMN LINES SHALL BE ASSUMED CENTERED ON THE COLUMN 19. THE CONTRACTOR SHALL FURNISH AND INSTALL BLOCKING IN FRAMED WALL
- ASSEMBLIES WHERE WALL MOUNTED ACCESSORIES, CABINETS OR OTHER 0. TERMINATE ALL INTERIOR WALLS TO THE UNDERSIDE OF DECKING, UNLESS OTHERWISE
- NOTED OR INDICATED BY SPECIFIC PARTITION TYPES. 21. ALL OUTSIDE CMU CORNERS OF INTERIOR WALLS SHALL BE BULLNOSED, UNLESS
- 22. PROVIDE ANGLED BLOCKS AND BRICKS FOR OUTSIDE CORNERS OF MASONRY WALLS OR OTHER SPECIAL SHAPES AVAILABLE FROM MANUFACTURER. 23. REFER TO ROOM FINISH LEGEND AND PROJECT SPECIFICATIONS FOR FINISH

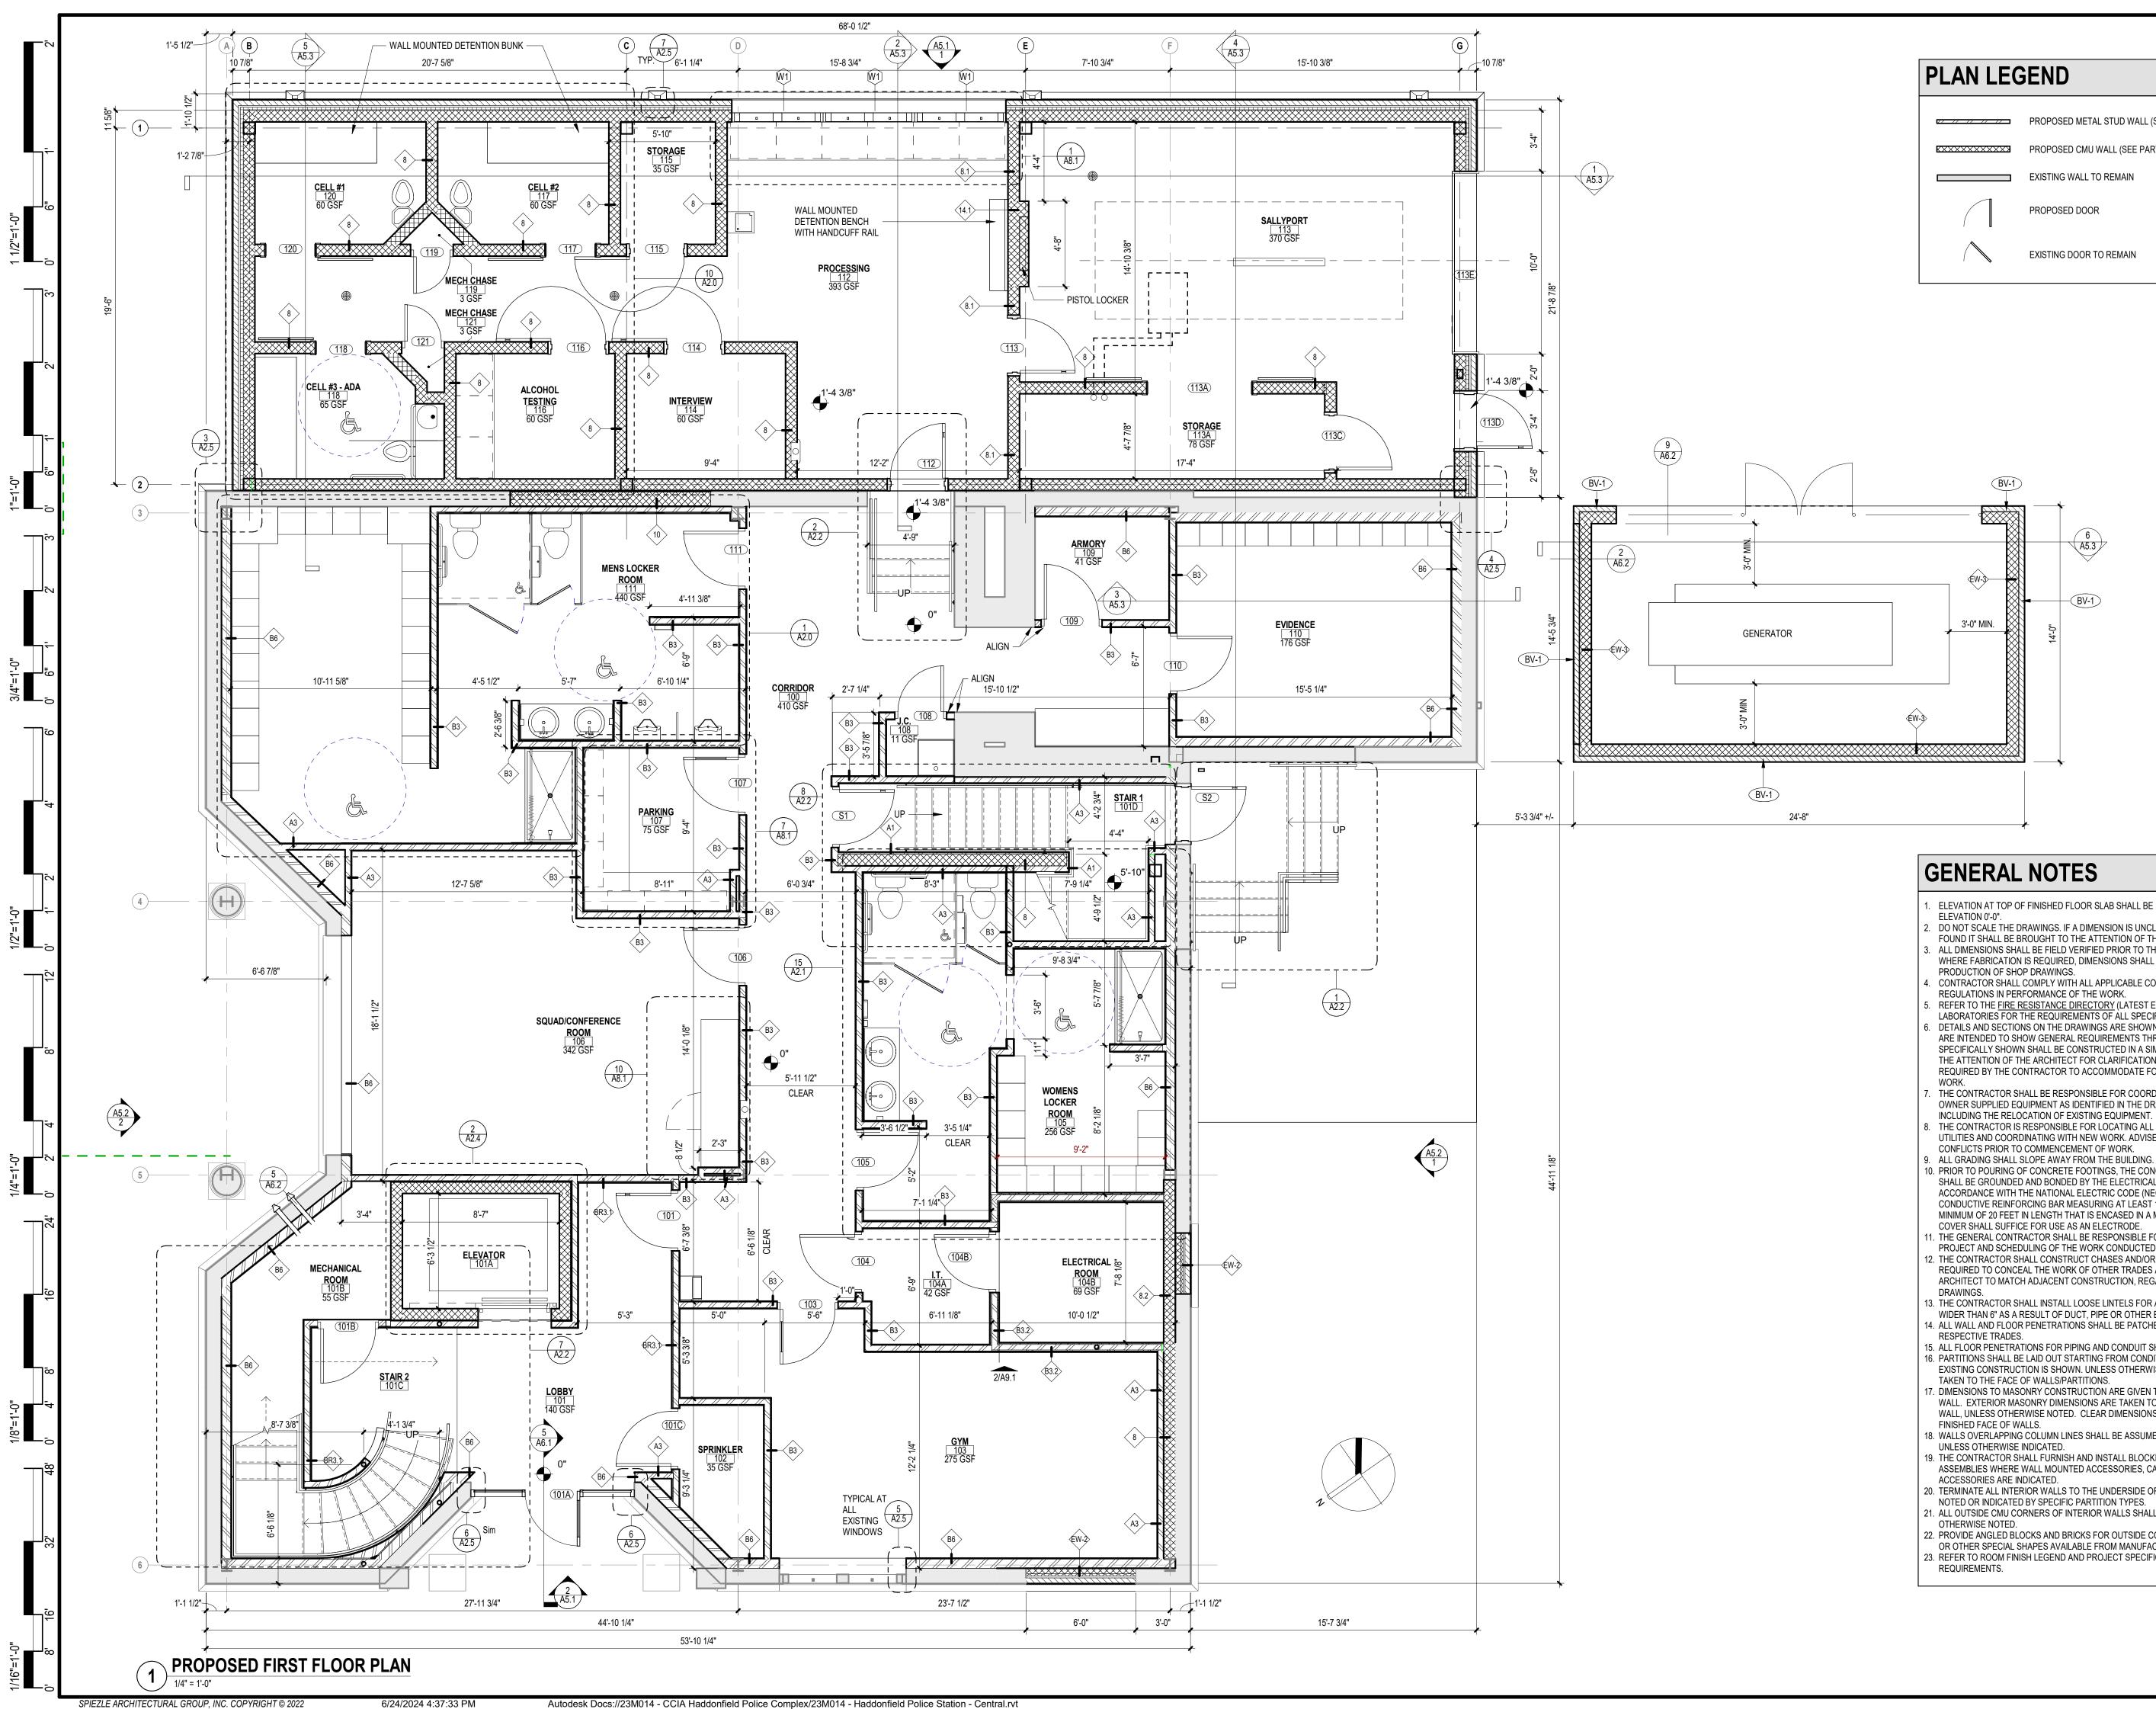CERTIFICATE:	
spieze	
SPIEZLE ARCHITECTURAL GROUP INC. 121 MARKET STREET CAMDEN, NJ 08102 PHONE: (866) 974 7666	
SIGNATURE:           THOMAS S. PERRINO         21AI01505400           SCOTT E. DOWNIE         21AI01674400           STEVEN LEONE         21AI01170100	
STEVEN G. SIEGEL 21A/01564200 ANGELO ALBERTO 21A/0106700 JOHN F. WRIGHT 21A/01784200 SPIEZLE ARCHITECTURAL GROUP, INC. 21AC00063000	
SEAL:	
BID SET - 06/25/2024	
PROJECT:	
HADDONFIELD POLICE	
STATION 1 WALNUT STREET, HADDONFIELD, NJ	
08033 FOR	
CAMDEN COUNTY	
AUTHORITY 520 MARKET STREET, 6TH FLOOR,	
CAMDEN, NEW JERSEY 08102	
REVISIONS:	
FOR BID: 06/25/2024	
DRAWING TITLE:	
FIRST FLOOR PLAN	
COMMISSION NUMBER: 23M014	
DO NOT SCALE THE DRAWINGS	

CODE REVIEW:



### PLAN LEGEND

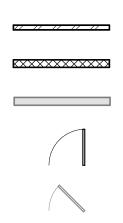

PROPOSED METAL STUD WALL (SEE PARTITION TYPES)

CODE REVIEW:

PROPOSED CMU WALL (SEE PARTITION TYPES)


EXISTING WALL TO REMAIN


PROPOSED DOOR

EXISTING DOOR TO REMAIN


### **GENERAL NOTES**


- ELEVATION AT TOP OF FINISHED FLOOR SLAB SHALL BE REFERENCED AS DATUM ELEVATION 0'-0".
- DO NOT SCALE THE DRAWINGS. IF A DIMENSION IS UNCLEAR OR A DISCREPANCY IS FOUND IT SHALL BE BROUGHT TO THE ATTENTION OF THE ARCHITECT. ALL DIMENSIONS SHALL BE FIELD VERIFIED PRIOR TO THE COMMENCEMENT OF WORK. WHERE FABRICATION IS REQUIRED, DIMENSIONS SHALL BE VERIFIED PRIOR TO THE
- PRODUCTION OF SHOP DRAWINGS. CONTRACTOR SHALL COMPLY WITH ALL APPLICABLE CODES, STATUTES, AND
- REGULATIONS IN PERFORMANCE OF THE WORK. REFER TO THE FIRE RESISTANCE DIRECTORY (LATEST EDITION) BY UNDERWRITER'S
- LABORATORIES FOR THE REQUIREMENTS OF ALL SPECIFIED FIRE RATED ASSEMBLIES. DETAILS AND SECTIONS ON THE DRAWINGS ARE SHOWN AT SPECIFIC LOCATIONS AND ARE INTENDED TO SHOW GENERAL REQUIREMENTS THROUGHOUT. CONDITIONS NOT SPECIFICALLY SHOWN SHALL BE CONSTRUCTED IN A SIMILAR MANNER OR BROUGHT T THE ATTENTION OF THE ARCHITECT FOR CLARIFICATION. MODIFICATIONS MAY BE REQUIRED BY THE CONTRACTOR TO ACCOMMODATE FOR MINOR VARIATIONS IN THE WORK.
- THE CONTRACTOR SHALL BE RESPONSIBLE FOR COORDINATION AND INSTALLATION OF OWNER SUPPLIED EQUIPMENT AS IDENTIFIED IN THE DRAWINGS AND SPECIFICATIONS, INCLUDING THE RELOCATION OF EXISTING EQUIPMENT.
- THE CONTRACTOR IS RESPONSIBLE FOR LOCATING ALL EXISTING UNDERGROUND UTILITIES AND COORDINATING WITH NEW WORK. ADVISE ARCHITECT/ENGINEER OF
- CONFLICTS PRIOR TO COMMENCEMENT OF WORK. ALL GRADING SHALL SLOPE AWAY FROM THE BUILDING.
- 0. PRIOR TO POURING OF CONCRETE FOOTINGS, THE CONCRETE REINFORCEMENT STEEL SHALL BE GROUNDED AND BONDED BY THE ELECTRICAL CONTRACTOR IN ACCORDANCE WITH THE NATIONAL ELECTRIC CODE (NEC) SECTION 250-50. A CONDUCTIVE REINFORCING BAR MEASURING AT LEAST 1/2" IN DIAMETER AND A MINIMUM OF 20 FEET IN LENGTH THAT IS ENCASED IN A MINIMUM OF 2" CONCRETE COVER SHALL SUFFICE FOR USE AS AN ELECTRODE.
- . THE GENERAL CONTRACTOR SHALL BE RESPONSIBLE FOR THE COORDINATION OF THE PROJECT AND SCHEDULING OF THE WORK CONDUCTED BY OTHER TRADES. . THE CONTRACTOR SHALL CONSTRUCT CHASES AND/OR RECESSES AS SHOWN, AND AS REQUIRED TO CONCEAL THE WORK OF OTHER TRADES AS DIRECTED BY THE ARCHITECT TO MATCH ADJACENT CONSTRUCTION, REGARDLESS IF SHOWN ON THE
- DRAWINGS. 13. THE CONTRACTOR SHALL INSTALL LOOSE LINTELS FOR ALL WALL PENETRATIONS WIDER THAN 6" AS A RESULT OF DUCT, PIPE OR OTHER EQUIPMENT INSTALLATIONS.
- 4. ALL WALL AND FLOOR PENETRATIONS SHALL BE PATCHED AND SEALED BY THEIR RESPECTIVE TRADES.
- 15. ALL FLOOR PENETRATIONS FOR PIPING AND CONDUIT SHALL BE SLEEVED AND SEALED 16. PARTITIONS SHALL BE LAID OUT STARTING FROM CONDITIONS WHERE ALIGNMENT WITH EXISTING CONSTRUCTION IS SHOWN. UNLESS OTHERWISE NOTED, DIMENSIONS ARE TAKEN TO THE FACE OF WALLS/PARTITIONS.
- . DIMENSIONS TO MASONRY CONSTRUCTION ARE GIVEN TO THE NOMINAL FACE OF THE WALL. EXTERIOR MASONRY DIMENSIONS ARE TAKEN TO THE NOMINAL FACE OF THE WALL, UNLESS OTHERWISE NOTED. CLEAR DIMENSIONS SHALL BE TAKEN FROM THE FINISHED FACE OF WALLS.
- 8. WALLS OVERLAPPING COLUMN LINES SHALL BE ASSUMED CENTERED ON THE COLUMN UNLESS OTHERWISE INDICATED. 19. THE CONTRACTOR SHALL FURNISH AND INSTALL BLOCKING IN FRAMED WALL ASSEMBLIES WHERE WALL MOUNTED ACCESSORIES, CABINETS OR OTHER
- ACCESSORIES ARE INDICATED. 20. TERMINATE ALL INTERIOR WALLS TO THE UNDERSIDE OF DECKING, UNLESS OTHERWISI NOTED OR INDICATED BY SPECIFIC PARTITION TYPES.
- 21. ALL OUTSIDE CMU CORNERS OF INTERIOR WALLS SHALL BE BULLNOSED, UNLESS OTHERWISE NOTED. 22. PROVIDE ANGLED BLOCKS AND BRICKS FOR OUTSIDE CORNERS OF MASONRY WALLS
- OR OTHER SPECIAL SHAPES AVAILABLE FROM MANUFACTURER. 23. REFER TO ROOM FINISH LEGEND AND PROJECT SPECIFICATIONS FOR FINISH REQUIREMENTS.

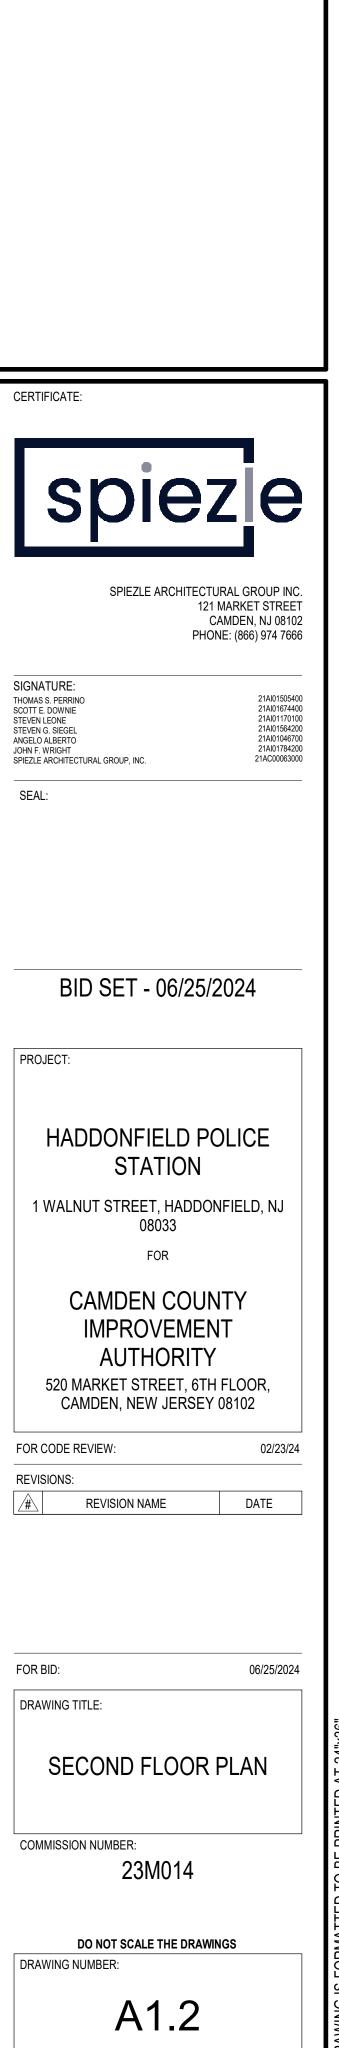

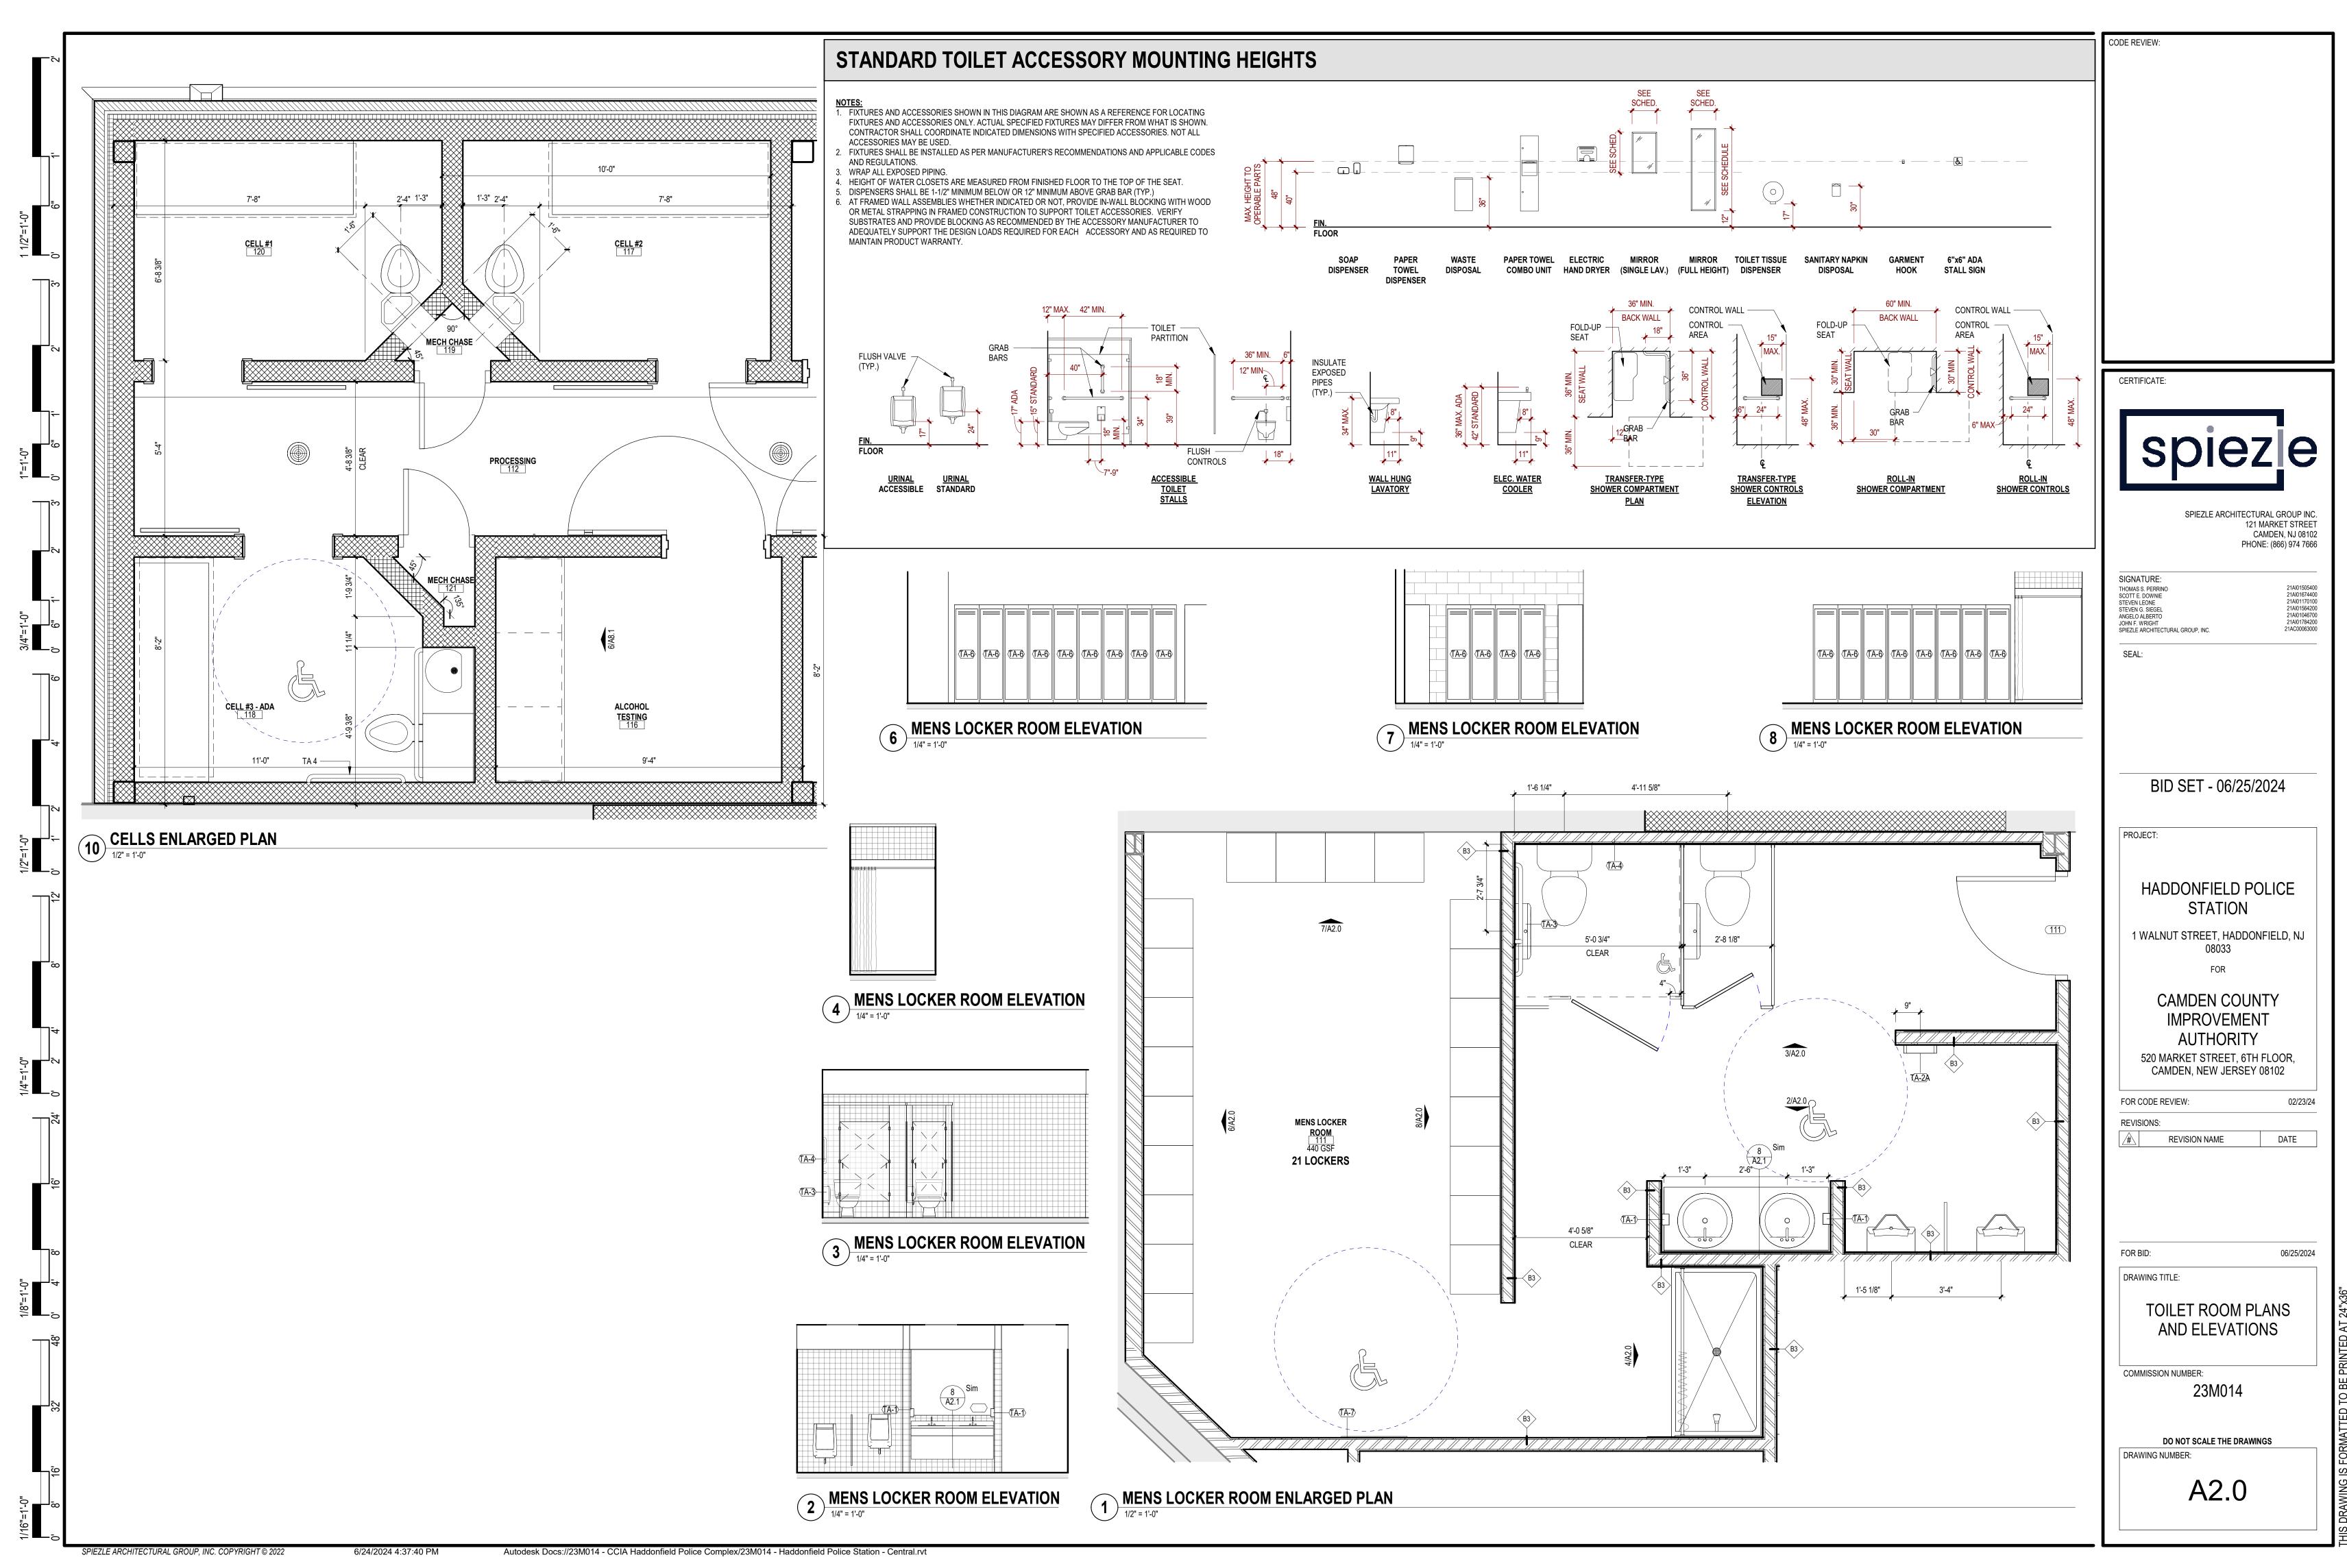



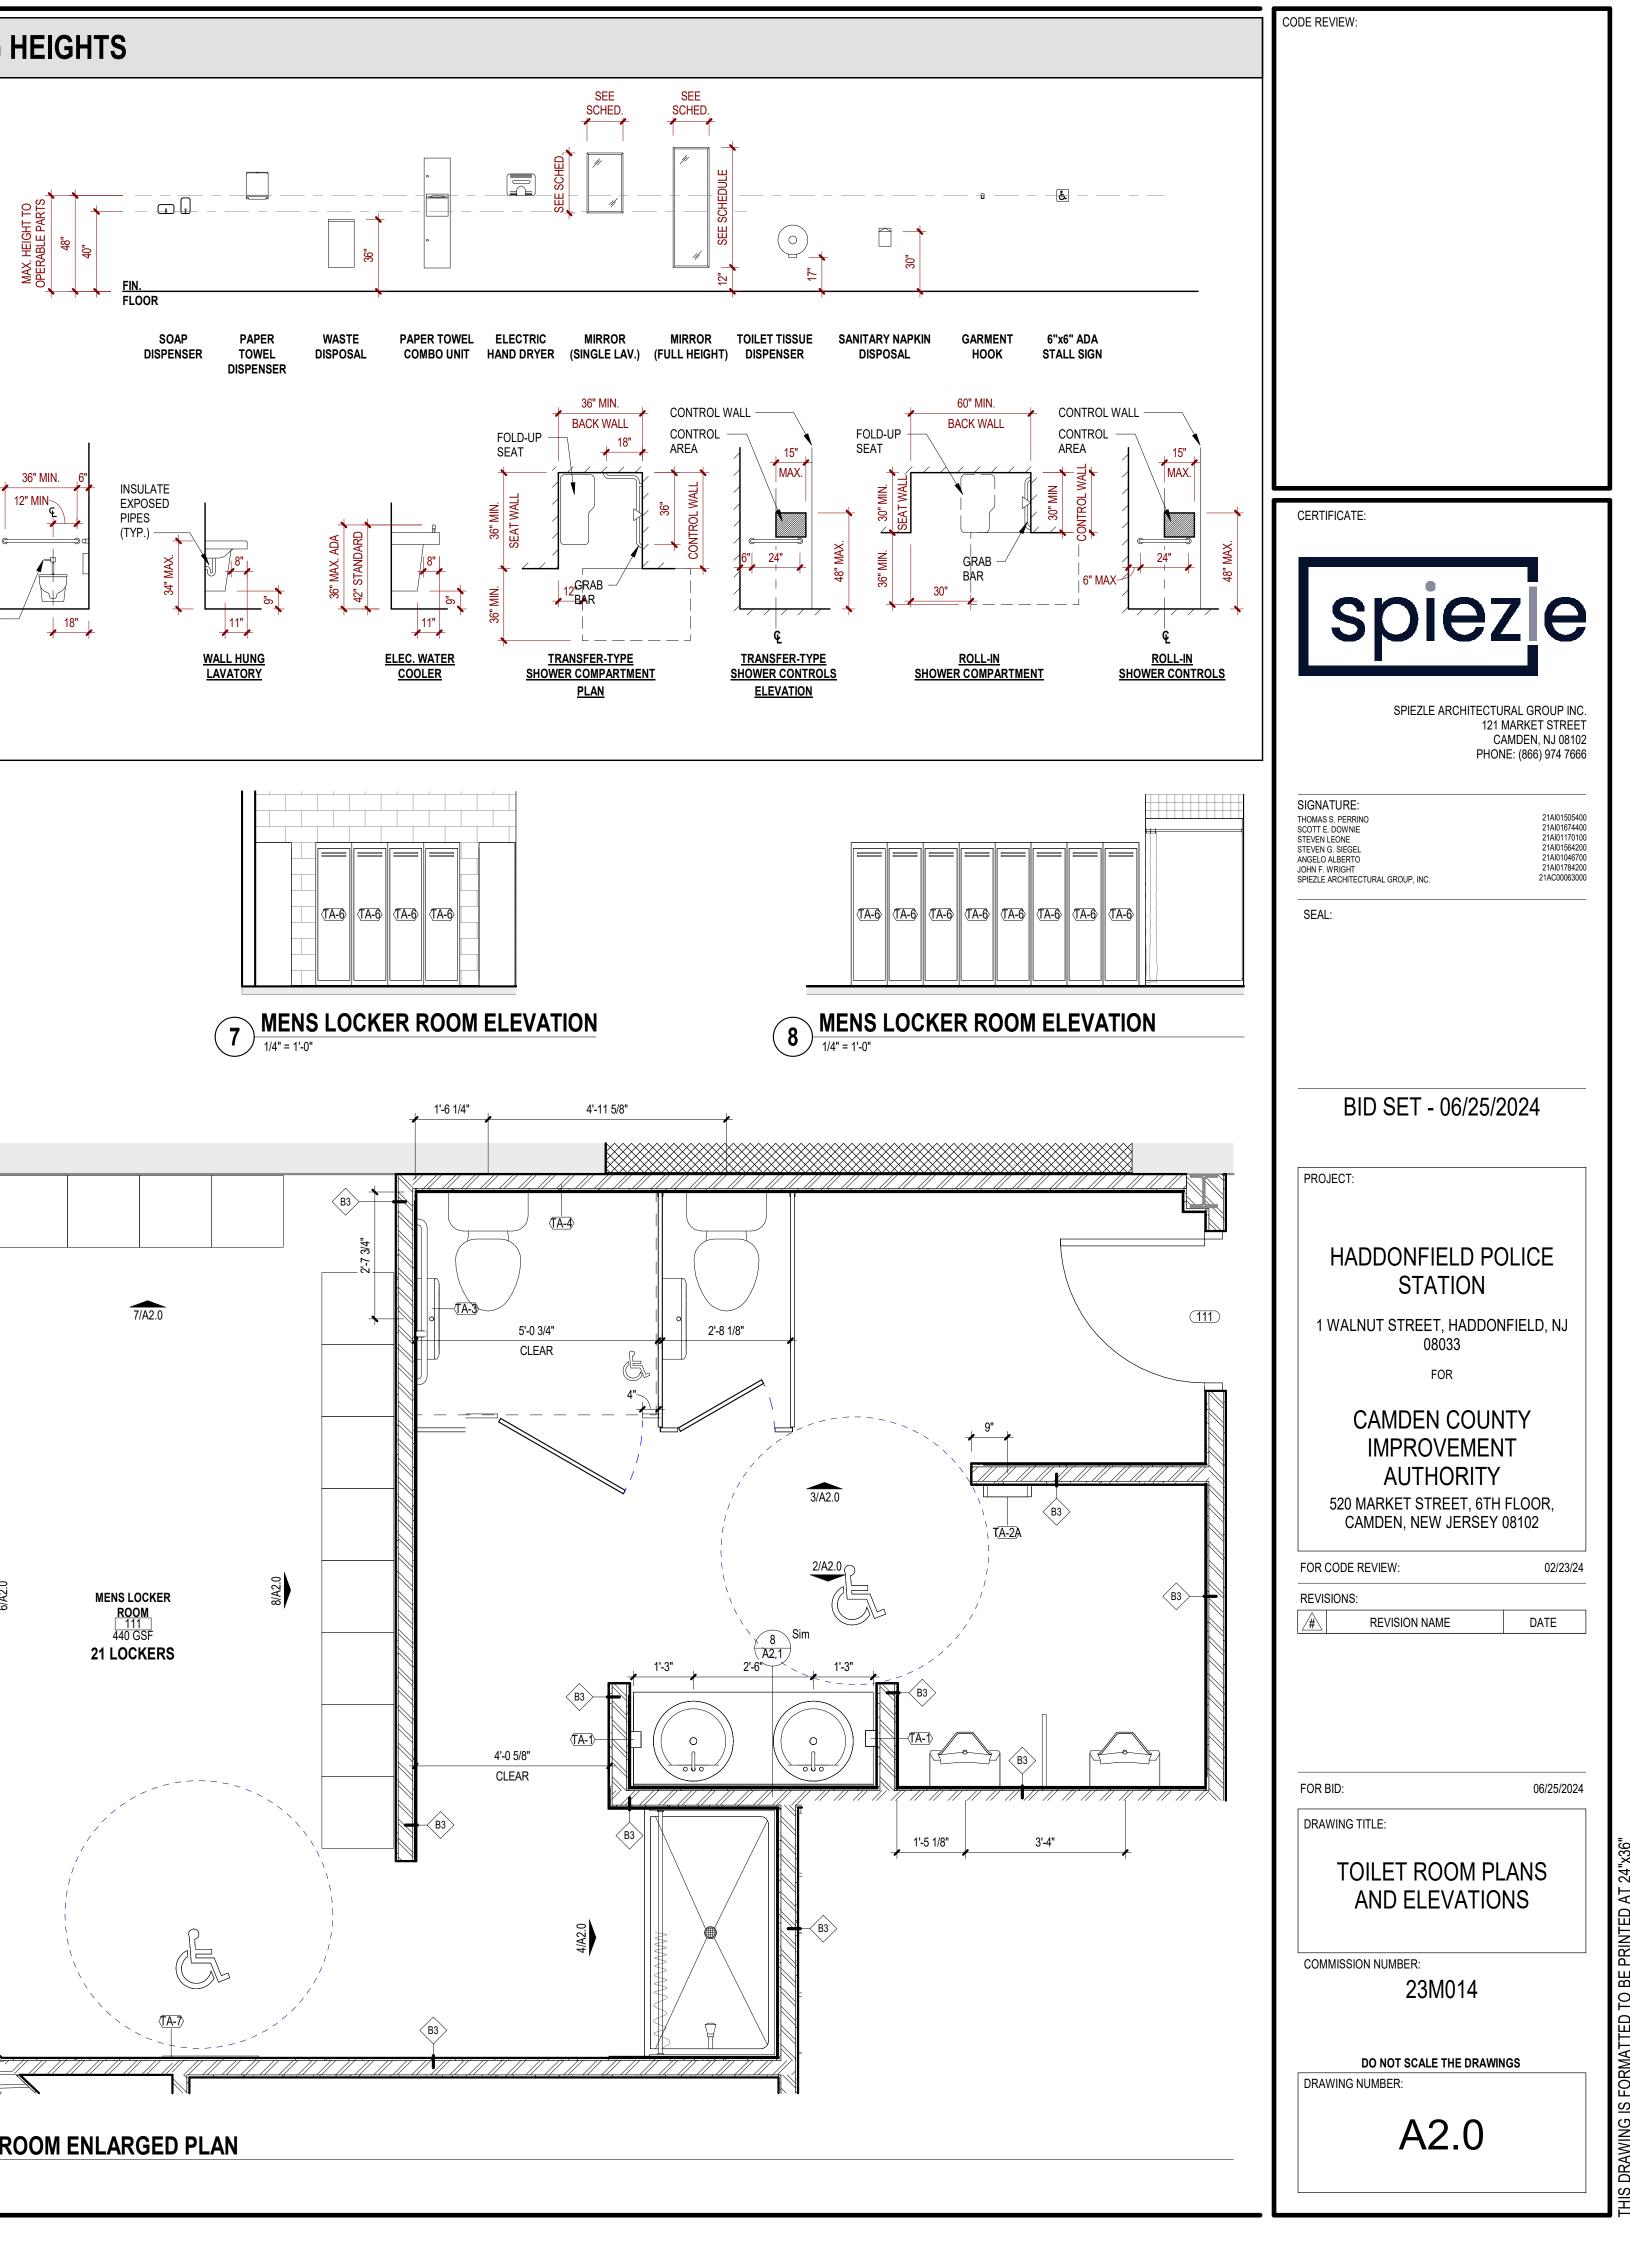

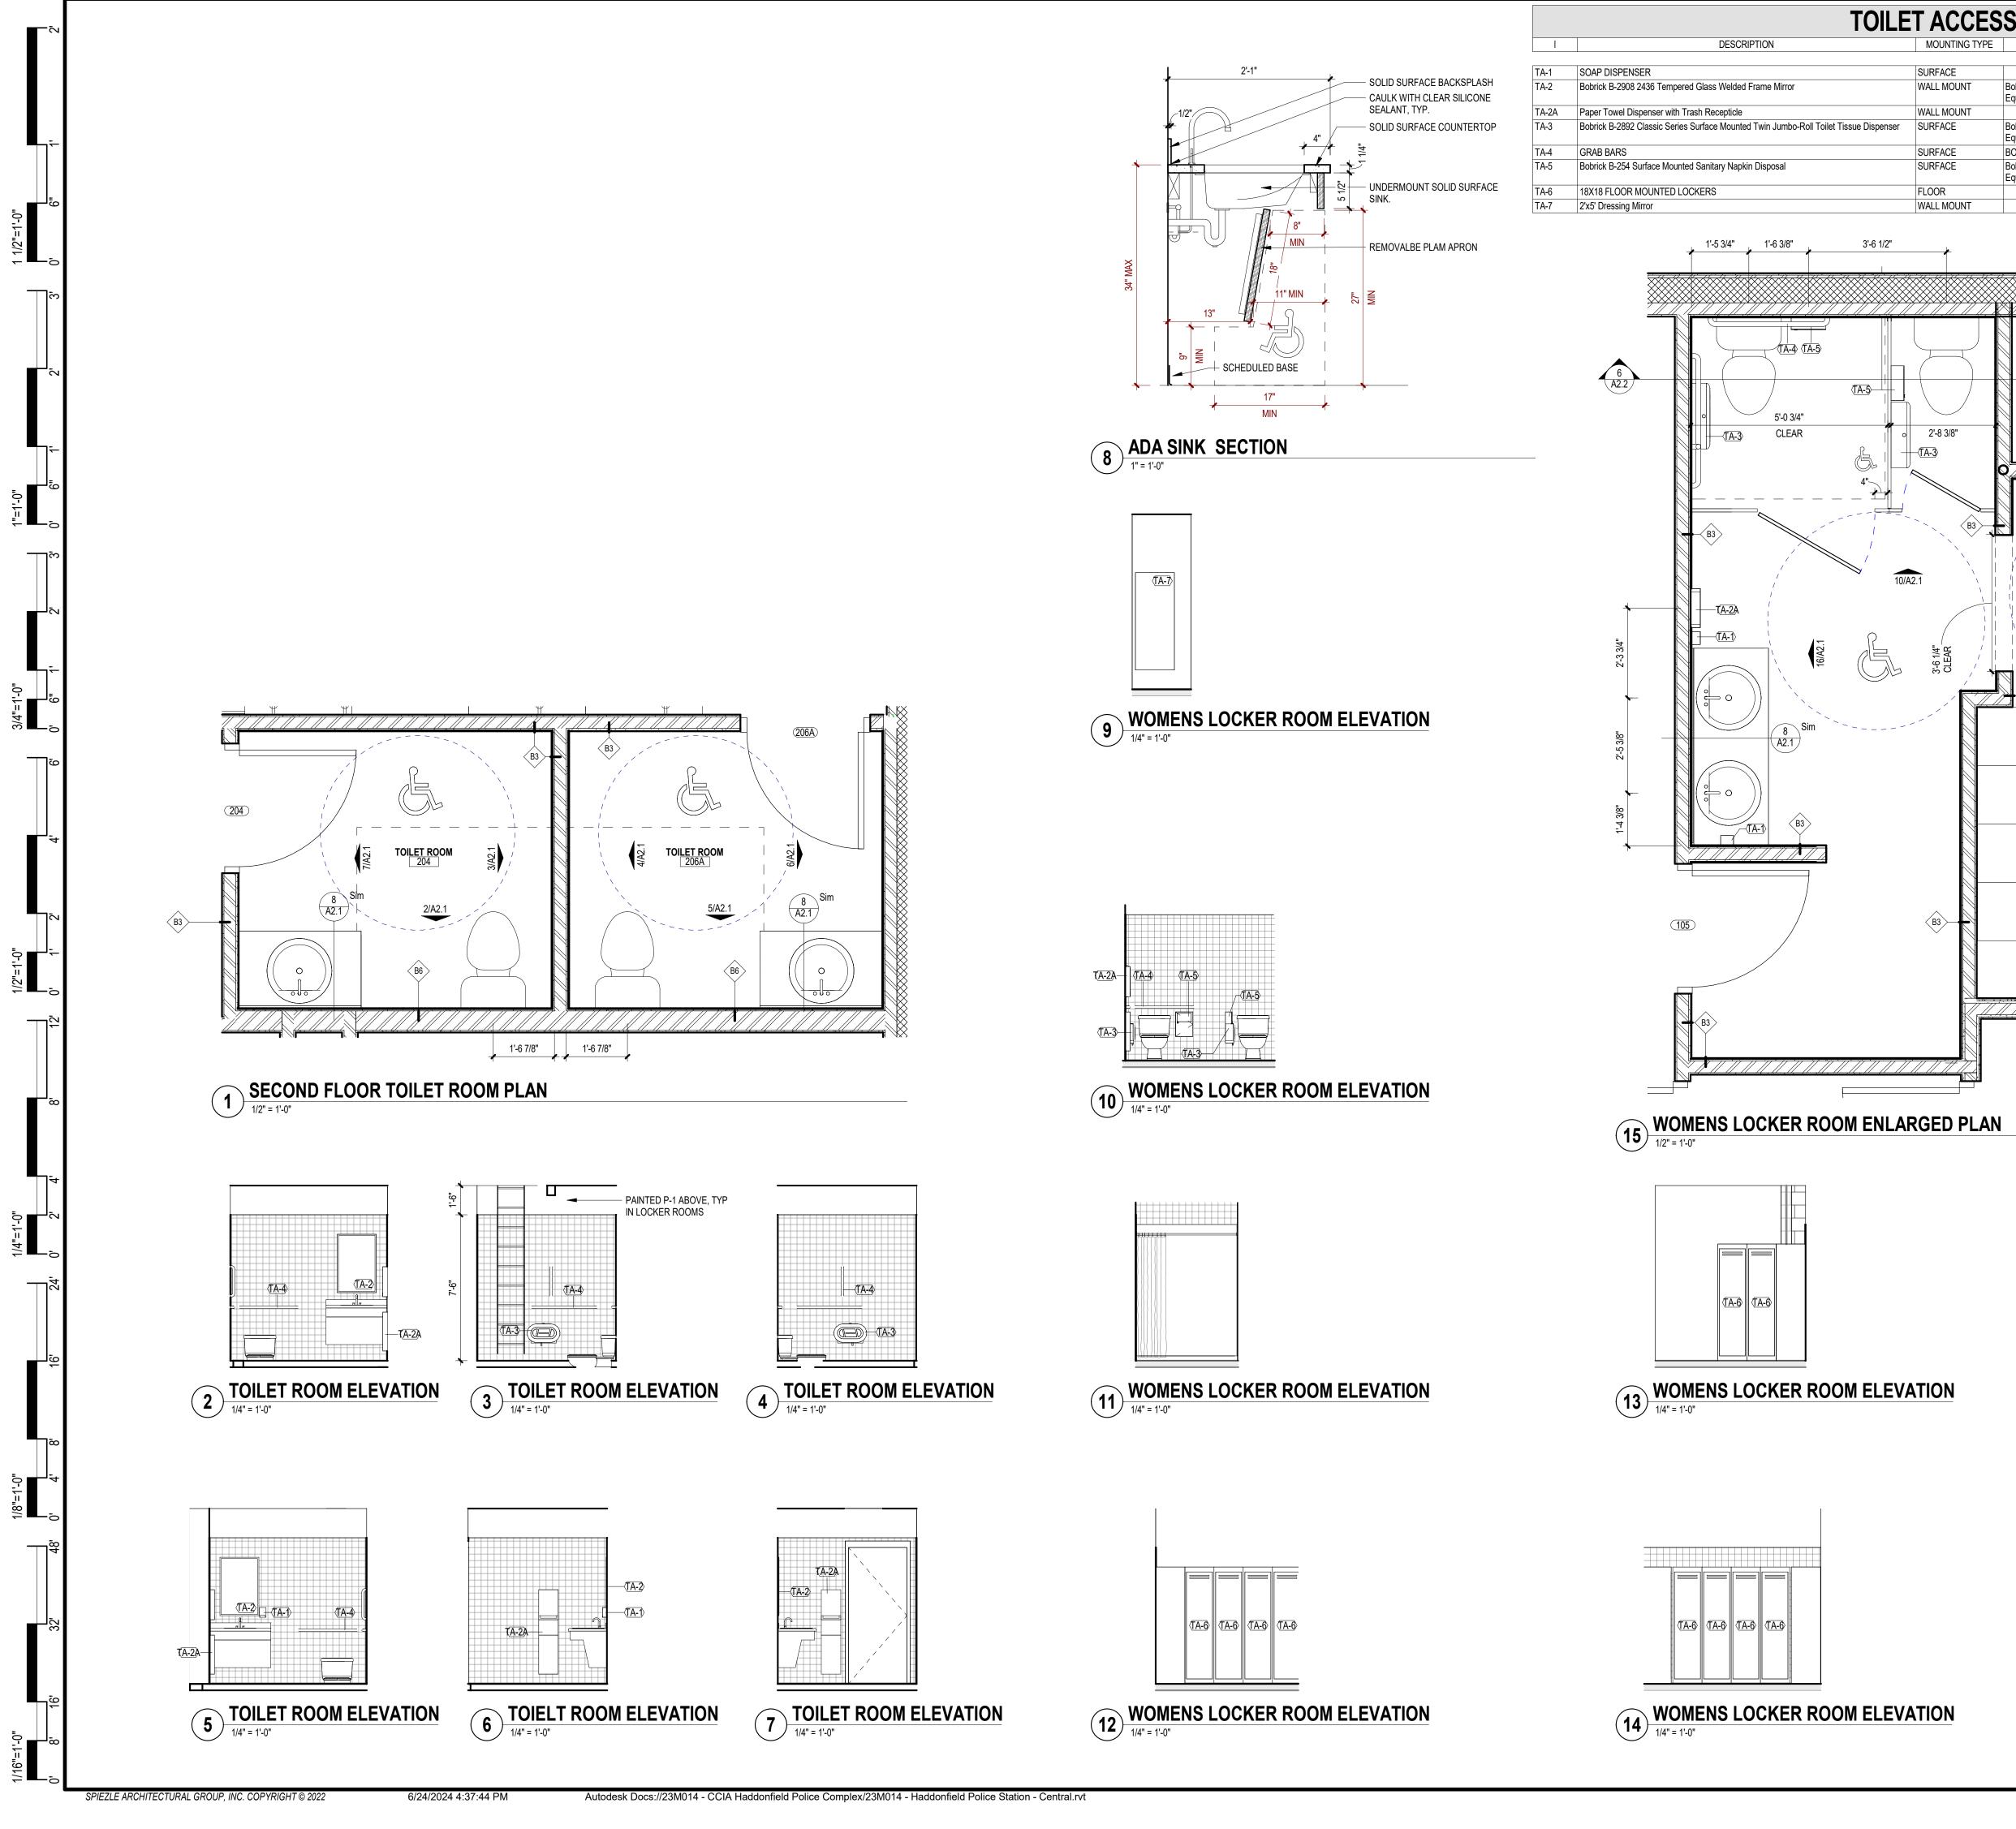


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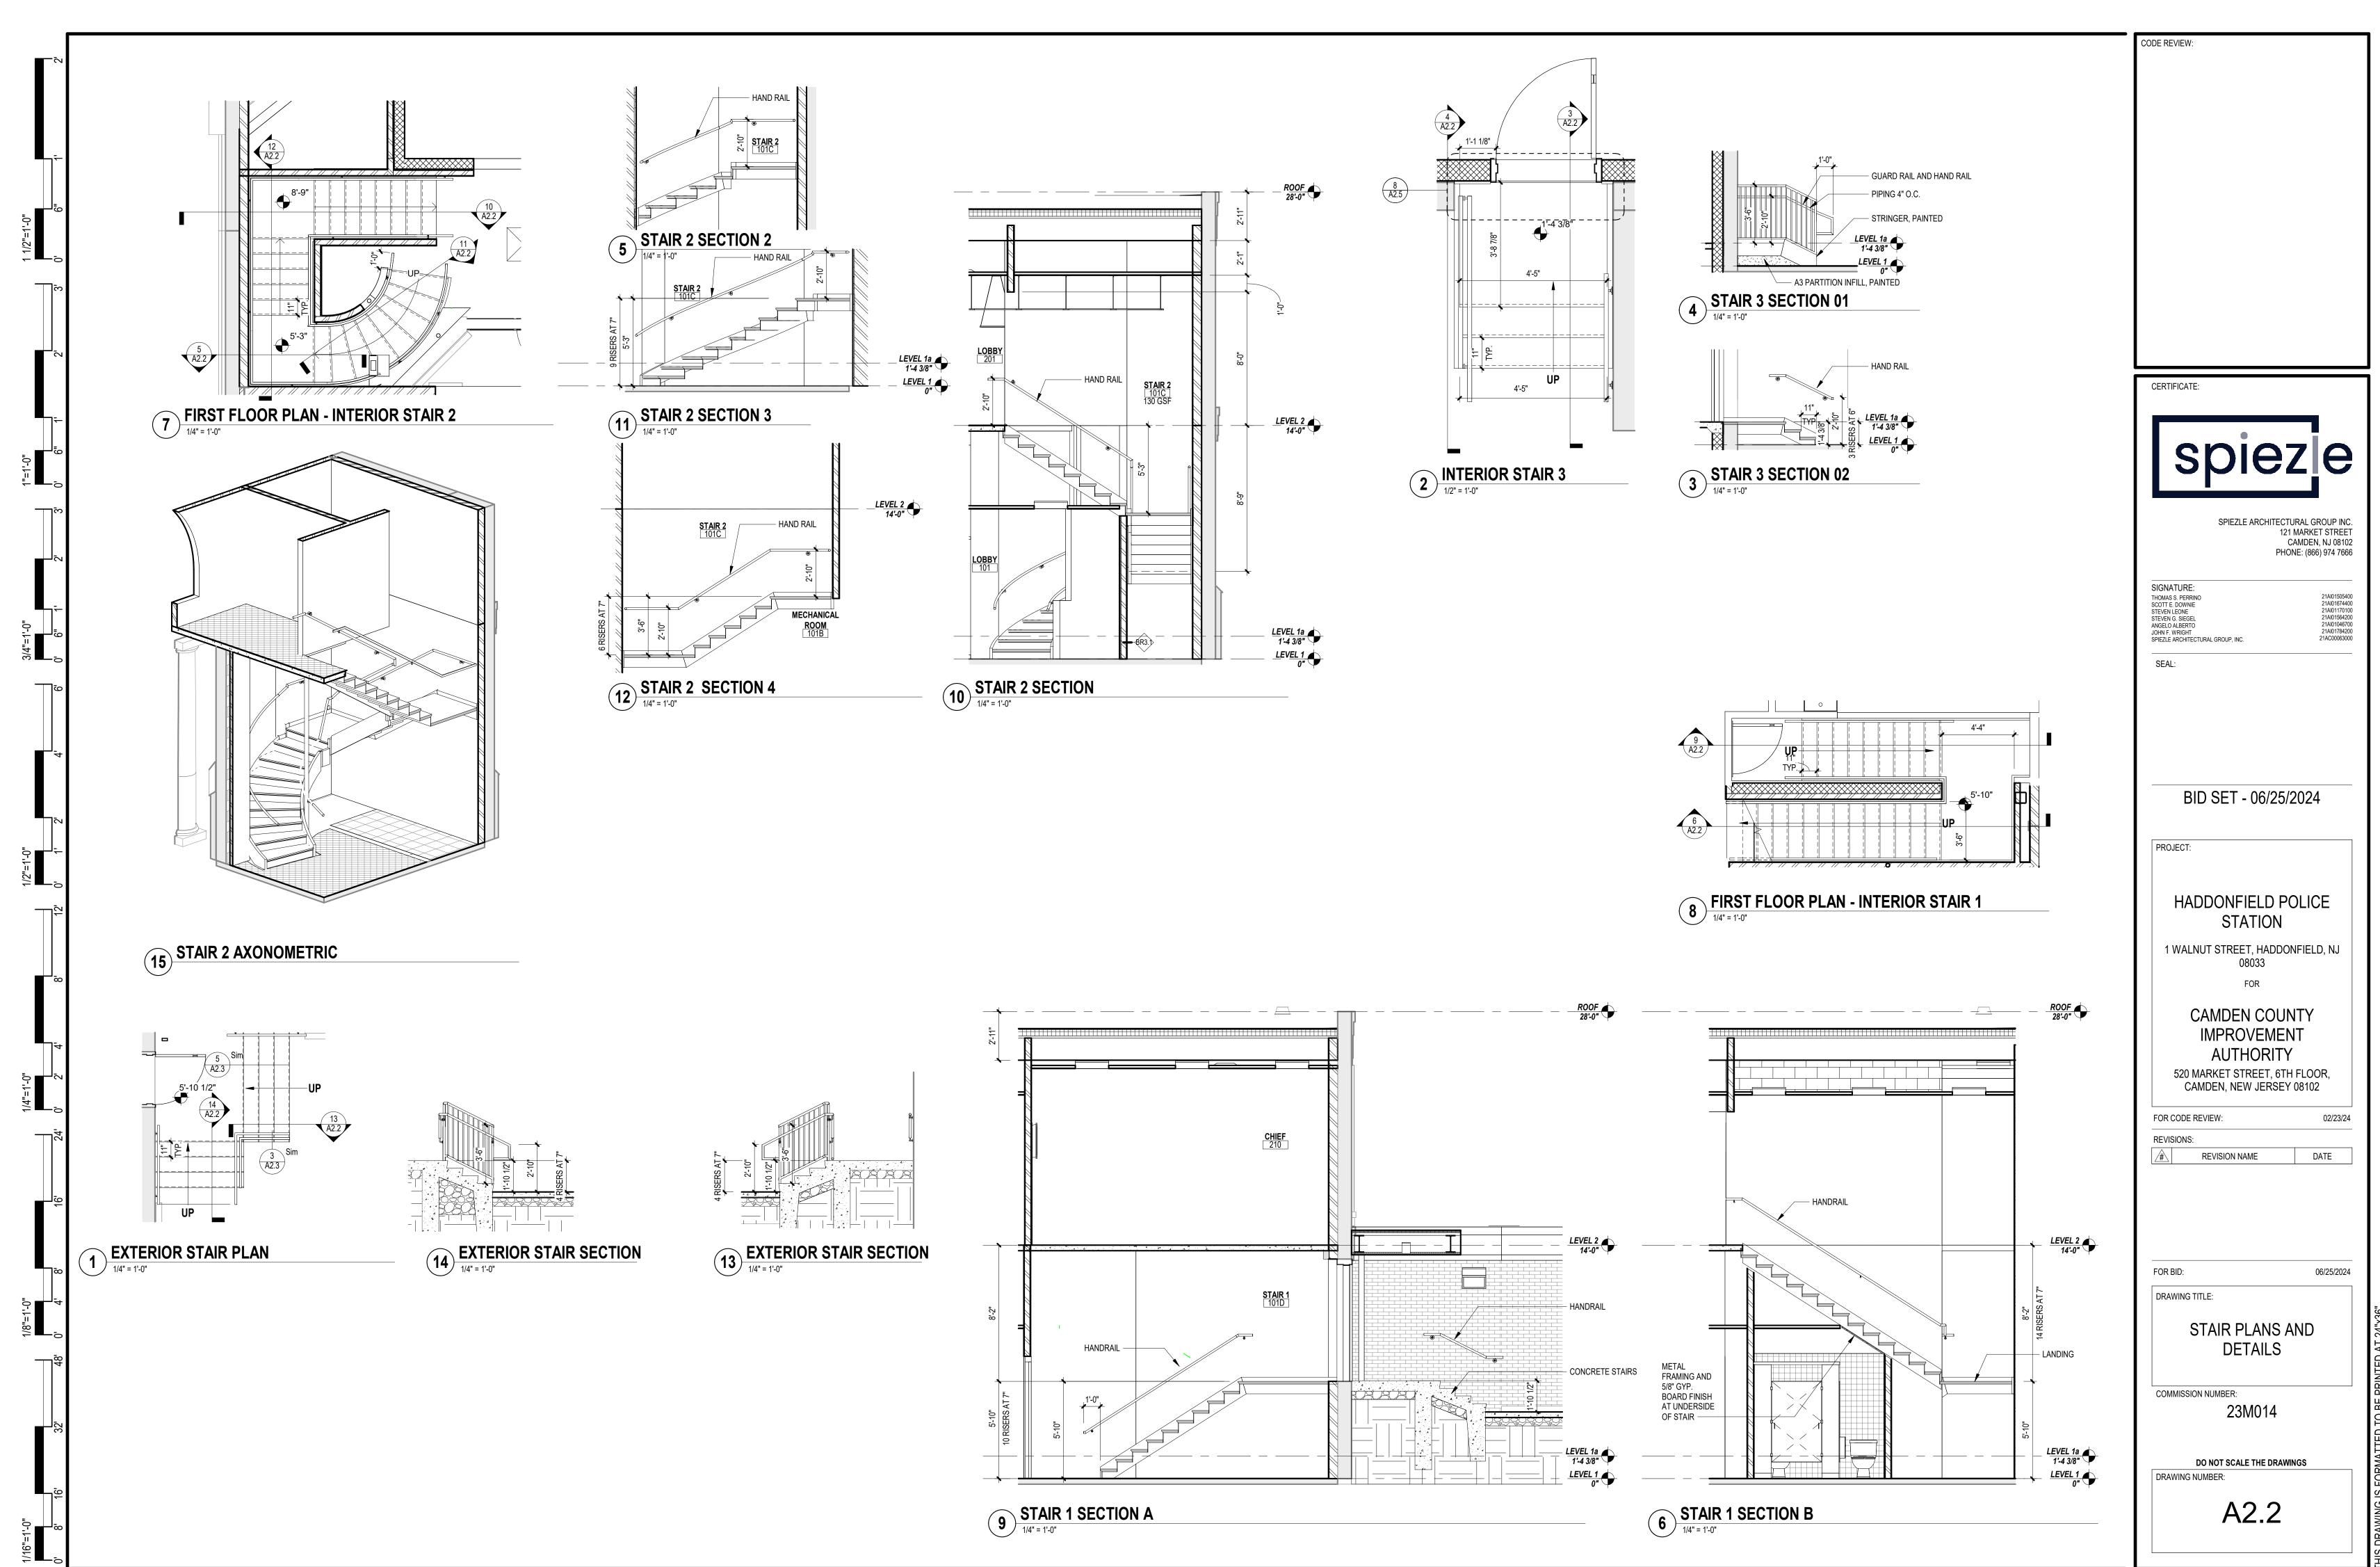
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I	DESCRIPTION	MOU
A-1	SOAP DISPENSER	SURFA
A-2	Bobrick B-2908 2436 Tempered Glass Welded Frame Mirror	WALL N
A-2A	Paper Towel Dispenser with Trash Recepticle	WALL N
A-3	Bobrick B-2892 Classic Series Surface Mounted Twin Jumbo-Roll Toilet Tissue Dispenser	SURFA
A-4	GRAB BARS	SURFA
A-5	Bobrick B-254 Surface Mounted Sanitary Napkin Disposal	SURFA
A-6	18X18 FLOOR MOUNTED LOCKERS	FLOOR
A-7	2'x5' Dressing Mirror	WALL N
A-1		VVAL


3'-6 1/2"


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— 1-1/2" DIA. STEEL POST

(PAINTED)

- 1/2" DIA. STEEL

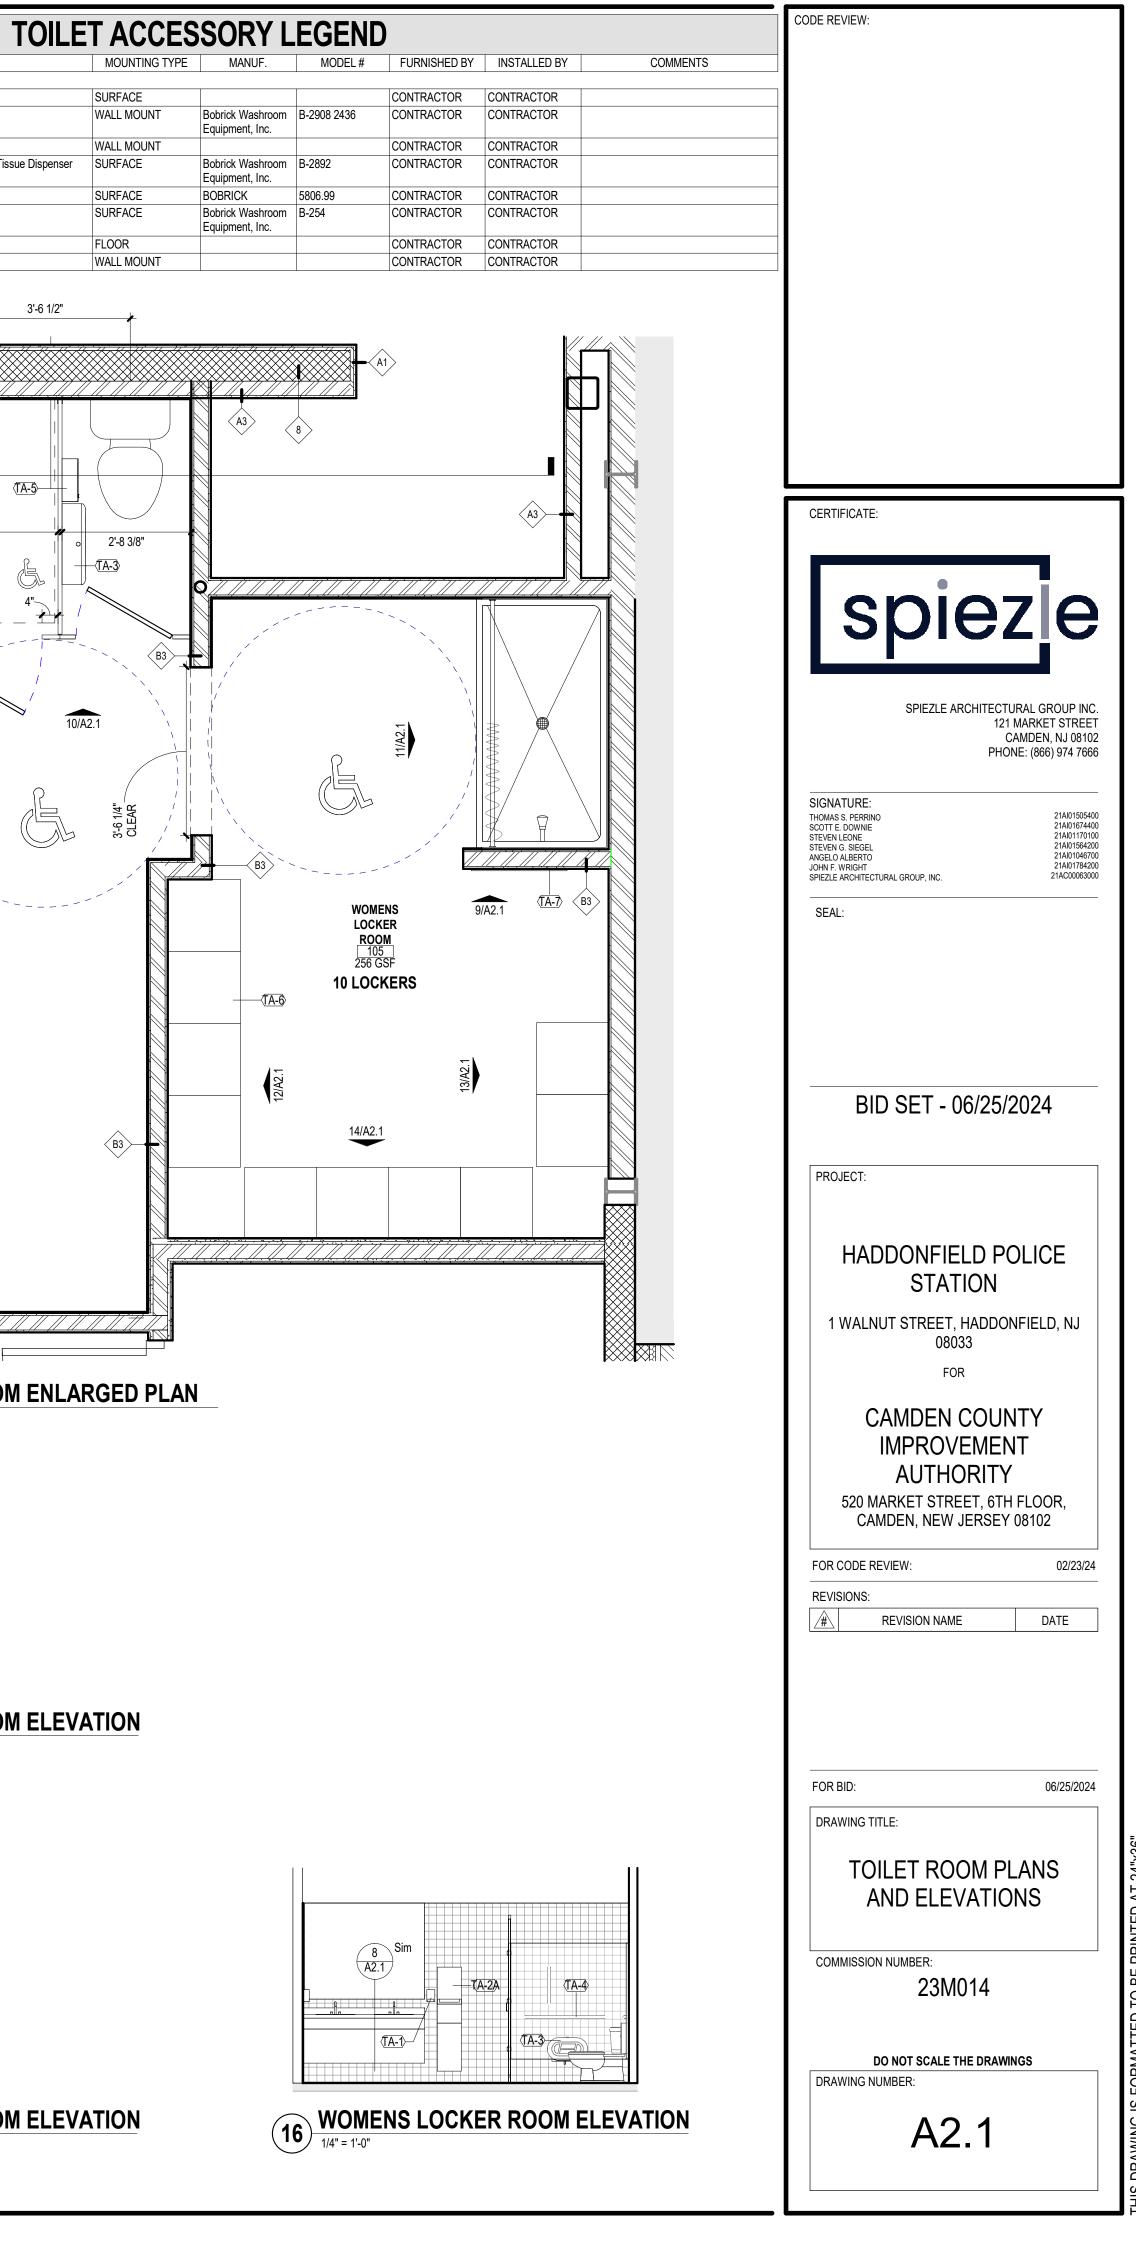PICKETS (PAINTED)

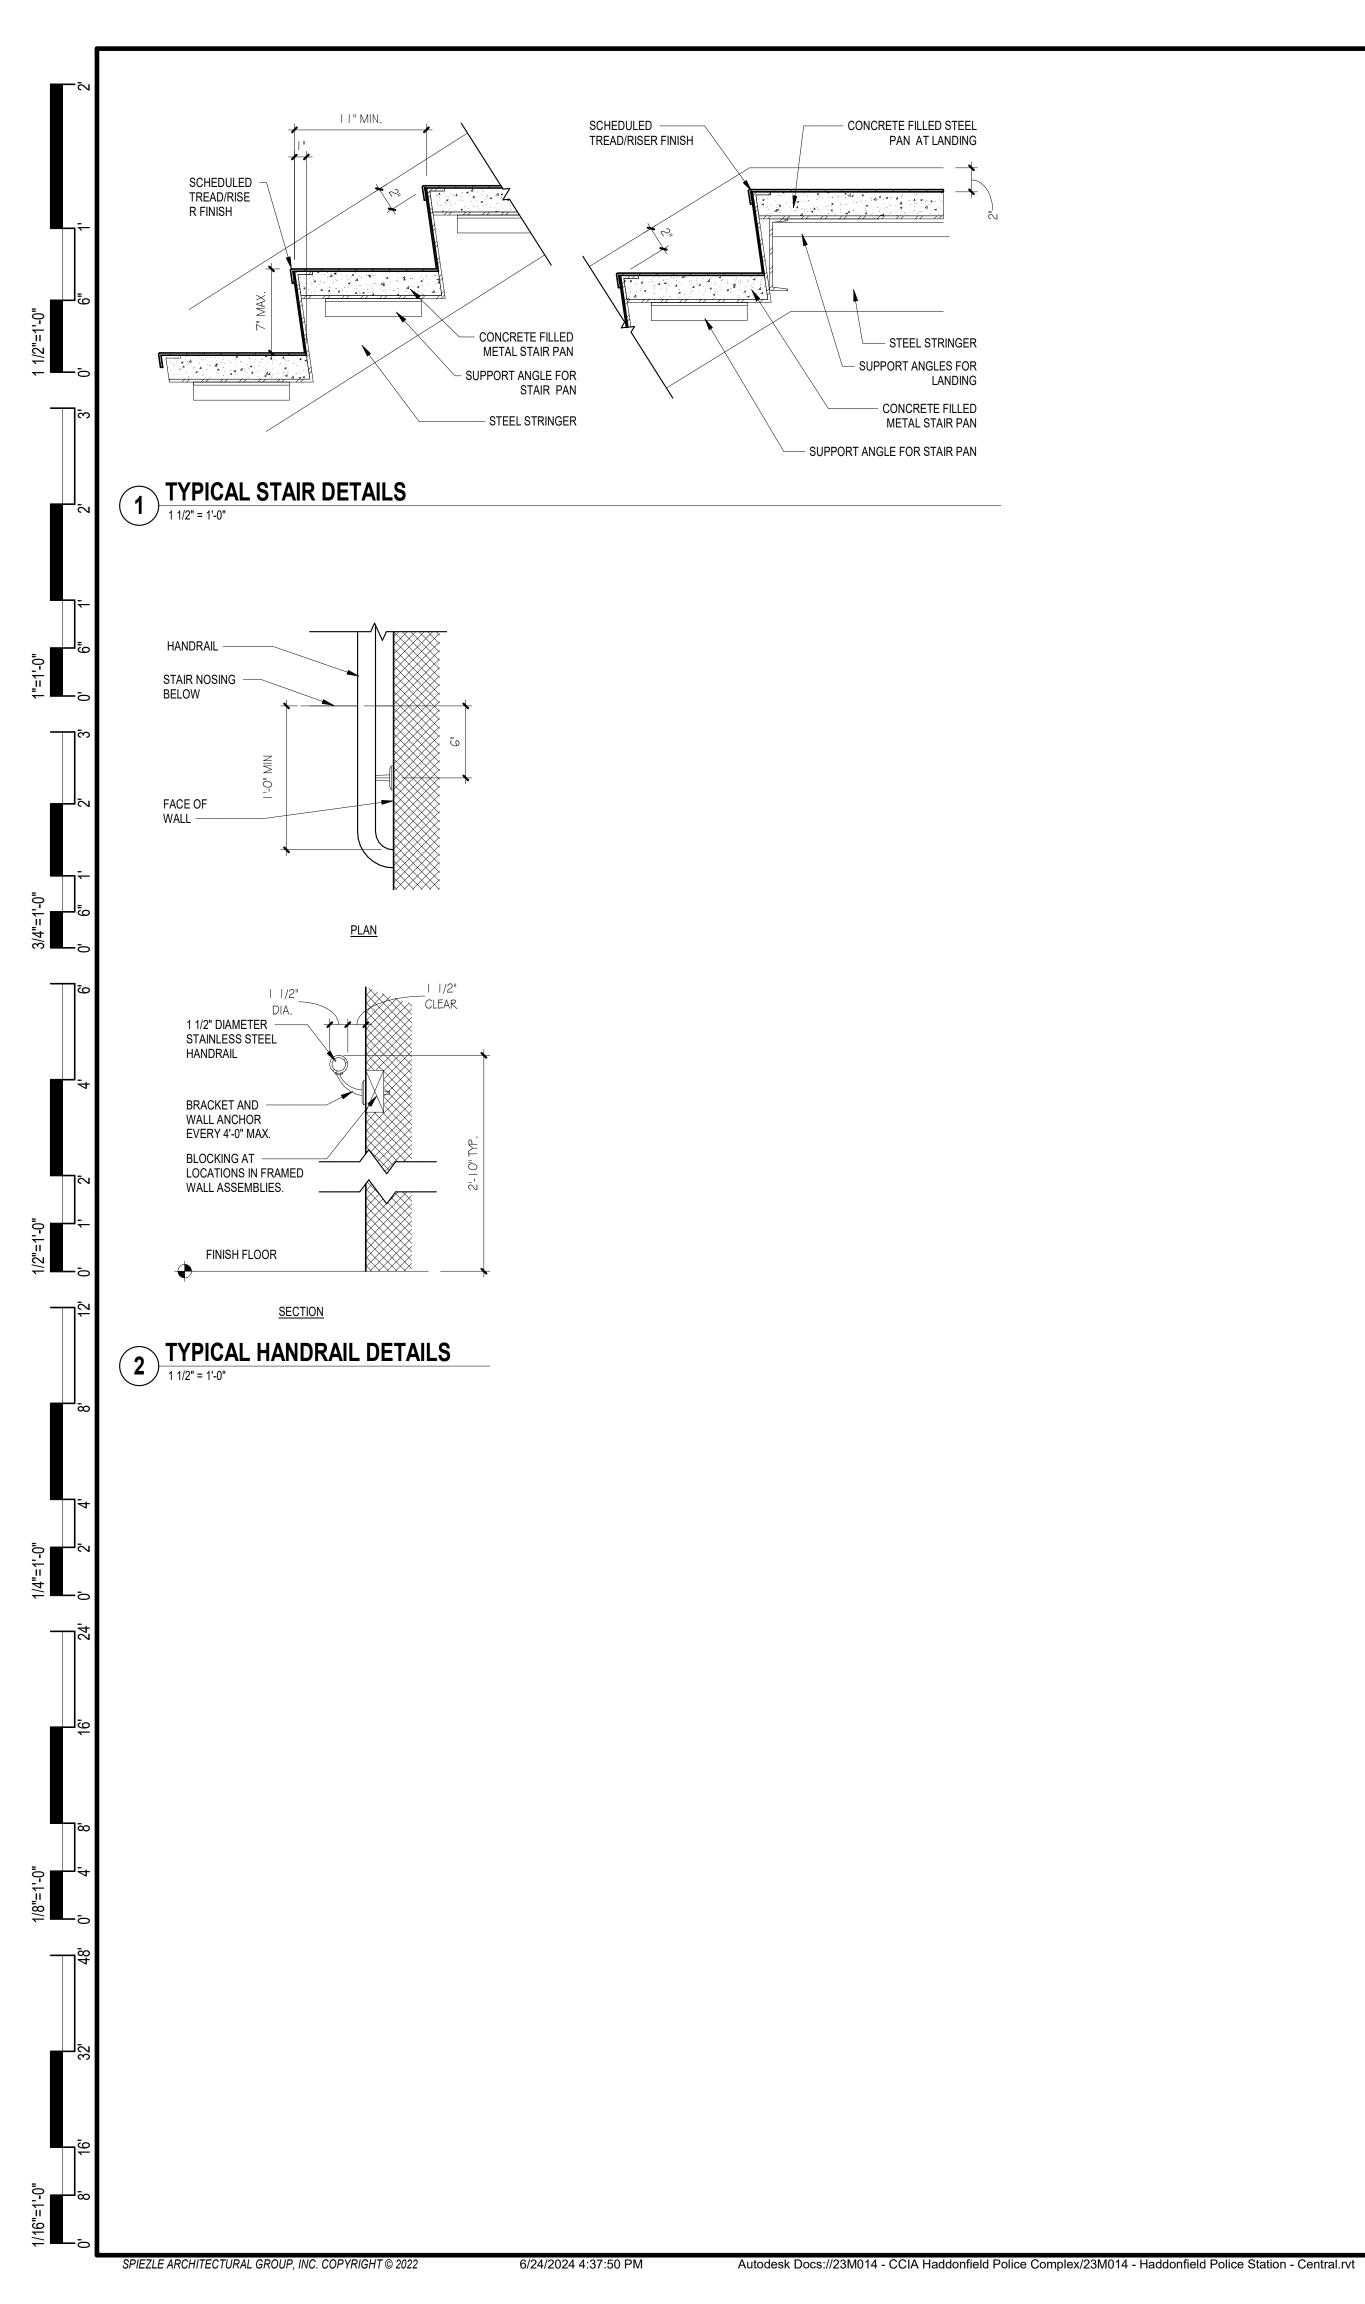SCHEDULED FLOOR FINISH
 OVER CONCRETE LANDING
 OR STRUCT. SLAB

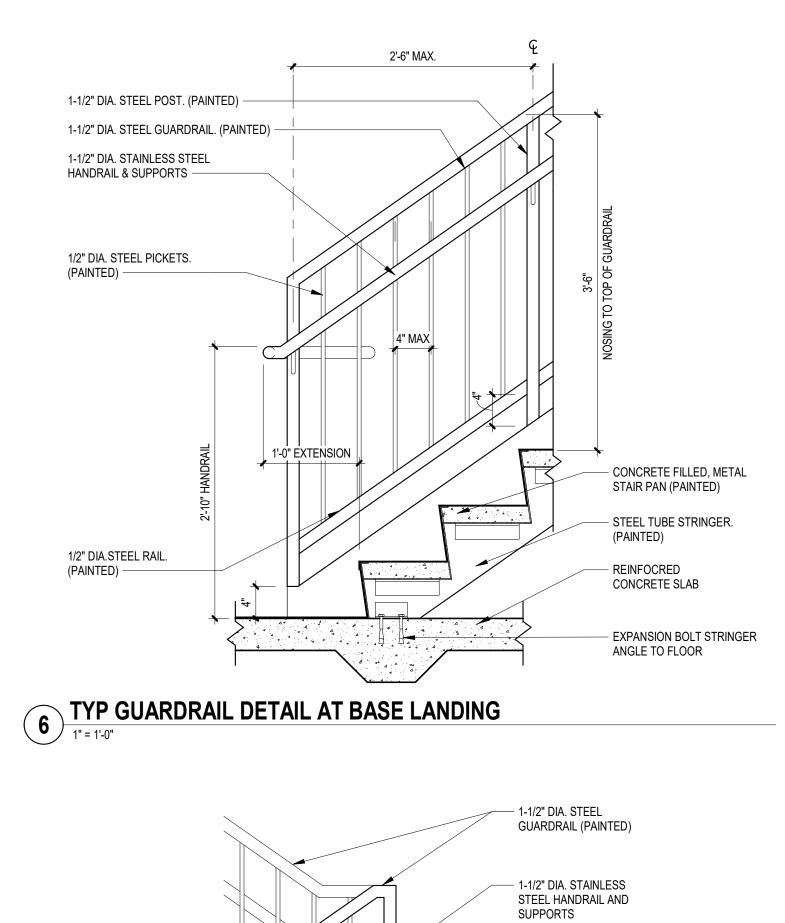



STAIR TREADS BEYOND -

1-1/2" DIA. STEEL RAIL (PAINTED) —————

STEEL STRINGER — BEYOND (PAINTED)

CONCRETE FILLED, METAL STAIR PAN (PAINTED) ———

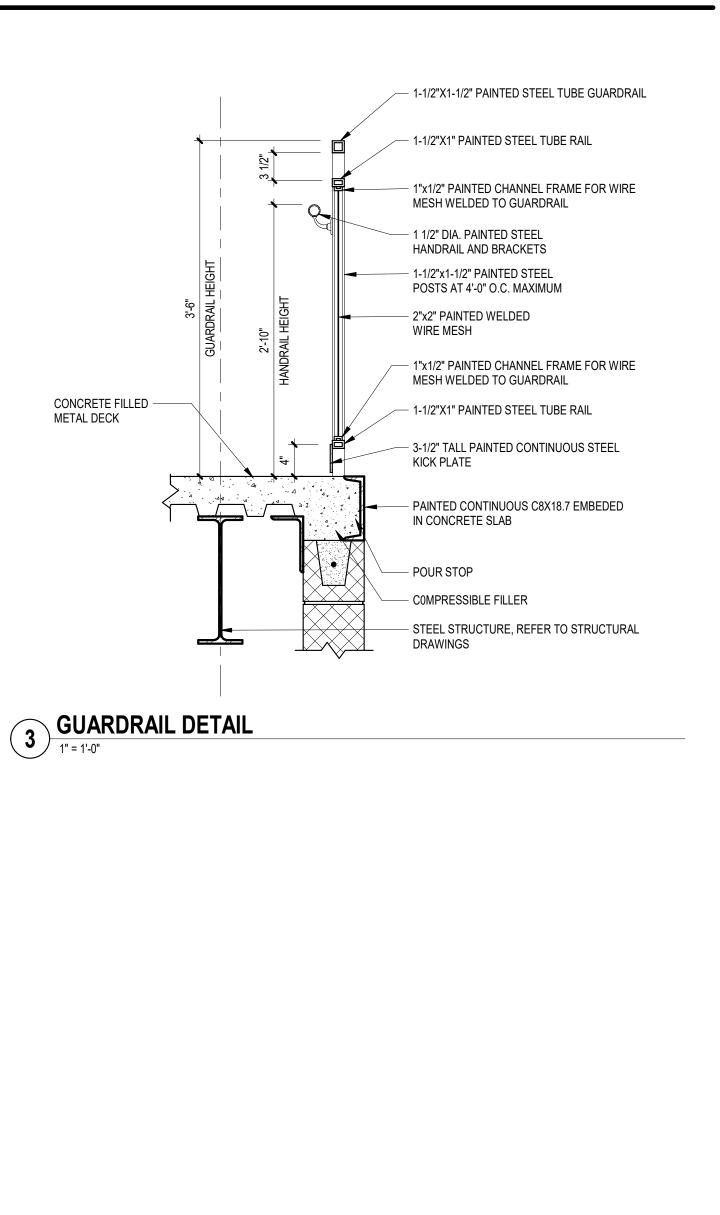


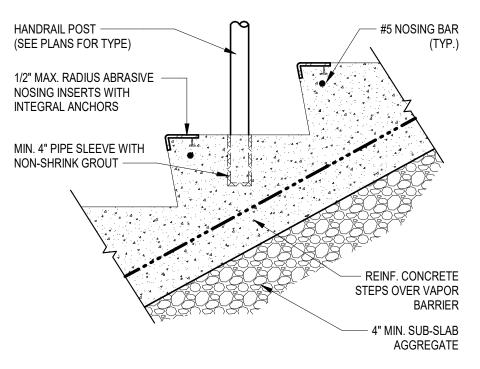


5 E -EXTERIOR STAIR TREAD DETAIL

CERTIFICATE:
spiezle
SPIEZLE ARCHITECTURAL GROUP INC. 121 MARKET STREET CAMDEN, NJ 08102 PHONE: (866) 974 7666
SIGNATURE:           THOMAS S. PERRINO         21AI01505400           SCOTT E. DOWNIE         21AI01674400           STEVEN LEONE         21AI01170100           STEVEN G. SIEGEL         21AI01564200
STEVEN G. SIEGEL 21401554200 ANGELO ALBERTO 21401046700 JOHN F. WRIGHT 21401784200 SPIEZLE ARCHITECTURAL GROUP, INC. 21AC00063000 
BID SET - 06/25/2024
PROJECT:
HADDONFIELD POLICE STATION
1 WALNUT STREET, HADDONFIELD, NJ 08033
IMPROVEMENT AUTHORITY 520 MARKET STREET, 6TH FLOOR,
CAMDEN, NEW JERSEY 08102 FOR CODE REVIEW: 02/23/24
REVISIONS:
FOR BID: 06/25/2024
DRAWING TITLE:
23M014
DO NOT SCALE THE DRAWINGS DRAWING NUMBER:
A2.3


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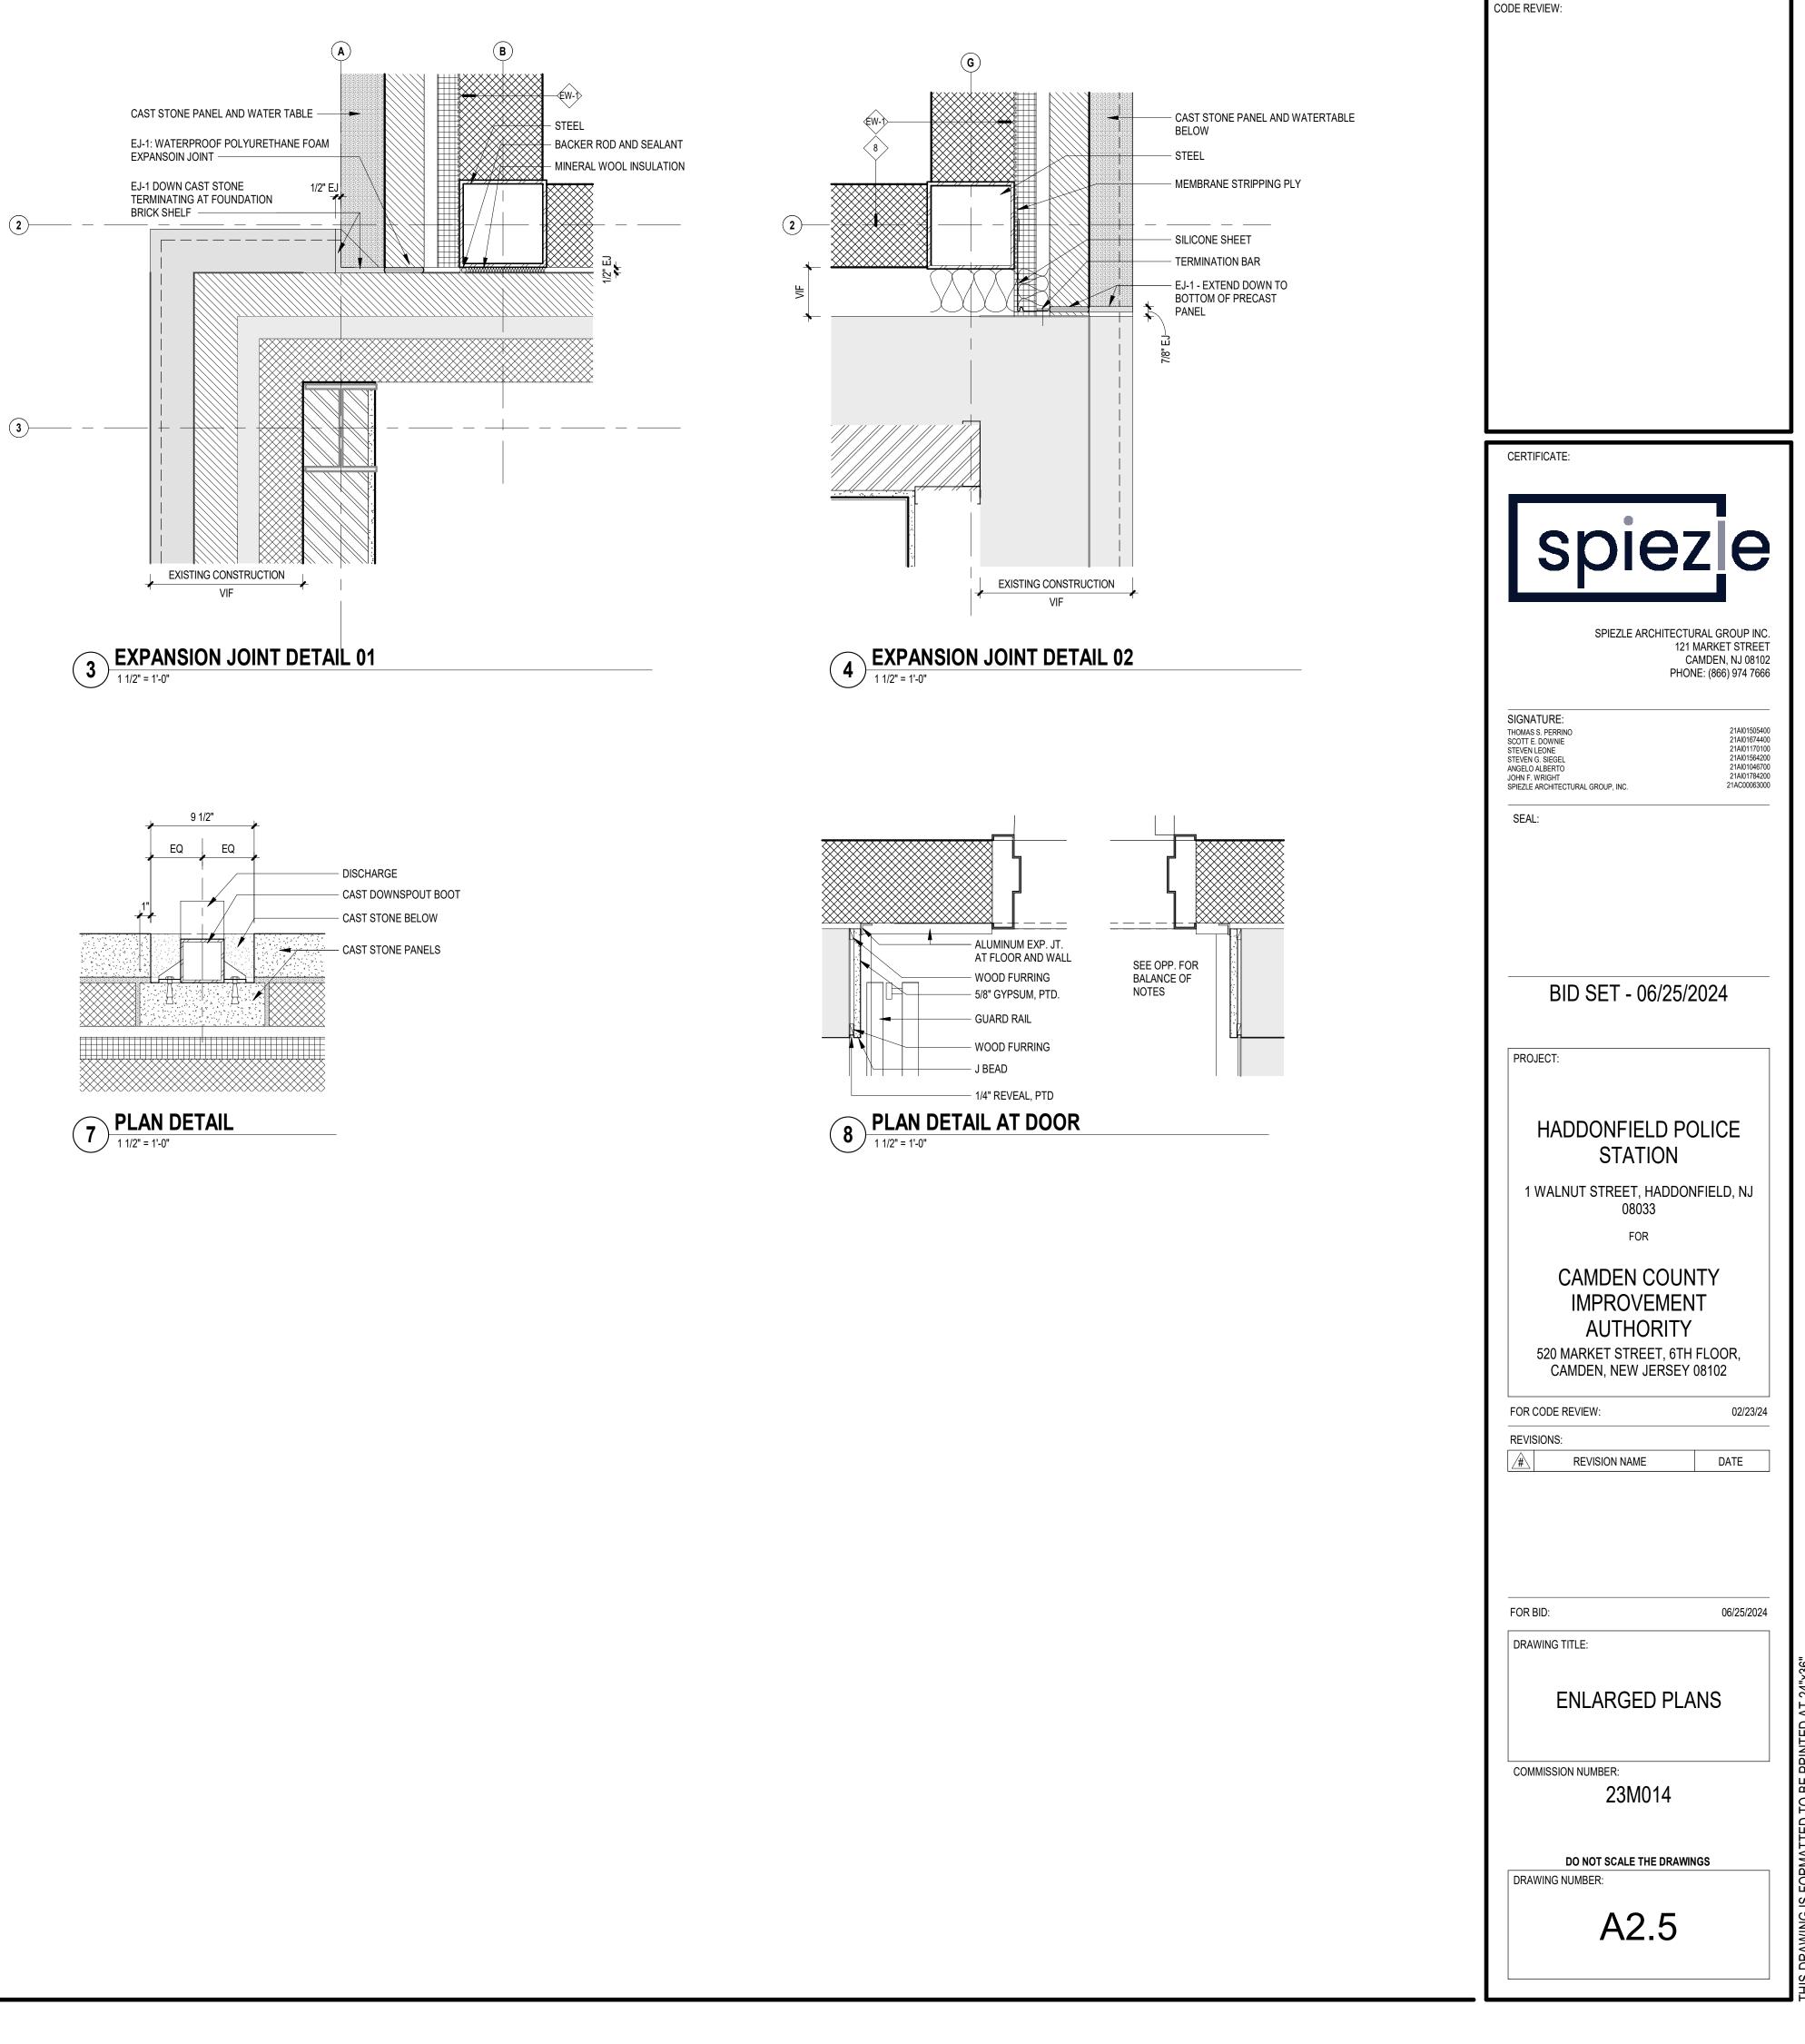


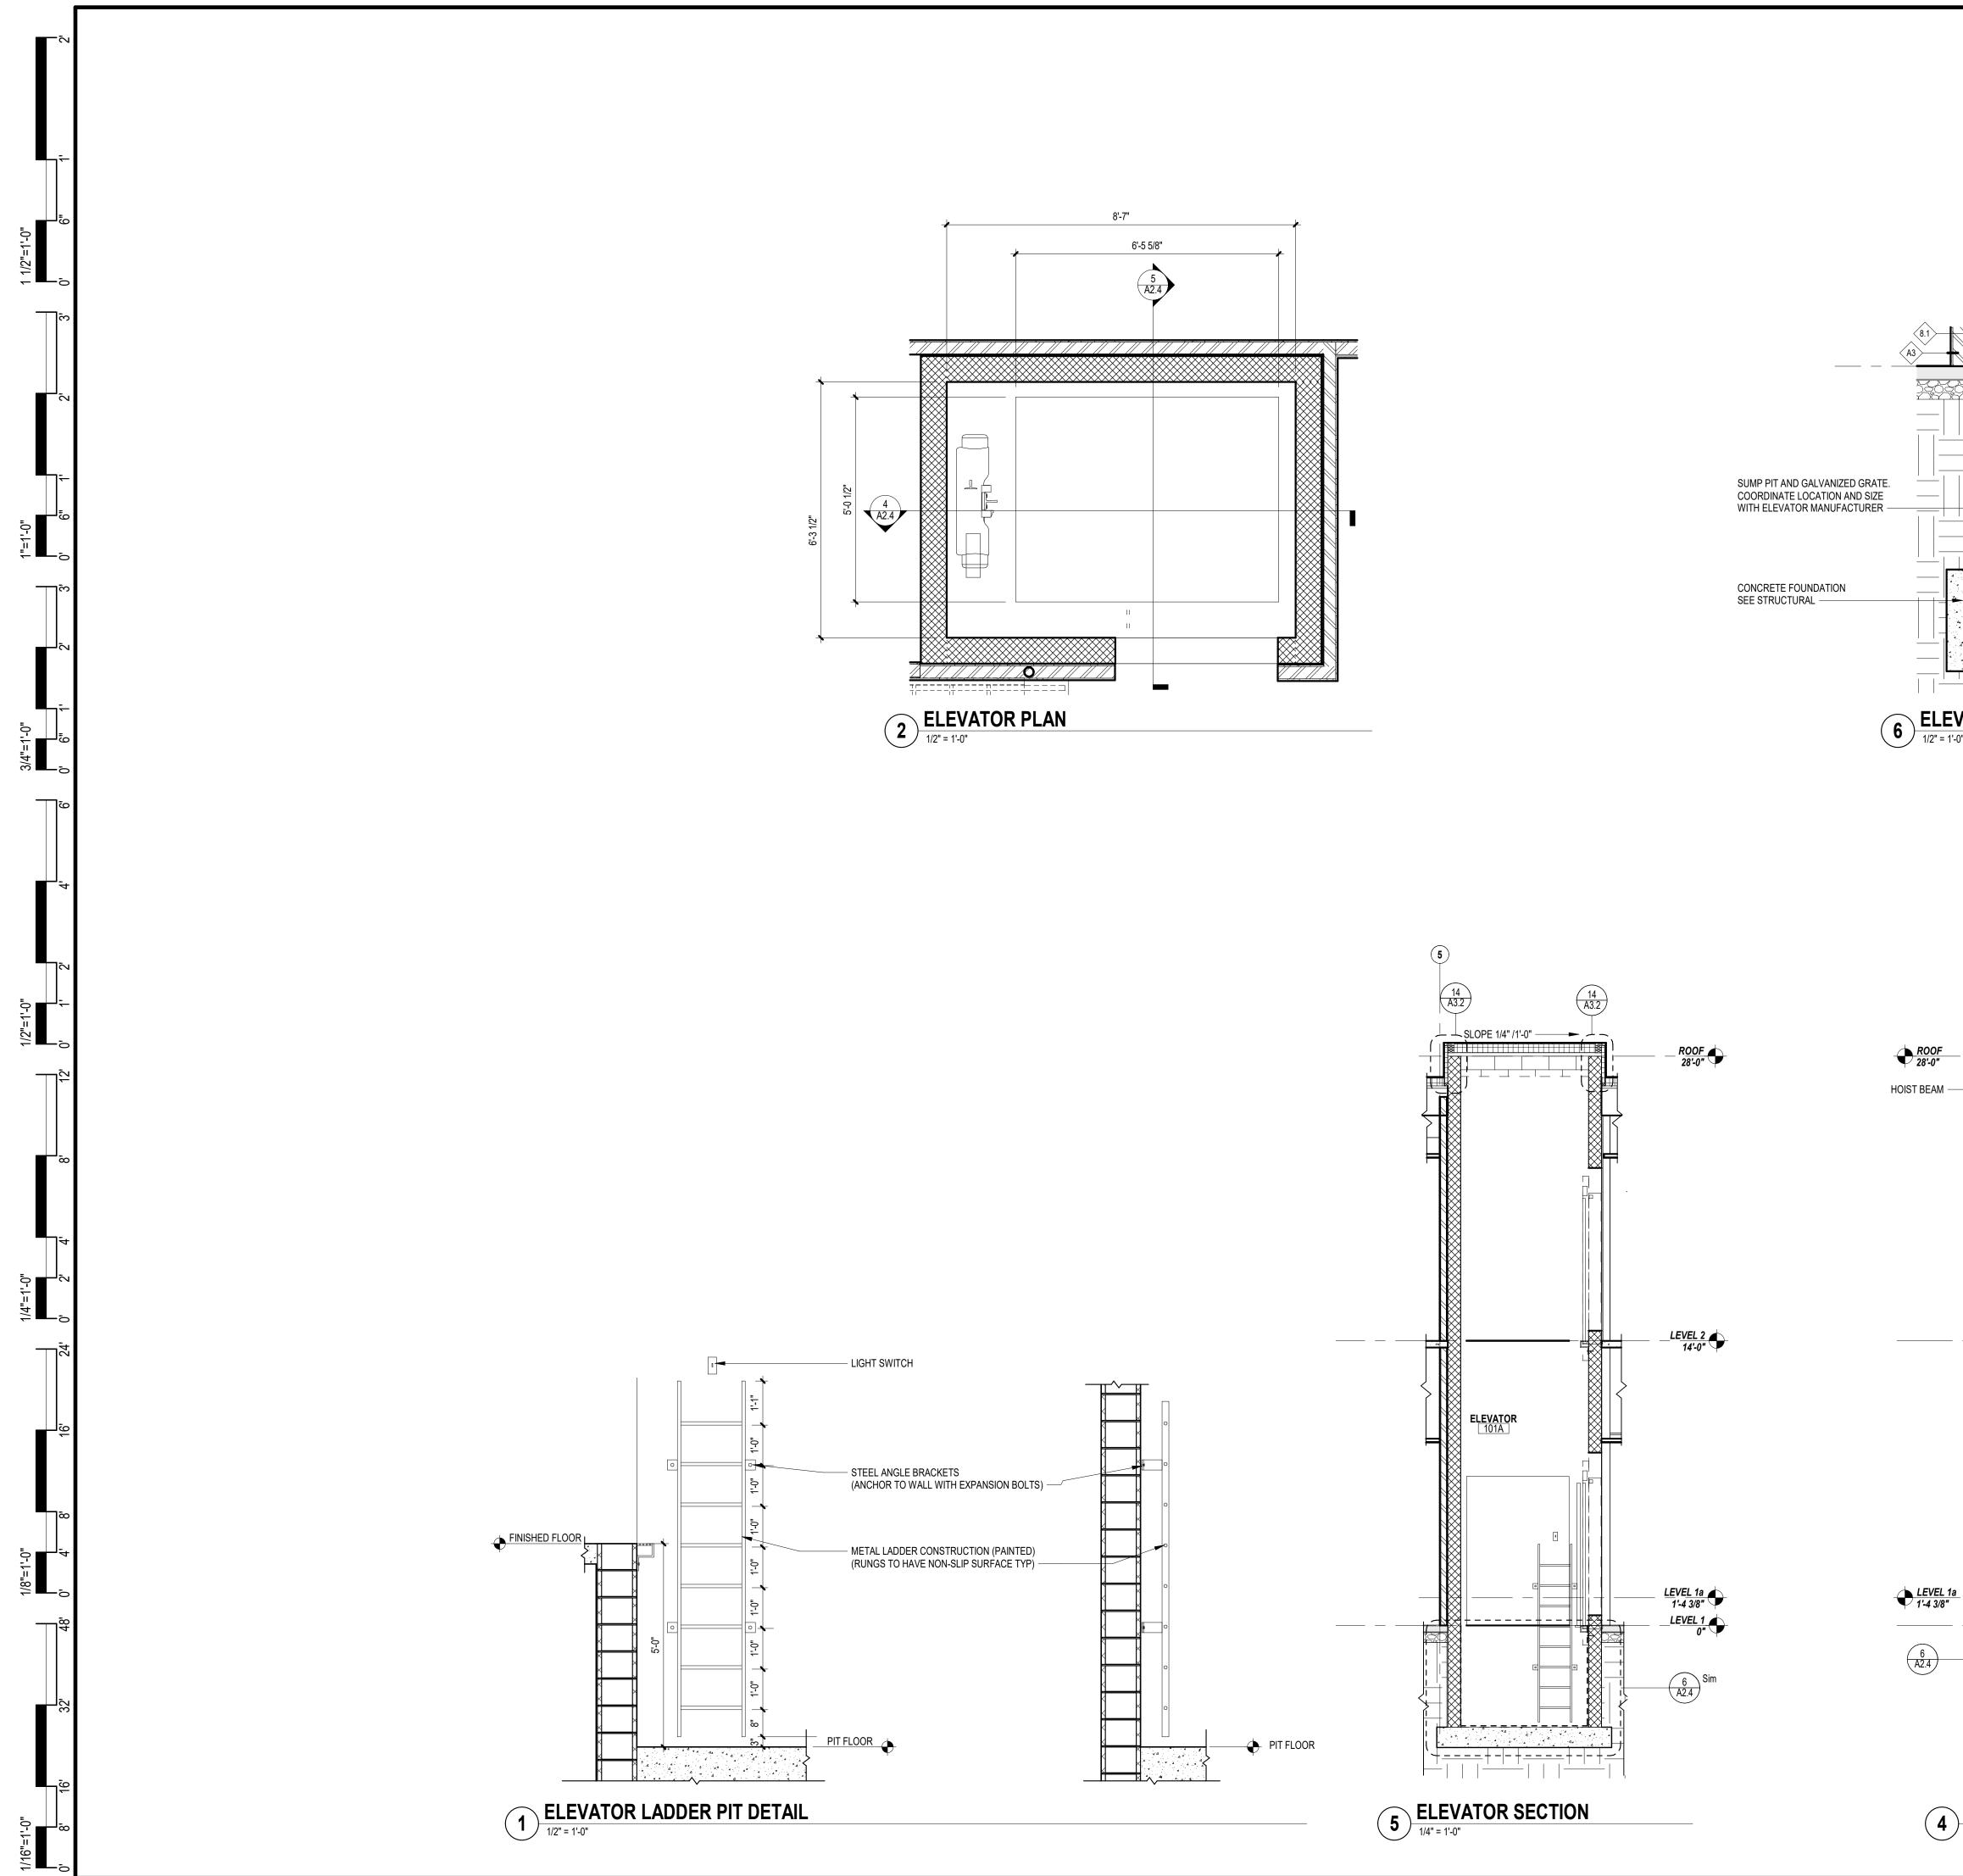


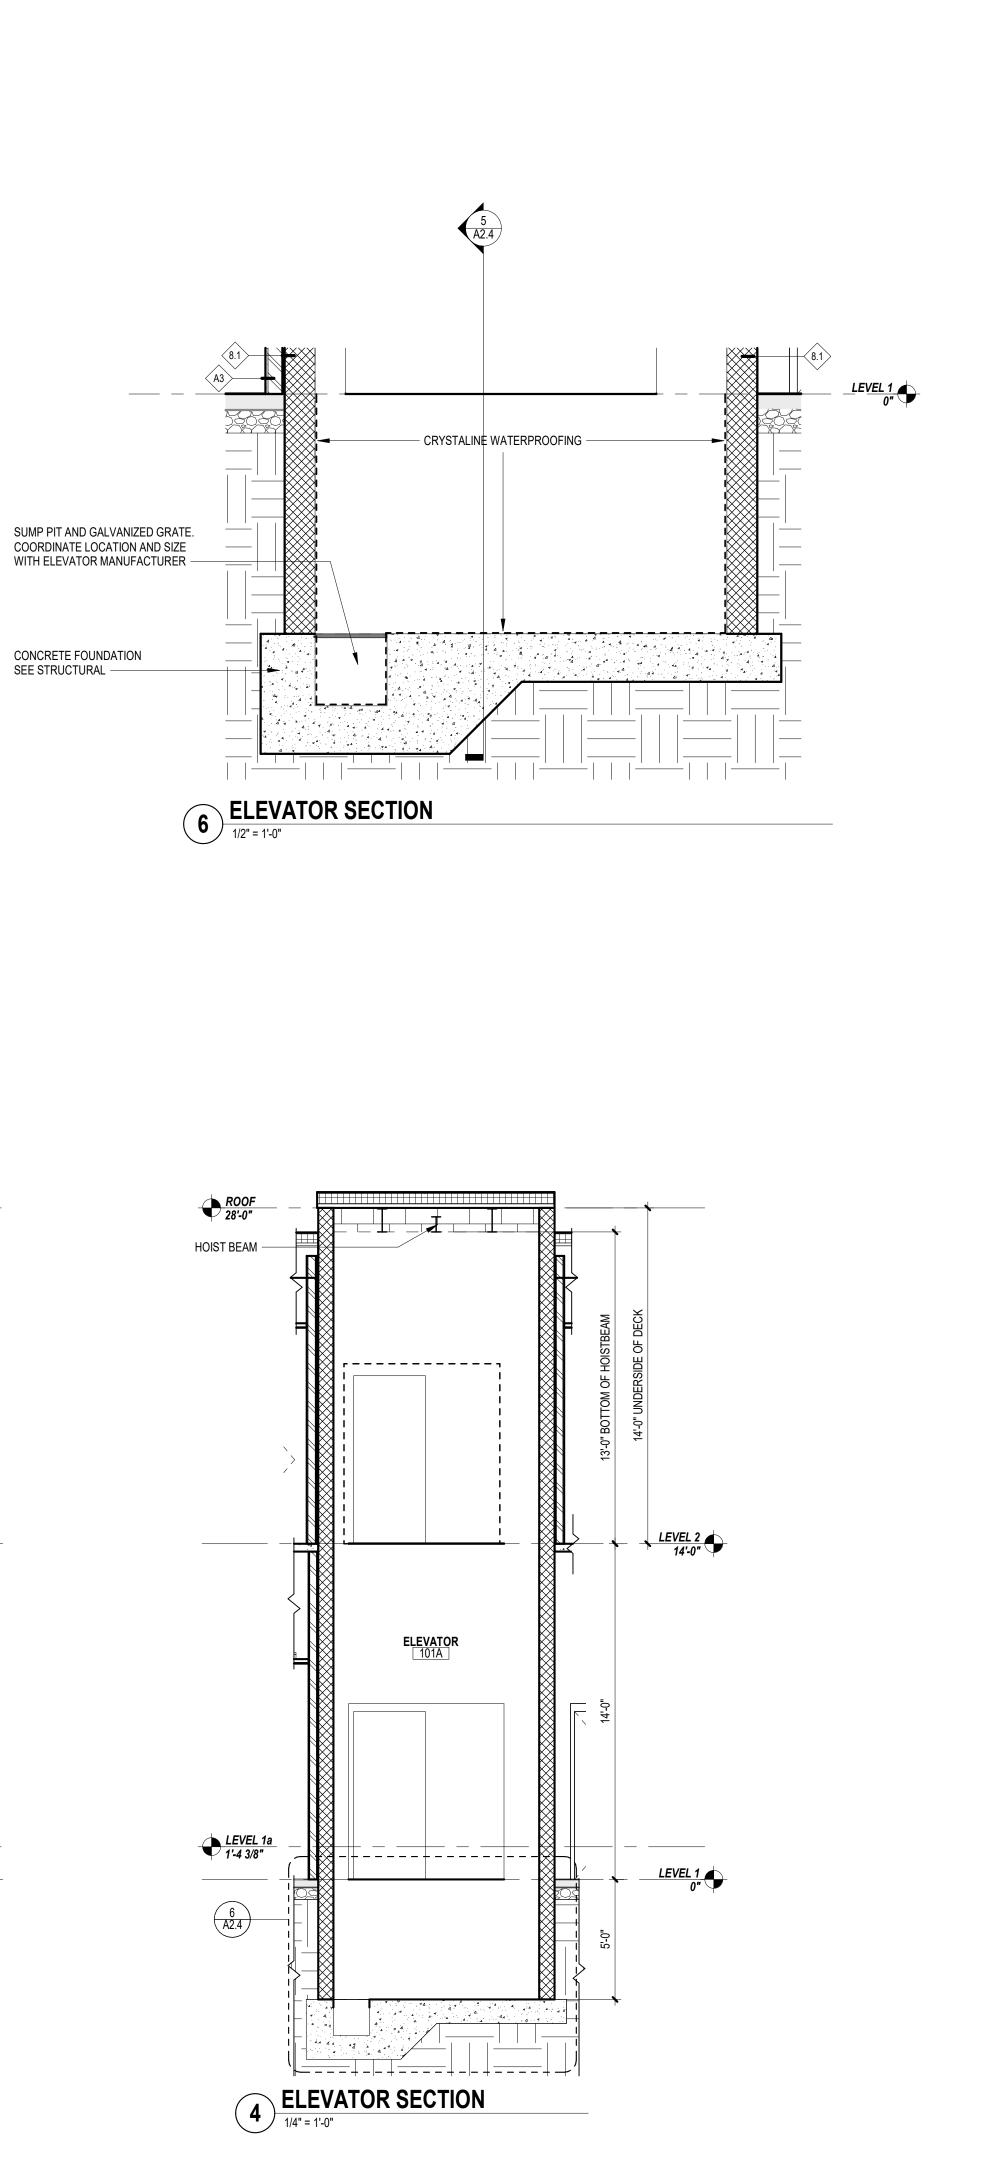
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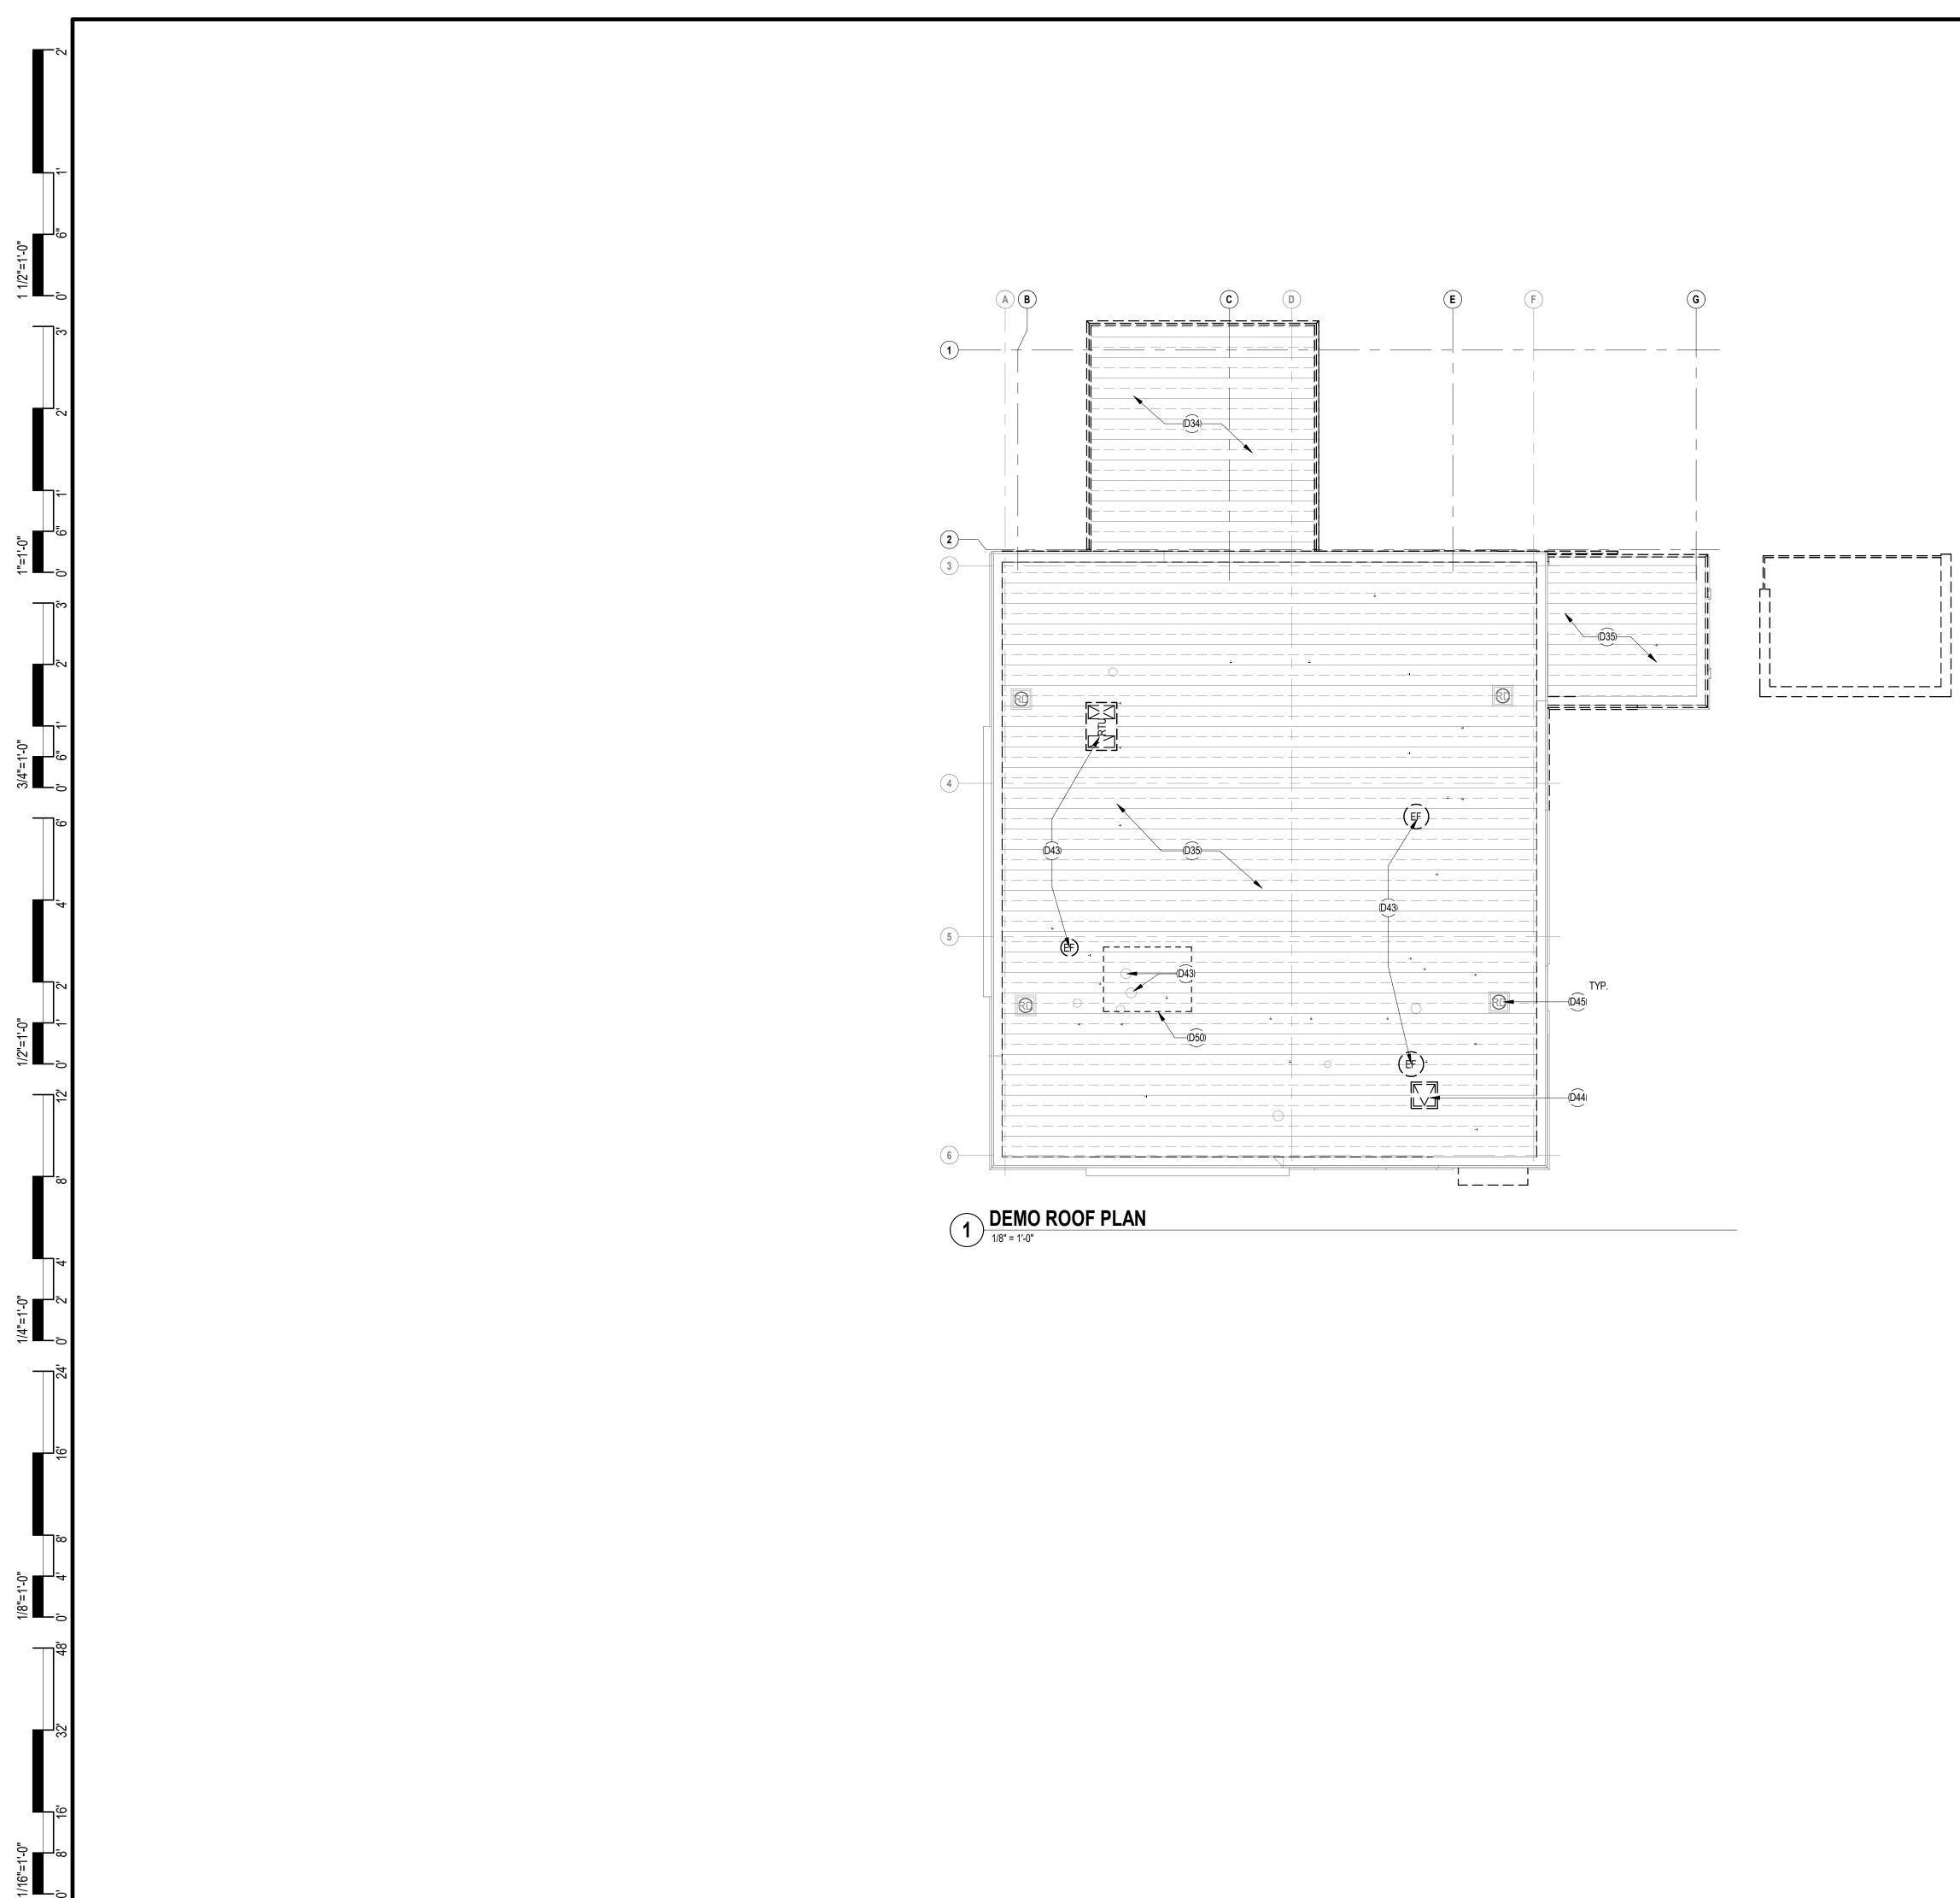
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SPIEZLE ARCHITECTU	
C	MARKET STREET AMDEN, NJ 08102 NE: (866) 974 7666
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SCOTT E. DOWNIE STEVEN LEONE STEVEN G. SIEGEL ANGELO ALBERTO JOHN F. WRIGHT	21Al01674400 21Al01170100 21Al01564200 21Al01046700 21Al01784200
SPIEZLE ARCHITECTURAL GROUP, INCSEAL:	21AC00063000
BID SET - 06/25/2	2024
PROJECT:	
HADDONFIELD PO	DLICE
STATION 1 WALNUT STREET, HADDOI	NFIFI D. NJ
08033 FOR	
CAMDEN COUN	ITY
IMPROVEMEN AUTHORITY	
520 MARKET STREET, 6TH CAMDEN, NEW JERSEY	FLOOR,
FOR CODE REVIEW:	02/23/24
REVISIONS:	DATE
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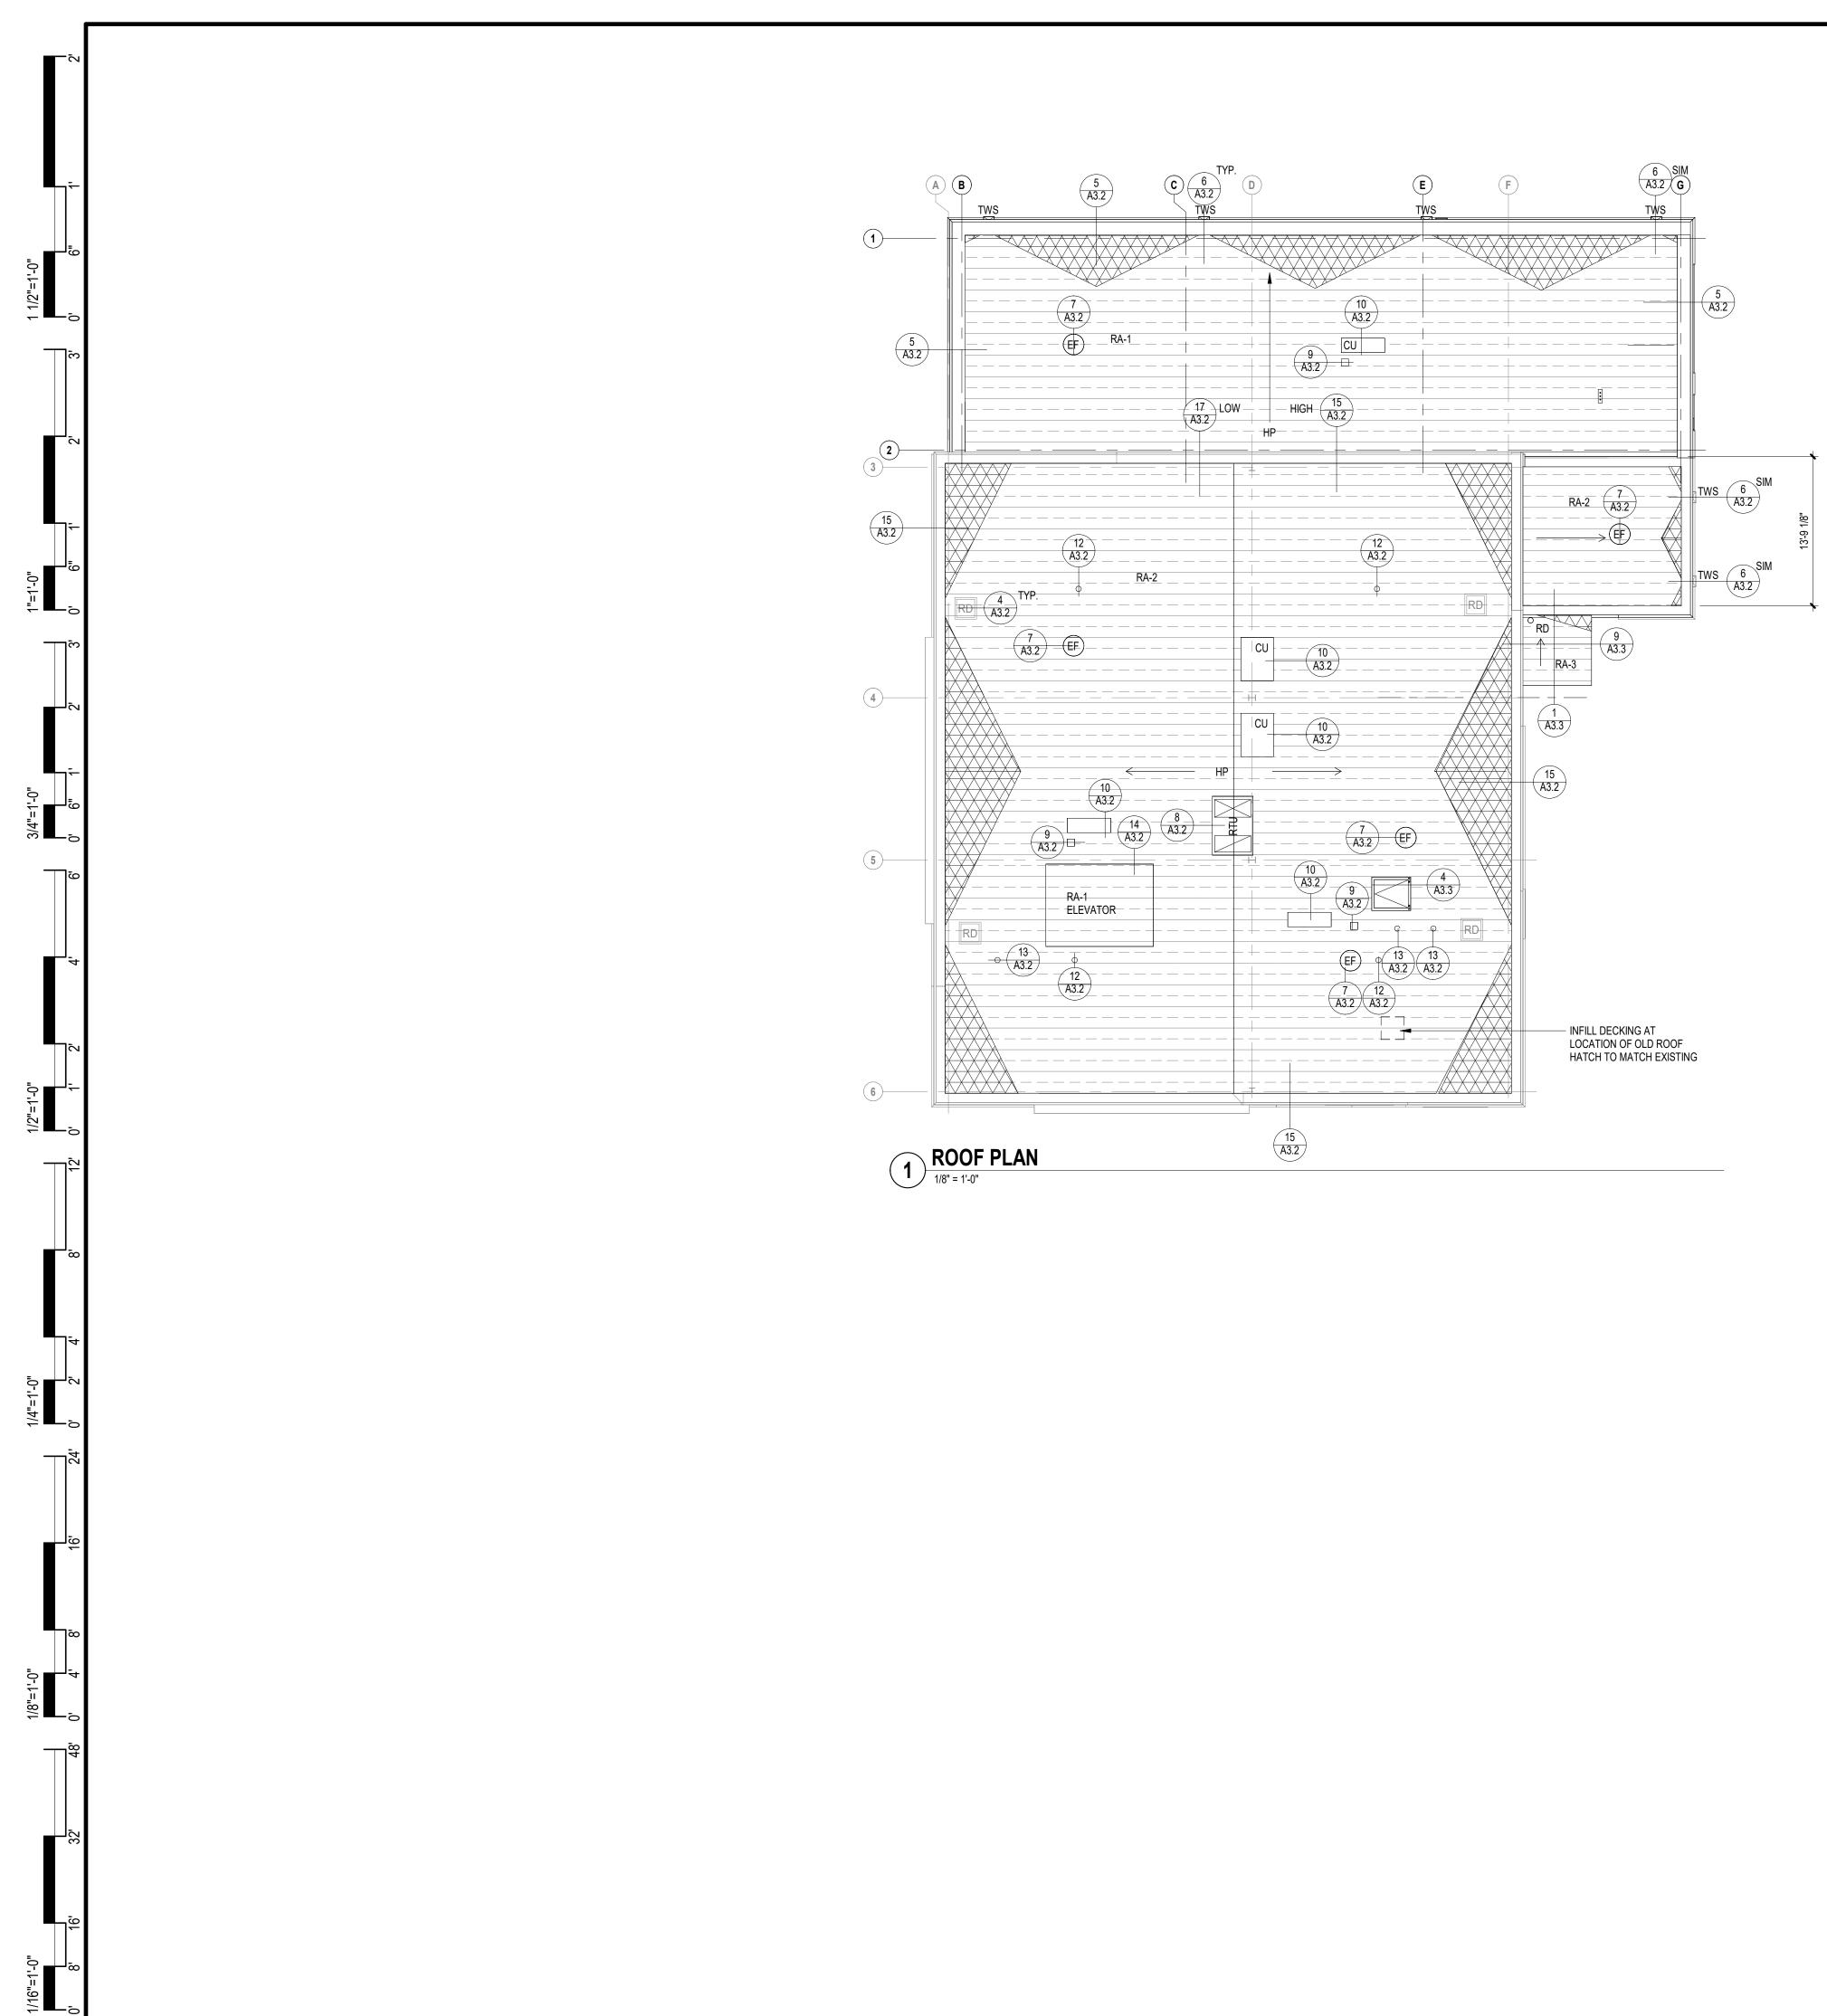




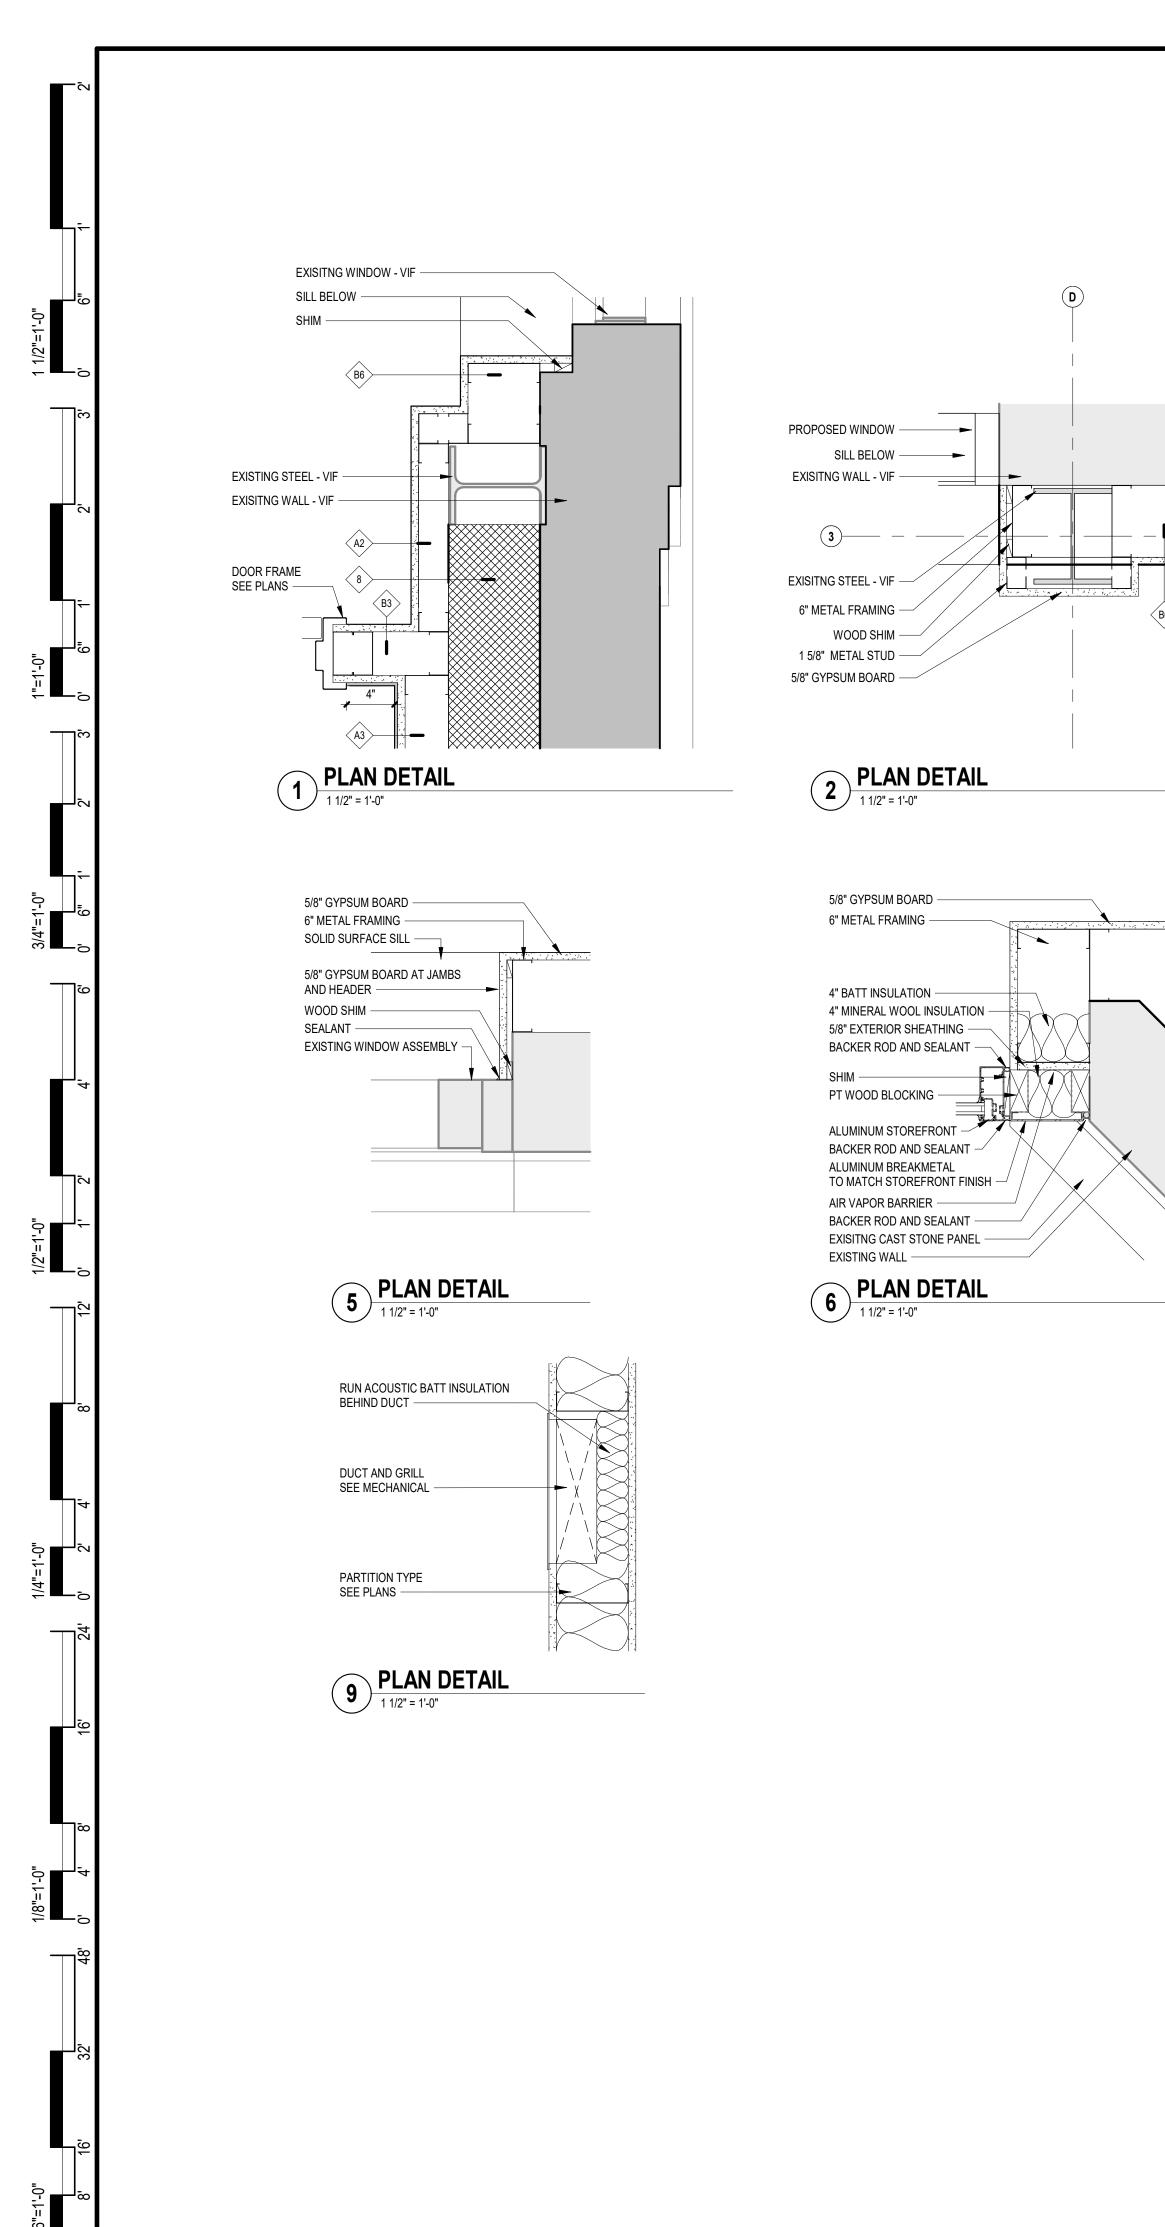

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HEREWITH, AS COORDINATED WITH WORK OF ALL OTHER TRADES, AS INDICATED           LESEMINER, AND AS REQUIRED TO ACCOMMONDATE CONSTRUCTION ALL DEMOLITION REQUIRED SHALL BE INCLUEDE IN EACH CONTRACTORS BASE BD TO PERFORM AND COMPLETE CONSTRUCTION. UNLESS OTHERWISE INDICATED.           2. ALL TENS DESIGNATED AS SALVAGED SHALL BE PROTECTED AND TUNNED OVER TO THE OWNER.           3. TERM TO BE RELOCATED OR REINSTALED SHALL BE AS INDICATED. SPECIAL CARE SHALL BETAREN SOA SNOT DUAKES OTHERWISE INES AT BE CONTRACTOR SHALL COORDINATE IN STORAGE OF ALL SALVAGED TENS THE CONTRACTOR SHALL COORDINATE IN STORAGE OF ALL SALVAGED TENS THE CONTRACTOR SHALL COORDINATE IN STORAGE OF ALL SALVAGED TENS AS SHOWN ON THE ORAWING A GREATER SOA SNOT DE OWNER SALVAGED TENS AS SHOWN ON THE ORAWING A GREATER SOA SNOT DE CONTRACTOR SHALL DEL SALVAGED THER AS SHOWN ON THE ORAWING A GREATER SOA SNOT DE CONTRACTOR SHALL DEL SALVAGED THE AS SHOWN ON THE ORAWING A GREATER STARLEY REMOVED TO THE SALVAGED THE SALVAGED THE SALVAGED SUBJICITUDE SHALL ALL DERESSIONS, INDENTATIONS, OR ROTRUSIONS LEFT AFTER BEMOVILD AND CENTRING SUBSTICHTIFE REMOVED AND CAPPED BEININ THE SUBRACES TO REMAIN ALL DERESSIONS, INDENTATIONS, OR ROTRUSIONS SHOLL OLESTINGS ON DEISONG DE DESTING GUARDATE DE SALVAGED SOUTITIES THE REMOVED AND EXISTING SUBSTICT AND ALL DOTTION SHALL SO SOUTITIES TORAGE ARE INCLUED ALL ELECTRICAL SALVAGED TO THE ORAWING ANY OTHER BETWEN NEW AND EXISTING SUBACALL TO THE IN HERE CONTRACTORS SHALL SECTOR SHALL DET THE SALVAGED TO SUBJIC SOUTING AND FRANING AND SHOLL OLECTIONS ON DELESCHARES AND DAVEL SHALL SO STRUCTURAL ELECTRICAL SALVAGED DID REMOVE CONSTRUCTION TO MATCH ADJUGGED COMPANY WALL, PARTITION, OR ANY OTHER LEBERANICAL SALVES TO REMOVE AND TRACTOR SHALL NOTH THE ACCHTECT AND REMOVE PORTION OF EXISTING SHOLT CONSTRUMENTS IN THE REMOVE DISTING CONTRET SHALL DESTING SALVAGED DID REMOVE CONTING DOOR FRAME AND HARDWARE IN THE ENTIRETY. DR REMOVE ED	zje
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2. ALL TEMS DESIGNATED AS 'SALVAGED'SHALL BE PARTICE/TED AND TURNED OVER TO THE OWNER.         3. ITEMS TO BE RELOCATED OR REINSTALLED SHALL BE AS INDICATED, SPECIAL CARE SHALL BE TAKEN SO AS INTO DAMAGE THESE TEMS. THE CONTRACTOR SHALL COORDINATE THE STORAGE OF ALL SALVAGED ITEMS TO BE ETHER RELOCATED OR REINSTALLED WITH THE OWNER.         4. LOCATIONS ANDOR ELEVATIONS OF EXISTING ITEMS AS SHOWN ON THE DRAWINGS ARE APPROXIMATE RESPONSED LEVATIONS OF EXISTING ITEMS AS SHOWN ON THE DRAWINGS ARE APPROXIMATE RESPONSED LEVATIONS OF EXISTING ITEMS AS SHOWN ON THE DRAWINGS ARE APPROXIMATE RESPONSED LEVATIONS OF RUCOR ASSEMBLY IS INDICATED WHERE AN EVENTIME WALL, CELLING, ROOF OR FLOOR ASSEMBLY IS INDICATED WHERE AN EVENTIME WALL, CELLING, ROOF OR PLOOR ASSEMBLY IS INDICATED WHERE AN EVENTIME WALL, CELLING, ROOF OR PLOOR ASSEMBLY IS INDICATED WHERE AN EVENTIME VALL, CELLING, ROOF OR PLOOR ASSEMBLY IS INDICATED AND CAMPED BEHIND THE SURFACES TO REMAIN ALL DEPRESSION ON AND EARD PLOTES AND OTHER EVENTIME VALL CELLING, ROOF OR PLOOR ASSEMBLY IS INDICATED AND CAMPED BEHIND THE SURFACES TO REMAIN ALL DEPRESSION ON THE EXISTING SUBALLOOTIFIN IT EVENTIME OF THE DEVICITIE OF BEHONE THE CONTRACTOR SHALL TOOTIFIN THE AROUTE AUTOR SHALL BEADER TO REMOVE DO REMOVED TO REMOVE DEAD IT AND AND EXISTING SUBFORED TO REMOVE DO REMOVED BE INSTING MARKONER WALL, PUT THE SURFACE AND REMOVE AND THE INTERTY PROTON OF DEVISITING AND AND CHARGE INT SENTIRETY. DEB REMOVE AUTION DO ROW INT READ ON THE ADVECTOR EXISTING SUBAL AND DAVE AND AND AND CHARGE AND ASS INDICATED. DT REMOVE EXISTING DOOR FRAME AND HARDWARE INTERS THEOR THAND, OR ANY OTHER LOAD BEARING ROUTER AND HARDWARE IN THE ENTIRETY. DE REMOVE EXISTING DOOR FRAME AND HARDWARE INTERS THEOR THAND, OR INDICATED. DT REMOVE EXISTING SUBFORDID COLLING SYSTEMS IN THEIR ENTIRETY. DT REMOVE EXISTING WINDOW IN ITS ENTIRETY. DT REMOVE EXISTING WINDOW IN ITS ENTIRETY AND ASSEMBLY AS IN	zje
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CORRINATE THE STORAGE OF ALL SALVAGED ITEMS TO BE EITHER RELOCATED OR REINSTALLED WITH THE OWNER.         4. LOCATIONS ANDOR ELEVATIONS OF EXISTING ITEMS AS SHOWN ON THE DRAWINGS ARE APPROXIMATE RESPECTIVE TRADES SHALL FIELD VEHTRE AN ELLOCATED OR REWISTING WAIL, CELLING, ROOF OR FLOOR ASSEMBLY IS INDICATED WHERE AN EXISTING WAIL, CELLING, ROOF OR FLOOR ASSEMBLY IS INDICATED WHERE AN EXISTING WAIL, CELLING, ROOF OR FLOOR ASSEMBLY IS INDICATED WHERE AN EXISTING WAIL, CELLING, ROOF OR FLOOR ASSEMBLY IS INDICATED WHERE AN EXISTING WAIL, CELLING, ROOF OR RICOR ASSEMBLY EXISTING SHALL BE COMPLETELY REMOVED, WITH ASSOCIATED UTLITES REMOVED AND CAPPED BEHIND THE SURFACES TO REMAN, ALL DEPRESSIONS, INDENTATION, OR APPOT BEAILTOOTH TRANSITION SETULE FEARMER, PER-LOCOR REMOVED TO PROVIDE A SMOOTH TRANSITION SETULE REPARED, REPLANCE DO REMOVED TO PROVIDE A SMOOTH TRANSITION SETULE TO BE INFLIED, THE CONTRACTOR SHALL TOOTH IN NEW MASONRY CONSTRUCTION TO MATCH ADJACENT COURSING. RECOTING CORES SHALL VERY ALL CONTINGING SHALL TOOTH IN NEW MASONRY CONSTRUCTION OF BINGLE FOR STRUCTURAL ELEVENT.         9. REMOVE ALL COAD-EARNING OR STRUCTURAL ELEVENT.         9. REMOVE ALL COAD-EARNING OR OF RORING, BRACING AND UNDERPINNING RELATED TO THE DEMOLITION, REMOVAL OR CUTTING OF ANY WALL, PARTITION, OR ANY OTHER LOAD-BEARING OR OF RAME AND HARDWARE IN ITS ENTIRETY.         9. REMOVE EXISTING GURTAWAILLEDENT.         9. REMOVE EXISTING UNDORD FRAME AND HARDWARE IN ITS ENTIRETY.         10. REMOVE EXISTING CULMAN FURRING AND FRAMING AS INDICATED.         10. REMOVE EXISTING CULMAN FURRING AND FRAMING AS INDICATED.         10. REMOVE EXISTING CULMAN FURRING AND RARE IN THEIR ENTIRETY DOING TO SUBSTING SUBJENCE OF EXISTING GULAND FRAMING BACS TO NAREREST INDICATED.         10.	zļe
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5. WHEN A NEW WALL CELING, ROOF OR FLOOR ASSEMBLY IS INDICATED WHERE AN EXISTING WALL CELING, ROOF OR FLOOR ASSEMBLY VESIS THE EXISTING SHALL BE COMPLETELY REMOVED, WITH ASSOCIATED UTILITES REMOVED AND CAPPED BEHIND THE SUFFACES TO REMAIN ALL DEPRESSIONS, INDERTATIONS, OR PROTRINGISONS LEFT AFTER THE REMOVAL OF ITEMS WHICH MAY INTERFERE WITH THE CONSTRUCTOR SHALL LERE REPARED, REPROVEDED TO FONDIGE A SMOOTH TRASSITING SERVERNEY ALL CONDITIONS FROR TO COMMENCING DEMOLITION. ACCHITECT ON SHALL LERE REPARED, REPRODUCE TO PROVIDE A SMOOTH TRASSITING OFENINGS ARE INDEGREPANCES ARISE, THE CONTRACTOR SHALL NOTIFY THE ACCHITECT IN WRITING PRIOR TO DE CAEPOLING WITH DEMOLITION. 7. WHERE OFENINGS ARE INDICATED TO BE MADE IN EXISTING MASONRY WALLS, OR EXISTING OFENINGS ARE INDICATED TO BE MADE IN EXISTING MASONRY WALLS, OR EXISTING OFENINGS ARE INDICATED TO BE MADE IN EXISTING MASONRY WALL, SASSEMBLY AS INDICATED. 8. REMOVE ALL MECHANICAL, ELECTRICAL AND PLUMBING SYSTEMS IN THIER ENTIRETY. 9. REMOVE EXISTING OR STRUCTURAL ELEMENT. 9. REMOVE EXISTING WINDOW IN THE SENTIRE Y. REPRONT STRUG EXTERIOR MASONRY WALL 2. ASSEMBLY AS INDICATED. 0. THE SUPPORTION OF EXISTING EXTERIOR MASONRY WALL 2. REMOVE EXISTING CURTAINWALLISTOREFRONT FRAMING AND GLAZING AS INDICATED. 0. THE REMOVE EXISTING CURTAINWALLISTOREFRONT FRAMING AND GLAZING AS INDICATED. 0. REMOVE EXISTING CURTAINWALLISTOREFRONT FRAMING AND GLAZING AS INDICATED. 0. REMOVE EXISTING CURTAINWALLISTOREFRONT FRAMING AND GLAZING AS INDICATED. 0. THE REMOVE EXISTING SUPPRIDED CELING SYSTEM IN IT'S ENTIRETY INCLUDING 0. THE REMOVE EXISTING SUPPREDUED CELING SYSTEM IN IT'S ENTIRETY INCLUDING 0. DERIVE EXISTING SUPPREDUED CELING SYSTEM IN IT'S ENTIRETY INCLUDING 0. DERIVE EXISTING SUBSTRATES. 0. REMOVE EXISTING SUBFRATES. 0. REMOVE EXISTING CARPET FLOOR FINISHES AND BASE IN THEIR ENTIRETY DOWN TO SUBSTRATES. 0. REMOVE EXISTING RELIVERS AND TOLET ACCESSORIES, INLCUDING 0. DERIVE EXISTING CARPET FLOOR FINISHES AND BASE IN THEIR ENTIRETY DOWN TO SUBSTRATES. 0. REMOVE EXISTING BULLIT	zje
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MASONRY/WALL OPENINGS TO REMAIN.       SPIEZLE ARCHITECT         D9       REMOVE EXISTING CURTAINWALL/STOREFRONT FRAMING AND GLAZING AS INDICATED.       SPIEZLE ARCHITECT         D10a       REMOVE PORTION OF EXISTING INTERIOR FRAMED WALL ASSEMBLY AS INDICATED.       PHC         D10b       REMOVE PORTION OF EXISTING COLUMN FURRING AND FRAMING AS INDICATED.       SIGNATURE:         D12       REMOVE PORTION OF EXISTING COLUMN FURRING AND FRAMING AS INDICATED.       SIGNATURE:         D12       REMOVE EXISTING SUSPENDED CEILING SYSTEM IN ITS ENTIRETY INCLUDING LIGHTING FIXTURES. SAFE-OFF EXISTING CONDUITS WHERE SCHEDULED TO BE REUSED OTHERWISE TERMINATE CONDUIT AND WIRING BACK TO NEAREST PANEL.       SIGNATURE:         D13       REMOVE EXISTING RESILIENT FLOOR FINISHES AND BASE IN THEIR ENTIRETY DOWN TO SUBSTRATES.       JOH REMOVE EXISTING CARPET FLOOR FINISHES AND BASE IN THEIR ENTIRETY DOWN TO SUBSTRATES.       SEAL:         D14       REMOVE EXISTING PLUMBING FIXTURES AND TOILET ACCESSORIES, INLCUDING BUT NOT LIMITED TO: TOILET, PAPER TOWEL AND TOILET TISSUE DISPENSERS, SOAP DISPENSERS, MIRRORS, GRAB BARS AND HAND DRYERS.       SEAL:         D21       REMOVE EXISTING BUILT-IN CASEWORK/CABINETRY IN ITS ENTIRETY.       SEAL:         D25       REMOVE EXISTING BOLLARDS AND FOUNDATIONS IN THEIR ENTIRETY.       SEAL:	
INDICATED.       INDICATED.         D10a       REMOVE PORTION OF EXISTING INTERIOR FRAMED WALL ASSEMBLY AS INDICATED.       PHC         D10b       REMOVE PORTION OF EXISTING COLUMN FURRING AND FRAMING AS INDICATED.       SIGNATURE:         D12       REMOVE EXISTING SUSPENDED CEILING SYSTEM IN ITS ENTIRETY INCLUDING LIGHTING FIXTURES. SAFE-OFF EXISTING CONDUITS WHERE SCHEDULED TO BE REUSED OTHERWISE TERMINATE CONDUIT AND WIRING BACK TO NEAREST PANEL.       SIGNATURE:         D13       REMOVE EXISTING RESILIENT FLOOR FINISHES AND BASE IN THEIR ENTIRETY DOWN TO SUBSTRATES.       D14         D14       REMOVE EXISTING PLUMBING FIXTURES AND BASE IN THEIR ENTIRETY DOWN TO SUBSTRATES.       SEAL:         D18       REMOVE EXISTING PLUMBING FIXTURES AND TOILET ACCESSORIES, INLCUDING BUT NOT LIMITED TO: TOILET, PAPER TOWEL AND TOILET TISSUE DISPENSERS, SOAP DISPENSERS, MIRRORS, GRAB BARS AND HAND DRYERS.       SEAL:         D21       REMOVE EXISTING BUILT-IN CASEWORK/CABINETRY IN ITS ENTIRETY.       SEAL:         D25       REMOVE PORTION OF EXISTING CONCRETE BUILDING BASE.       D26         D26       REMOVE EXISTING BOLLARDS AND FOUNDATIONS IN THEIR ENTIRETY.	URAL GROUP INC.
INDICATED.         D10b       REMOVE PORTION OF EXISTING COLUMN FURRING AND FRAMING AS INDICATED.         D12       REMOVE EXISTING SUSPENDED CEILING SYSTEM IN ITS ENTIRETY INCLUDING LIGHTING FIXTURES. SAFE-OFF EXISTING CONDUITS WHERE SCHEDULED TO BE REUSED OTHERWISE TERMINATE CONDUIT AND WIRING BACK TO NEAREST PANEL.         D13       REMOVE EXISTING RESILIENT FLOOR FINISHES AND BASE IN THEIR ENTIRETY DOWN TO SUBSTRATES.         D14       REMOVE EXISTING CARPET FLOOR FINISHES AND BASE IN THEIR ENTIRETY DOWN TO SUBSTRATES.         D18       REMOVE EXISTING PLUMBING FIXTURES AND TOILET ACCESSORIES, INLCUDING BUT NOT LIMITED TO: TOILET, PAPER TOWEL AND TOILET TISSUE DISPENSERS, SOAP DISPENSERS, MIRRORS, GRAB BARS AND HAND DRYERS.         D21       REMOVE EXISTING BUILT-IN CASEWORK/CABINETRY IN ITS ENTIRETY.         D25       REMOVE PORTION OF EXISTING CONCRETE BUILDING BASE.         D26       REMOVE EXISTING BOLLARDS AND FOUNDATIONS IN THEIR ENTIRETY.	MARKET STREET CAMDEN, NJ 08102
INDICATED.D12REMOVE EXISTING SUSPENDED CEILING SYSTEM IN ITS ENTIRETY INCLUDING LIGHTING FIXTURES. SAFE-OFF EXISTING CONDUITS WHERE SCHEDULED TO BE REUSED OTHERWISE TERMINATE CONDUIT AND WIRING BACK TO NEAREST PANEL.SIGNATURE: THOMAS S. PERRINO SCOTT E. DOWNIE STEVEN LEONED13REMOVE EXISTING RESILIENT FLOOR FINISHES AND BASE IN THEIR ENTIRETY DOWN TO SUBSTRATES.SIGNATURE: THOMAS S. PERRINO SCOTT E. DOWNIE STEVEN LEONED14REMOVE EXISTING CARPET FLOOR FINISHES AND BASE IN THEIR ENTIRETY DOWN TO SUBSTRATES.SIGNATURE: THOMAS S. PERRINO SCOTT E. DOWNIE STEVEN LEONED18REMOVE EXISTING PLUMBING FIXTURES AND TOILET ACCESSORIES, INLCUDING BUT NOT LIMITED TO: TOILET, PAPER TOWEL AND TOILET TISSUE DISPENSERS, SOAP DISPENSERS, MIRRORS, GRAB BARS AND HAND DRYERS.SEAL:D21REMOVE EXISTING BUILT-IN CASEWORK/CABINETRY IN ITS ENTIRETY. D25SEINOVE PORTION OF EXISTING CONCRETE BUILDING BASE. D26REMOVE EXISTING BOLLARDS AND FOUNDATIONS IN THEIR ENTIRETY.D26REMOVE EXISTING BOLLARDS AND FOUNDATIONS IN THEIR ENTIRETY.SEIN STIRETY	NE: (866) 974 7666
D12REMOVE EXISTING SUSPENDED CEILING SYSTEM IN ITS ENTIRETY INCLUDING LIGHTING FIXTURES. SAFE-OFF EXISTING CONDUITS WHERE SCHEDULED TO BE REUSED OTHERWISE TERMINATE CONDUIT AND WIRING BACK TO NEAREST PANEL.THOMAS S. PERRINO SCOTT E. DOWNIE STEVEN G. SIEGEL ANGELO ALBERTO JOHN F. WRIGHT SPIEZLE ARCHITECTURAL GROUP, INC.D13REMOVE EXISTING RESILIENT FLOOR FINISHES AND BASE IN THEIR ENTIRETY DOWN TO SUBSTRATES.Steven S. SIEGEL ANGELO ALBERTO JOHN F. WRIGHT SPIEZLE ARCHITECTURAL GROUP, INC.D14REMOVE EXISTING CARPET FLOOR FINISHES AND BASE IN THEIR ENTIRETY DOWN TO SUBSTRATES.SEAL:D18REMOVE EXISTING PLUMBING FIXTURES AND TOILET ACCESSORIES, INLCUDING BUT NOT LIMITED TO: TOILET, PAPER TOWEL AND TOILET TISSUE DISPENSERS, SOAP DISPENSERS, MIRRORS, GRAB BARS AND HAND DRYERS.SEAL:D21REMOVE EXISTING BUILT-IN CASEWORK/CABINETRY IN ITS ENTIRETY. D25SEMOVE PORTION OF EXISTING CONCRETE BUILDING BASE.D26REMOVE EXISTING BOLLARDS AND FOUNDATIONS IN THEIR ENTIRETY.	
REUSED OTHERWISE TERMINATE CONDUIT AND WIRING BACK TO NEAREST PANEL.D13REMOVE EXISTING RESILIENT FLOOR FINISHES AND BASE IN THEIR ENTIRETY DOWN TO SUBSTRATES.STEVEN G. SIEGEL ANGELO ALBERTO JOHN F. WRIGHT SPIEZLE ARCHITECTURAL GROUP, INC.D14REMOVE EXISTING CARPET FLOOR FINISHES AND BASE IN THEIR ENTIRETY DOWN TO SUBSTRATES.SEAL:D18REMOVE EXISTING PLUMBING FIXTURES AND TOILET ACCESSORIES, INLCUDING BUT NOT LIMITED TO: TOILET, PAPER TOWEL AND TOILET TISSUE DISPENSERS, SOAP DISPENSERS, MIRRORS, GRAB BARS AND HAND DRYERS.SEAL:D21REMOVE EXISTING BUILT-IN CASEWORK/CABINETRY IN ITS ENTIRETY.D25D26REMOVE EXISTING BOLLARDS AND FOUNDATIONS IN THEIR ENTIRETY.	21Al01505400 21Al01674400 21Al01170100
D13       REMOVE EXISTING RESILIENT FLOOR FINISHES AND BASE IN THEIR ENTIRETY DOWN TO SUBSTRATES.       SPIEZLE ARCHITECTURAL GROUP, INC.         D14       REMOVE EXISTING CARPET FLOOR FINISHES AND BASE IN THEIR ENTIRETY DOWN TO SUBSTRATES.       SEAL:         D18       REMOVE EXISTING PLUMBING FIXTURES AND TOILET ACCESSORIES, INLCUDING BUT NOT LIMITED TO: TOILET, PAPER TOWEL AND TOILET TISSUE DISPENSERS, SOAP DISPENSERS, MIRRORS, GRAB BARS AND HAND DRYERS.       SEAL:         D21       REMOVE EXISTING BUILT-IN CASEWORK/CABINETRY IN ITS ENTIRETY.       D25         D26       REMOVE EXISTING BOLLARDS AND FOUNDATIONS IN THEIR ENTIRETY.	21Al01564200 21Al01046700 21Al01784200
DOWN TO SUBSTRATES.DIRD18REMOVE EXISTING PLUMBING FIXTURES AND TOILET ACCESSORIES, INLCUDING BUT NOT LIMITED TO: TOILET, PAPER TOWEL AND TOILET TISSUE DISPENSERS, SOAP DISPENSERS, MIRRORS, GRAB BARS AND HAND DRYERS.D21REMOVE EXISTING BUILT-IN CASEWORK/CABINETRY IN ITS ENTIRETY.D25REMOVE PORTION OF EXISTING CONCRETE BUILDING BASE.D26REMOVE EXISTING BOLLARDS AND FOUNDATIONS IN THEIR ENTIRETY.	21AC00063000
BUT NOT LIMITED TO: TOILET, PAPER TOWEL AND TOILET TISSUE DISPENSERS, SOAP DISPENSERS, MIRRORS, GRAB BARS AND HAND DRYERS.D21REMOVE EXISTING BUILT-IN CASEWORK/CABINETRY IN ITS ENTIRETY.D25REMOVE PORTION OF EXISTING CONCRETE BUILDING BASE.D26REMOVE EXISTING BOLLARDS AND FOUNDATIONS IN THEIR ENTIRETY.	
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D25REMOVE PORTION OF EXISTING CONCRETE BUILDING BASE.D26REMOVE EXISTING BOLLARDS AND FOUNDATIONS IN THEIR ENTIRETY.	
ENTIRETY.	
D28       REMOVE EXISTING RAISED CURB AREA IN ITS ENTIRETY.         D30       REMOVE EXISTING INTERIOR COLUMN ENCASEMENT IN ITS ENTIRETY.	
D32 REMOVE EXISTING INTERIOR STAIR IN ITS ENTIRETY. BID SET - 06/25/	2024
D34 REMOVE EXISTING ROOF SYSTEM IN ITS ENTIRETY INCLUDING STRUCTURE. D35 REMOVE EXISTING ROOF SYSTEM IN ITS ENTIRETY DOWN TO ROOF DECK INCLUDING PUT NOT LIMITED TO ALL FLASUINGS AND CODINGS	
INCLUDING BUT NOT LIMITED TO ALL FLASHINGS AND COPINGS.         D36       REMOVE EXISTING DECORATIVE CORNICE IN ITS ENTIRETY.         PROJECT:	
D37       REMOVE PNEUMATIC TUBE TRANSPORT ASSEMBLY IN ITS ENTIRETY.         D38       REMOVE LIGHT FIXTURE.	
D39 REMOVE PASS THROUGH BOX. D40 REMOVE CANOPY IN ITS ENTIRETY.	
D41 REMOVE VAULT DOOR AND ASSEMBLY IN ITS ENTIRETY. HADDONFIELD P	OLICE
D43       REMOVE HVAC EQUIPMENT AND PATCH ROOF DECK PER NEW WORK.       STATION         D44       REMOVE AND SALVAGE ROOF HATCH FOR REINSTALLATION.       STATION         D45       REMOVE ROOF DRAIN IN ITS ENTIRETY.       STATION	
D46 REMOVE EXISTING STOREFRONT ASSEMBLY IN ITS ENTIRETY. 1 WALNUT STREET, HADDO	NFIELD, NJ
D47       REMOVE EXISTING BRICK, CONCRETE BLOCK, AND WOOD FENCING ENCLOSURE       08033         AND CONCRETE SLAB IN ITS ENTIRETY.       FOR         D48       REMOVE EXISTING CHILLER IN ITS ENTIRETY.       FOR	
D49 REMOVE BLAB AND FOUNDATIONS IN THEIR ENTIRETY.	
D50 REMOVE ROOF DECK AT INDICATED AREA.	
IMPROVEMEN AUTHORITY	
520 MARKET STREET, 6TH	
CAMDEN, NEW JERSEY	
FOR CODE REVIEW:	02/23/24
REVISIONS:	
#   REVISION NAME	DATE
FOR BID:	06/25/2024
	00/20/20/2024
DRAWING TITLE:	
ROOF DEMOLIT	ION
PLANS	
COMMISSION NUMBER:	
23M014	
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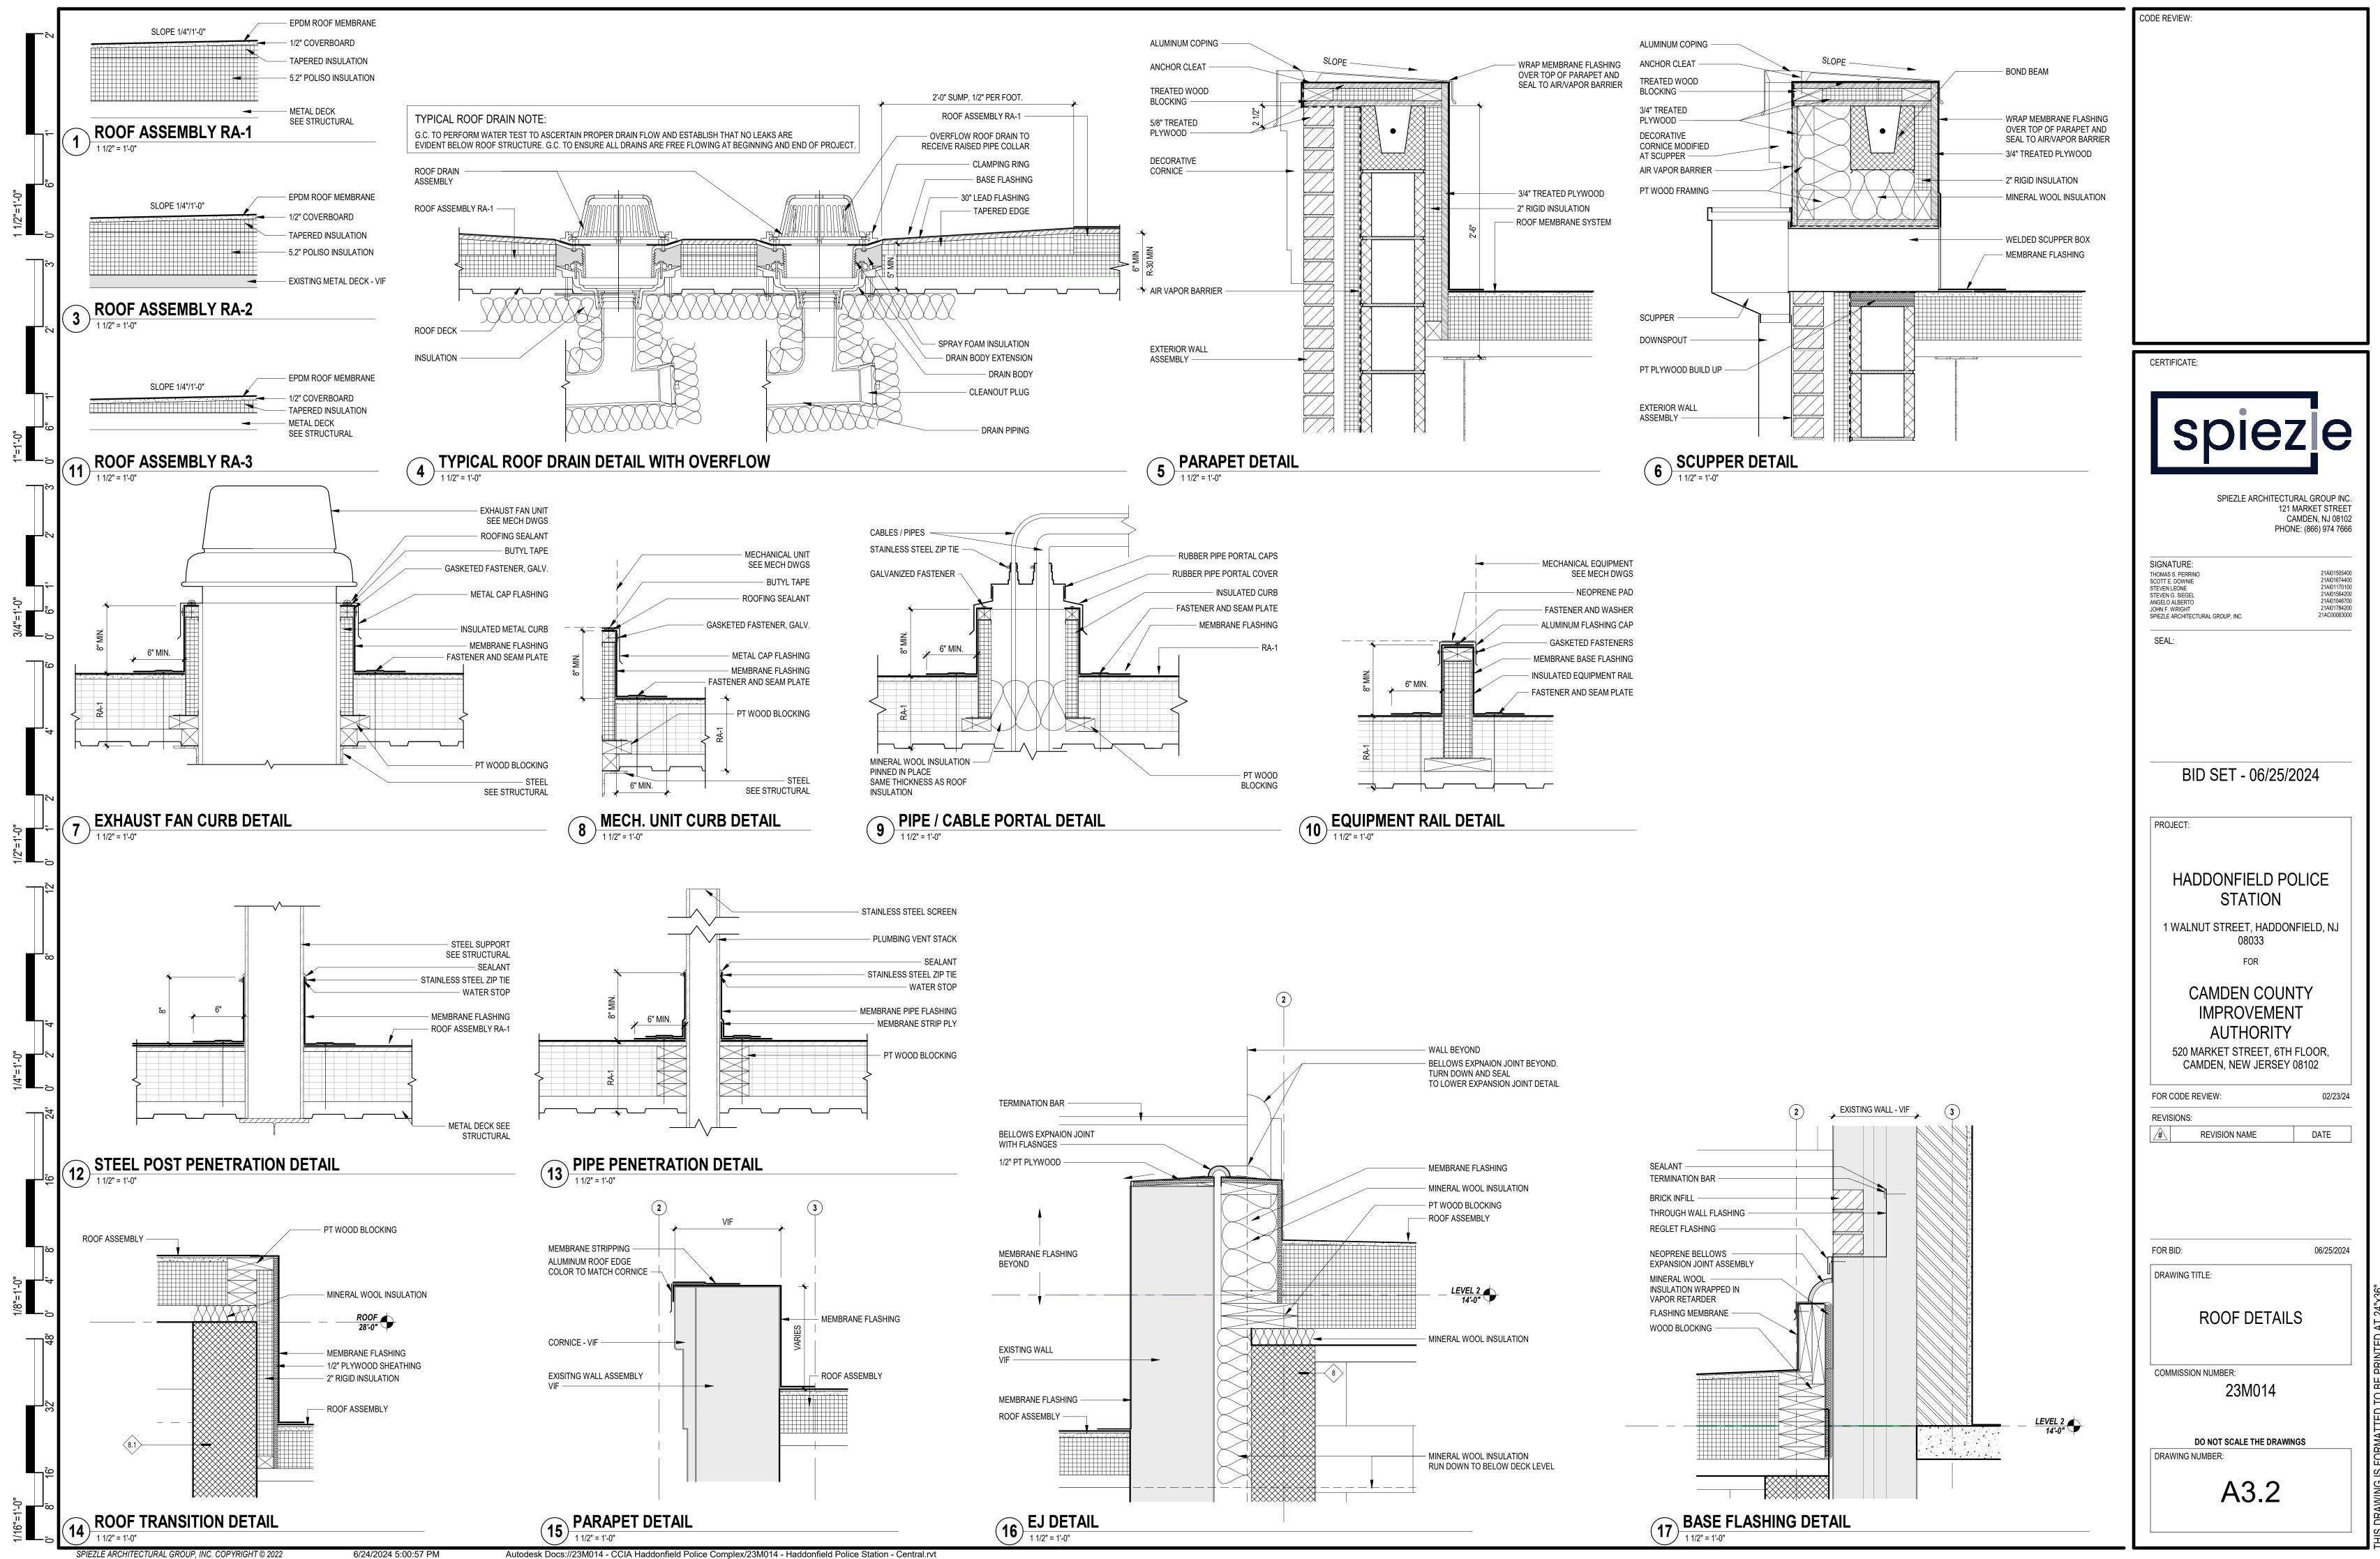


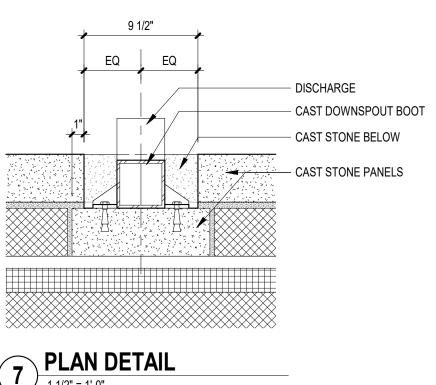Autodesk Docs://23M014 - CCIA Haddonfield Police Complex/23M014 - Haddonfield Police Station - Central.rvt

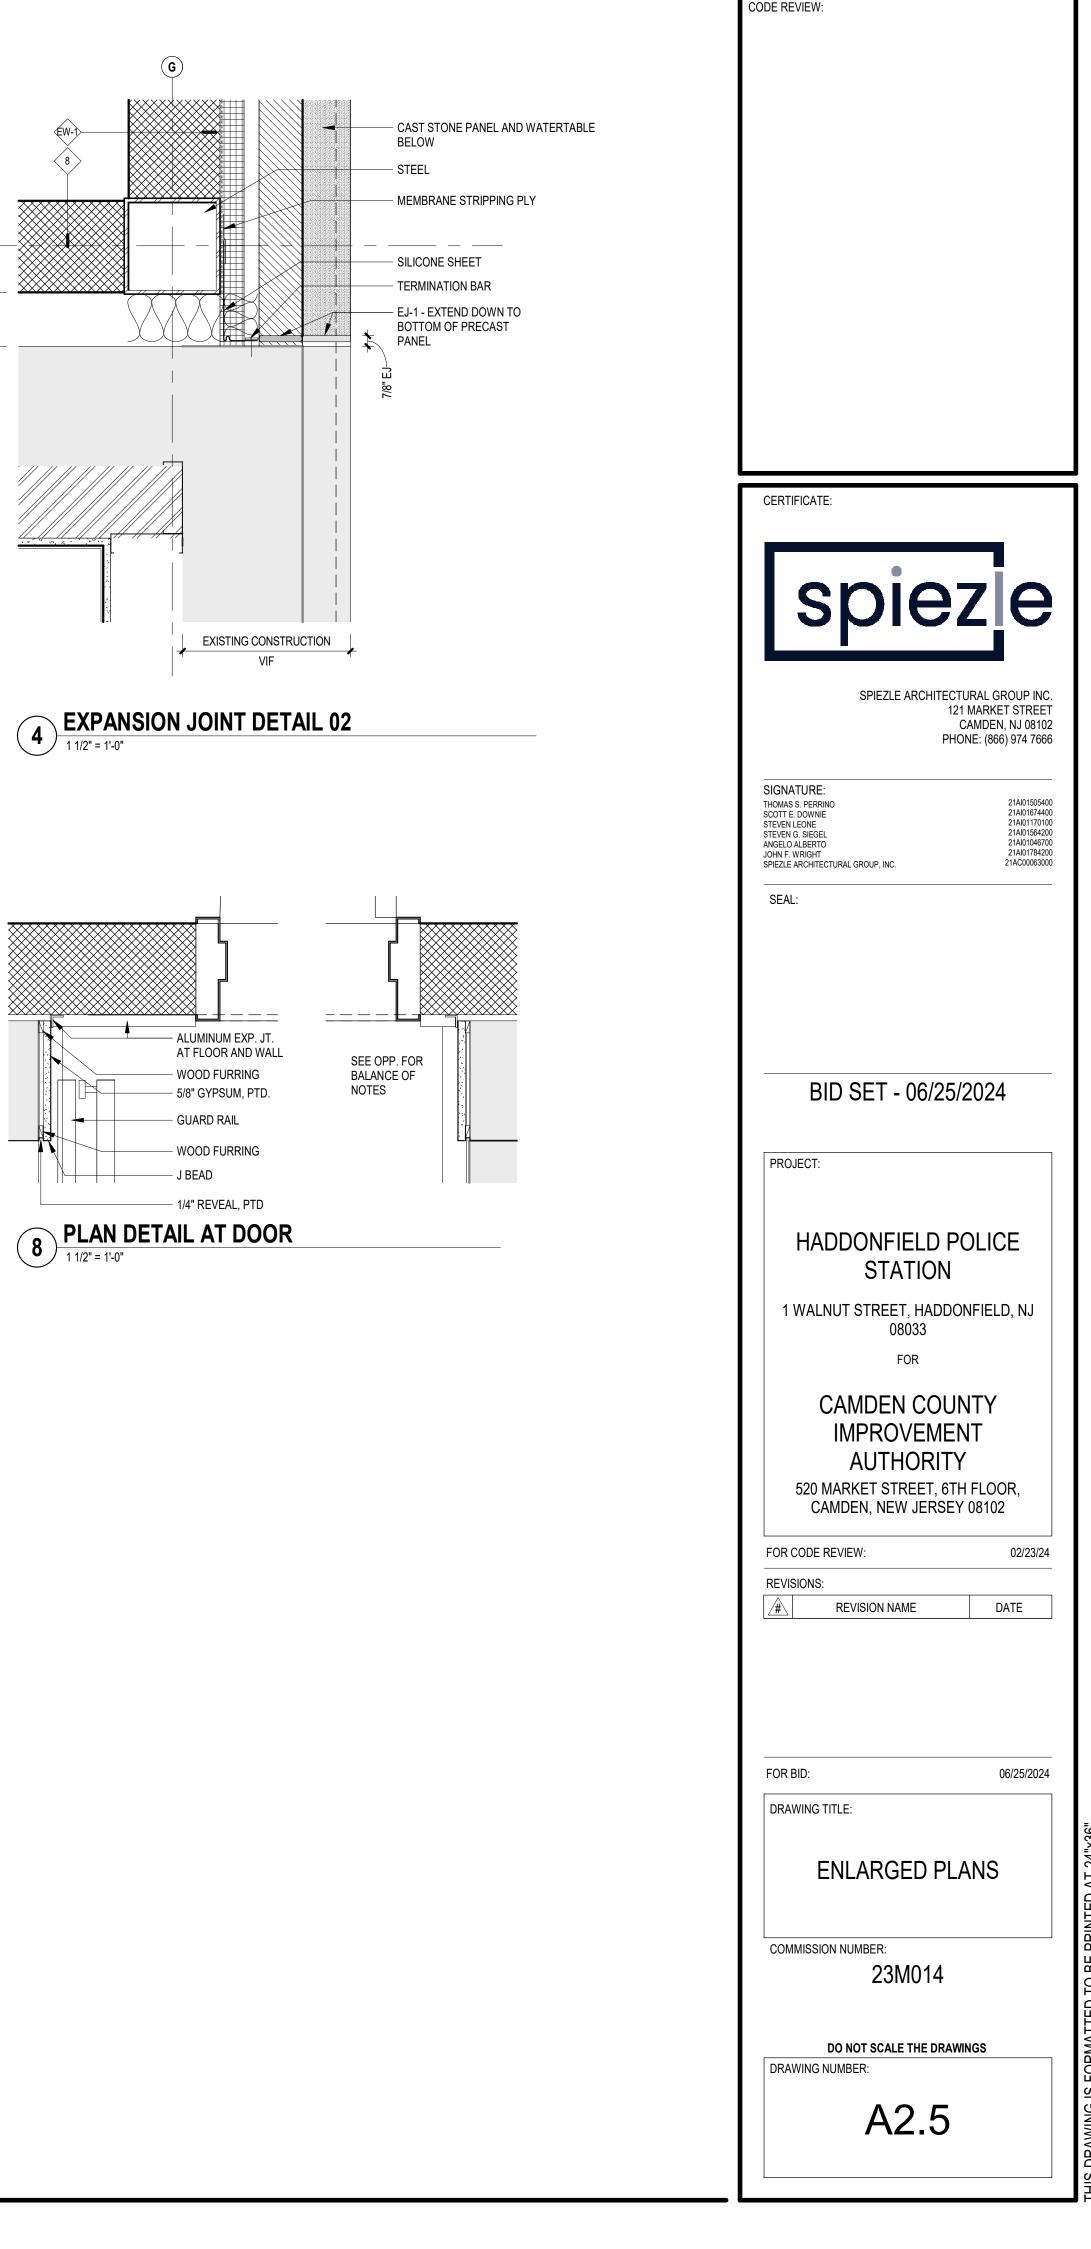
ROOF	LEGEND:
	CRICKET - SLOPE TO DRAIN (TYPICA 1/2"/FT. MIN. (TYPICAL)
	TAPERED RIGID INSULATION SLOPE TO DRAIN (TYPICAL) 1/4"/FT. MIN. (TYPICAL)
	36" PROTECTIVE WALKWAY PAD
	– DETAIL NUMBER
A1.1	- DRAWING NUMBER
<u>HIGH</u> LOW	ROOF TRANSITION or ROOF STEP
	— ROOF DRAIN — OVERFLOW DRAIN
RTU	ROOF TOP UNIT
EF	EXHAUST FAN
RV	ROOF VENT
DS	DOWN SPOUT
PV	PLUMBING VENT
TWS	THRU-WALL SCUPPER
DST	DUCT SUPPORT
HP	HIGH POINT
LP	LOW POINT

### DOOF LECEND.

GENERAL ROOFING NOTES	CODE REVIEW:
. SEE ROOF PLAN FOR DESIGNATION OF SPECIFIC 'ROOF ASSEMBLY TYPES'. . THE QUANTITY AND LOCATION OF ALL EXISTING AND NEW ROOFTOP EQUIPMENT INCLUDING BUT NOT	
LIMITED TO MECHANICAL UNITS, ROOF AND OVERFLOW DRAINS, VENTS AND ELECTRICAL CONDUIT AND DEVICES ARE SHOWN FOR REFERENCE ONLY. THE CONTRACTOR MUST FIELD VERIFY ALL EXISTING CONDITIONS PRIOR TO THE COMMENCEMENT OF WORK AND COORDINATE WITH NEW CONDITIONS	
INDICATED UNDER BASE BIDS, ALTERNATE BIDS AND SEPARATE CONTRACT(S) WHERE APPLICABLE. ALL ROOFS SHALL SLOPE AT A MINIMUM RATE OF 1/4" PER FOOT, UNLESS OTHERWISE NOTED. PROVIDE ADDITIONAL TAPERED INSULATION TO MAINTAIN REQUIRED SLOPE WHETHER INDICATED OR NOT.	
ROOF CRICKETS SHALL SLOPE AT A MINIMUM RATE OF 1/2" PER FOOT AND BE LOCATED IN LOW VALLEYS, BETWEEN ROOF DRAINS AND BEHIND EQUIPMENT TO DIVERT WATER AROUND CURBS, RAILS AND OTHER EQUIPMENT SUPPORTS, WHETHER INDICATED OR NOT.	
A MINIMUM BASE INSULATION THICKNESS OF 3-1/2" SHALL BE PROVIDED AT ALL ROOFS. PROVIDE ADDITIONAL BASE INSULATION THICKNESS AND/OR TAPERED INSULATION AS REQUIRED TO MEET R- VALUE REQUIREMENTS INDICATED ON THE DRAWINGS OR AS OUTLINED IN THE SPECIFICATIONS,	
WHICHEVER IS MORE STRINGENT. WITH THE EXCEPTION OF ROOF DRAIN PANS, NO POINT ON THE ROOF SHALL HAVE LESS THAN THE REQUIRED MINIMUM THICKNESS OF BASE INSULATION. ALL WOOD BLOCKING AND PLYWOOD SHEATHING SHALL BE PRESSURE TREATED. UNLESS OTHERWISE	
NOTED, ALL PLYWOOD SHEATHING SHALL BE A MINIMUM OF 1/2" THICK. PROVIDE 'BELLOWS' TYPE EXPANSION AND/OR CONTROL JOINTS IN ROOF SYSTEMS WHERE SHOWN ON DRAWINGS AND AS RECOMMENDED BY THE ROOFING MANUFACTURER.	
TAPERED EDGE STRIPS SHALL BE USED AT ALL TRANSITIONS FROM TAPERED TO FLAT INSULATION BOARDS AND AT ALL PERIMETER ROOF EDGES. MAINTAIN CONSTANT ROOF EDGE ELEVATIONS ACROSS THE SAME HORIZONTAL PLANE.	
INSULATE ALL HORIZONTAL ROOF/STORM DRAINAGE PIPING. PROVIDE CONCRETE SPLASHBLOCKS AT ALL DOWNSPOUTS AND CONDENSATE PIPING LOCATIONS WHICH ARE NOT TIED DIRECTLY INTO THE BUILDINGS STORM DRAINAGE SYSTEM. SPLASHBLOCKS SHALL BE	
SELF-BALLASTING AND PLACE ON A ROOF WALKWAY OR OTHER PROTECTION PAD AS COMPATIBLE AND APPROVED BY THE ROOFING SYSTEM MANUFACTURER. THE CONTRACTOR SHALL COORDINATE LOCATIONS OF ROOF DRAINS, OVERFLOW DRAINS AND	
DOWNSPOUT LEADERS WITH WINDOW LOCATIONS AND OTHER BUILDING FEATURES. CONFLICTS SHALL BE BROUGHT TO THE ATTENTION OF THE ARCHITECT PRIOR TO INSTALLATION. WHETHER INDICATED OR NOT ON THE DRAWINGS, THE CONTRACTOR SHALL BE RESPONSIBLE FOR	CERTIFICATE:
FLASHING ALL ROOFTOP EQUIPMENT AND PENETRATIONS PER THE DETAILS AND/OR ROOFING MANUFACTURER'S REQUIREMENTS, WHICHEVER IS STRICTER. PROVIDE ROOF PROTECTION PADS COMPATIBLE WITH THE SPECIFIED ROOFING SYSTEM BELOW ALL	
POINTS OF CONTACT OF EQUIPMENT SUPPORT RAILS, DUCT SUPPORTS, PIPE CARRIERS AND OTHER SUPPORT DEVICES WHICH DO NOT PENETRATE THE ROOF. THE BUILDING MAY BE OCCUPIED DURING ROOFING REMOVAL AND REPLACEMENT. THE CONTRACTORS	
WORK AND SEQUENCING SHALL BE COORDINATED WITH THE OWNER AND ARCHITECT PRIOR TO COMMENCEMENT OF WORK. FOR ALL CONNECTIONS TO EXISTING ROOFS TO REMAIN, COORDINATE WITH THE MANUFACTURER OF	
THE EXISTING ROOFING SYSTEM PRIOR TO THE START OF WORK TO VERIFY THE COMPATIBILITY OF ALL FLASHING METHODS, ROOFING MATERIALS AND INSTALLATION METHODS SO AS NOT TO VOID EXISTING ROOF WARRANTIES.	SPIEZLE ARCHITECTURAL GROUP IN
EXTEND/RAISE ALL EXISTING ROOF CURBS, EQUIPMENT, SKYLIGHTS, ETC. TO MAINTAIN A MINIMUM OF 8" HIGH FLASHING ABOVE THE FINISHED ROOF SURFACE. THE CONTRACTOR IS RESPONSIBLE FOR ALL DISCONNECT, EXTENSION, TEMPORARY RELOCATION AND	121 MARKET STREE CAMDEN, NJ 0810 PHONE: (866) 974 760
RECONNECTION OF UTILITIES THAT MAY BE NECESSARY TO FACILITATE THE WORK. COORDINATE ALL UTILITY INTERRUPTIONS AND SHUTDOWNS WITH THE OWNER AND ARCHITECT PER THE SPECIFICATIONS. THE CONTRACTOR SHALL PURGE, DISCONNECT, RAISE AND RECONNECT EXISTING GAS PIPING AS	SIGNATURE:
NECESSARY TO COMPLETE THE WORK. DETAILS SHOWN ARE FOR BASE BID ROOFING SYSTEMS. WHERE ACCEPTED, THE CONTRACTOR SHALL PROVIDE REVISED DETAILS FOR ALTERNATE BID ROOFING SYSTEMS PER THE MANUFACTURER'S	THOMAS S. PERINO         21AI01505-           SCOTT E. DOWNIE         21AI01674-           STEVEN LEONE         21AI0170           STEVEN LEONE         21AI01564:
RECOMMENDATIONS. WHERE RE-ROOFING OCCURS AND EXISTING VENTS OR OTHER PIPING ARE TO REMAIN, THE CONTRACTOR SHALL BE RESPONSIBLE FOR PROVIDING PIPE EXTENSIONS TO ENSURE THAT PIPING AND	ANGELO ALBERTO 21A101046 JOHN F. WRIGHT 21A101784 SPIEZLE ARCHITECTURAL GROUP, INC. 21AC00063
FLASHINGS ARE A MINIMUM OF 8" ABOVE THE FINISHED ROOF SURFACE. ALL EXISTING ROOFTOP EQUIPMENT, CURBS, RAILS AND VENTS SHALL REMAIN, UNLESS OTHERWISE NOTED. THE CONTRACTOR SHALL BE RESPONSIBLE FOR MAINTAINING MINIMUM CLEARANCES BETWEEN ROOF SURFACES AND BOTTOM OF EQUIPMENT. THE CONTRACTOR SHALL BE RESPONSIBLE FOR	SEAL:
PROTECTING EXISTING EQUIPMENT TO REMAIN AND SHALL REPAIR/REPLACE DAMAGED EQUIPMENT IMMEDIATELY AT NO COST TO THE OWNER. THE [STEEL] CONTRACTOR SHALL BE RESPONSIBLE FOR PROVIDING SUPPLEMENTAL STEEL SUPPORT	
ANGLES AND OTHER FRAMING AS REQUIRED AT ALL NEW AND/OR RELOCATED ROOF DRAIN ASSEMBLIES OR OTHER PENETRATIONS GREATER THAN 4" DIAMETER, WHETHER INDICATED OR NOT. LOCATIONS OF ROOF DRAINS, OVERFLOW DRAINS AND OTHER ROOF PENETRATIONS ARE DIAGRAMMATIC	
AND MUST BE COORDINATED WITH OTHER ASPECTS OF THE WORK. THE CONTRACTOR SHALL COORDINATE FINAL PLACEMENT OF DRAINS AND EQUIPMENT WITH STEEL FRAMING, EXISTING EQUIPMENT AND CONDITIONS BELOW THE ROOF DECK THAT MAY INHIBIT THE INSTALLATION OF SAID	
EQUIPMENT FROM LOCATIONS DEPICTED IN THE DRAWINGS. TO THE GREATEST EXTENT, ROOF DRAINS SHALL BE LOCATED TO PROVIDE UNIFORM CRICKET HEIGHTS AND UNOBSTRUCTED FLOW TO DRAINS WHILE MINIMIZING INSULATION HEIGHTS AT PARAPETS OR OTHER RISING WALL CONDITIONS.	BID SET - 06/25/2024
TAPERED INSULATION LAYOUTS ARE FOR GENERAL REFERENCE ONLY. THE CONTRACTOR SHALL PROVIDE TAPERED INSULATION DRAWINGS AND SPECIFIC MANUFACTURING DETAILS FOR REVIEW AND APPROVAL.	
THE CONTRACTOR IS RESPONSIBLE FOR REMOVAL AND DISPOSAL OF ALL HAZARDOUS MATERIALS. REFER TO THE PROJECT MANUAL AND ABATEMENT DRAWINGS FOR ADDITIONAL INFORMATION REGARDING REMOVAL, HANDLING AND DISPOSAL PROCEDURES.	PROJECT:
REPLACE DAMAGED MATERIALS AND ASSEMBLIES IN 'LIKE KIND' LEAVING NO EVIDENCE OF PATCHING OR REPAIRS AS DETERMINED BY THE ARCHITECT AND AT NO COST TO THE OWNER. NO SCREWS AND/OR PLATES SHALL BE USED TO ADHERE BASE SHEETS TO EXISTING WOOD DECKING.	
CONSULT THE RECOMMENDATIONS OF THE ROOFING MANUFACTURER FOR BASE SHEET INSTALLATION OVER WOOD DECKS. WHERE FINISHES ARE REQUIRED OVER EXISTING SUBSTRATES, THE CONTRACTOR SHALL COMPLETELY	HADDONFIELD POLICE
REMOVE EXISTING MATERIALS; SUCH AS, BUT NOT LIMITED TO: COATINGS, FILMS, OILS, SEALERS AND ADHESIVES, ETC. DEFECTIVE SUBSTRATES WHICH ARE NO LONGER UNIFORM, DIMENSIONALLY STABLE, STRUCTURALLY	1 WALNUT STREET, HADDONFIELD, NJ
SOUND, OR OTHERWISE UNACCEPTABLE FOR THE INSTALLATION OF WORK SHALL BE QUANTIFIED AND DOCUMENTED BY SURVEY AND PHOTOGRAPHS AND BROUGHT TO THE ATTENTION OF THE ARCHITECT AND OWNER. SUBSTRATES SHALL BE REPLACED WITH MATERIAL(S) COMPATIBLE WITH EXISTING	08033 FOR
SYSTEMS AND SUITABLE FOR THE WORK IN ACCORDANCE WITH THE MATERIAL MANUFACTURER'S WRITTEN LITERATURE AND RECOGNIZED INDUSTRY STANDARDS. FAILURE TO INSPECT AND IDENTIFY DEFECTIVE SUBSTRATES PRIOR TO COMMENCEMENT OF NEW ROOFING SYSTEM(S) INSTALLATION SHALL	CAMDEN COUNTY
CONSTITUTE THE CONTRACTOR'S COMPLETE ACCEPTANCE OF SAID SUBSTRATE CONDITIONS. WHERE EXISTING LIGHT FIXTURES, CONDUITS, JUNCTION BOXES OR OTHER ELECTRICAL EQUIPMENT REQUIRE MODIFICATIONS TO ACCOMMODATE NEW CONSTRUCTION, COORDINATE UTILITY SERVICE	IMPROVEMENT
INTERRUPTIONS WITH THE OWNER. TEMPORARILY RAISE OR RELOCATE EXISTING ELECTRICAL WIRING/CONDUIT LAYING ON ROOFS TO ACCOMMODATE NEW CONSTRUCTION AND ROOFING INSTALLATIONS. COORDINATE UTILITY SERVICE	AUTHORITY 520 MARKET STREET, 6TH FLOOR,
INTERRUPTIONS WITH THE OWNER. UNLESS OTHERWISE NOTED, ALL EXISTING ROOF TRANSITION LADDERS ARE TO BE REMOVED AND REPLACED.	CAMDEN, NEW JERSEY 08102
ALL ROOF TRANSITION LADDERS SHALL BE SHOP FABRICATED AND PAINTED ALUMINUM CONSTRUCTION WITH SLIP-RESISTANT RUNGS. LADDERS SHALL BE FULLY SUPPORTED BY WALL/PARAPET CONSTRUCTION WITHOUT SUPPORT OR PENETRATION OF THE ROOFING ASSEMBLIES. PROVIDE (1)	FOR CODE REVIEW: 02/23/2
36"x36" ROOF WALKWAY PAD BELOW EACH SIDE OF THE TRANSITION LADDER COMPATIBLE WITH THE ROOFING SYSTEM.	REVISION NAME DATE
	FOR BID: 06/25/202
	DRAWING TITLE:
	ROOF PLANS AND
	DETAILS
	COMMISSION NUMBER:
	23M014
	DO NOT SCALE THE DRAWINGS
	DRAWING NUMBER:
	A3.1





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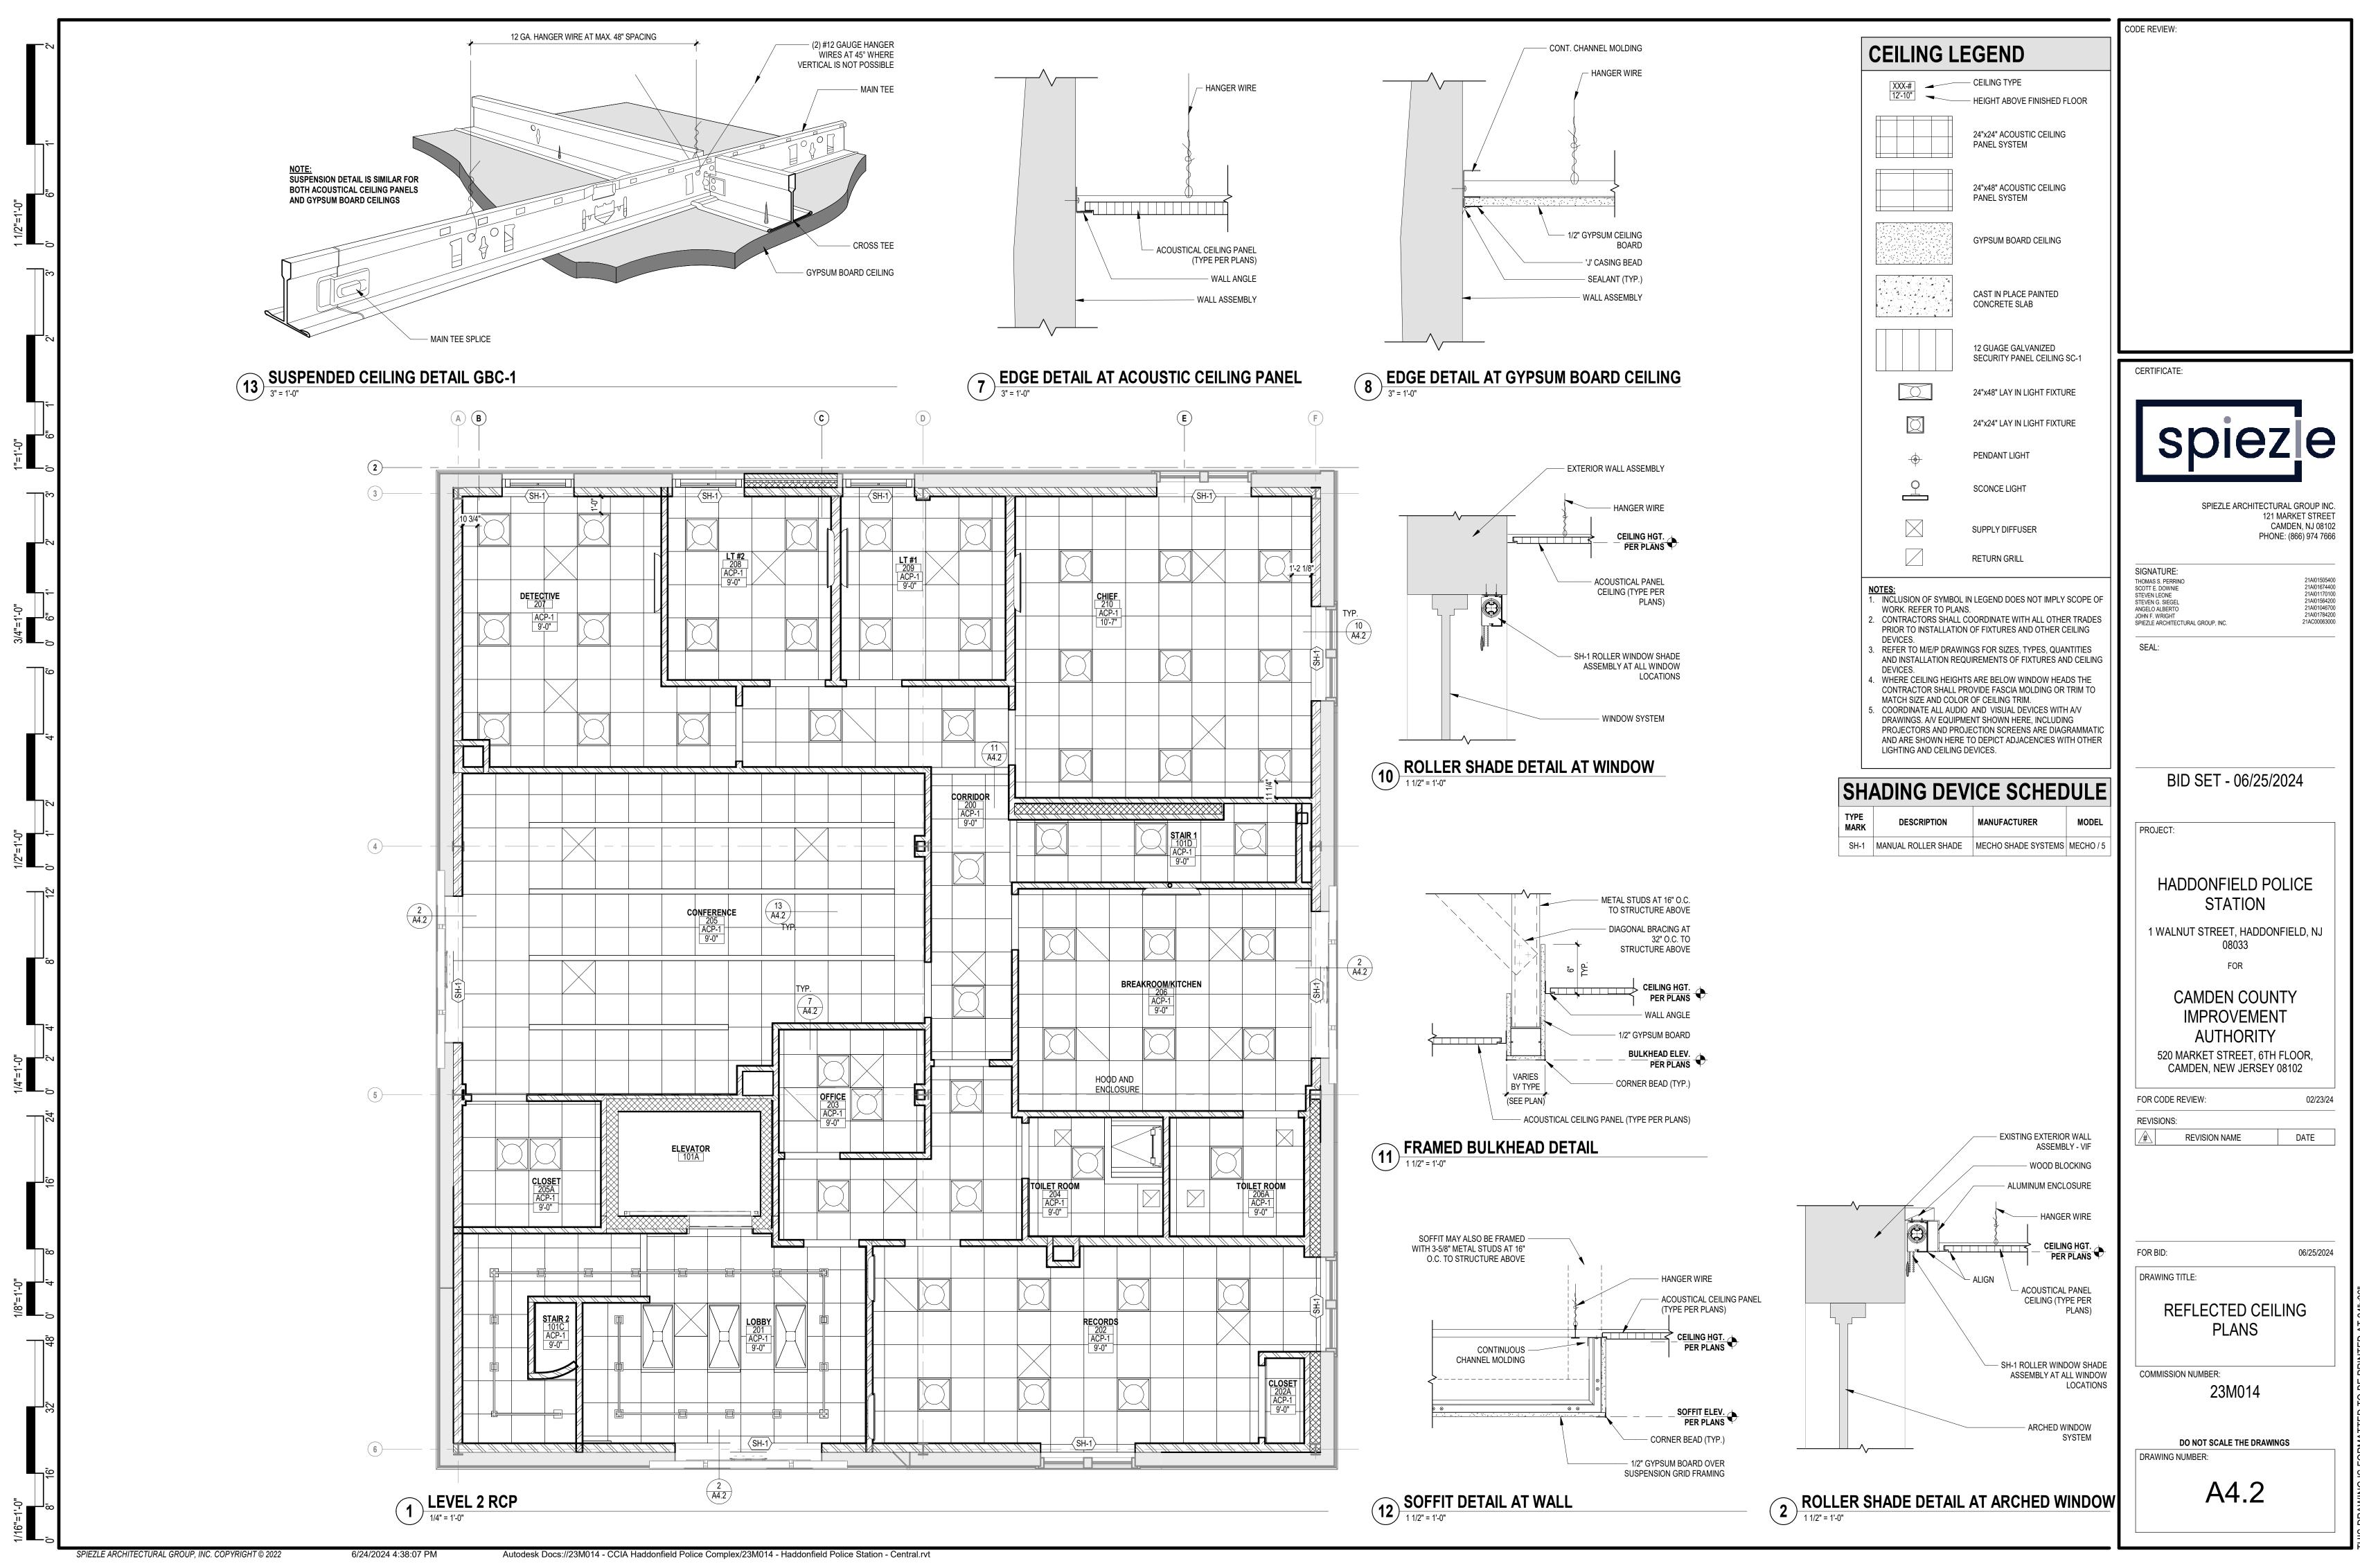


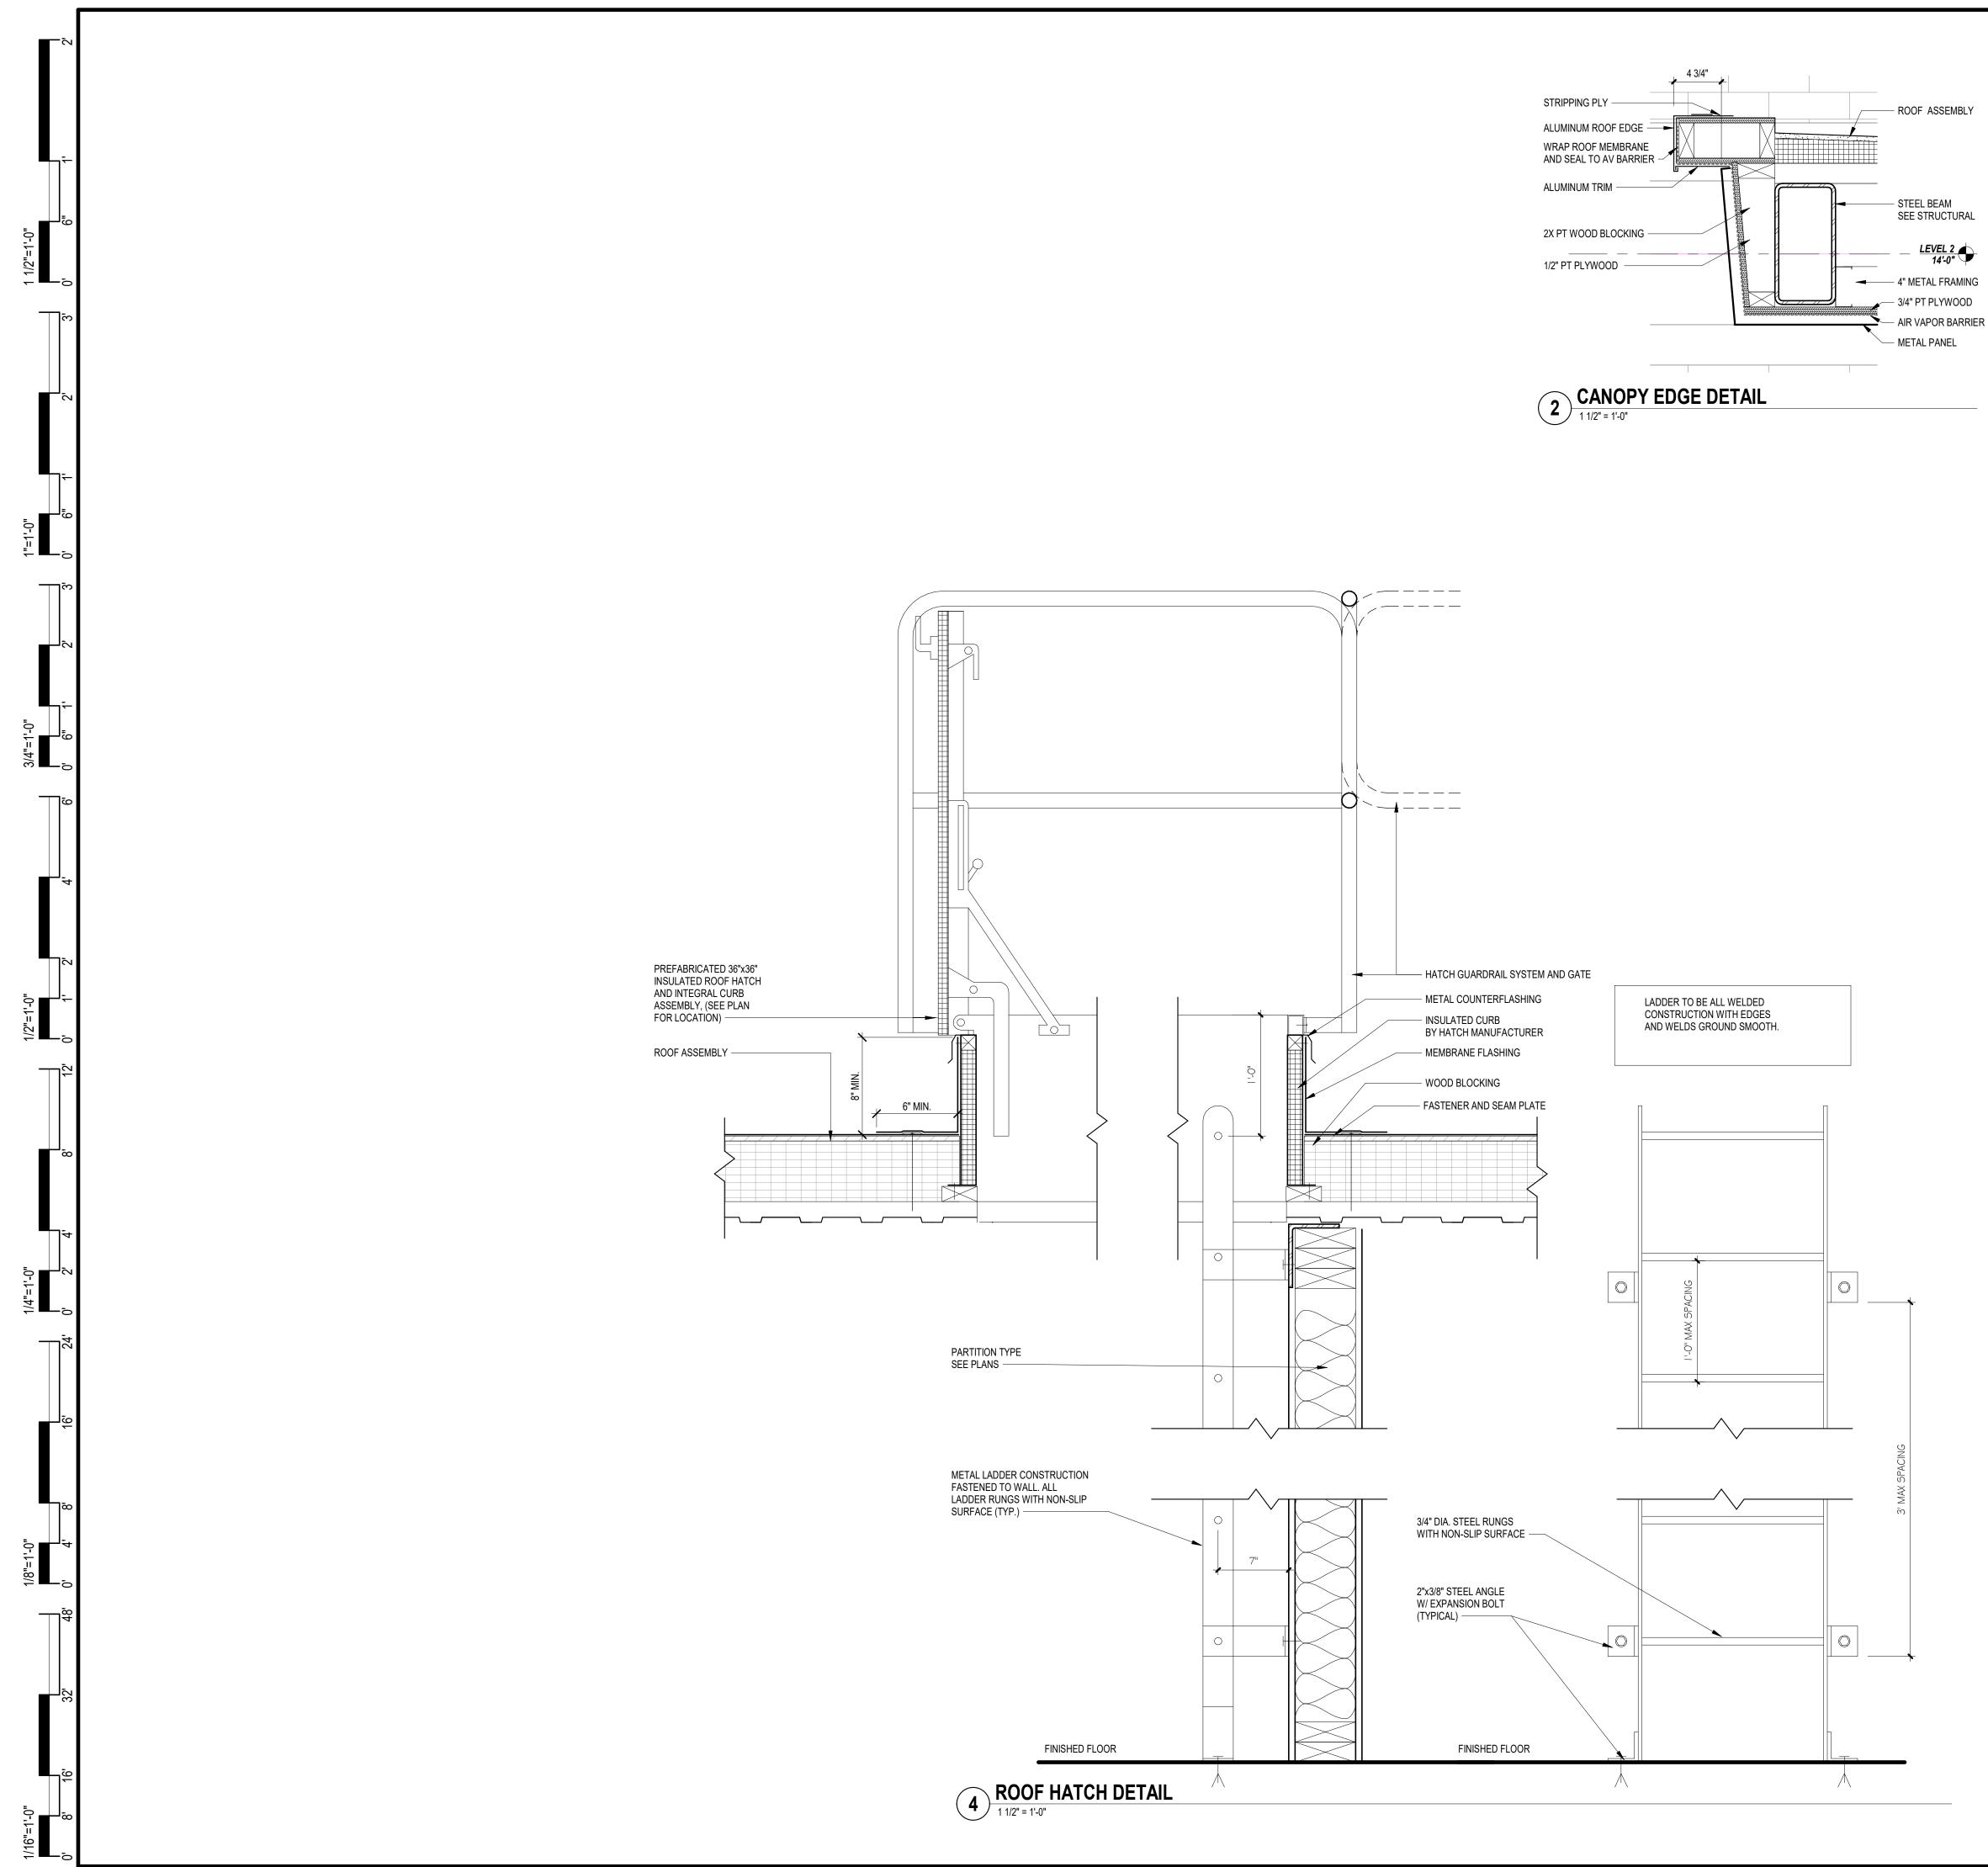


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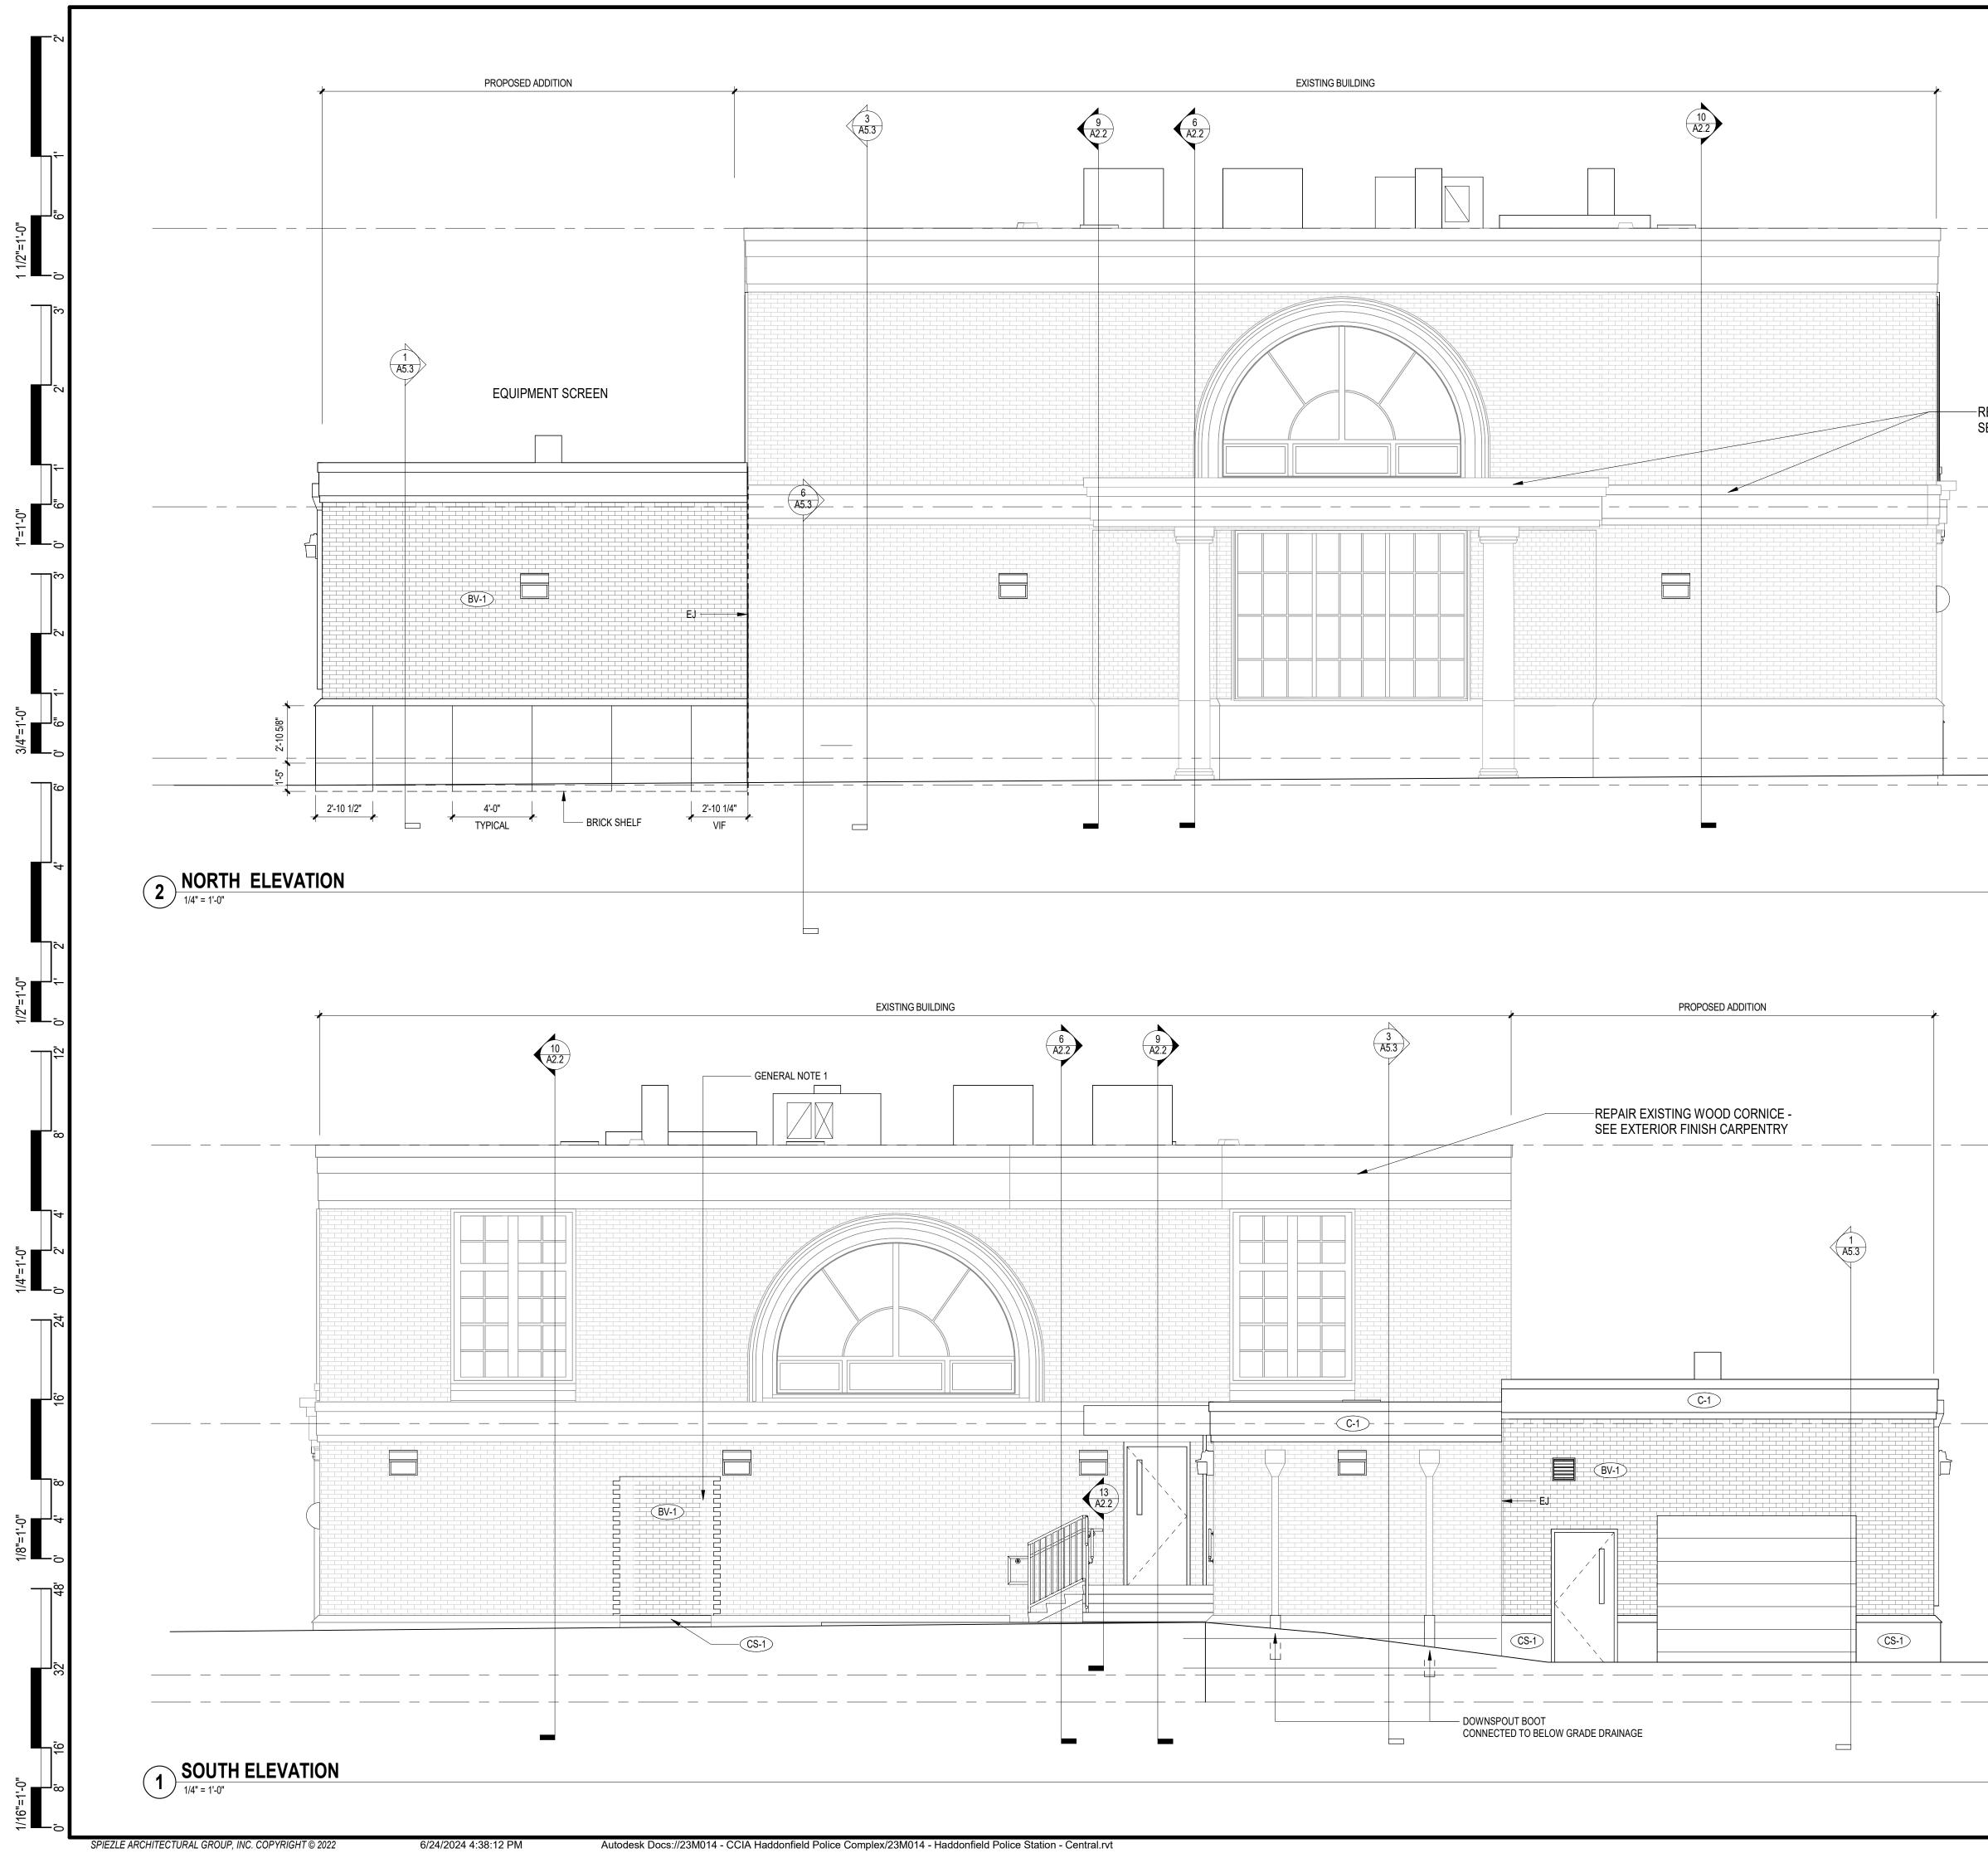




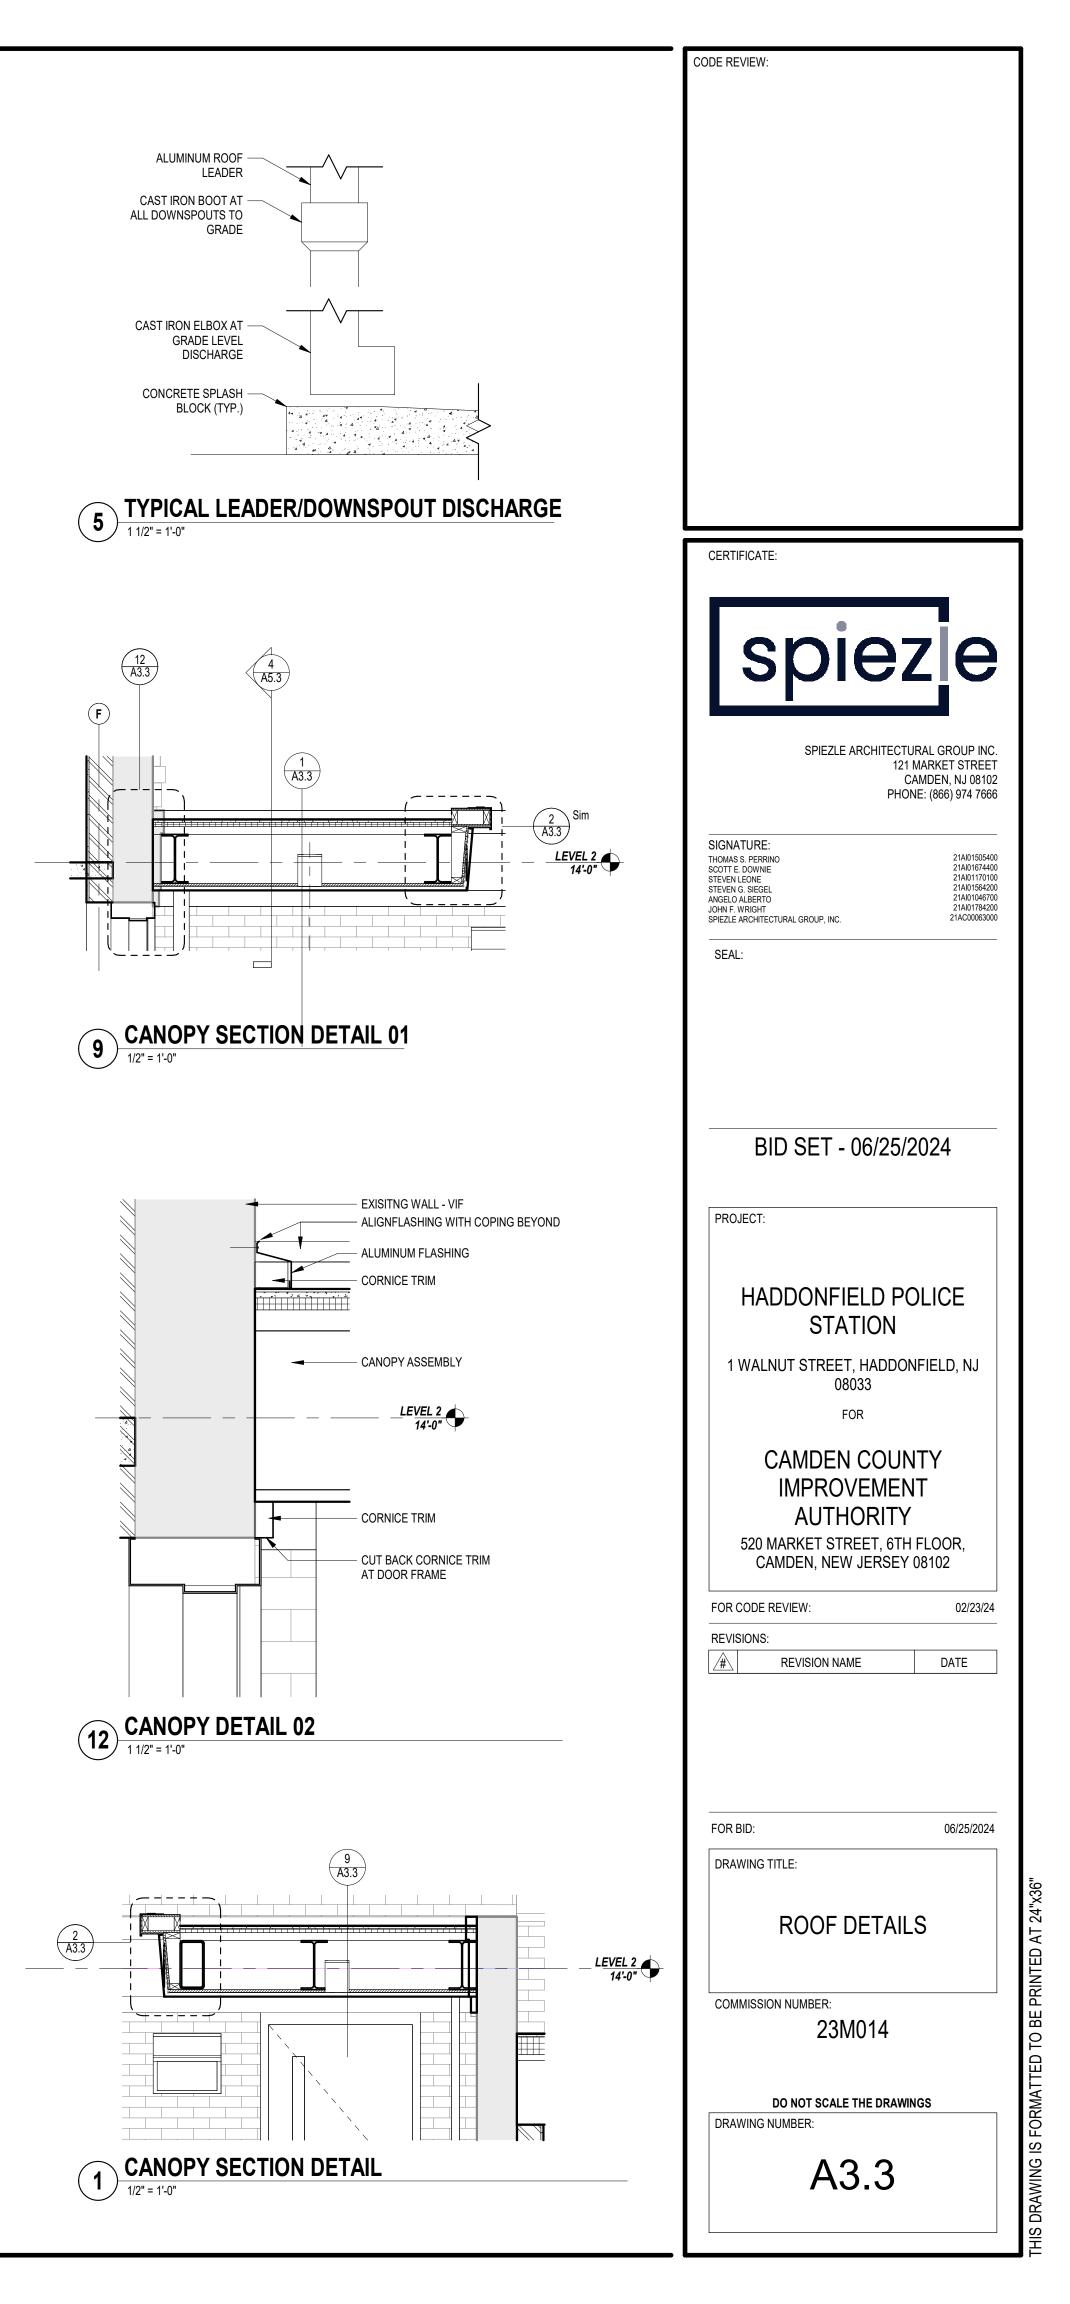


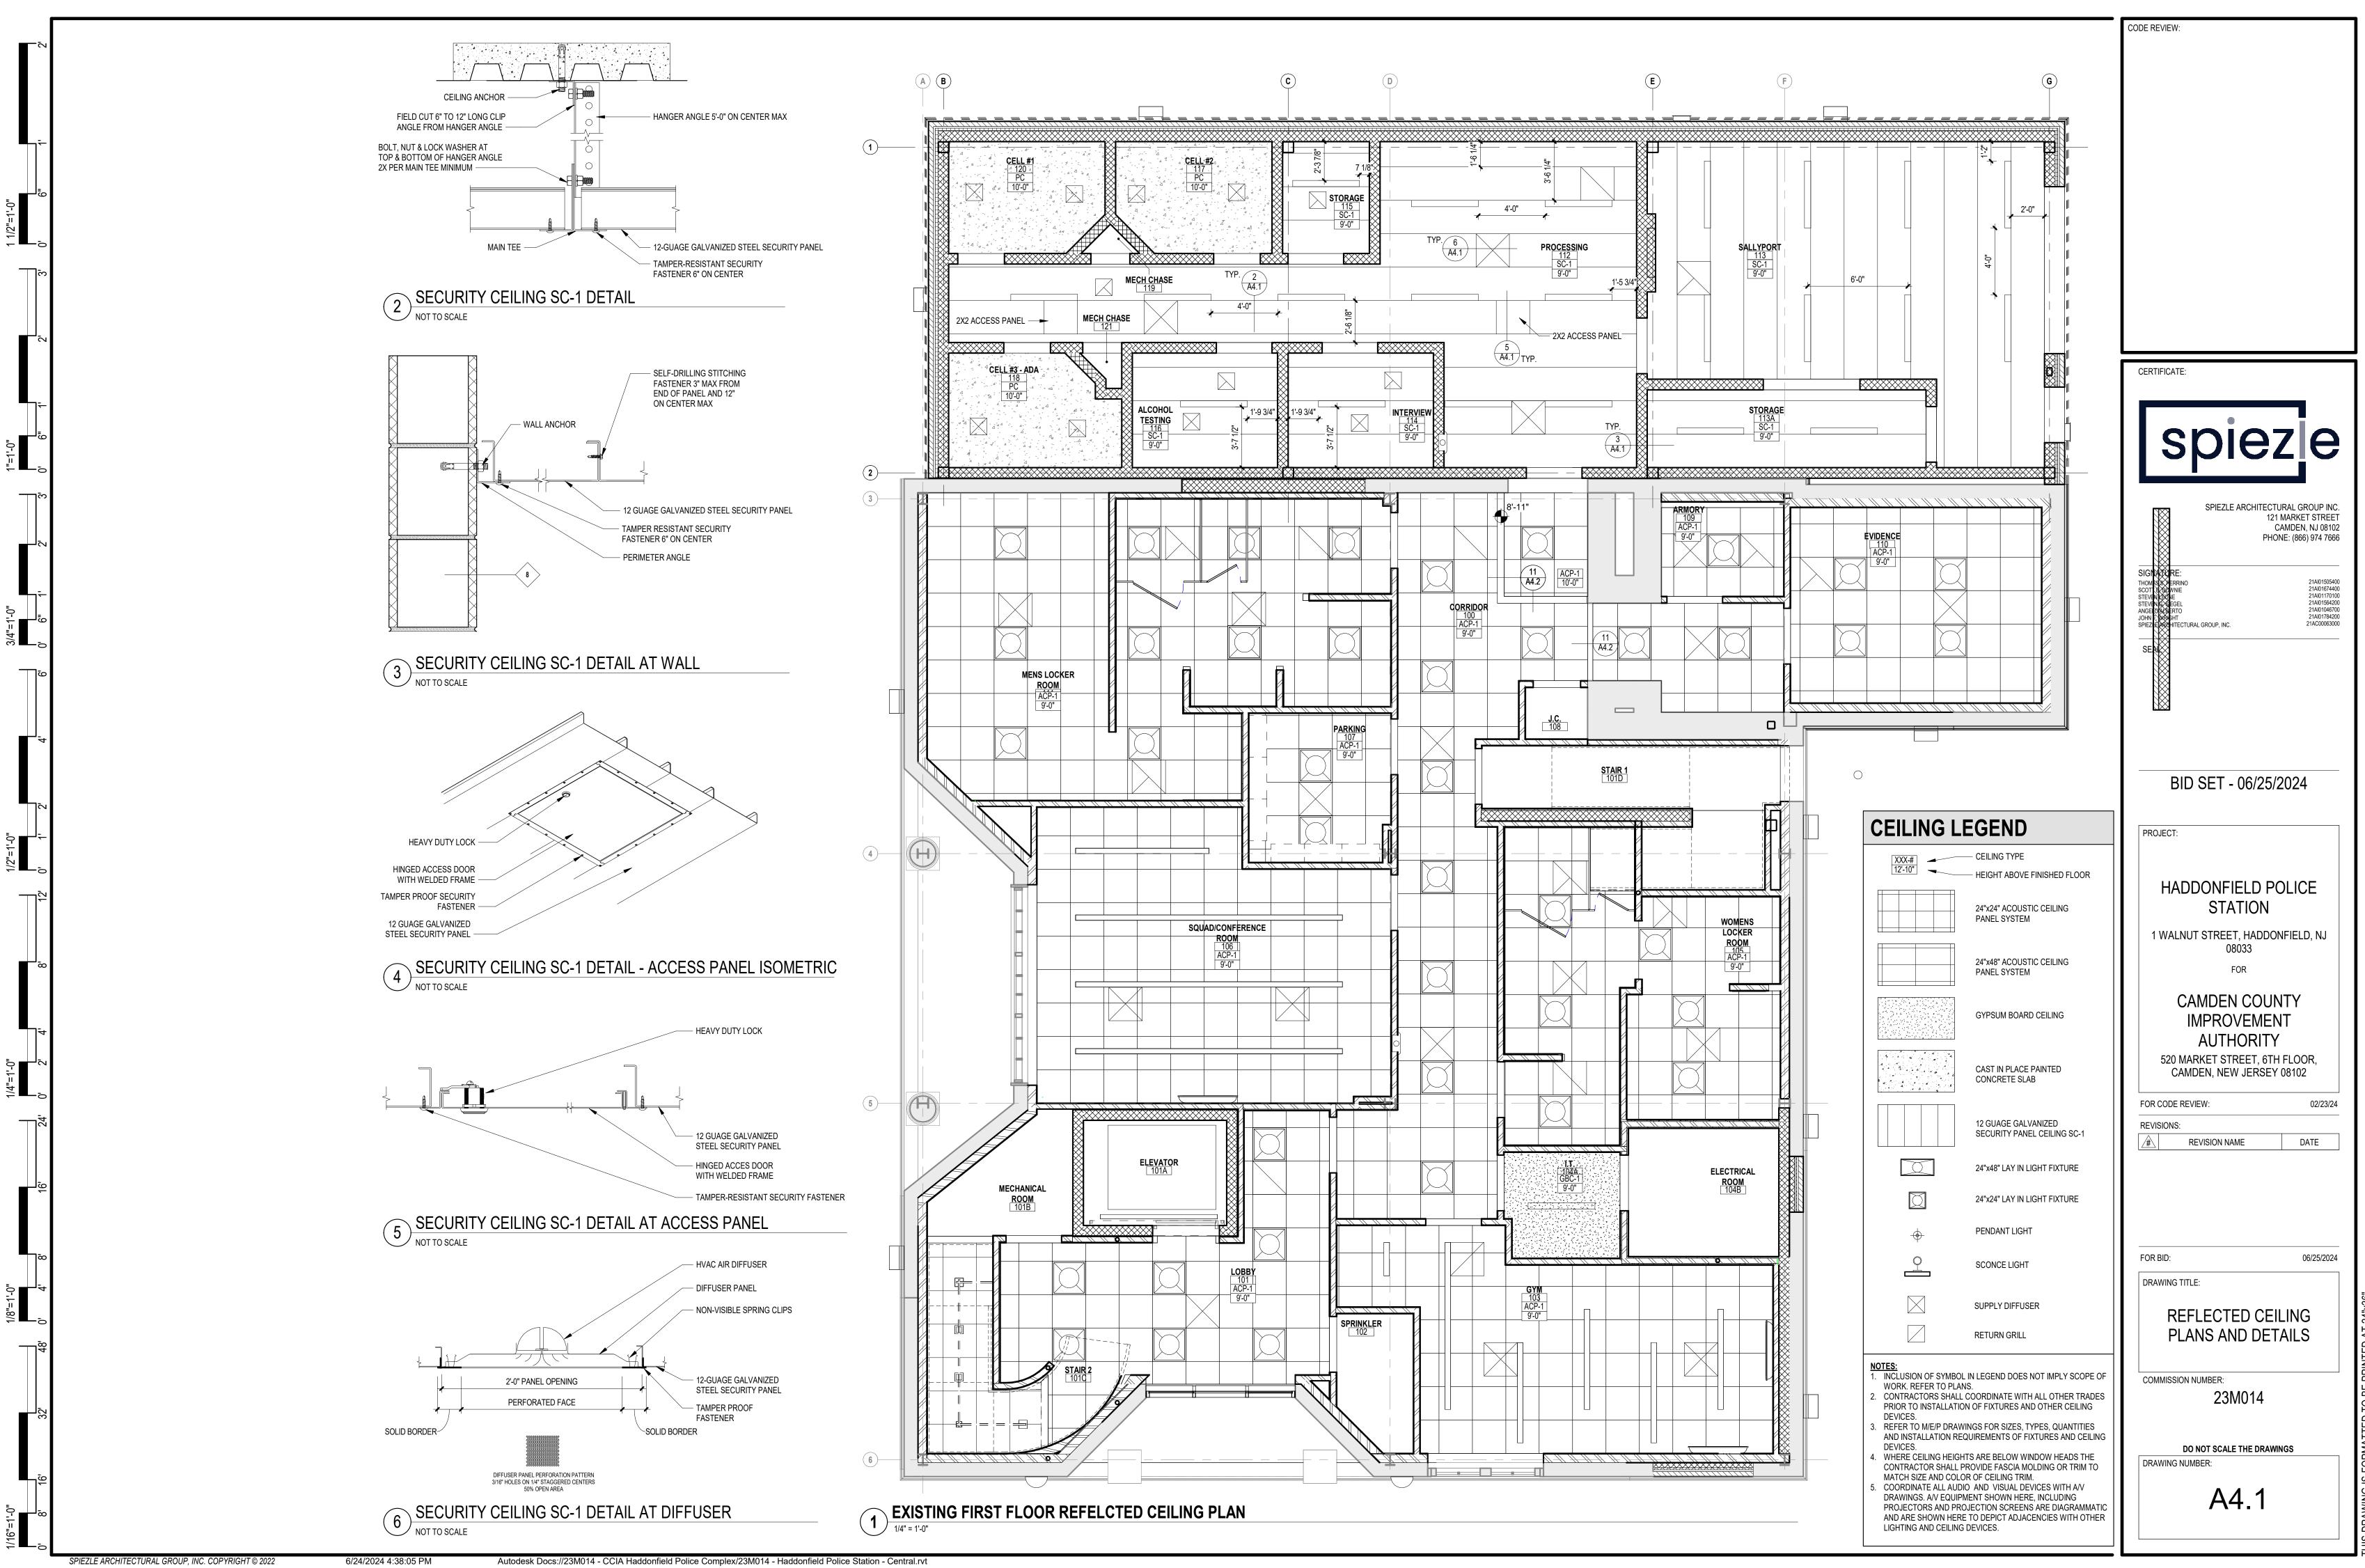


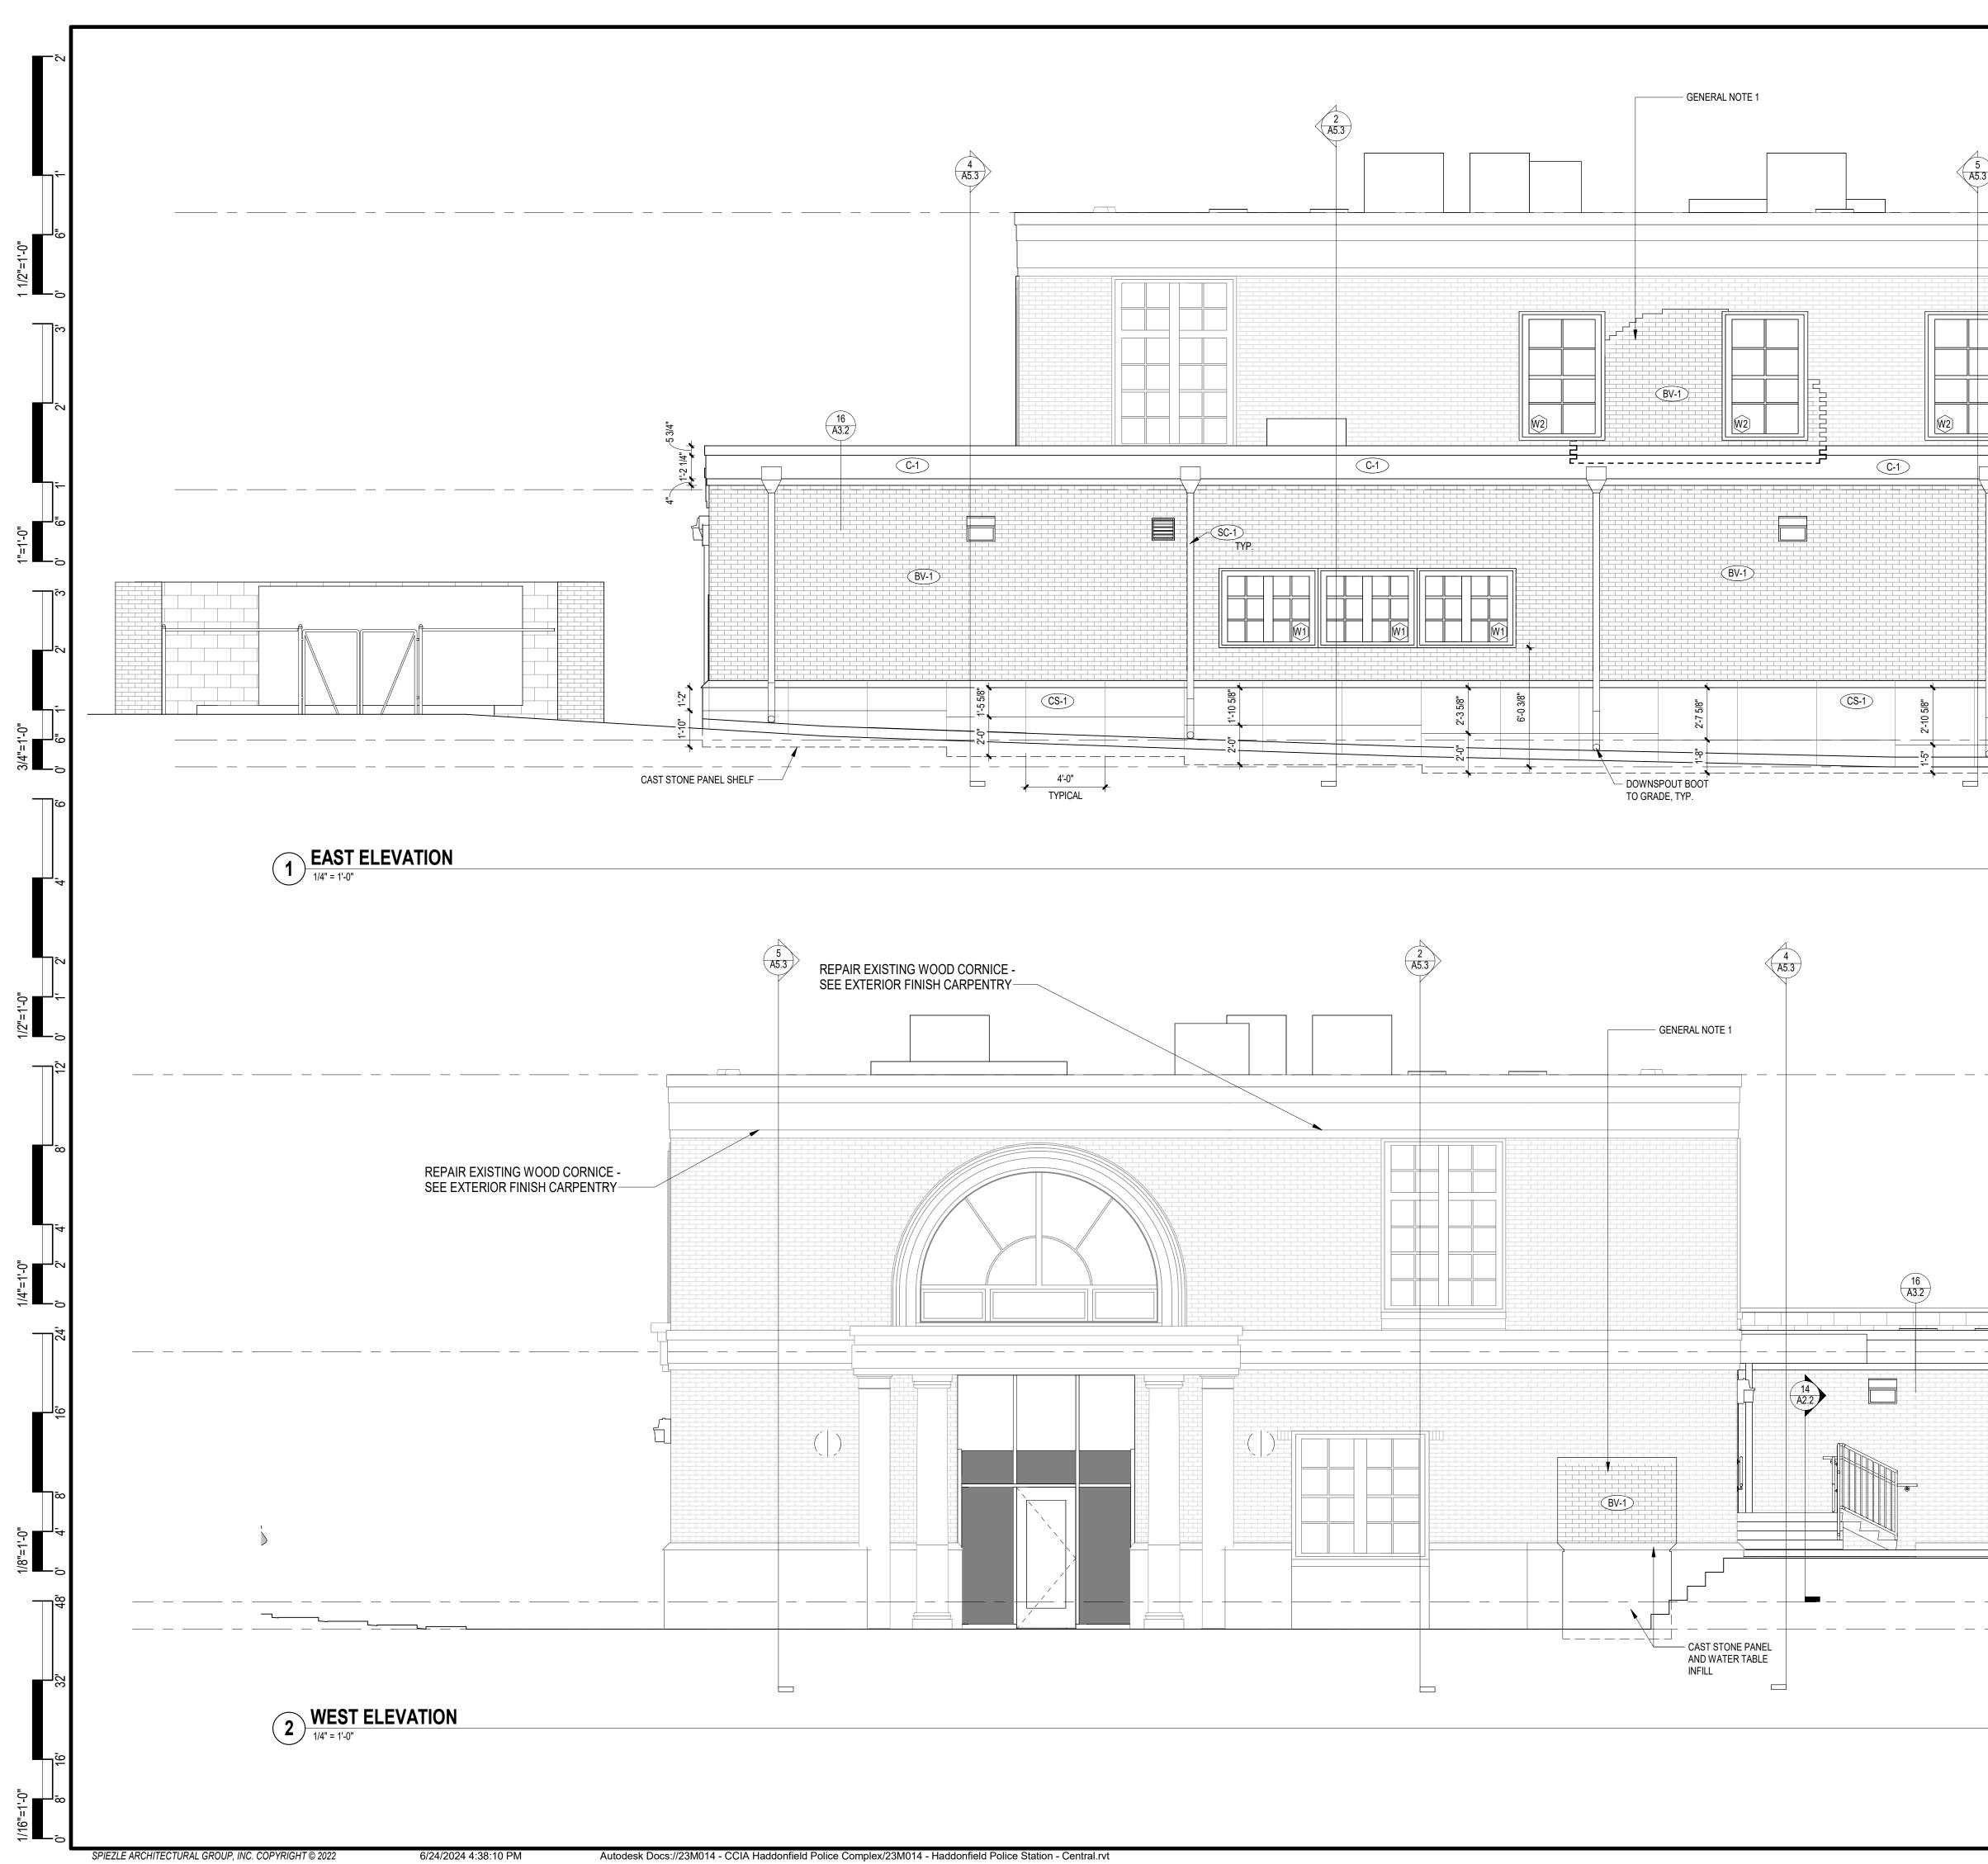EXTERIOR FINIS	HLEGEND:
BV-1     BRICK BLEND       CS-1     CAST STONE PANEL	
CS-1     CAST STONE PANEL       C-1     DECORATIVE CORNICE	
SC-1 SCUPPER / DOWNSPOUT	
TO MATCH	IOTES: INEER AT ALL EXTERIOR WALLS EXISTING. EXISITNG EXTERIOR ISIST OF TWO COLOR BRICK IN A DND PATTERN.
	CERTIFICATE:
	Spieze Architectural Group Inc. 121 Market Street CAMDEN, NJ 08102 PHONE: (866) 974 7666
	SIGNATURE: THOMAS S. PERRINO 21A01505400 SCOTT E. DOWNIE 21A01674400 STEVEN LEONE 21A01170100 STEVEN G. SIEGEL 21A01164700 ANGELO ALBERTO 21A10164700 JOHN F. WRIGHT 21A101784200 SPIEZLE ARCHITECTURAL GROUP, INC. 21AC00063000 SEAL:
	BID SET - 06/25/2024          PROJECT:         HADDONFIELD POLICE         STATION         1 WALNUT STREET, HADDONFIELD, NJ
	FOR CODE REVIEW: 02/23/24
	REVISIONS:
	FOR BID: 06/25/2024       DRAWING TITLE:      EXTERIOR ELEVATIONS
LEVEL 1a 1'-4 3/8" LEVEL 1 0"	
	23M014
	DO NOT SCALE THE DRAWINGS DRAWING NUMBER:
	A5.1



		CODE REVIEW:
	EXTERIOR FINISH LEGEND:	
	BV-1 BRICK BLEND	
	CS-1 CAST STONE PANEL	
	C-1 DECORATIVE CORNICE	
	SC-1 SCUPPER / DOWNSPOUT	
	GENERAL NOTES: 1. BRICK VENEER AT ALL EXTERIOR WALLS	
	TO MATCH EXISTING. EXISITNG EXTERIOR	
	ROOF     FLEMISH BOND PATTERN.	
-REPAIR EXISTING WOOD CORNICE -		
SEE EXTERIOR FINISH CARPENTRY		CERTIFICATE:
	LEVEL 2 14'-0"	spiezle
	14-0"	
		SPIEZLE ARCHITECTURAL GROUP INC. 121 MARKET STREET
		CAMDEN, NJ 08102
		PHONE: (866) 974 7666
		SIGNATURE:
		THOMAS S. PERRINO         21AI01505400           SCOTT E. DOWNIE         21AI01674400
		STEVEN LEONE         21AI01170100           STEVEN G. SIEGEL         21AI01564200           ANGELO ALBERTO         21AI01046700
		JOHN F. WRIGHT 21AI01784200 SPIEZLE ARCHITECTURAL GROUP, INC. 21AC00063000
	LEVEL 1a 1'-4 3/8"	SEAL:
	LEVEL 1	
	0" 🗸	
		BID SET - 06/25/2024
		PROJECT:
		HADDONFIELD POLICE
		STATION
		1 WALNUT STREET, HADDONFIELD, NJ
		08033
		FOR
	20-0 4	
		520 MARKET STREET, 6TH FLOOR, CAMDEN, NEW JERSEY 08102
		FOR CODE REVIEW: 02/23/24
		REVISIONS:
		REVISION NAME DATE
	<u>LEVEL 2</u> 14'-0"	
	ד <b>י</b> די, די	
		FOR BID: 06/25/2024
		DRAWING TITLE:
		EXTERIOR ELEVATIONS
		COMMISSION NUMBER:
		23M014
	<u>LEVEL 1a</u> 1'-4 3/8" •	
	<u>LEVEL 1</u>	
	<b>v</b> ⊤	DO NOT SCALE THE DRAWINGS DRAWING NUMBER:
		A5.2

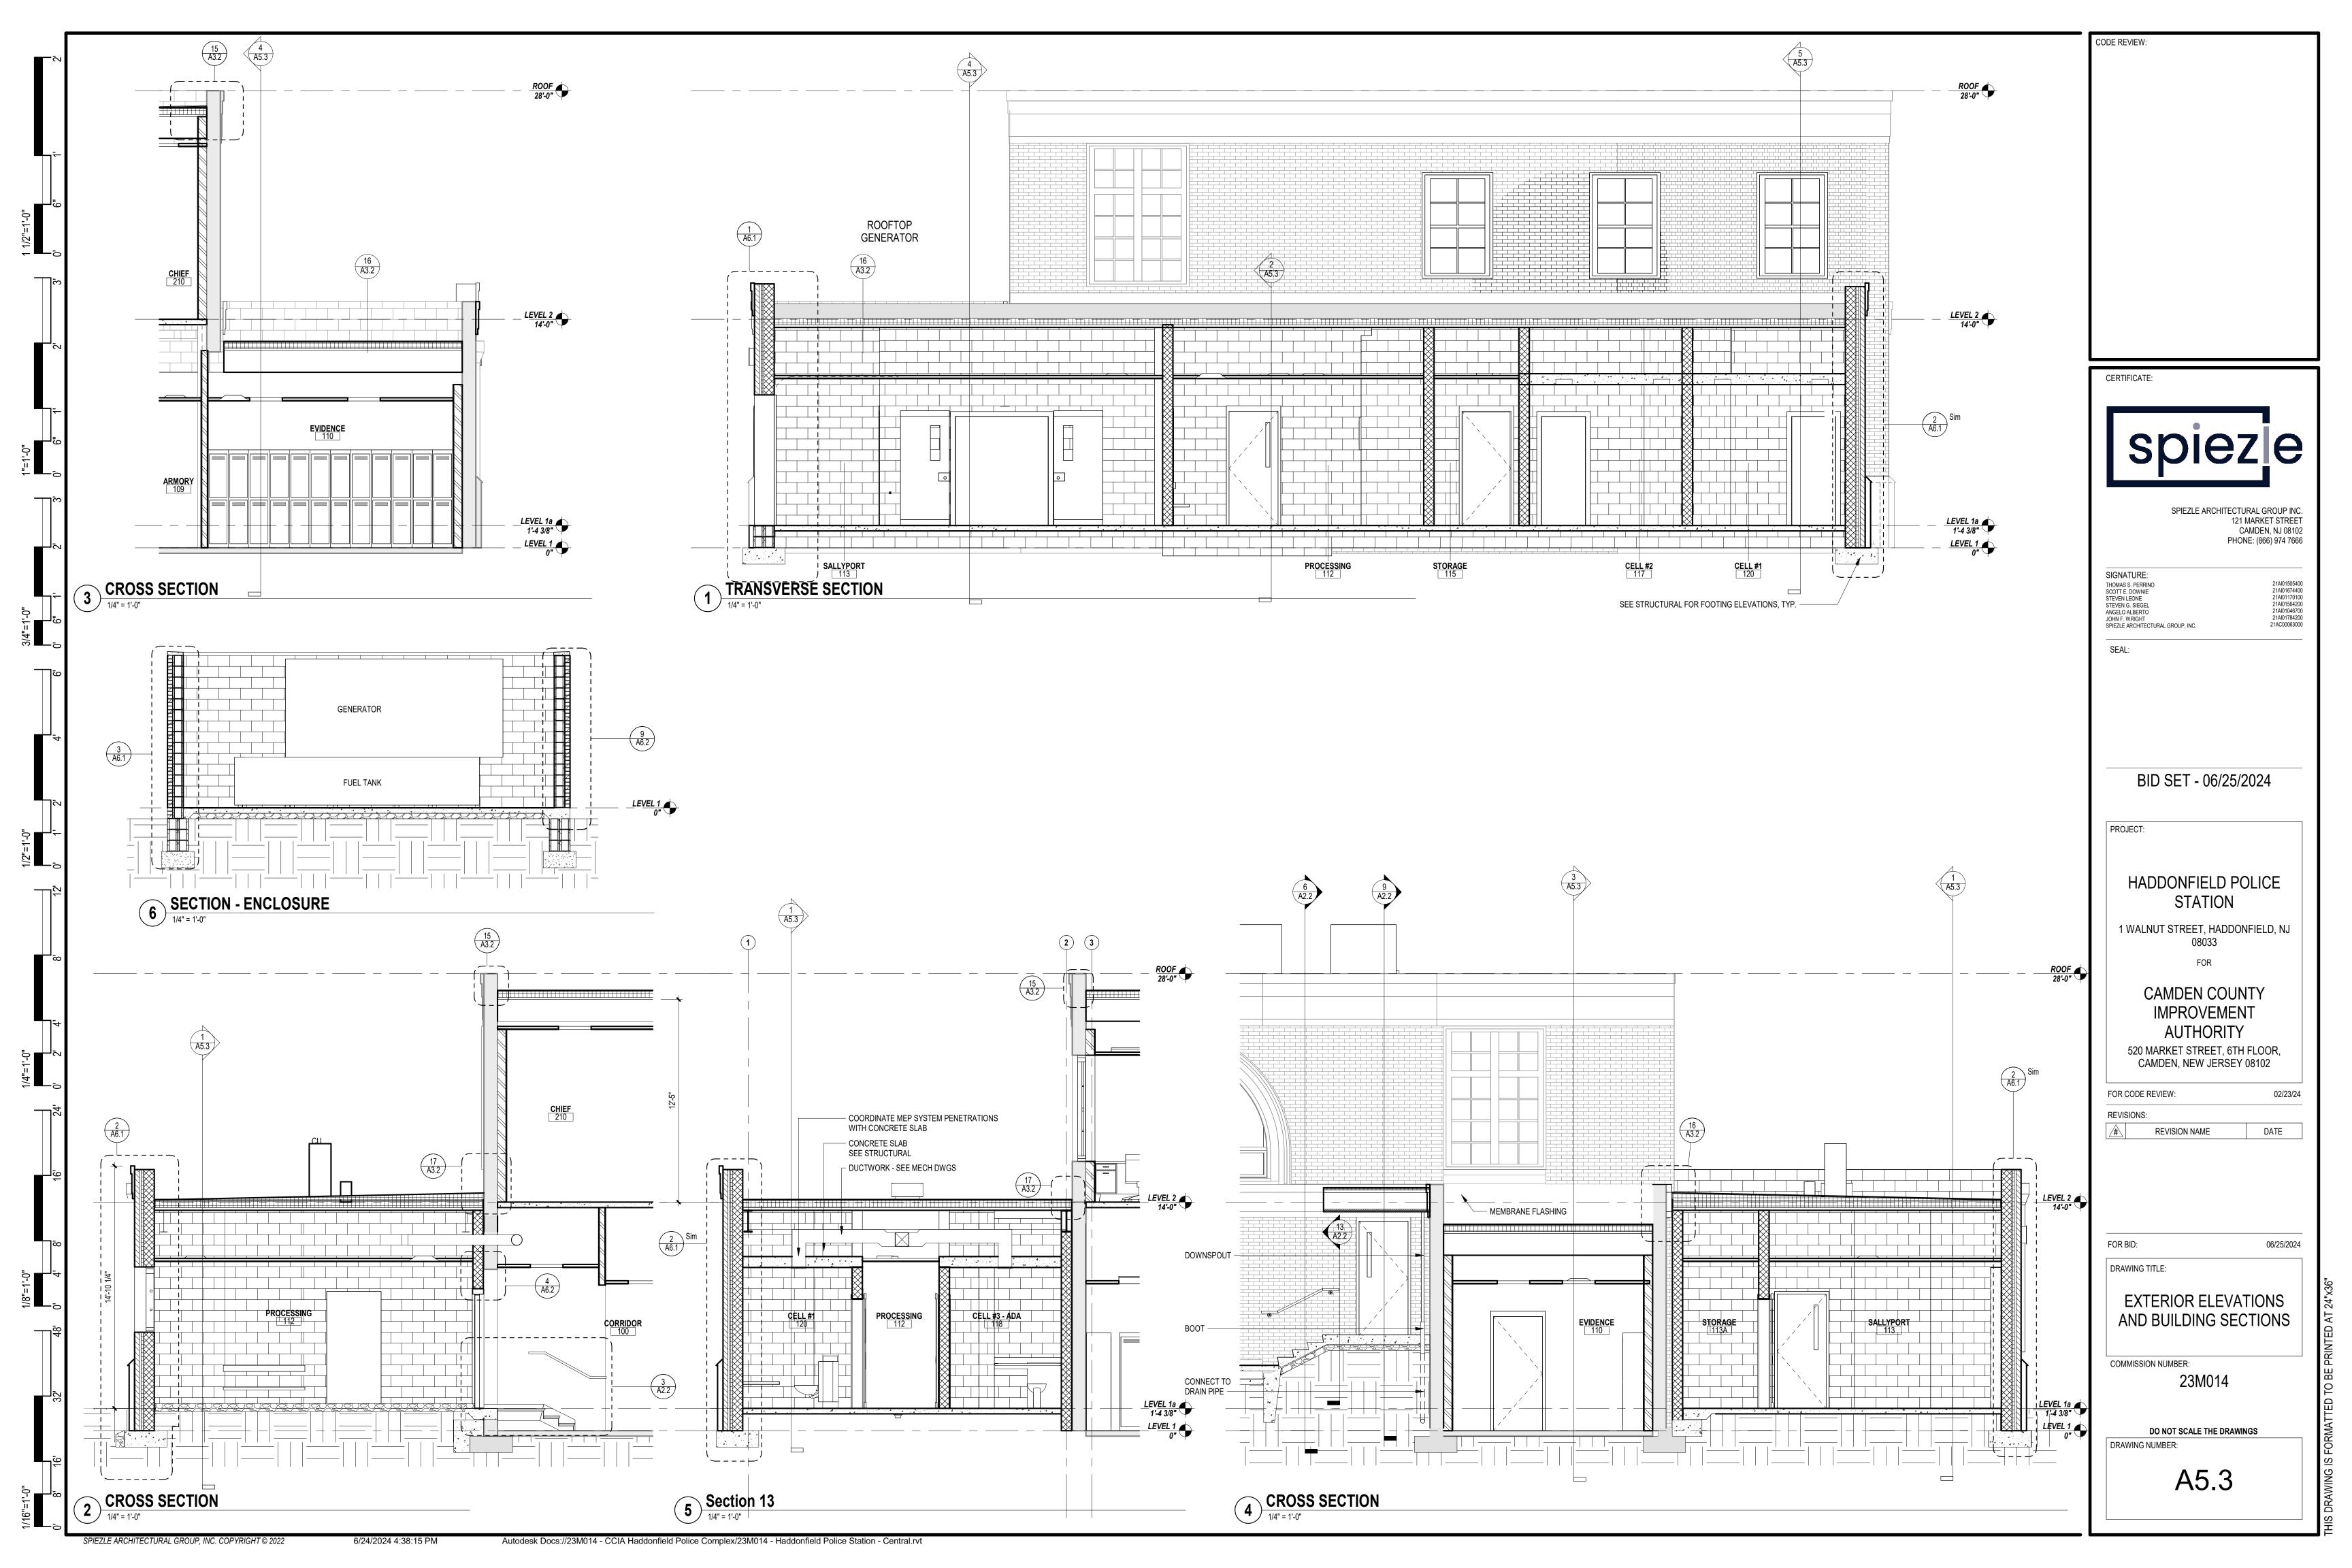


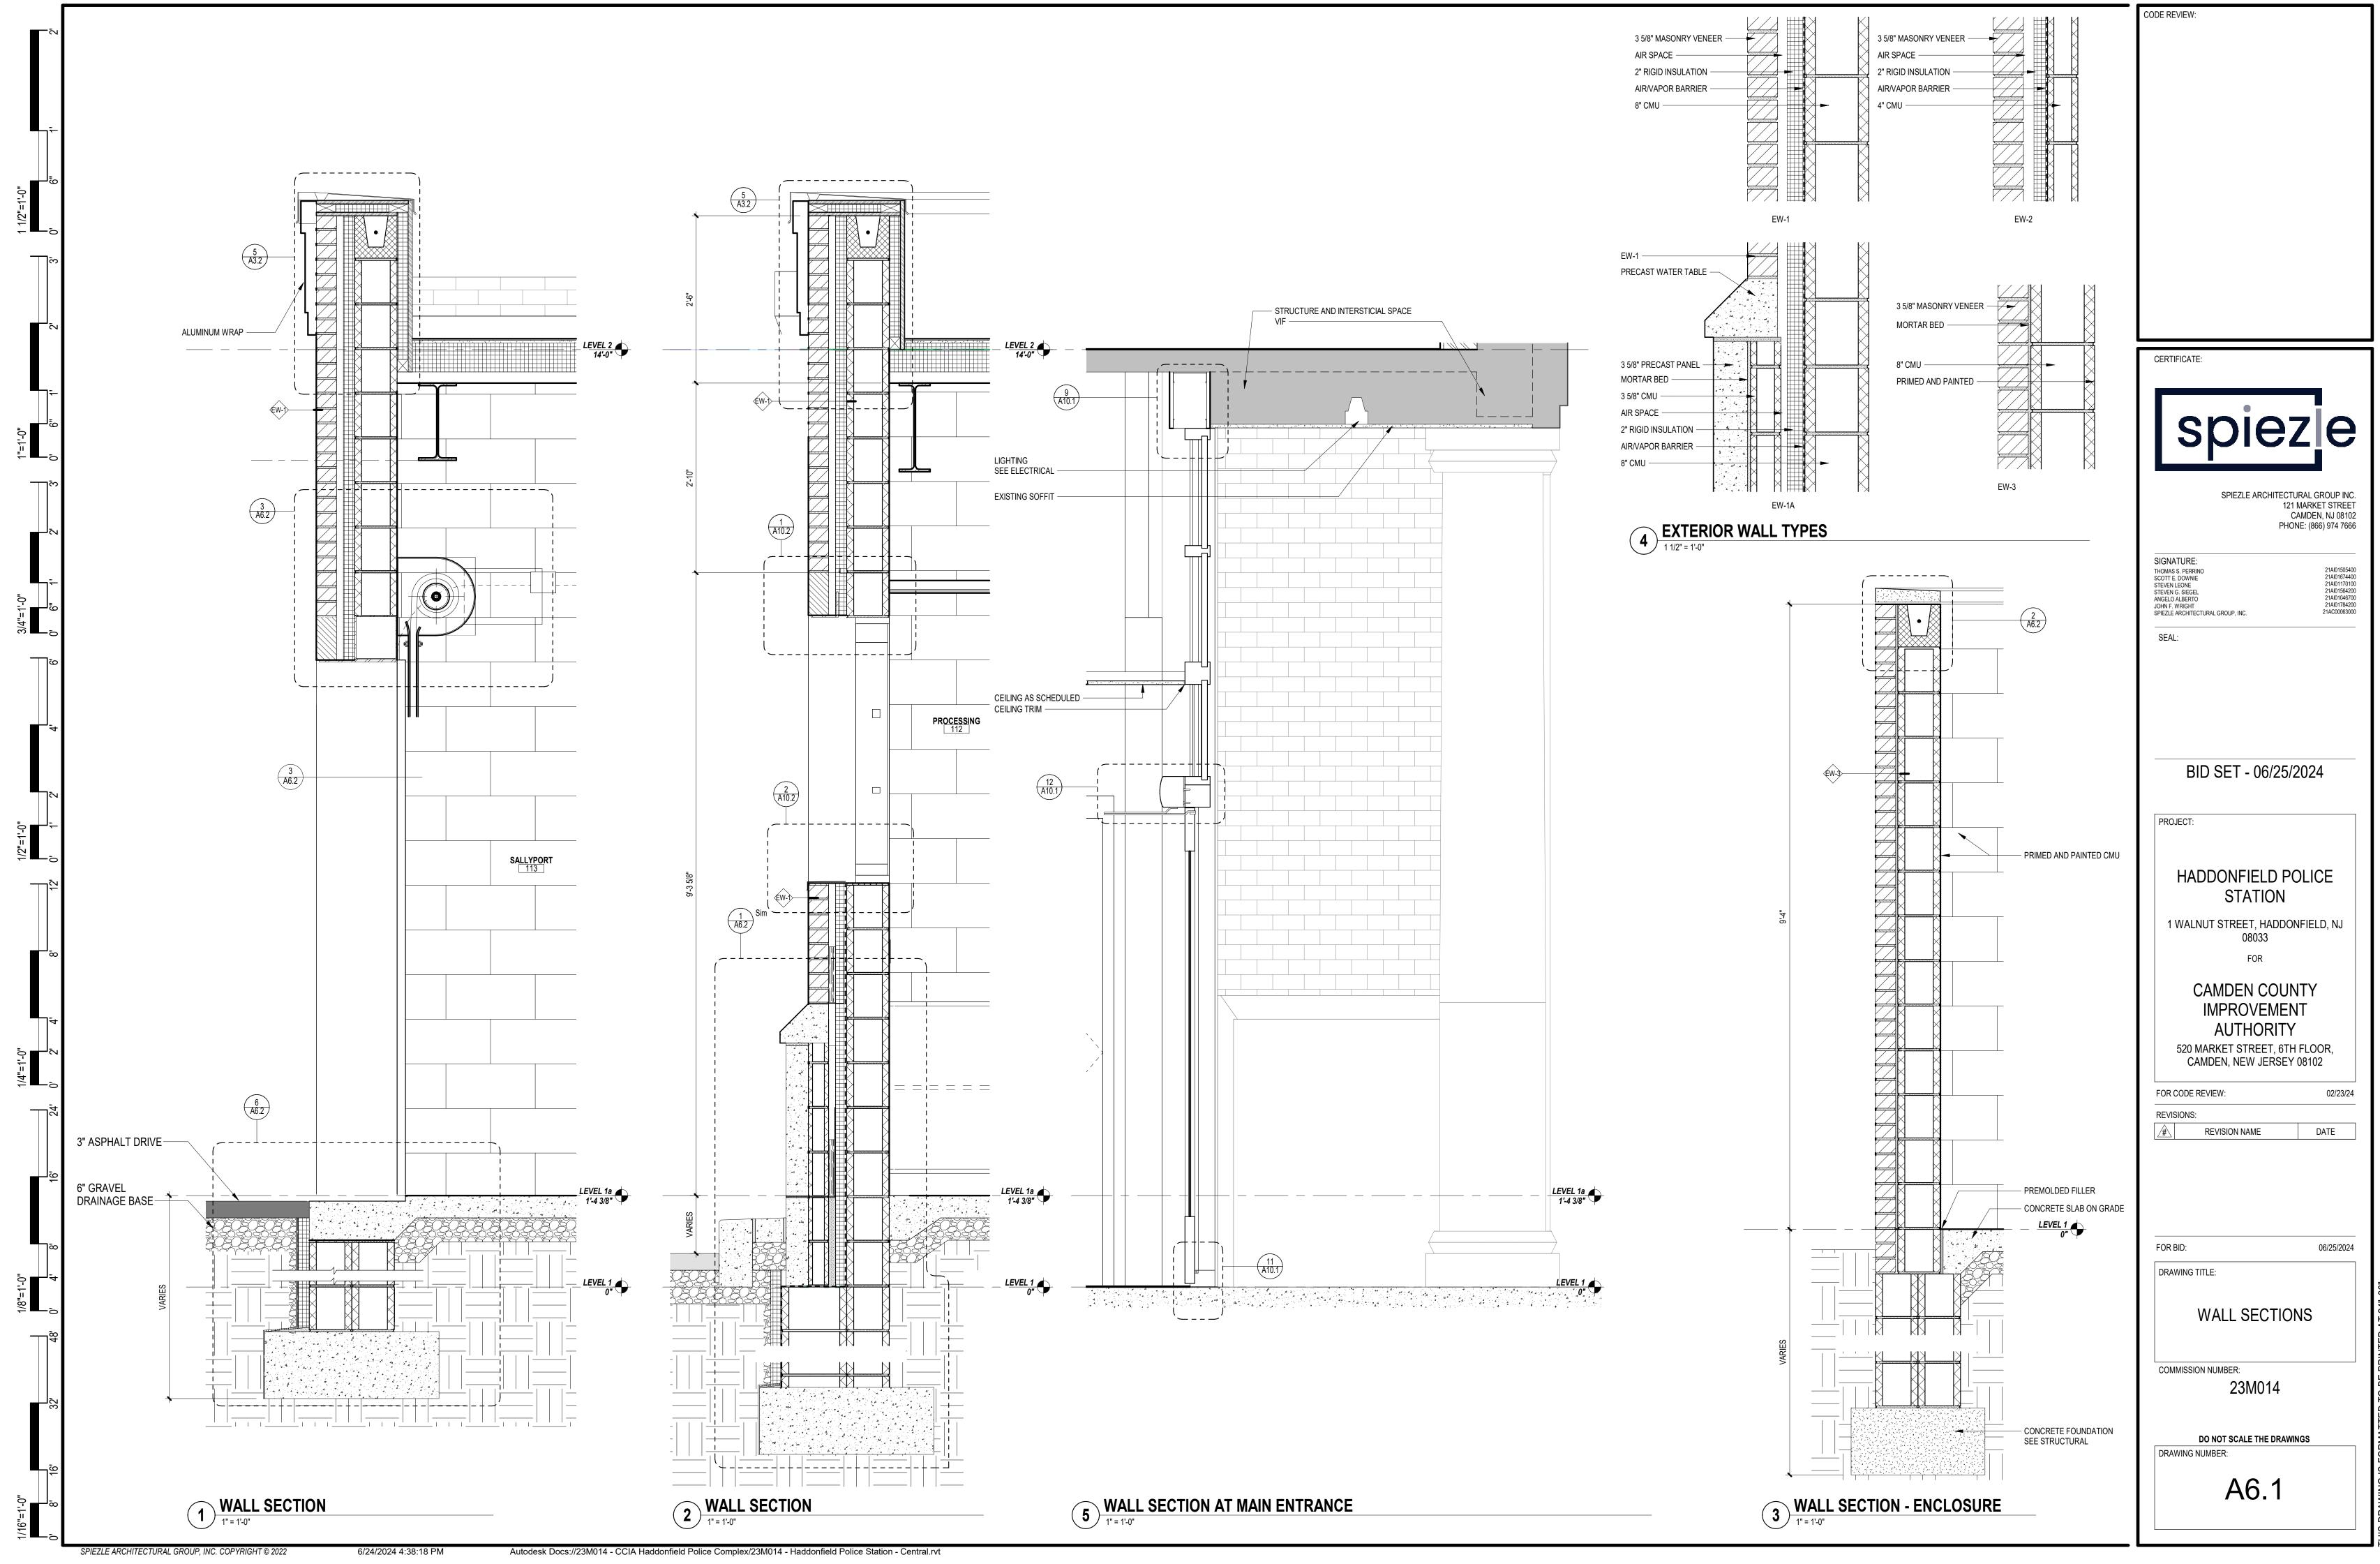

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SPIEZLE ARCHITECTURAL GROUP, INC. COPYRIGHT © 2022





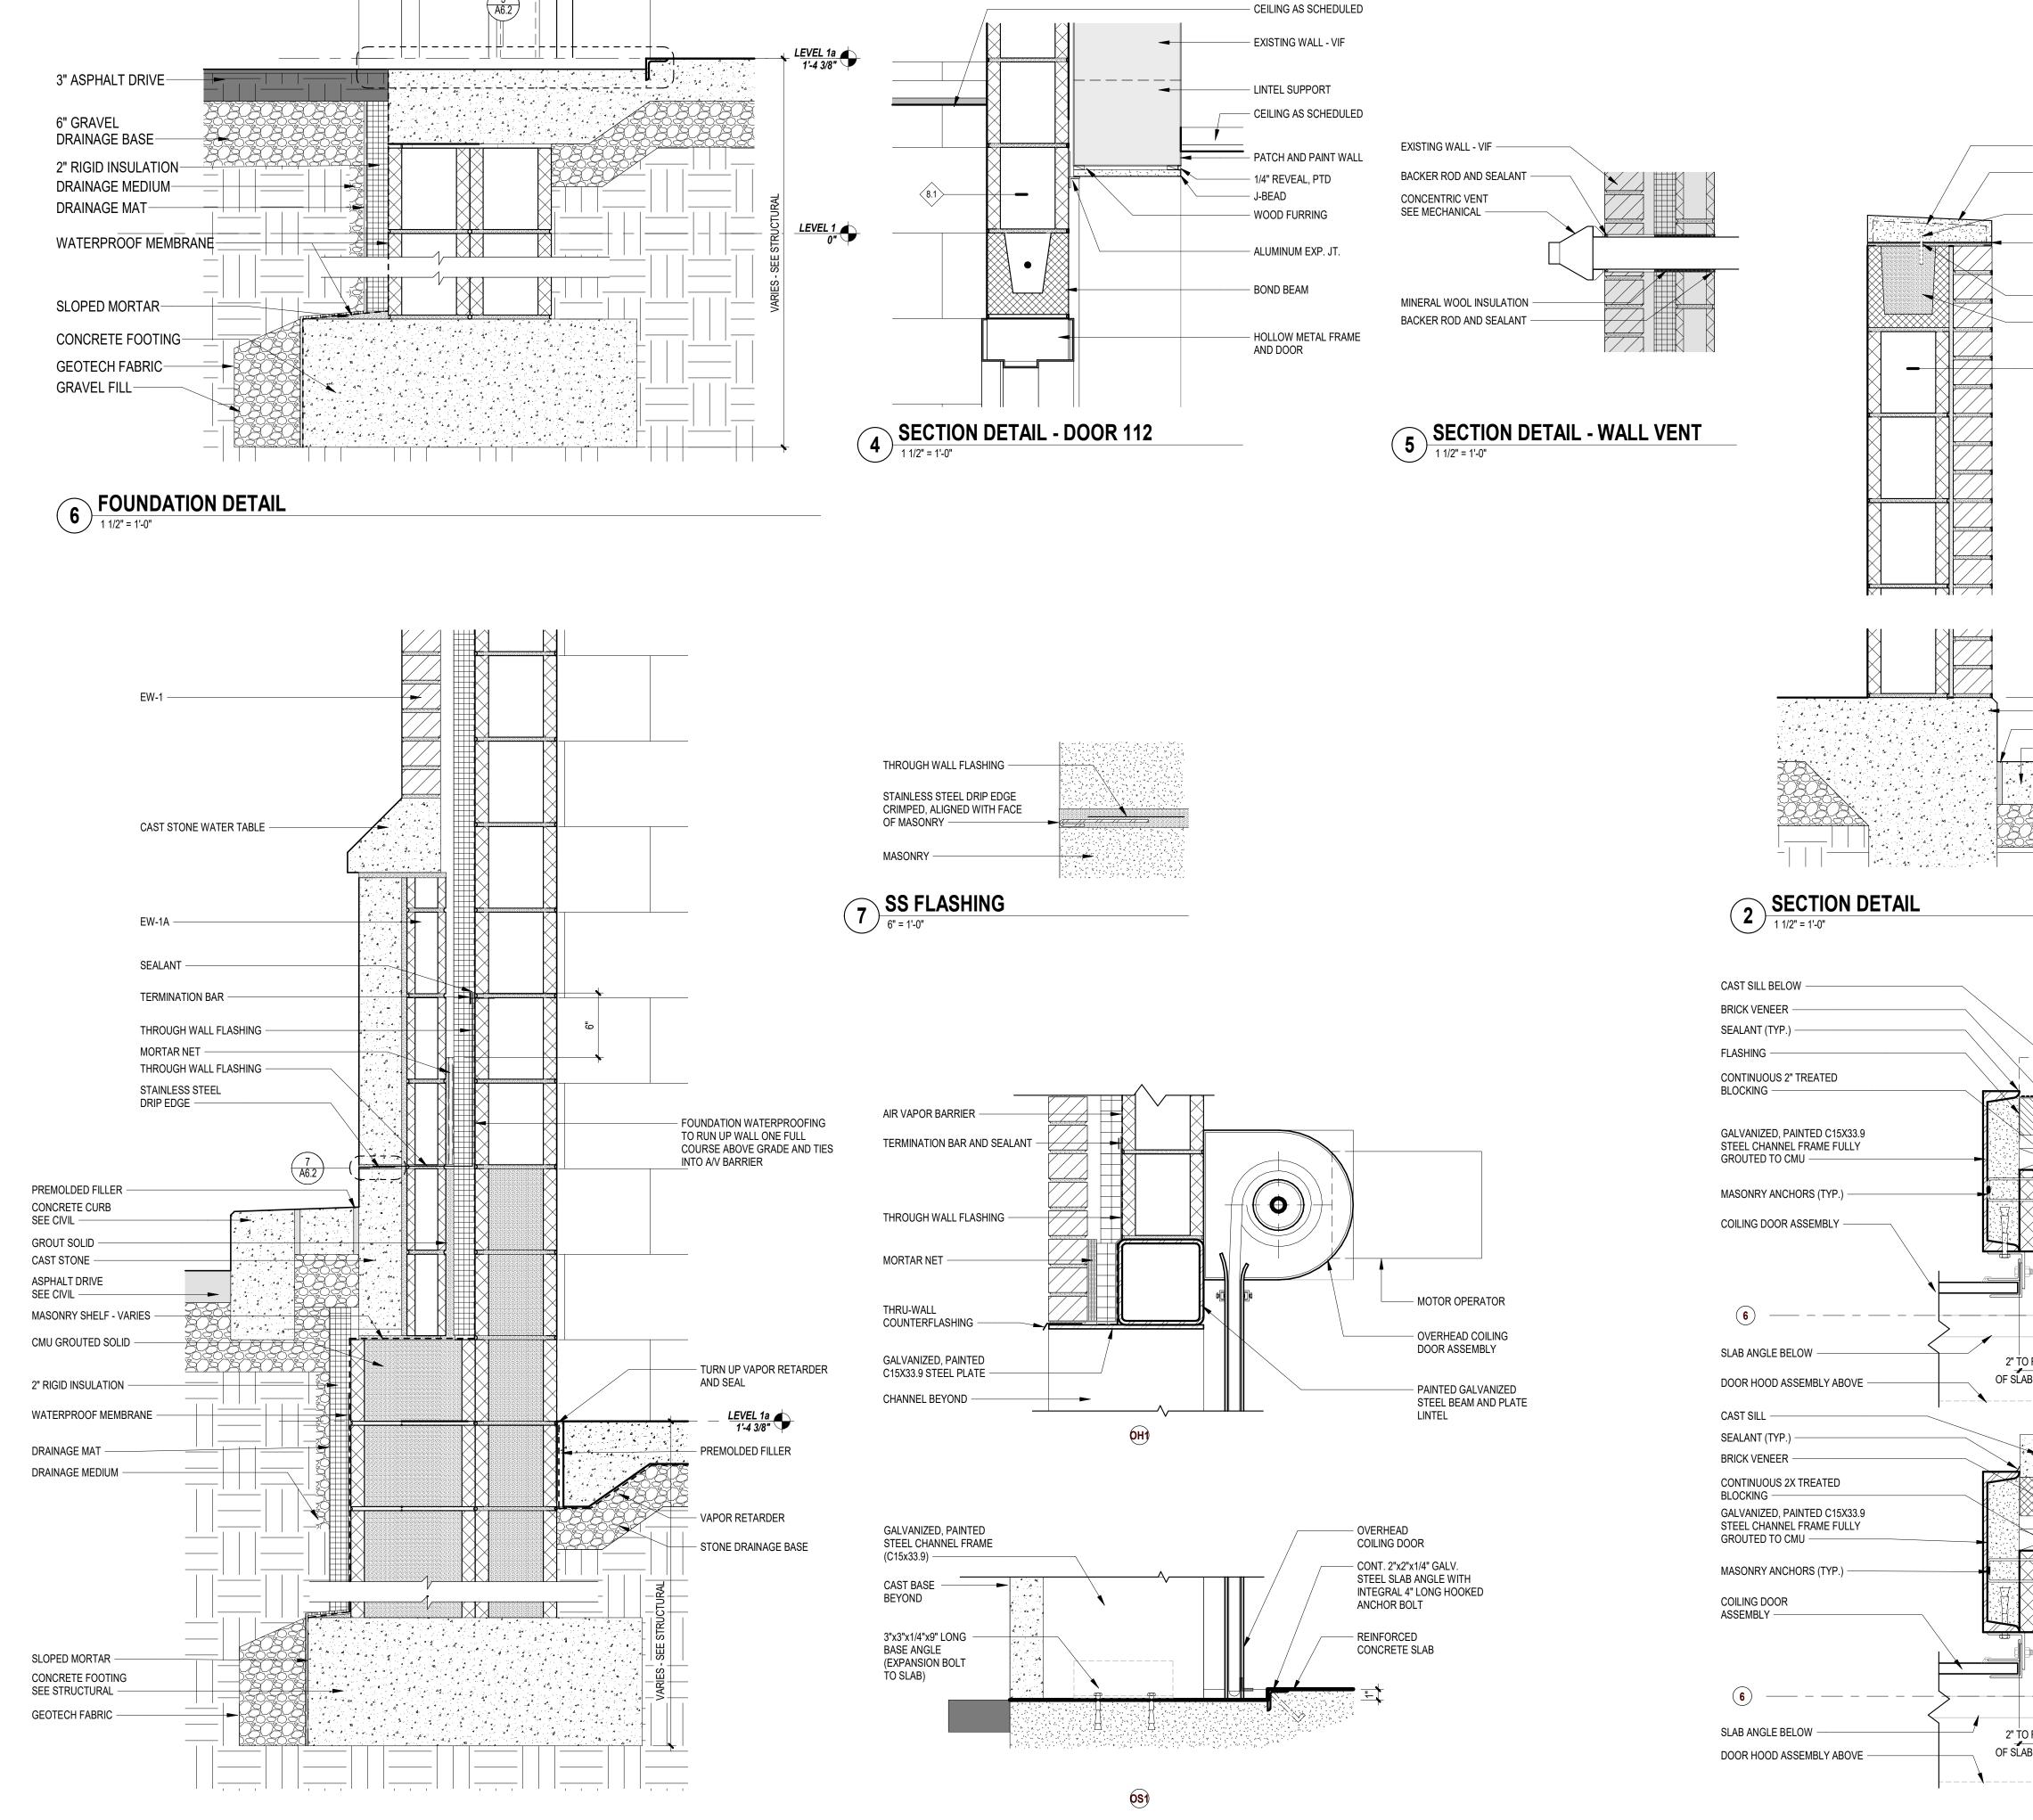

1 1/2"=1

1"=1'-0"


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1/2"=


1/4"=1'

1/8"=1


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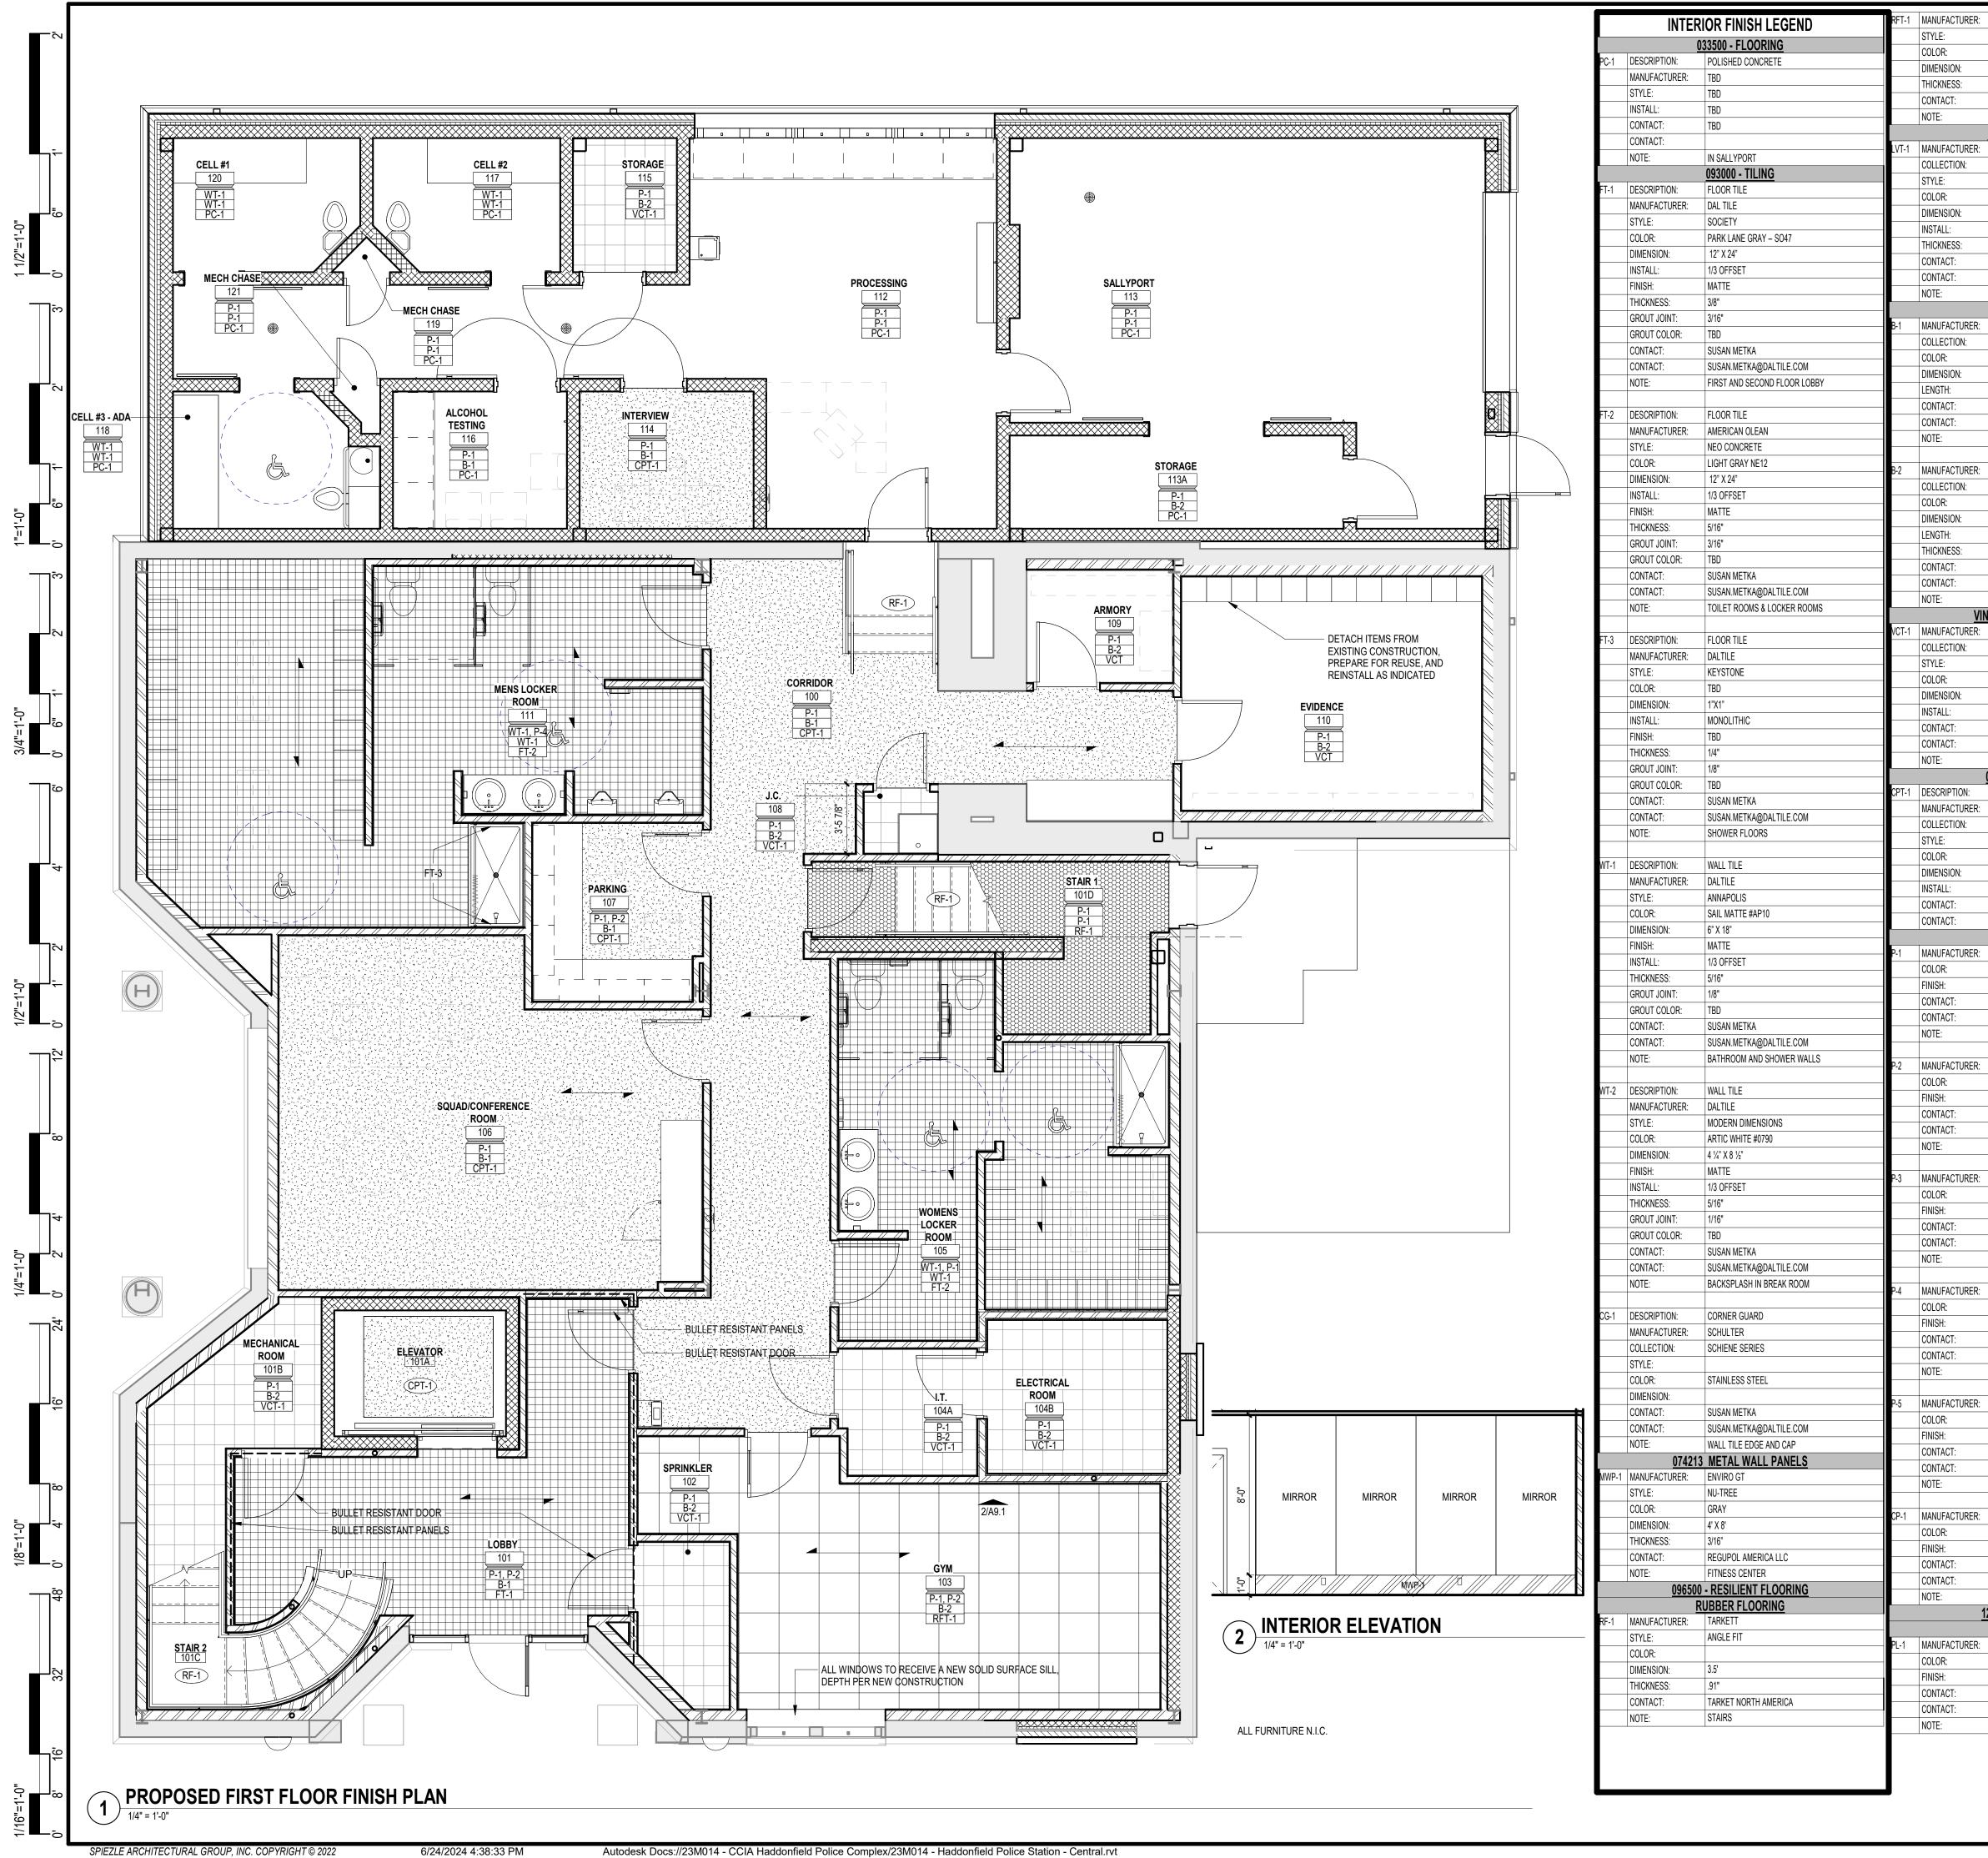


	CODE REVIEW:
- CAST STONE COPING	
- BACKER ROD AND SEALANT AT ALL EXPOSED JOINTS	AST STONE
DOWEL SET IN EPOXY CC	OPING BEYOND ACKER ROD AND
WITH CRIMED DRIP EDGE	ALANT ALL EXPOSED JOINTS
	OSED CELL CMU ID BLOCK BEYOND
-EW.3	RICK VENEER EYOND
	CERTIFICATE:
	TALL CHAINLINK INCE AND GATES Spieze
	SPIEZLE ARCHITECTURAL GROUP INC.
	121 MARKET STREET CAMDEN, NJ 08102 PHONE: (866) 974 7666
	ONCRETE SLAB OLED EDGE - VERTICAL SIGNATURE:
	MENSION NOT TO         THOMAS S. PERRINO         21AI01505400           CEED 1"         SCOTT E. DOWNIE         21AI01674400           STEVEN LEONE         21AI0167170100           STEVEN G. SIEGEL         21AI01564200
	ANGELO ALBERTO 21AI01046700 JOHN F. WRIGHT 21AI01784200 SPIEZLE ARCHITECTURAL GROUP, INC. 21AC00063000
- CONCRETE WALK	SEAL:
= $         -$	
9 SECTION DETAIL 1 1/2" = 1'-0"	BID SET - 06/25/2024
EW1	PROJECT:
	HADDONFIELD POLICE STATION
	1 WALNUT STREET, HADDONFIELD, NJ
	08033 FOR
1-2 1/2	CAMDEN COUNTY
	IMPROVEMENT
	AUTHORITY 520 MARKET STREET, 6TH FLOOR,
	CAMDEN, NEW JERSEY 08102
) FACE	FOR CODE REVIEW: 02/23/24 REVISIONS:
	REVISION NAME DATE
	FOR BID: 06/25/2024
	DRAWING TITLE:
	COMMISSION NUMBER:
D FACE LOW	23M014
D FACE LOW B ÂNGLE	DO NOT SCALE THE DRAWINGS
(LQ	
	A6.2

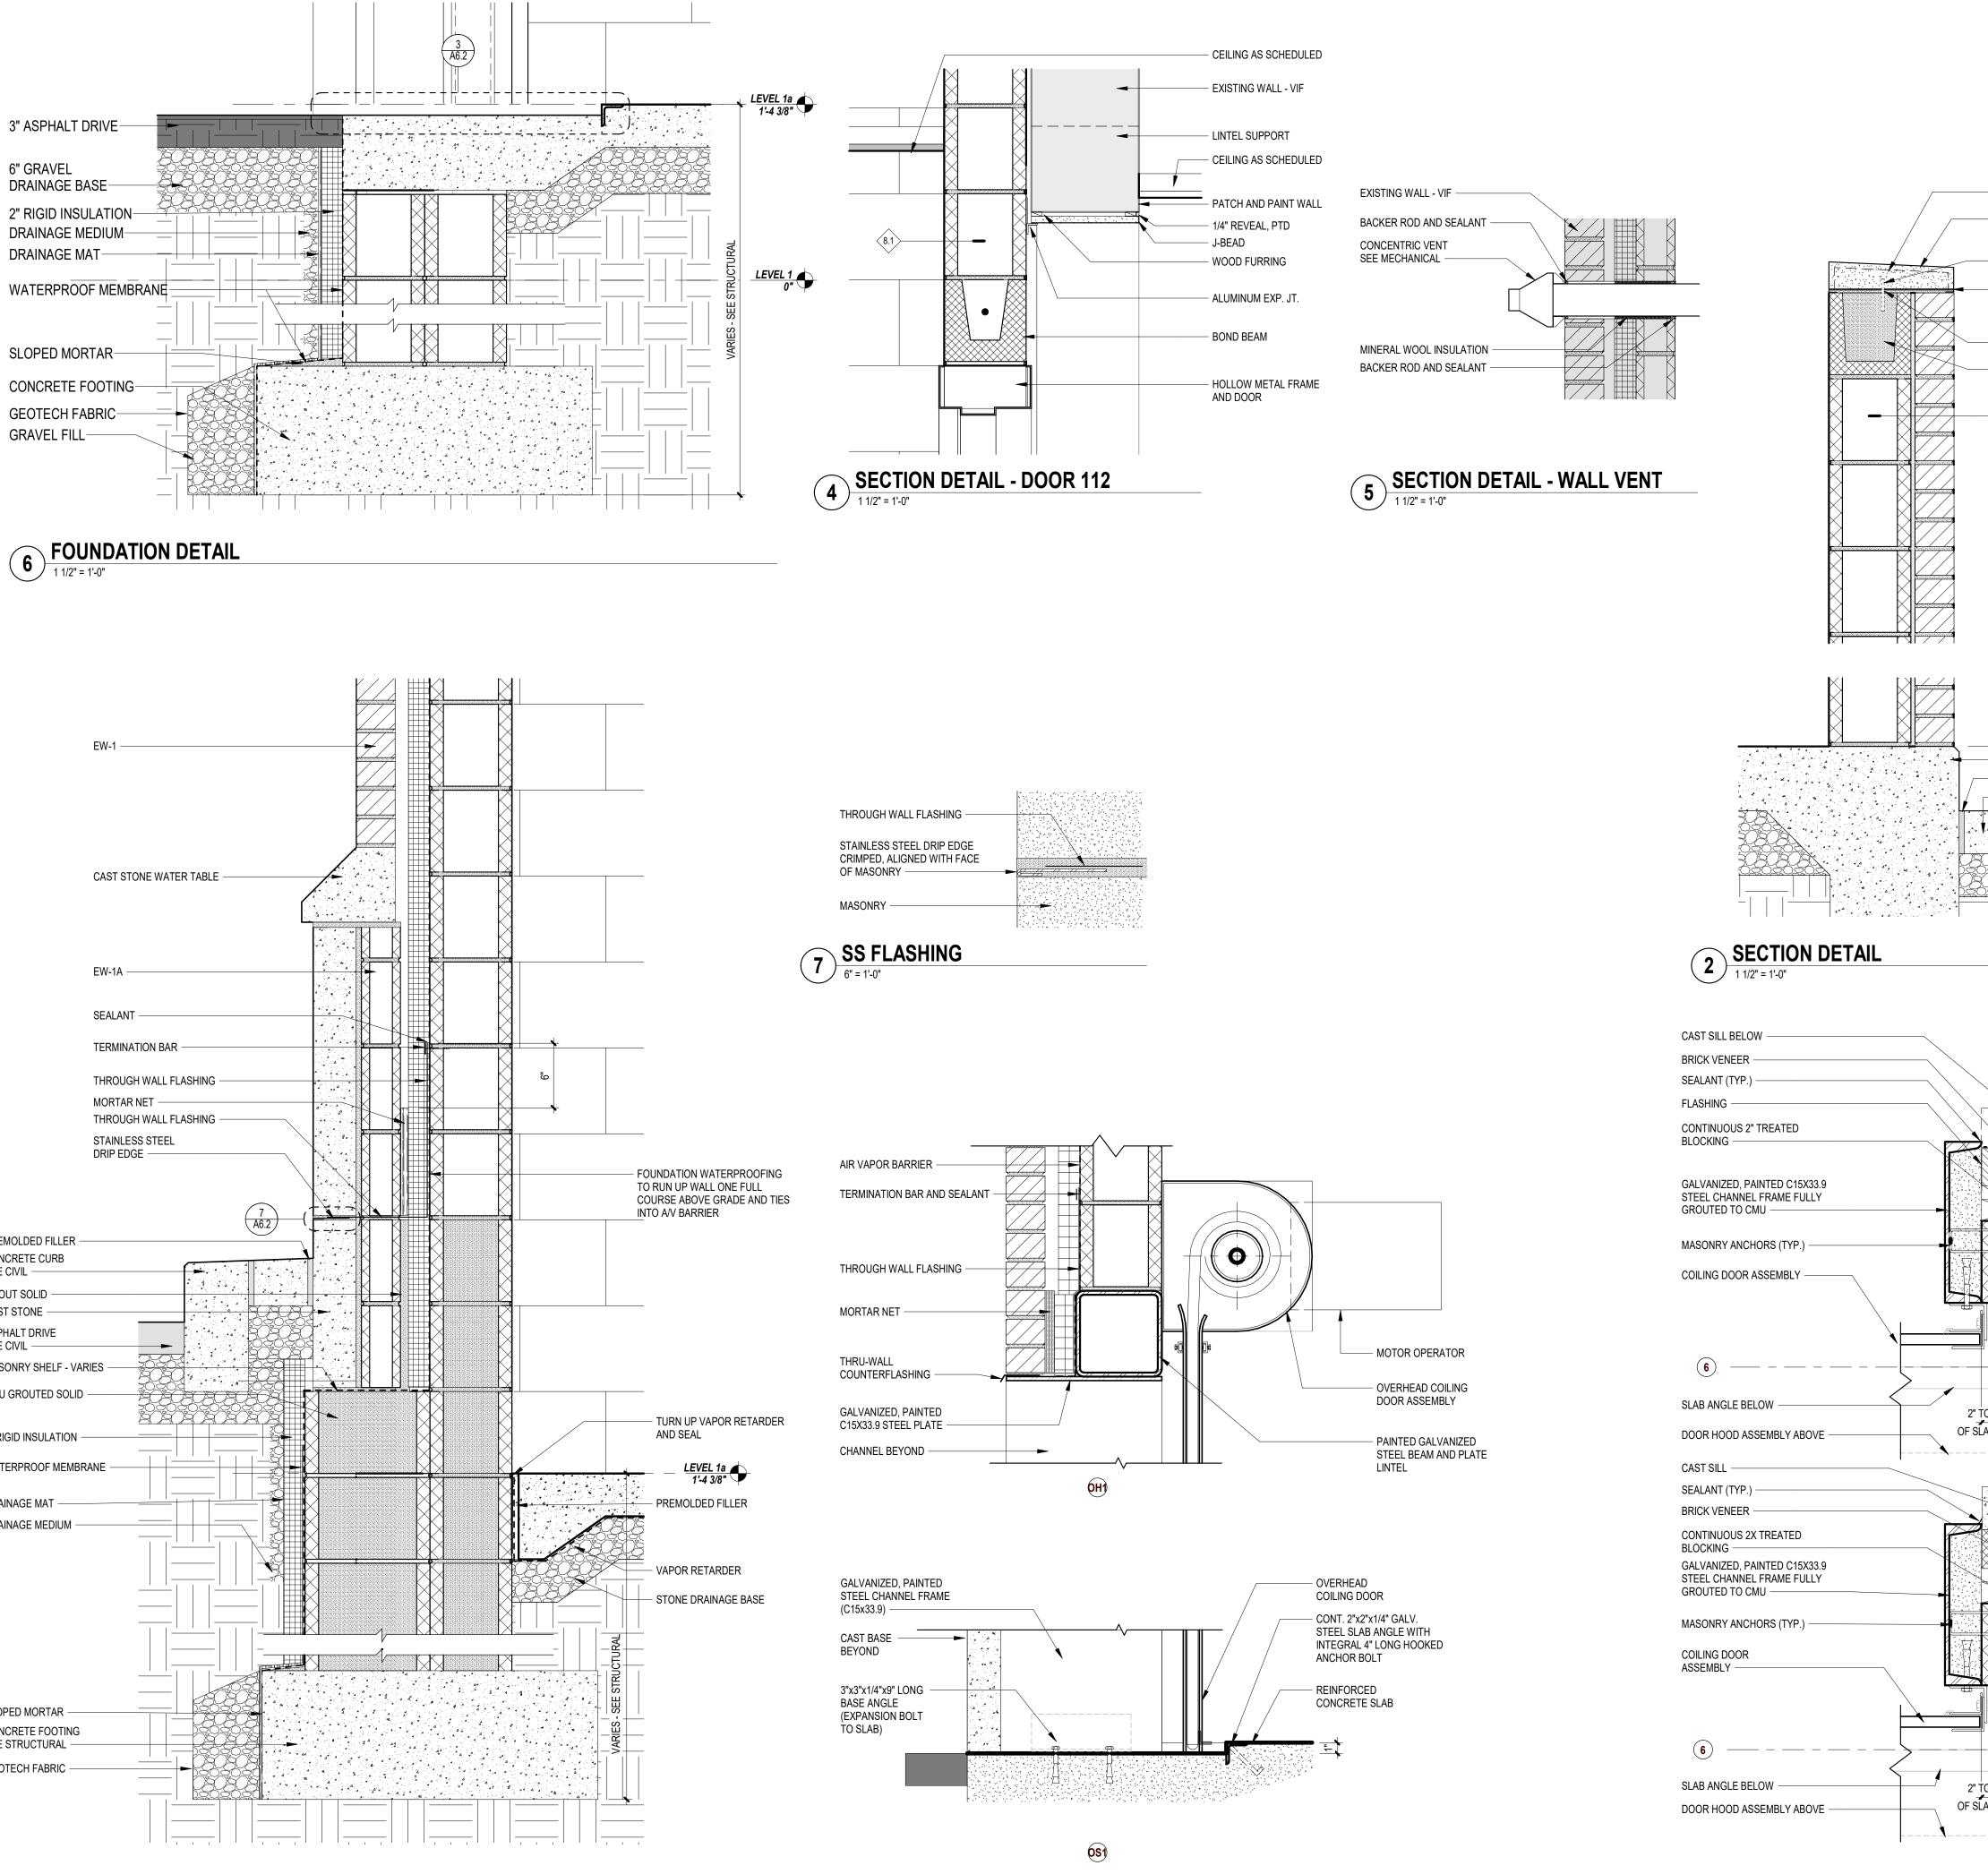

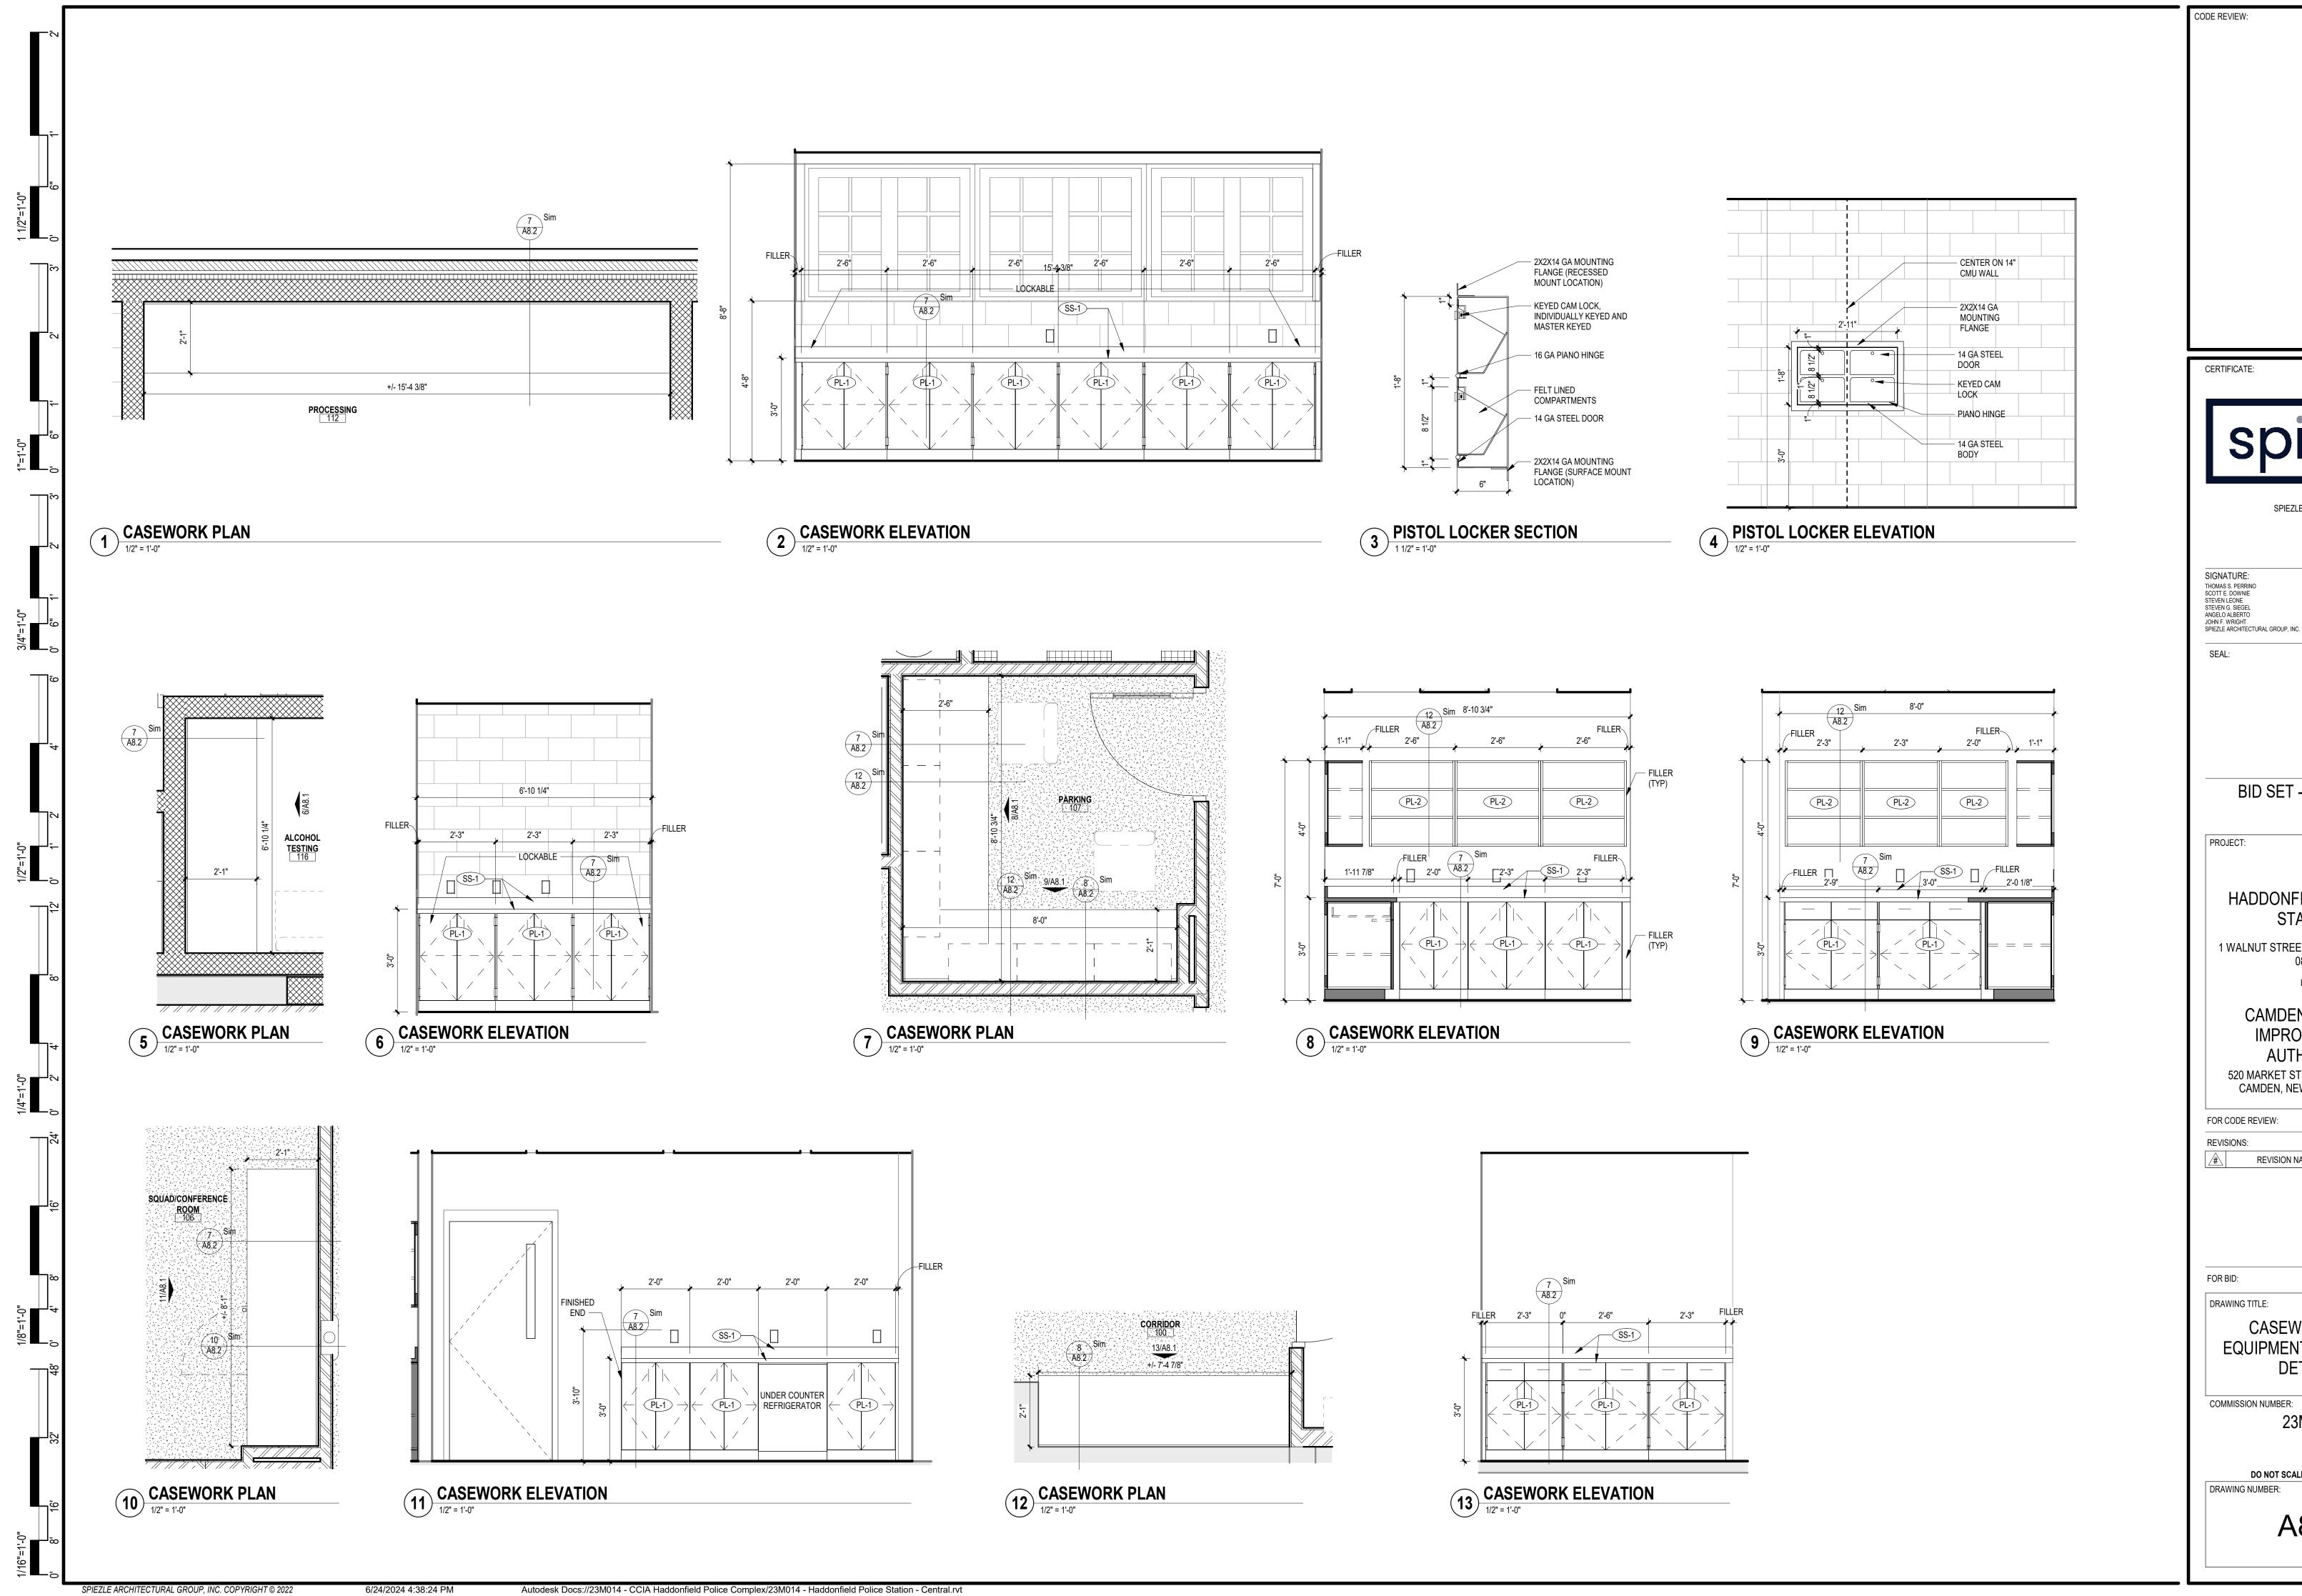
DE REVIEW:
CERTIFICATE:
spiezle
SPIEZLE ARCHITECTURAL GROUP INC. 121 MARKET STREET CAMDEN, NJ 08102 PHONE: (866) 974 7666
SIGNATURE:           THOMAS S. PERRINO         21AI01505400           SCOTT E. DOWNIE         21AI01674400
STEVEN LEONE         21AI0170100           STEVEN G. SIEGEL         21AI01564200           ANGELO ALBERTO         21AI01046700           JOHN F. WRIGHT         21AI01784200           SPIEZLE ARCHITECTURAL GROUP, INC.         21AC0063000
SEAL:
BID SET - 06/25/2024
PROJECT:
HADDONFIELD POLICE STATION
1 WALNUT STREET, HADDONFIELD, NJ 08033 FOR
IMPROVEMENT AUTHORITY
520 MARKET STREET, 6TH FLOOR, CAMDEN, NEW JERSEY 08102
FOR CODE REVIEW: 02/23/24 REVISIONS:
REVISION NAME DATE
FOR BID: 06/25/2024
EQUIPMENT PLANS AND DETAILS
COMMISSION NUMBER: 23M014
DO NOT SCALE THE DRAWINGS
A8.1



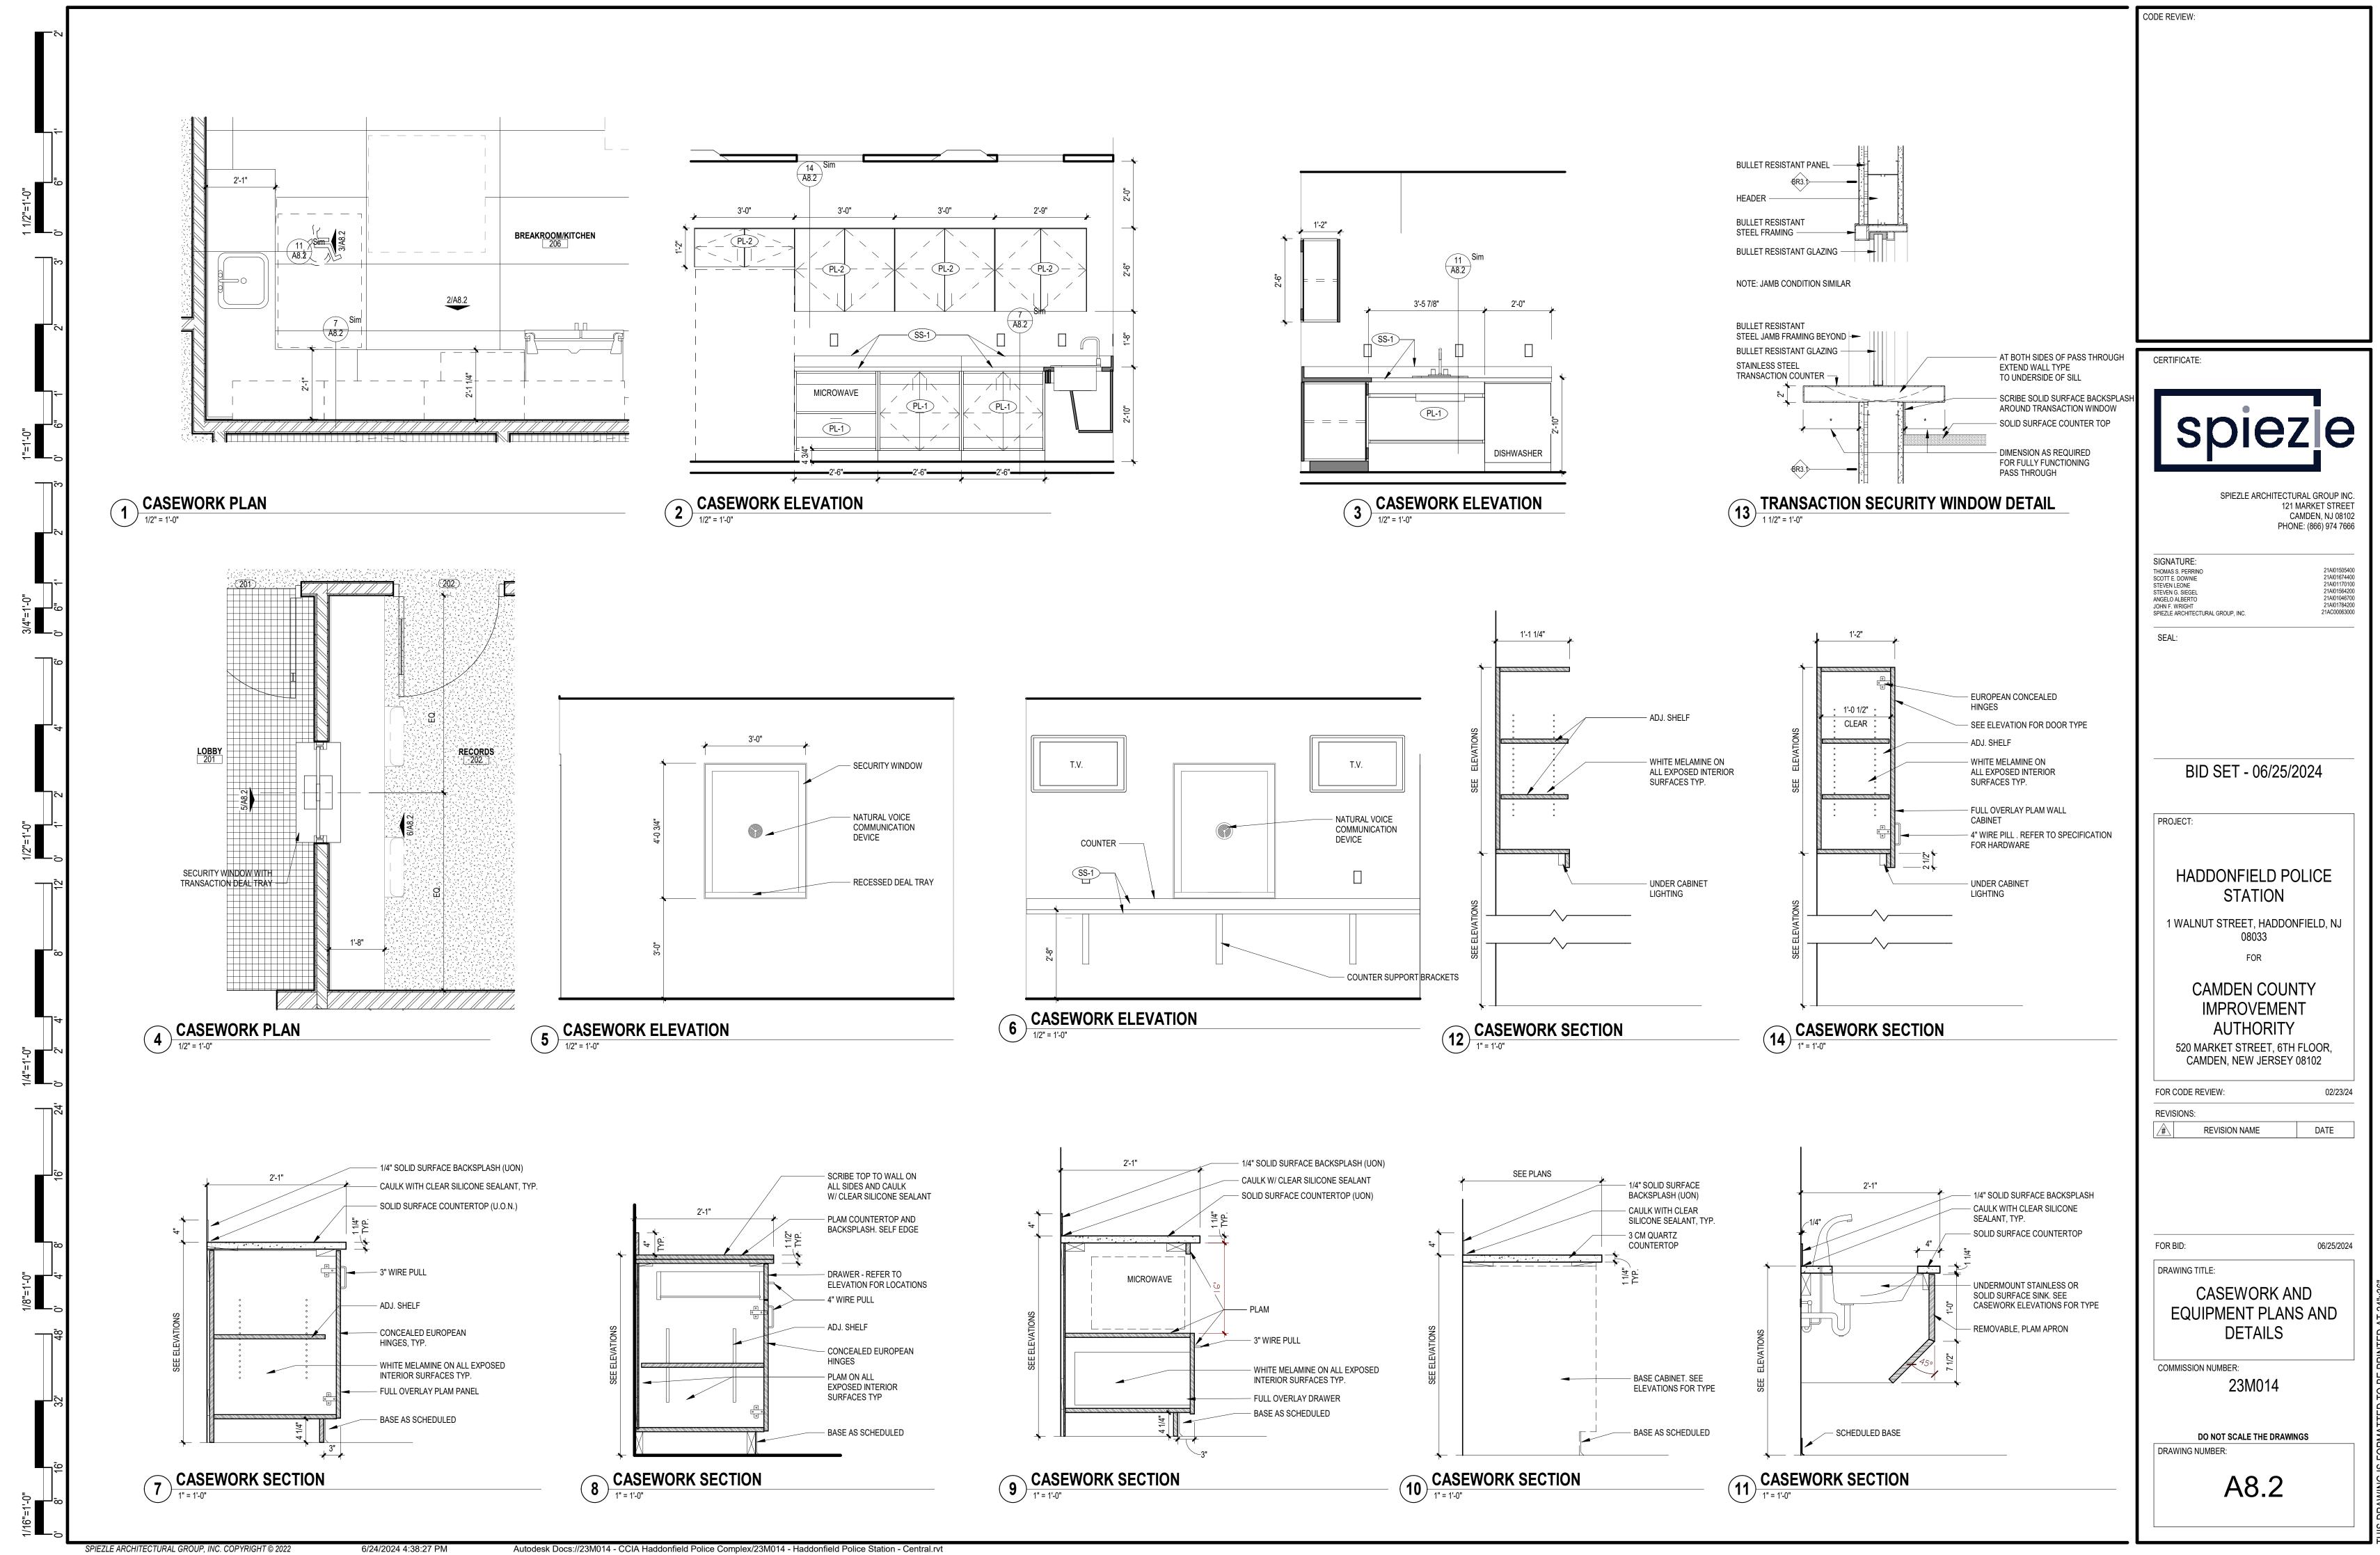


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INPRO	1				CODE REVIEW:
AKTIVLOK	PL-2	MANUFACTURER:	WILSONART	_	
AK10102-JAYZ BLUE	1	COLOR:	ALABASTER D431-60		
24" X 24" 3/8"	┨──	FINISH:	MATTE BRIAN PARENT	_	
3/8" INPRO CORPORATION	┨──	CONTACT: CONTACT:	BRIAN PARENT BRIANPARENT@FESSENDENHALL.COM	-	
1' BASE UNDER MIRROR IN FITNESS CENTER		NOTE:	UPPER CABINETS		
UXURY VINYL TILE	00.4	MANUFACTURER:	SOLID SURFACE		
ACCESS WOOD	SS-1	COLOR:	WHITEHALL	-	
SHIBORI JASMINE		EDGE:	TBD		
SX5W7800	┨───	CONTACT:	SARA KINNEY	_	
6" X 40" ASHLAR	┨├──	CONTACT: NOTE:	SARAK@SURFACEMATERIALS.COM COUNTER TOPS ALL CASEWORK	-	
5 MM					
LORISE VAN VOORTHUIZEN	SS-1	MANUFACTURER:		_	
LORISE.VAN@MANNINGTON.COM BREAK ROOM, CORRIDOR		COLOR: EDGE:	URBAN HABITAT TBD	_	
WALL BASE		CONTACT:	KYLE MCDEVITT		
ROPPE-PINNACLE PLUS		CONTACT:			
STYLE 6065 123 CHARCOAL	┨┖──	NOTE:	BATHROOM COUNTERTOPS		
ROPPE-PINNACLE PLUS					
CONTINUOUS ROLL ERIC SAENZ	_				
ESAENZ@SSTFLOOR.COM	-				CERTIFICATE:
WALL BASE AT CPT AND LVT AREAS					CERTIFICATE.
				61	
COVE WALL BASE TBD			AL FINISH NOTE	J.	
TBD	1 Г				
TBD		CDT (	FINISH TAG		
	$\left\{ \right\}$	CPT-1			
		P-1 WT-2	FINISH SEPARATION TAG		
WALL BASE AT VCT AND GYM AREAS	$\left  \right $	<u> </u>			SPIEZLE ARCHITECTURAL GROUP INC.
<u>'L COMPOSITION TILE</u>		_	SPAN DIRECTION OF SHEET C	R BROAD	121 MARKET STREET CAMDEN, NJ 08102
ARMSTRONG			LOOM PRODUCTS		PHONE: (866) 974 7666
STANDARD EXCELON 51927	$\left\{ \right\}$		ROOM FINISH TAG		
FIELD GRAY		ROOM NAME	ROOM NAME		SIGNATURE:           THOMAS S. PERRINO         21AI01505400           SCOTT F. DOWNIE         21AI01674400
12"X12"		A1000	ROOM NUMBER 		STEVEN LEONE         21AI01170100           STEVEN G. SIEGEL         21AI01564200
QUARTER TURNES LINDSAY HARBOLD	$\left\{ \right\}$	BF FF	BASE FINISH FLOOR FINISH		ANGELO ALBERTO         21AI01046700           JOHN F. WRIGHT         21AI01784200           SPIEZLE ARCHITECTURAL GROUP, INC.         21AC00063000
LINDSAY.HARBOLD@AHFPRODUCTS.COM					
	1.	NOTES PERTAIN	TO AREAS WITHIN THIS SCOPE OF WORK	ONLY.	SEAL:
06800 - CARPETING CARPET TILE	2.		OR DESIGNER/ARCHITECT FOR CLARIFIC		
MANNINGTON			ORY INFORMATION BETWEEN DRAWINGS OR IF COLOR AND/OR FINISH IS NOT SPE	,	
DESIGN LOCAL	3		LEGEND AND PLAN FOR GENERAL FINIS		
NASHVILLE EAST NASHVILLE	-				
18" X 36"	<b>1 1 4</b> . <b>−</b>		TERIOR FINISH NOTES AND INTERIOR DR INS AND DETAILS) FOR COMPLETE INTER		
HORIZONTAL BRICK ASHLAR	5.		R IS RESPONSIBLE FOR VERIFYING PROI		
LORISE VAN VOORTHUIZEN LORISE.VAN@MANNINGTON.COM	$\left\{ \right\}$		Y THAT MEETS THE PROJECT SCHEDULE		BID SET - 06/25/2024
099100 - PAINTING	6.		R IS RESPONSIBLE TO FIELD VERIFY ALL JANTITIES PRIOR TO ORDERING PRODUC		BIB 021 00/20/2021
SHERWIN WILLIAMS TBD	$\left  \right $	CONTRADICTORY	INFORMATION CONTACT THE INTERIOR		
EGGSHELL	$\left\{ \right\}$		TECT FOR CLARIFICATION PRIOR TO ORI		PROJECT:
RICA SUHANEC	<b>    7</b> .		HALL BE INSTALLED USING MANUFACTUR		
RICA.SUHANEC@SHERWIN.COM	- 8.	WARRANTY INFO	RMATION AND INSTRUCTIONS OF MAINTE	NANCE ON ALL	
		FINISH MATERIAL	S SHALL BE PROVIDED TO THE OWNER A VARRANTY AND MAINTENANCE MANUAL.		HADDONFIELD POLICE
SHERWIN WILLIAMS					STATION
TBD EGGSHELL	- 9.	FINISHES SPECIF	R IS RESPONSIBLE FOR SUBMITTING SAI		
RICA SUHANEC	$\left  \right $	PRIOR TO ORDER	RING MATERIAL.		1 WALNUT STREET, HADDONFIELD, NJ 08033
RICA.SUHANEC@SHERWIN.COM	10.		SURFACES ARE TO BE PROPERLY PREPA S. CONTRACTOR IS NOT TO APPLY FINIS		
ACCENT PAINT	$\left\{ \right\}$	SUBSTRATE IS PR	REPARED PER MANUFACTURES WRITTEN		FOR
SHERWIN WILLIAMS			NS OR APPLICATIONS.		CAMDEN COUNTY
IRON ORE	]   <sup>11.</sup>	BOXES, ACCESS I	ALL DIFFUSERS, ELECTRICAL PANELS, WA PANELS, ETC., WHICH ARE EXPOSED IN F	INISHED SPACES TO	IMPROVEMENT
SEMI GLOSS RICA SUHANEC	$\left\{ \right\}$	MATCH THE SURF	ACE ON WHICH THEY OCCUR IF THE ITE PROVIDE A CUSTOM PAINT COLOR USED	M IS ON A WALL-	AUTHORITY
RICA.SUHANEC@SHERWIN.COM			GIGNER/ARCHITECT FOR APPROVAL.		
TRIM PAINT	12.		LAMINATES SHOULD RUN WITH THE VER	RTICAL GRAIN	520 MARKET STREET, 6TH FLOOR, CAMDEN, NEW JERSEY 08102
SHERWIN WILLIAMS	$\left\{ \right\}$	PATTERN UON.			,
TBD			TO BE EGGSHELL FINISH UON.		FOR CODE REVIEW: 02/23/24
EGGSHELL	14.	ALL METAL AND P	AINTED TRIM TO BE SEMI-GLOSS ENAME	L FINISH UON.	REVISIONS:
RICA SUHANEC RICA.SUHANEC@SHERWIN.COM	15.	INSTALL DIRECTION	DNAL WALLCOVERING ORIENTED AS SPE	CIFIED IN	Image: matrix display="block">REVISION NAME         DATE
ACCENT PAINT		-			
SHERWIN WILLIAMS	-     <sup>16</sup> .	ALL VINYL/RUBBE UON.	R BASE TO BE ROLLED GOODS, NOT LINI	LAN 4 LENG (HÖ,	
TBD	17.		ED ON "ROOM FINISH TAG" ARE INCLUSI		
EGGSHELL		RESPECTIVE SUR	FACES IN ROOM (UNLESS OTHERWISE N ON PLANS OR ELEVATIONS.		
RICA SUHANEC RICA.SUHANEC@SHERWIN.COM		OOR FINISH NOTES			
ACCENT PAINT	+ $-$		_		FOR BID: 06/25/2024
	$\begin{bmatrix} 1 \\ 1 \end{bmatrix}$		RAWING LAYOUT SHOWING ALL FLOOR F IN DIRECTION AND SEAMING DIAGRAMS.		
SHERWIN WILLIAMS TBD	2.	INSTALL DIRECTION	DNAL FLOORING ORIENTED AS SPECIFIEI	) IN THE FINISH	DRAWING TITLE:
FLAT	1	PLAN.			
RICA SUHANEC	3.		IUFACTURERS INSTALLATION SPECIFICA PE TO VERIFY REQUIREMENTS.	TIONS FOR EACH	FINISH PLANS AND
RICA.SUHANEC@SHERWIN.COM CEILING PAINT	$\left\{ \right\}_{i}$				INTERIOR ELEVATIONS
3000 - FURNISHINGS	4.	ALIGN TRANSITIO DOORWAY UON.	N OF FLOOR MATERIAL WITH CENTER OF	IN JUNCE IN	
LASTIC LAMINATE	5.	IN A WALL OPENI	NG WITHOUT HINGES REFER TO FINISH P	LANS FOR	COMMISSION NUMBER:
WILSONART FOSSIL SHALE D504-60	-		ATION OF WRAPPED MATERIALS.		23M014
MATTE	6.		E FLOOR AT TRANSITION OF ALL MATERI PS AS NECESSARY. SUBMIT TRANSITION		_0011
BRIAN PARENT		DESIGNER/ARCHI	TECT FOR APPROVAL. ALL FLOORING TH		
BRIANPARENT@FESSENDENHALL.COM LOWER CABINETS	$\left\{ \right\}$		AMERICANS WITH DISABILITIES ACT.		DO NOT SCALE THE DRAWINGS
	∟   <u>כ</u> ב	ILING NOTES – FOI	R ALL PROJECTS:		DRAWING NUMBER:
	1.	ALL NEW GWB CE NOTED.	EILINGS/SOFFITS TO BE PAINTED CP-1 UN	LESS OTHERWISE	
					A9.1

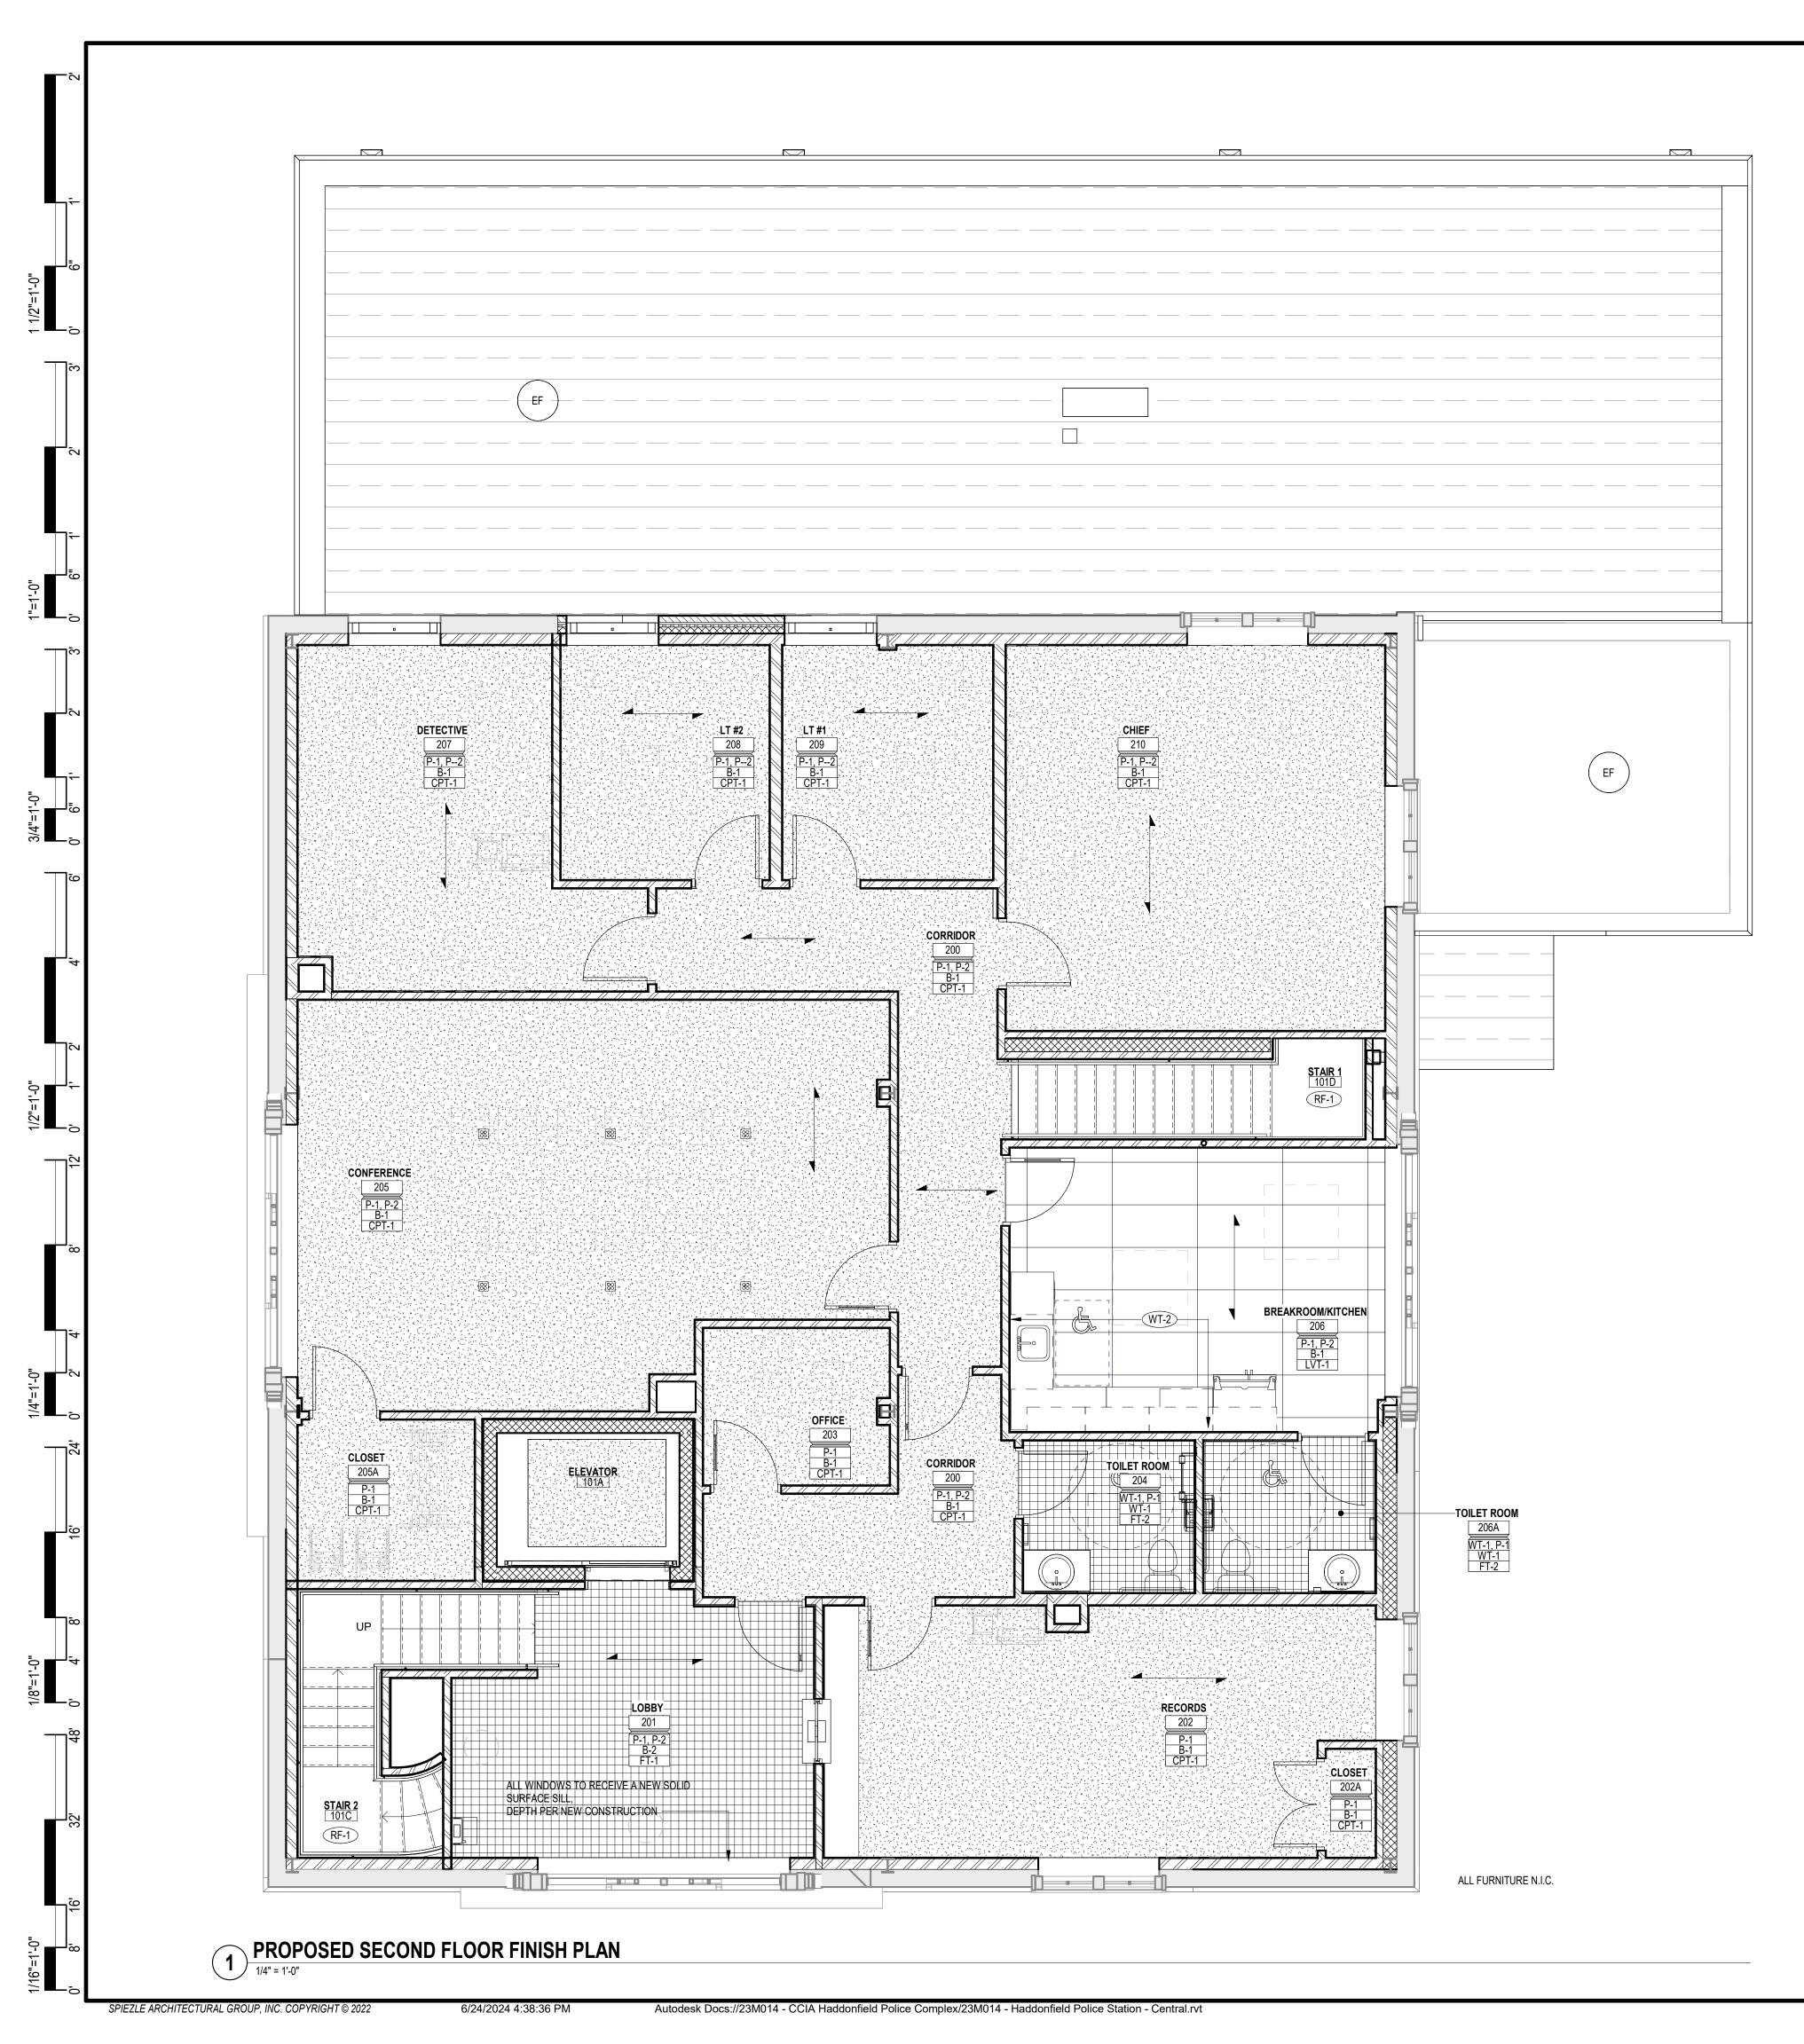

GENERAL FINISH NOTES:	
CPT-1 FINISH TAG	
FINISH SEPARATION TAG	
WI-Z	
SPAN DIRECTION OF SHEET OR BROAD LOOM PRODUCTS	
ROOM FINISH TAG ROOM NAME	
A1000 ROOM NUMBER	
BF BASE FINISH FF FILOOR FINISH	
1. NOTES PERTAIN TO AREAS WITHIN THIS SCOPE OF WORK ONLY.	
2. CONTACT INTERIOR DESIGNER/ARCHITECT FOR CLARIFICATION IN THE EVENT OF CONTRADICTORY INFORMATION BETWEEN DRAWINGS, LEGEND AND/ OR SPECIFICATIONS OR IF COLOR AND/OR FINISH IS NOT SPECIFIED.	
3. REFER TO FINISH LEGEND AND PLAN FOR GENERAL FINISHES.	
4. REFER TO ALL INTERIOR FINISH NOTES AND INTERIOR DRAWINGS (INCLUDING PLANS, ELEVATIONS AND DETAILS) FOR COMPLETE INTERIORS INFORMATION.	CERTIFICATE:
5. THE CONTRACTOR IS RESPONSIBLE FOR VERIFYING PRODUCT LEAD TIMES TO ENSURE DELIVERY THAT MEETS THE PROJECT SCHEDULE.	
6. THE CONTRACTOR IS RESPONSIBLE TO FIELD VERIFY ALL SITE CONDITIONS AND CONFIRM QUANTITIES PRIOR TO ORDERING PRODUCTS. IN THE EVENT OF CONTRADICTORY INFORMATION CONTACT THE INTERIOR	Spiezie
DESIGNER/ARCHITECT FOR CLARIFICATION PRIOR TO ORDERING. 7. ALL MATERIALS SHALL BE INSTALLED USING MANUFACTURERS	
RECOMMENDED INSTALLATION METHODS AND ADHESIVES.	SPIEZLE ARCHITECTURAL GROUP II
<ol> <li>WARRANTY INFORMATION AND INSTRUCTIONS OF MAINTENANCE ON ALL FINISH MATERIALS SHALL BE PROVIDED TO THE OWNER AND INCLUDED IN THE CLOSEOUT WARRANTY AND MAINTENANCE MANUAL.</li> <li>THE CONTRACTOR IS RESPONSIBLE FOR SUBMITTING SAMPLES OF ALL</li> </ol>	121 MARKET STRE CAMDEN, NJ 08 PHONE: (866) 974 7
<ol> <li>THE CONTRACTOR IS RESPONSIBLE FOR SUBMITTING SAMPLES OF ALL FINISHES SPECIFIED TO INTERIOR DESIGNER/ARCHITECT FOR APPROVAL PRIOR TO ORDERING MATERIAL.</li> <li>ALL SUBSTRATE SURFACES ARE TO BE PROPERLY PREPARED TO RECEIVE</li> </ol>	SIGNATURE:           THOMAS S. PERRINO         21AI0150           SCOTT E. DOWNIE         21AI0167
10. ALL SUBSTRATE SURFACES ARE TO BE PROPERLY PREPARED TO RECEIVE FINISH MATERIALS. CONTRACTOR IS NOT TO APPLY FINISHES UNTIL SUBSTRATE IS PREPARED PER MANUFACTURES WRITTEN INSTRUCTIONS FOR ALL INSTALLATIONS OR APPLICATIONS.	STEVEN LEONE 21AI0117 STEVEN LEONE 21AI0177 STEVEN G. SIEGEL 21AI0156 ANGELO ALBERTO 21AI0104 JOHN F. WRIGHT 21AI0178 SPIEZLE ARCHITECTURAL GROUP, INC. 21AC0006
11. PAINT GRILLS, WALL DIFFUSERS, ELECTRICAL PANELS, WALL MOUNTED BOXES, ACCESS PANELS, ETC., WHICH ARE EXPOSED IN FINISHED SPACES TO MATCH THE SURFACE ON WHICH THEY OCCUR IF THE ITEM IS ON A WALL- COVERED WALL. PROVIDE A CUSTOM PAINT COLOR USED TO MATCH. SUBMIT TO INTERIOR DESIGNER/ARCHITECT FOR APPROVAL.	SEAL:
12. ALL DIRECTIONAL LAMINATES SHOULD RUN WITH THE VERTICAL GRAIN PATTERN UON.	
13. ALL WALL PAINT TO BE EGGSHELL FINISH UON.	
14. ALL METAL AND PAINTED TRIM TO BE SEMI-GLOSS ENAMEL FINISH UON.	
15. INSTALL DIRECTIONAL WALLCOVERING ORIENTED AS SPECIFIED IN ELEVATION.	BID SET - 06/25/2024
16. ALL VINYL/RUBBER BASE TO BE ROLLED GOODS, NOT LINEAR 4' LENGTHS, UON.	
<ul> <li>17. FINISHES INDICATED ON "ROOM FINISH TAG" ARE INCLUSIVE OF ALL RESPECTIVE SURFACES IN ROOM (UNLESS OTHERWISE NOTED) WHETHER OR NOT INDICATED ON PLANS OR ELEVATIONS.</li> </ul>	PROJECT:
FLOOR FINISH NOTES:	HADDONFIELD POLICE
1. PROVIDE SHOP DRAWING LAYOUT SHOWING ALL FLOOR PATTERN LOCATIONS, GRAIN DIRECTION AND SEAMING DIAGRAMS.	STATION
2. INSTALL DIRECTIONAL FLOORING ORIENTED AS SPECIFIED IN THE FINISH PLAN.	1 WALNUT STREET, HADDONFIELD, NJ
3. REFERENCE MANUFACTURERS INSTALLATION SPECIFICATIONS FOR EACH	08033
<ul><li>FLOOR FINISH TYPE TO VERIFY REQUIREMENTS.</li><li>4. ALIGN TRANSITION OF FLOOR MATERIAL WITH CENTER OF HINGE IN</li></ul>	FOR
DOORWAY UON. 5. IN A WALL OPENING WITHOUT HINGES REFER TO FINISH PLANS FOR	CAMDEN COUNTY IMPROVEMENT
<ul><li>TRANSITION LOCATION OF WRAPPED MATERIALS.</li><li>6. FLASH PATCH THE FLOOR AT TRANSITION OF ALL MATERIALS, PROVIDE</li></ul>	AUTHORITY
TRANSITION STRIPS AS NECESSARY. SUBMIT TRANSITIONS TO INTERIOR DESIGNER/ARCHITECT FOR APPROVAL. ALL FLOORING TRANSITIONS MUST ADHERE TO THE AMERICANS WITH DISABILITIES ACT.	520 MARKET STREET, 6TH FLOOR, CAMDEN, NEW JERSEY 08102
CEILING NOTES – FOR ALL PROJECTS:	FOR CODE REVIEW: 02/23/
1. ALL NEW GWB CEILINGS/SOFFITS TO BE PAINTED CP-1 UNLESS OTHERWISE NOTED.	REVISIONS:
	REVISION NAME DATE
	FOR BID: 06/25/20
	DRAWING TITLE:
	FINISH PLANS AND INTERIOR ELEVATIONS
	COMMISSION NUMBER:
	23M014
	DO NOT SCALE THE DRAWINGS DRAWING NUMBER:
	A9.2

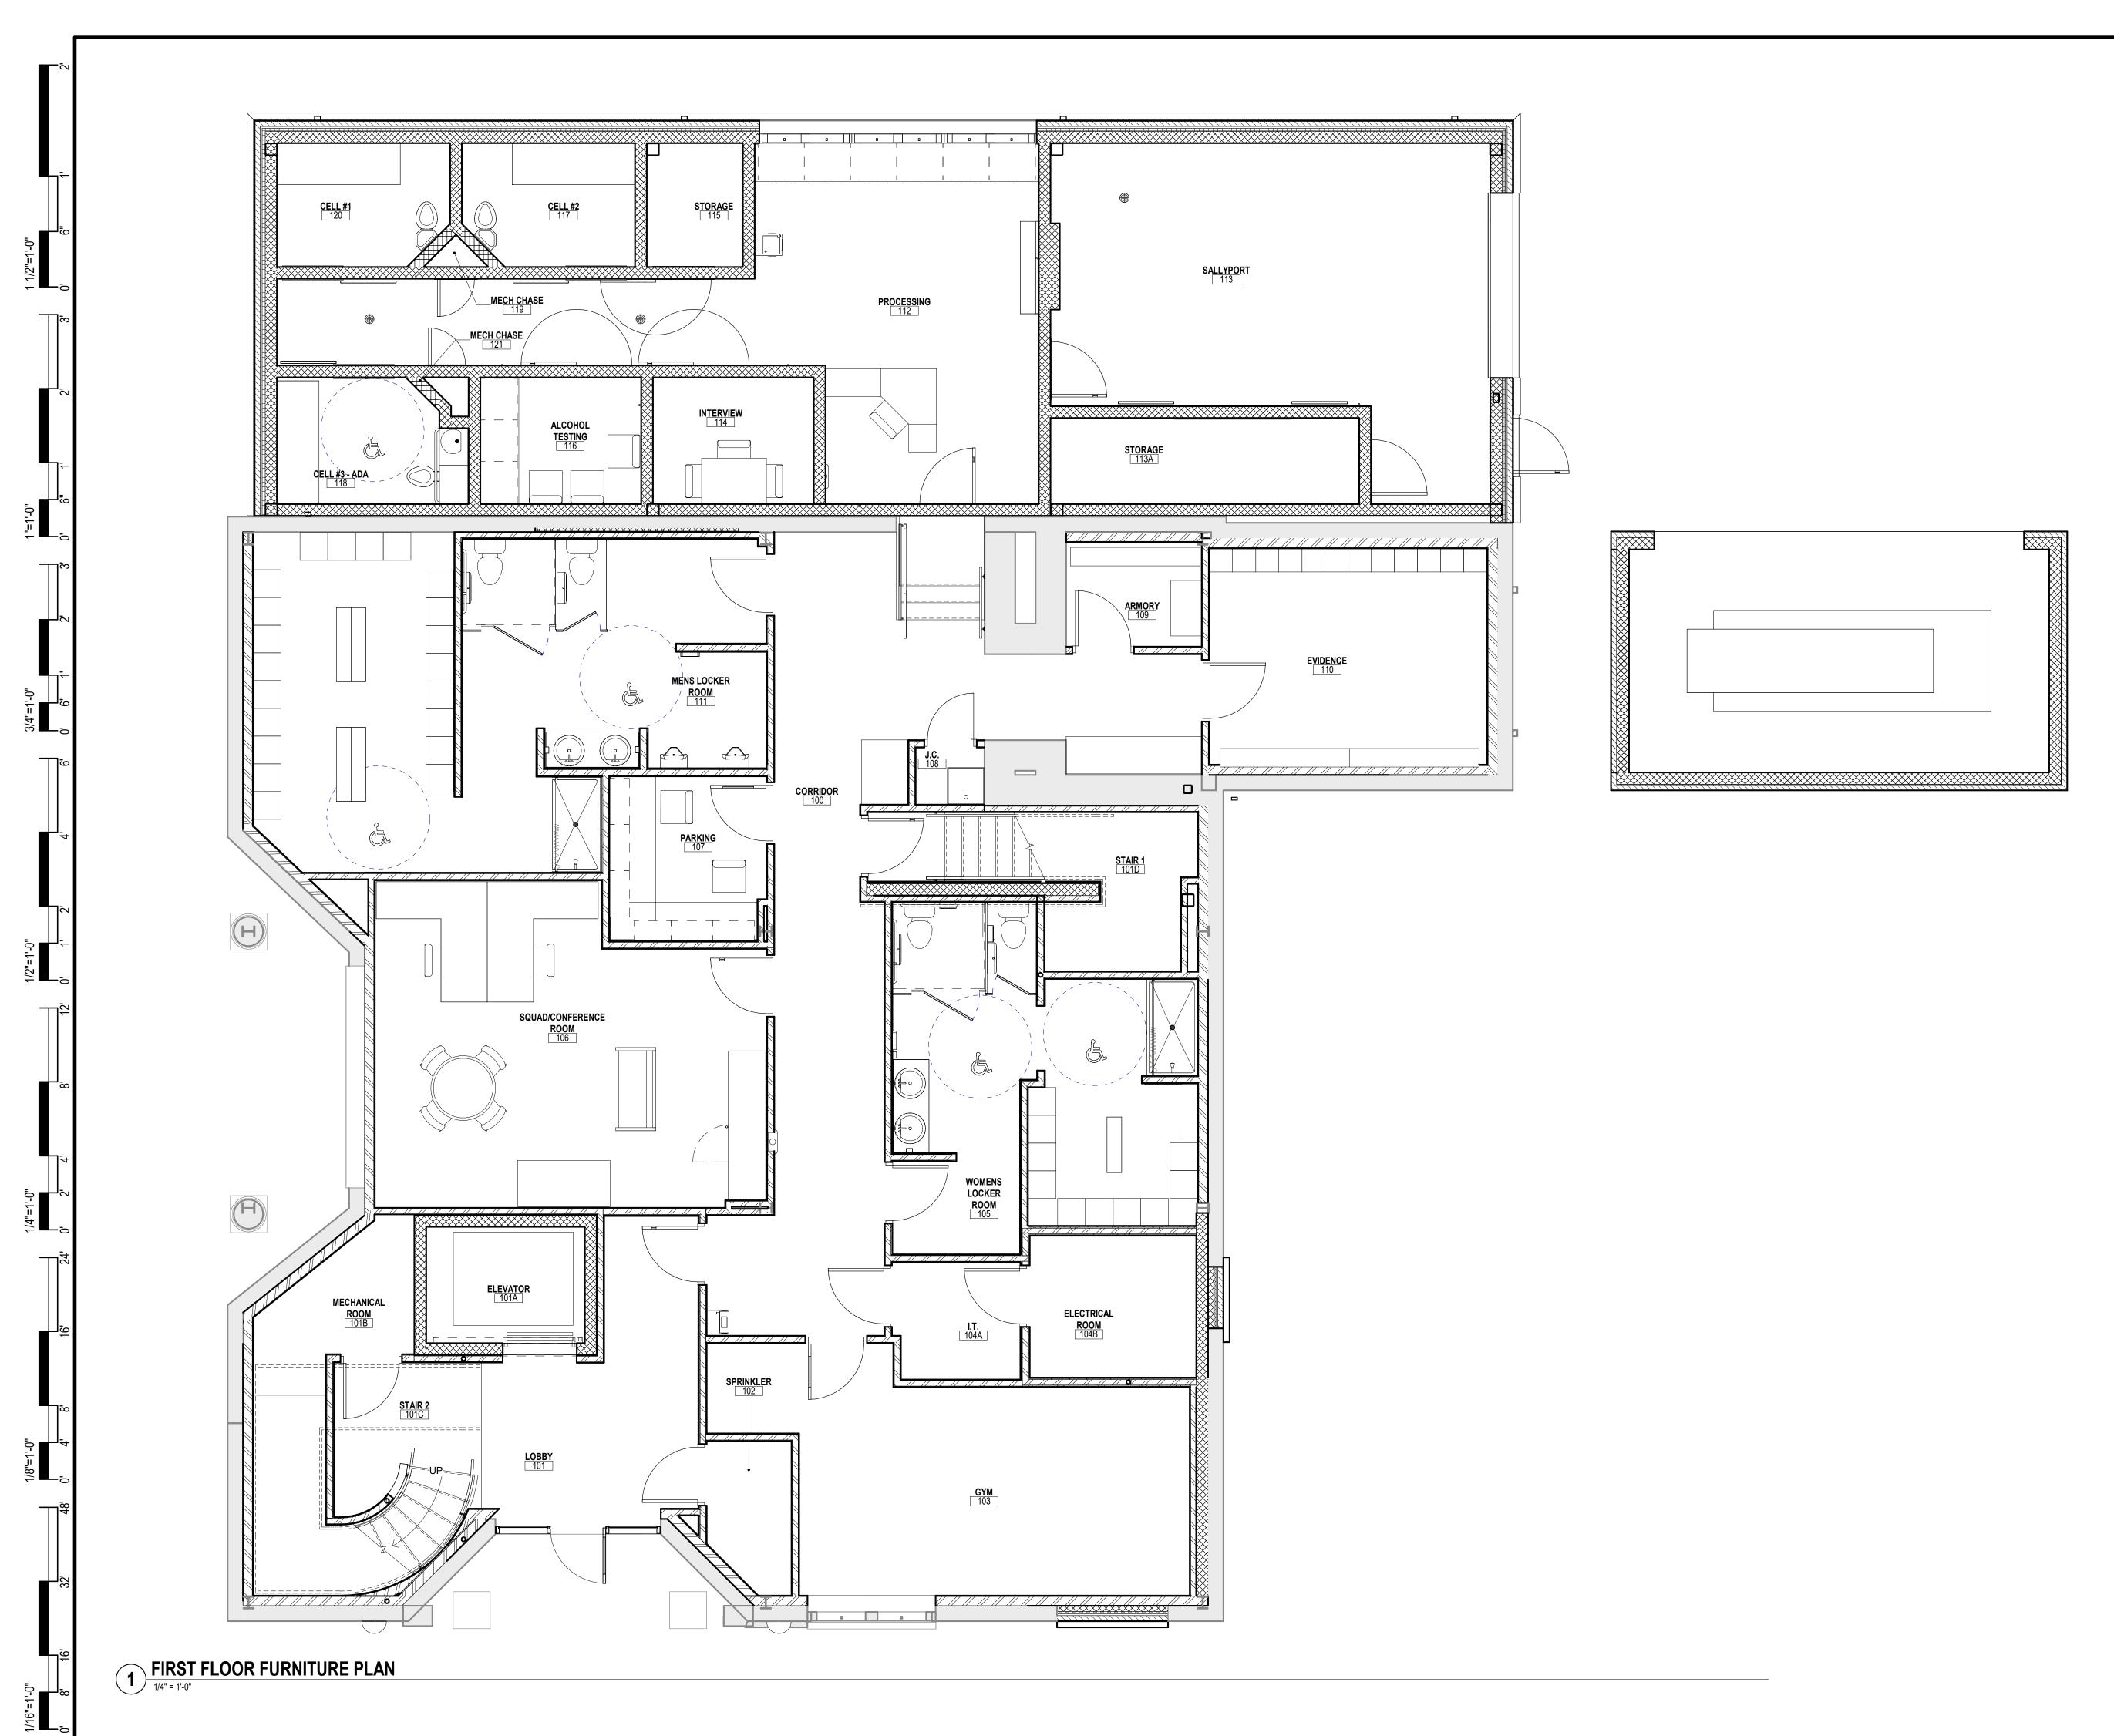



 CODE REVIEW:
CERTIFICATE:
SPIEZLE ARCHITECTURAL GROUP INC. 121 MARKET STREET CAMDEN, NJ 08102
PHONE: (866) 974 7666
SIGNATURE:           THOMAS S. PERRINO         21AI01505400           SCOTT E. DOWNIE         21AI01674400           STEVEN LEONE         21AI01170100
STEVEN G. SIEGEL21AI01564200ANGELO ALBERTO21AI01046700JOHN F. WRIGHT21AI01784200SPIEZLE ARCHITECTURAL GROUP, INC.21AC00063000
SEAL:
BID SET - 06/25/2024
PROJECT:
HADDONFIELD POLICE STATION
1 WALNUT STREET, HADDONFIELD, NJ
08033 FOR
CAMDEN COUNTY
IMPROVEMENT AUTHORITY
520 MARKET STREET, 6TH FLOOR, CAMDEN, NEW JERSEY 08102
FOR CODE REVIEW: 02/23/24
REVISIONS:
FOR BID: 06/25/2024
DRAWING TITLE:
FURNITURE PLANS
COMMISSION NUMBER:
23M014
DO NOT SCALE THE DRAWINGS
DO NOT SCALE THE DRAWINGS DRAWING NUMBER:
A9.3

# 1 SECOND FLOOR FURNITURE PLAN


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Autodesk Docs://23M014 - CCIA Haddonfield Police Complex/23M014 - Haddonfield Police Station - Central.rvt




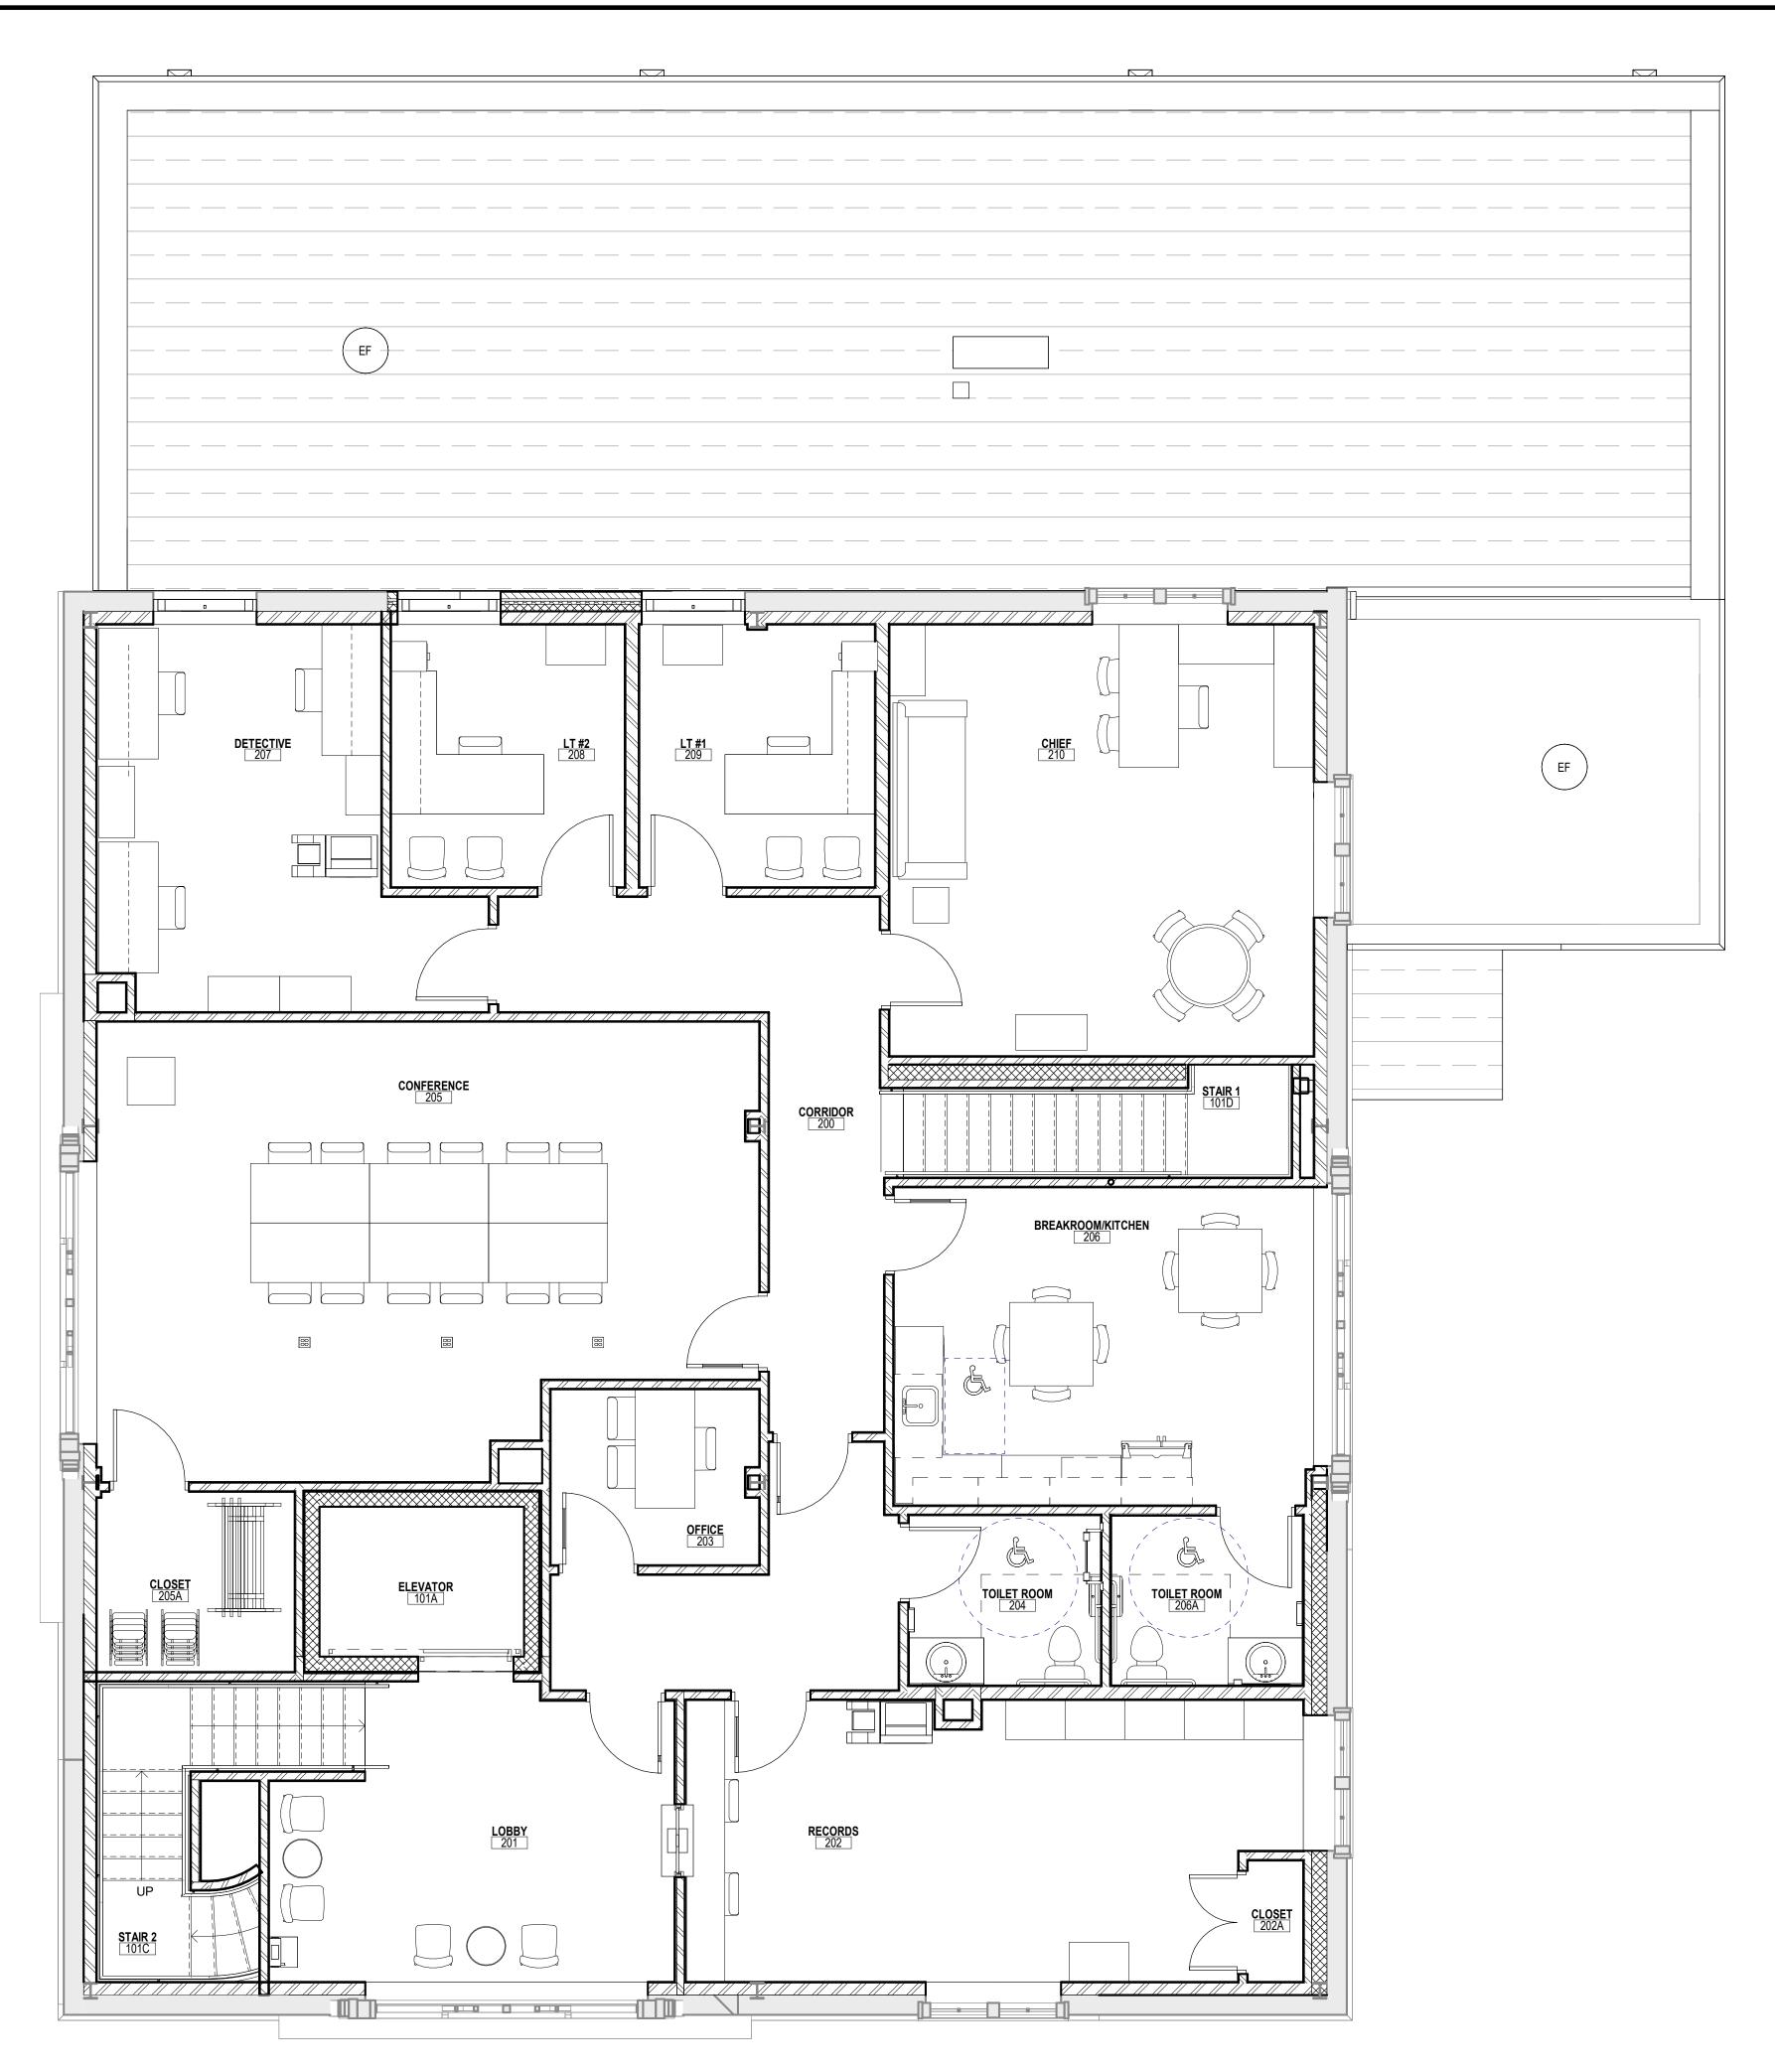

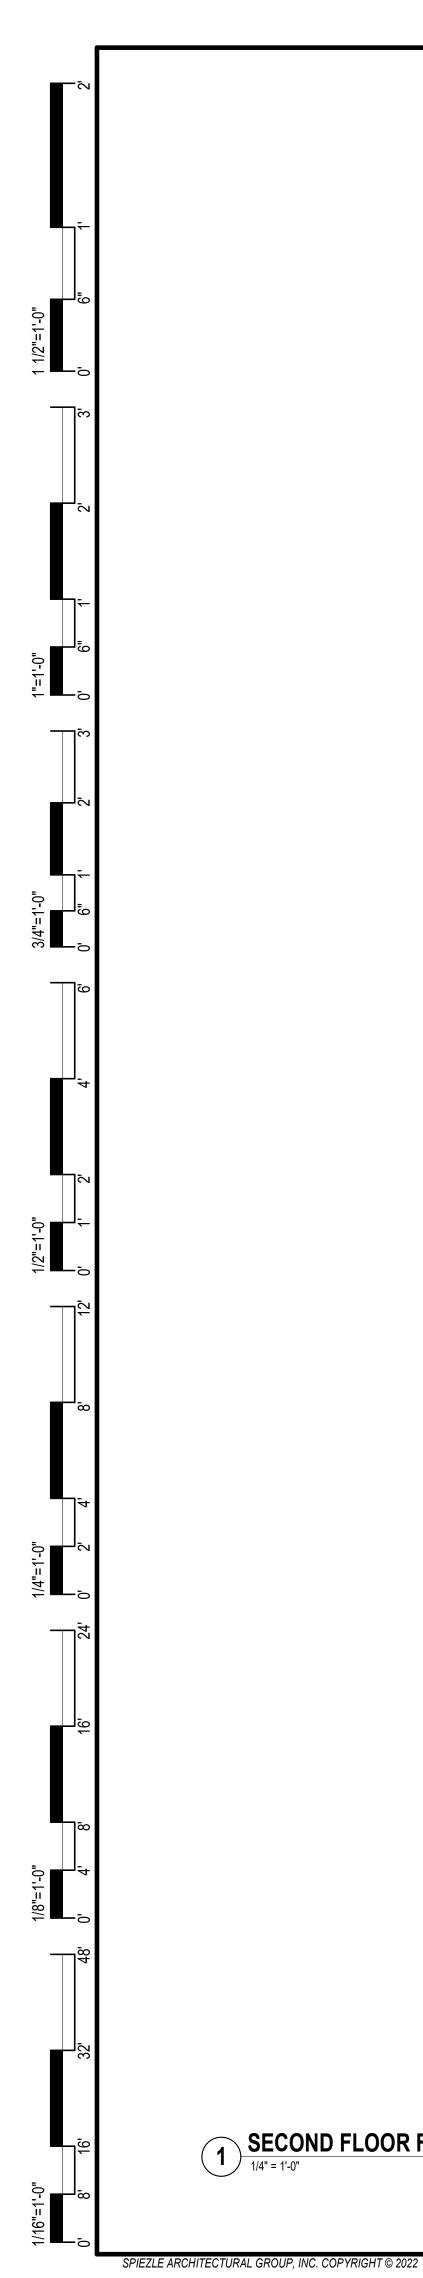CODE REVIEW:
CODE REVIEW.
CERTIFICATE:
SPIEZLE ARCHITECTURAL GROUP INC. 121 MARKET STREET
CAMDEN, NJ 08102 PHONE: (866) 974 7666
SIGNATURE: THOMAS S. PERRINO 21AI01505400
THOMAS S. PERRINO         2 TAIO 1000400           SCOTT E. DOWNIE         21AI01674400           STEVEN LEONE         21AI01170100           STEVEN G. SIEGEL         21AI01564200
STEVEN G. STEGEL         2 TAID 100-200           ANGELO ALBERTO         21AID 1046700           JOHN F. WRIGHT         21AID 1784200           SPIEZLE ARCHITECTURAL GROUP, INC.         21AC00063000
SEAL:
BID SET - 06/25/2024
PROJECT:
HADDONFIELD POLICE
STATION
1 WALNUT STREET, HADDONFIELD, NJ 08033
FOR
CAMDEN COUNTY
IMPROVEMENT
AUTHORITY
520 MARKET STREET, 6TH FLOOR, CAMDEN, NEW JERSEY 08102
FOR CODE REVIEW: 02/23/24
#         REVISION NAME         DATE
FOR BID: 06/25/2024
FOR BID: 06/25/2024 DRAWING TITLE:
DRAWING TITLE:
DRAWING TITLE:
DRAWING TITLE: FURNITURE PLANS COMMISSION NUMBER:
DRAWING TITLE:
DRAWING TITLE: FURNITURE PLANS COMMISSION NUMBER:
DRAWING TITLE: FURNITURE PLANS COMMISSION NUMBER: 23M014 DO NOT SCALE THE DRAWINGS
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DRAWING TITLE: FURNITURE PLANS COMMISSION NUMBER: DO NOT SCALE THE DRAWINGS DRAWING NUMBER:
DRAWING TITLE: FURNITURE PLANS COMMISSION NUMBER: 23M014 DO NOT SCALE THE DRAWINGS
DRAWING TITLE: FURNITURE PLANS COMMISSION NUMBER: DO NOT SCALE THE DRAWINGS DRAWING NUMBER:

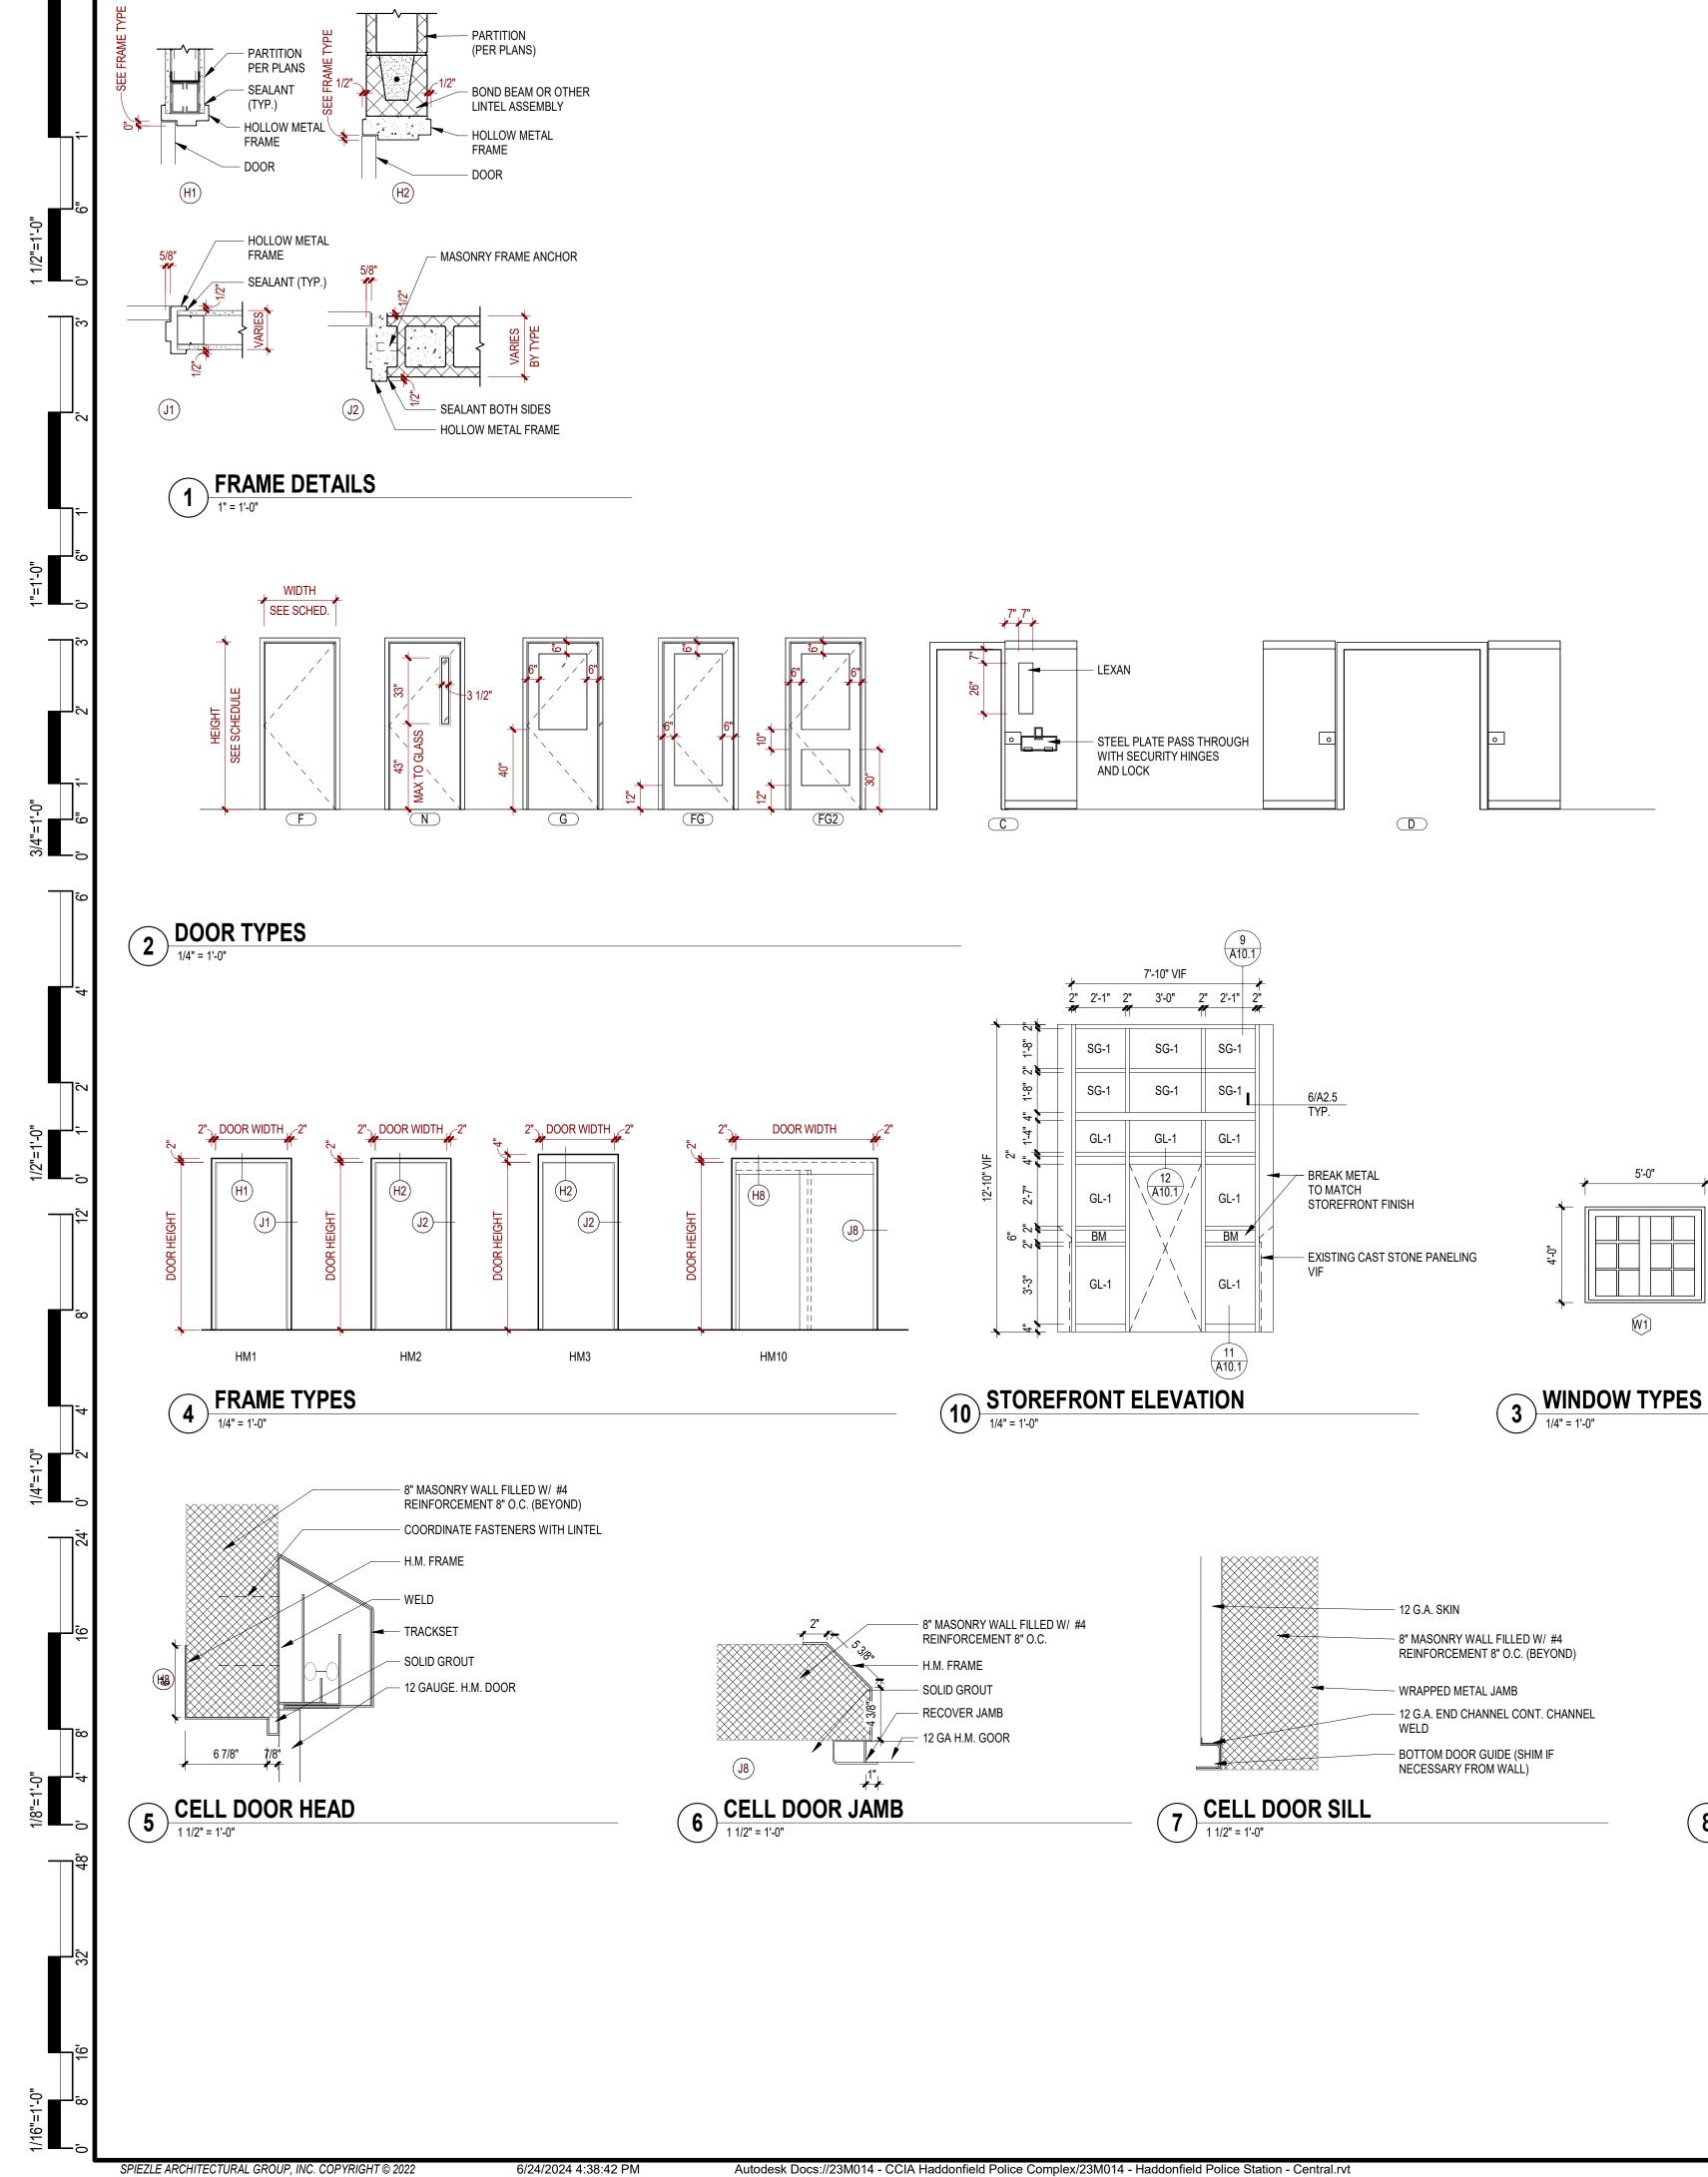


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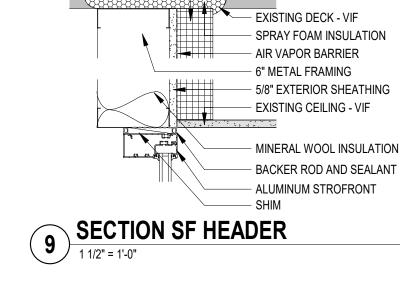


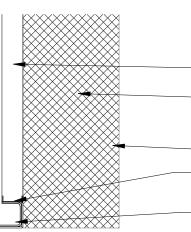- 8" MASONRY WALL FILLED W/ #4 REINFORCEMENT 8" O.C. (BEYOND) - WRAPPED METAL JAMB




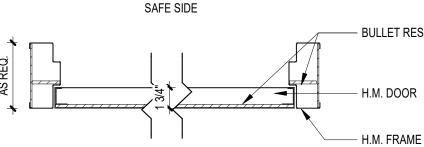



- BULLET RESISTANT PANEL



\_ \_\_\_

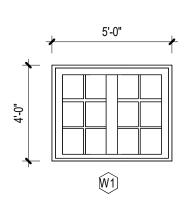


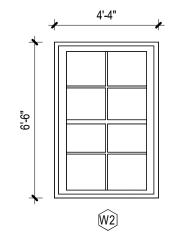

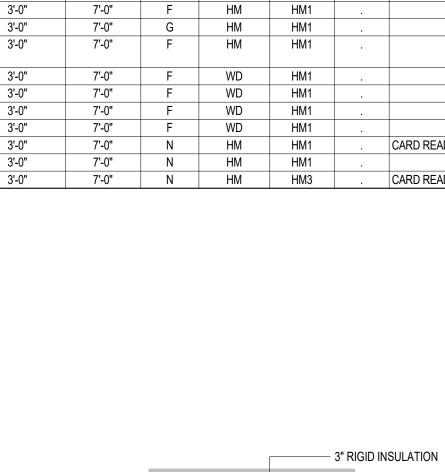

5 THROUGH NGES	<u> </u>		٥	

	DOOR SCHEDULE											
			DOOR			FRAME	RATING		AAOS Project HV			
MARK	LOCATION	WIDTH(s)	HEIGHT	TYPE	MATERIAL	TYPE	(MINS)	REMARKS	Set			
101	CORRIDOR	3'-0"	7'-0"	N	HM	HM1		CARD READER CONTROL DOOR	6.0			
101A	LOBBY	3'-0"	7'-2"	FG	AL	AL		CARD READER CONTROL DOOR WITH INTERCOM	20.0			
101B	MECHANICAL ROOM	3'-0"	7'-0"	F	HM	HM1			7.0			
101C	LOBBY	3'-0"	7'-0"	F	HM	HM1			8.0			
103	GYM	3'-0"	7'-0"	G	HM	HM1			9.0			
104	CORRIDOR	3'-0"	7'-0"	F	HM	HM1			7.0			
104B	I.T.	3'-0"	7'-0"	F	HM	HM1		90 MINUTE FIRE RATED DOOR				
105	CORRIDOR	3'-0"	7'-0"	F	HM	HM1			15.0			
106	CORRIDOR	3'-0"	7'-0"	N	HM	HM1			9.0			
107	CORRIDOR	3'-0"	7'-0"	G	HM	HM1			9.0			
108	J.C.	2'-6"	7'-0"	F	HM	HM1			7.0			
109	CORRIDOR	3'-0"	7'-0"	F	HM	HM1			4.0			
110	CORRIDOR	3'-0"	7'-0"	F	HM	HM1			4.0			
111	CORRIDOR	3'-0"	7'-0"	F	HM	HM1			16.0			
112	CORRIDOR	3'-0"	7'-0"	Ν	HM	HM3		CARD READER CONTROL DOOR - INTERCONNECTED	5.0			
113	SALLYPORT	3'-0"	7'-0"	Ν	HM	HM2		CARD READER CONTROL DOOR - INTERCONNECTED	5.0			
113A	SALLYPORT	6'-0"	7'-0"	D	HM	HM10			3.0			
113C	STORAGE	3'-0"	7'-0"	F	HM	HM3			7.0			
113D	SALLYPORT	3'-0"	7'-2"	N	HM	HM2		CARD READER CONTROL DOOR - INTERCONNECTED	2.0			
113E	SALLYPORT	10'-0"	8'-0"					CARD READER OVERHEAD COILING DOOR - CONTROL FROM DISPATCH AND REMOTE GARAGE DOOR OPENER, BUT SHOULD NOT OPEN IF INTERIOR DOORS 113, & 113D ARE OPEN AND DOOR CONTACTS FOR BOTH DOORS. SEE SHEET A6.2 FOR DETAILS.	3.0			
114	INTERVIEW	3'-0"	7'-0"	N	HM	HM3			17.0			
115	STORAGE	3'-0"	7'-0"	F	HM	HM3			7.0			
116	ALCOHOL TESTING	3'-0"	7'-0"	N	HM	HM3			17.0			
117	CELL #2	3'-0"	7'-0"	С	HM	HM10		SLIDING DETENTION DOOR AND FRAME	3.0			
118	CELL #3 - ADA	3'-0"	7'-0"	C	HM	HM10		SLIDING DETENTION DOOR AND FRAME	3.0			
119	MECH CHASE	2'-0"	7'-0"	F	HM	HM1			18.0			
120	CELL #1	3'-0"	7'-0"	С	HM	HM10		SLIDING DETENTION DOOR AND FRAME	3.0			
121	MECH CHASE	2'-0"	7'-0"	F	HM	HM1			18.0			
201	LOBBY	3'-0"	7'-0"	N	HM	HM1		BULLET RESISTANT DOOR & FRAME, CARD READER	4.0			
202	CORRIDOR	3'-0"	7'-0"	G	HM	HM1			9.0			
202A	CLOSET	2'-0" / 2'-0"	8'-0"	F	HM	HM1			14.0			
203	OFFICE	3'-0"	7'-0"	G	WD	HM1			10.0			
204	CORRIDOR	3'-0"	7'-0"	F	HM	HM1			12.0			
205	CORRIDOR	3'-0"	7'-0"	G	HM	HM1			9.0			
205A	CLOSET	3'-0"	7'-0"	F	HM	HM1	•		13.0			
2007	CORRIDOR	3'-0"	7'-0"	G	HM	HM1	•		9.0			
206A	BREAKROOM/KITC HEN	3'-0"	7'-0"	F	HM	HM1			12.0			
207	CORRIDOR	3'-0"	7'-0"	F	WD	HM1			11.0			
208	CORRIDOR	3'-0"	7'-0"	F	WD	HM1			11.0			
209	CORRIDOR	3'-0"	7'-0"	F	WD	HM1			11.0			
203	CORRIDOR	3'-0"	7'-0"	F	WD	HM1	· ·		11.0			
210	CORRIDOR	3'-0"	7'-0"	N	HM	HM1		CARD READER	4.0			
S1	CORRIDOR	3'-0"	7'-0"	N	HM	HM1	•		19.0			
S2	STAIR 1	3'-0"	7'-0"	N	HM	HM3	•	CARD READER	1.0			

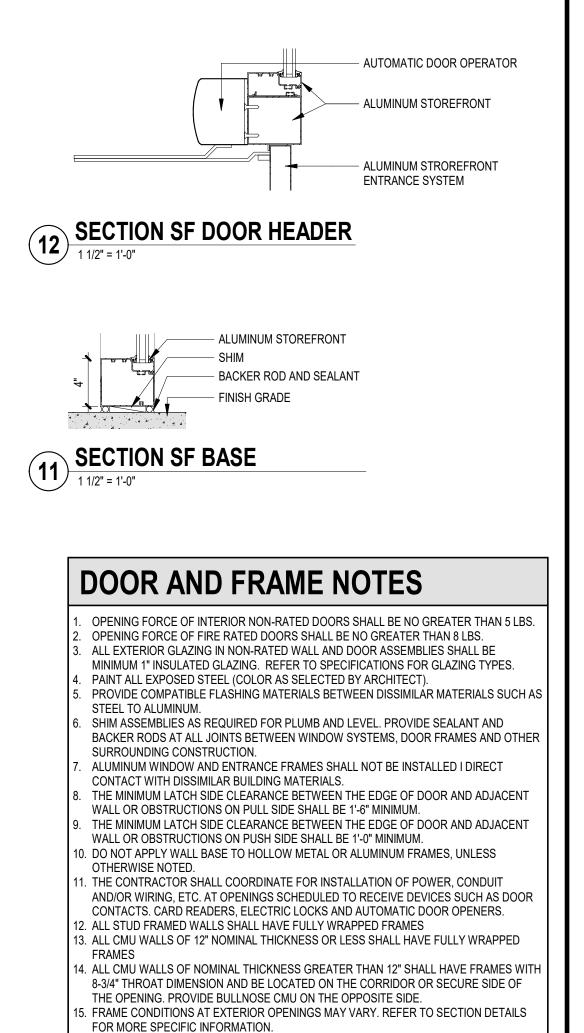


ABBREVIATIONS:

HM - HOLLOW METAL WD - WOOD

AL - ALUMINUM FRP - FIBER REINFORCED POLYMER

CERTIFICATE:	
spiezie	
SPIEZLE ARCHITECTURAL GROUP INC. 121 MARKET STREET CAMDEN, NJ 08102 PHONE: (866) 974 7666	
SIGNATURE:           THOMAS S. PERRINO         21AI01505400           SCOTT E. DOWNIE         21AI01674400           STEVEN LEONE         21AI01170100	)
STEVEN G. SIEGEL 21AI01564200 ANGELO ALBERTO 21AI0146700 JOHN F. WRIGHT 21A01784200 SPIEZLE ARCHITECTURAL GROUP, INC. 21AC00063000	)
SEAL:	
PROJECT:	
HADDONFIELD POLICE STATION	
1 WALNUT STREET, HADDONFIELD, NJ 08033 FOR	
IMPROVEMENT AUTHORITY 520 MARKET STREET, 6TH FLOOR,	
CAMDEN, NEW JERSEY 08102	
FOR CODE REVIEW: 02/23/24 REVISIONS:	1
FOR CODE REVIEW: 02/23/24	
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FOR CODE REVIEW:         02/23/24           REVISIONS:	
FOR CODE REVIEW: 02/23/24 REVISIONS:          #       REVISION NAME       DATE         FOR BID:       06/25/2024         DRAWING TITLE:       DOOR AND FRAME	
FOR CODE REVIEW: 02/23/24 REVISIONS:          Image: Market with the second se	

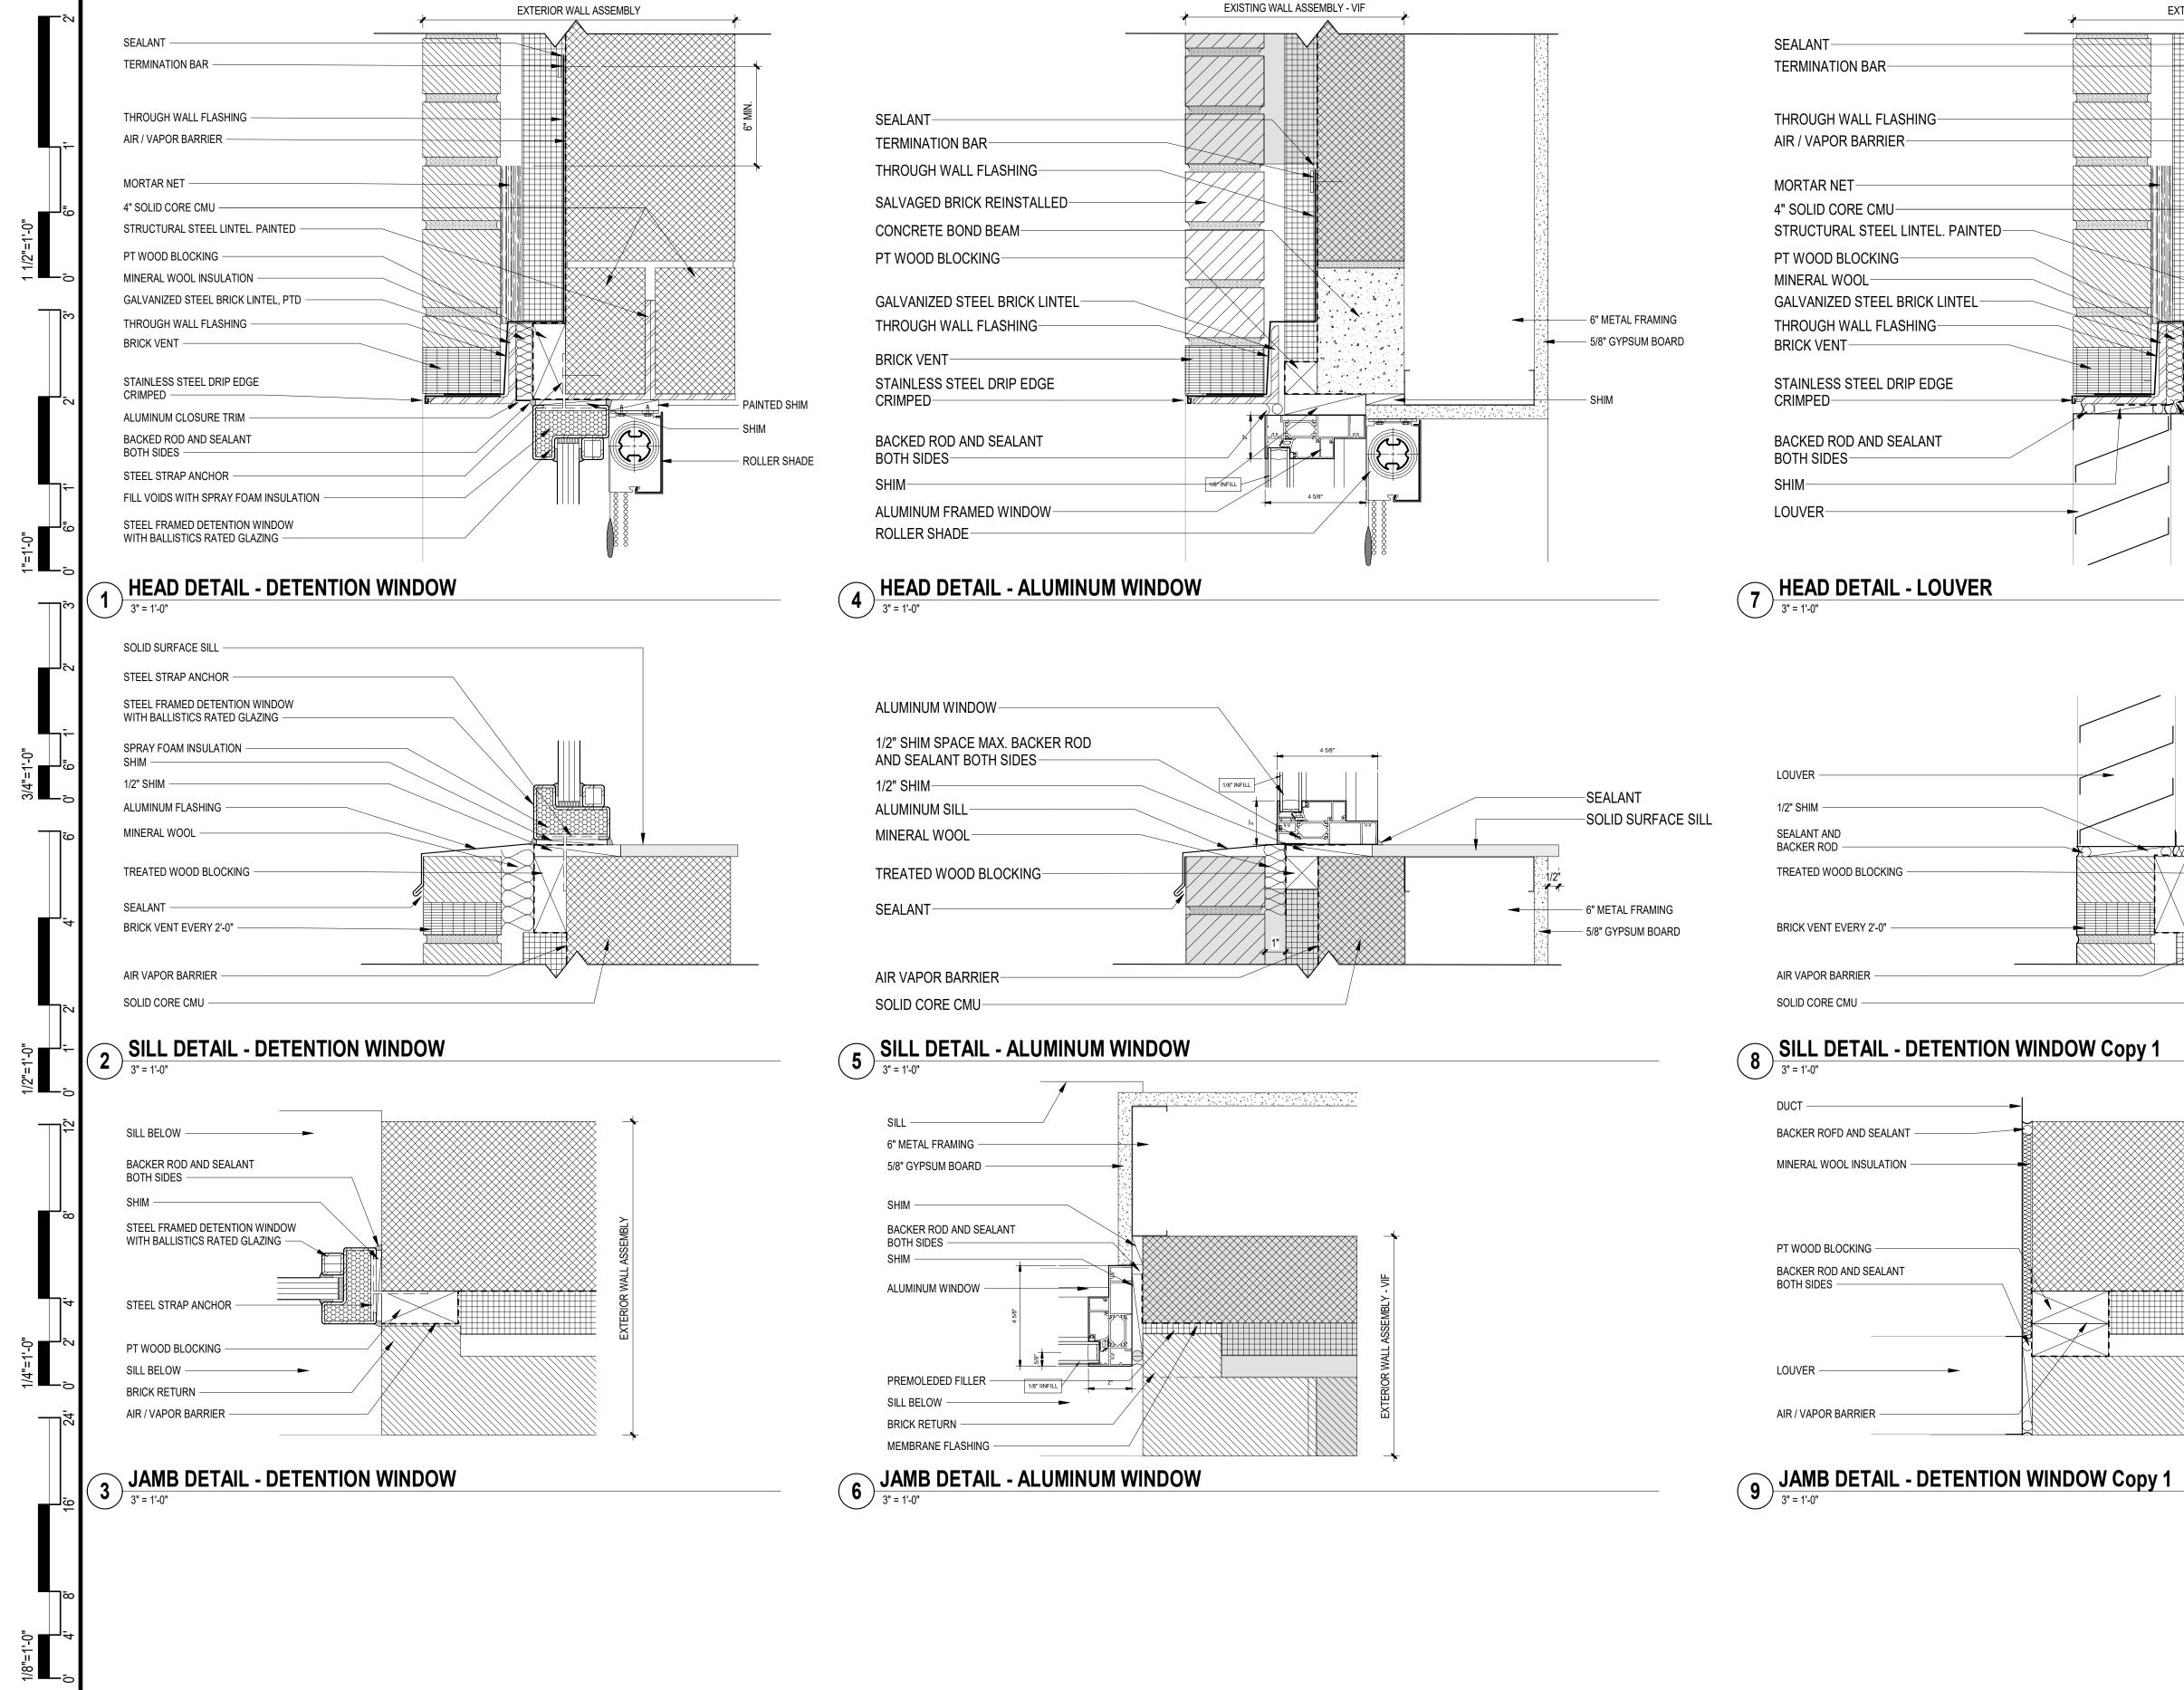

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LOUVER	
1/2" SHIM	
SEALANT AND BACKER ROD	
BRICK VENT EVERY 2'-0"	
AIR VAPOR BARRIER	
SOLID CORE CMU	

### **8** SILL DETAIL - DETENTION WINDOW Copy 1

DUCT		-				
BACKER ROFD AND SEALANT					$\bigotimes$	$\bigotimes$
					$\bigotimes$	$\bigotimes$
					$\bigotimes$	$\bigotimes$
					$\bigotimes$	$\bigotimes$
PT WOOD BLOCKING					$\bigotimes$	$\bigotimes$
BACKER ROD AND SEALANT					$\bigotimes$	$\bigotimes$
BOTH SIDES			$\sim$		$\overset{\times}{\boxplus}$	¥
	/				Ħ	
			$> \!\!\!/$			
LOUVER	►		X	<u>M</u>		$\sum$
						$\langle \rangle$
AIR / VAPOR BARRIER		-1			$\langle \rangle \rangle$	$\langle \rangle$

