ADDITION & ALTERATIONS BURLINGTON COUNTY DEPARTMENT OF PUBLIC WORKS 10 HARTFORD ROAD, DELRAN TWP, NEW JERSEY 08075



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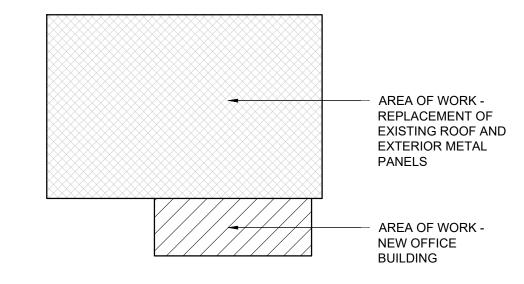


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LOCATION MAP

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	FIRE PROTECTION
FP-1.1	FIRE PROTECTION DEMOLITION FLOOR PLAN
FP-2.1	FIRE PROTECTION FLOOR PLAN
	TINE TROTECTION LEOUR LEAN








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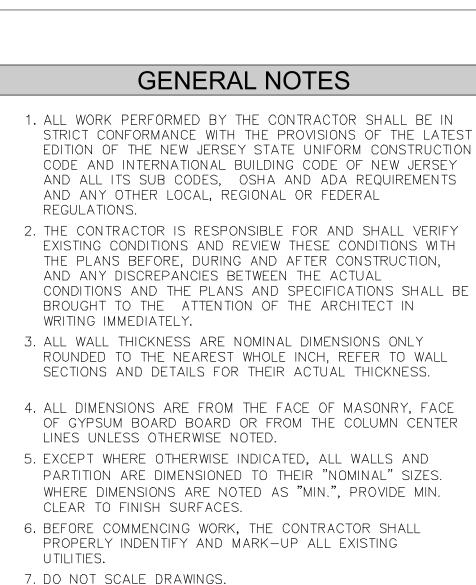
Drawing No.

ADDITIONS AND ALTERATIONS
BURLINGTON COUNTY DEPT. OF
PUBLIC WORKS

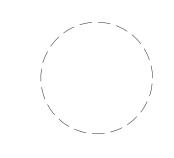10 HARTFORD ROAD, DELRAN TWP.
BURLINGTON CO. NJ

2025.03.12 - ISSUED FOR BID

DATE	REVIS	SIONS	BY	CHKD			
Date		04.09.24					
Scale		AS SHOWN					
Drawn	by	JT					
Checke	d by	LU					
Job No).	2241869					



- UTILITIES.

 7. DO NOT SCALE DRAWINGS.

 8. MINOR DETAILS NOT USUALLY SHOWN OR SPECIFIED BUT NECESSARY FOR PROPER EXECUTION OF ANY PART OF THE WORK SHALL BE INCLUDED AS IF THEY WERE INDICATED IN THE DRAWINGS.
- 9. REFER TO STRUCTURAL, MECHANICAL, ELECTRICAL AND PLUMBING DRAWINGS FOR ADDITIONAL GENERAL NOTES, ABBREVIATIONS, SYMBOLS AND LEGENDS. ALL NOTES ARE TO BE REVIEWED AND APPLIED TO RELATED BUILDING COMPONENTS.
- 10. WHERE PIPING IS TO BE CONCEALED, THE HUNG OR FURRED CEILING IN THIS AREAS ARE NOT TO BE INSTALLED UNTIL THOSE PIPES HAVE BEEN PROPERLY TESTED.
- 11. INTERIOR PARTITIONS SHALL NOT BE BUILT TO FULL HEIGHT UNLESS ALL DUCTS, PIPES, ETC. ARE IN PLACE.
- 12. ALL SPACES WITH FLOOR DRAIN (INCLUDING AREAWAYS)
 SHALL HAVE THEIR FLOORS PITCHED TO THOSE FLOOR
 DRAINS UNLESS OTHERWISE INDICATED ON THE DRAWINGS.
- 13. ALL ITEMS RECESSED INTO RATED PARTITIONS (SUCH AS OUTLET BOXES, PANEL BOXES, ETC) SHALL HAVE THOSE OPENINGS PROTECTED WITH BACK—UP MATERIALS SO AS TO RETAIN THE INTEGRITY OF THE PARTITION RATING THROUGHOUT.
- 14. ALL STRUCTURAL STEEL LESS THAN 8" FROM EXTERIOR SHALL BE PROPERLY WATERPROOFED.
- 15. EXCEPT AS OTHERWISE INDICATED, DOOR SADDLES OR DIVIDING STRIPS ARE REQUIRED AT INTERIOR DOOR OPENINGS WHERE DIFFERENT TYPES OF FLOOR FINISHES OCCUR IN IMMEDIATELY ADJOINING ROOMS, POSITION ON LINE OF CENTER DOOR WHEN DOOR IS CLOSED.
- 16. THE GENERAL CONTRACTOR SHALL FURNISH AND INSTALL ALL LINTELS, STRUTS, BRACKETS, HANGERS, ETC. WHEREVER NECESSARY TO SUPPORT OR BRACE ALL FINISHES, EQUIPMENT RECESSES, HEADS OVER OPENINGS, FURNITURE, ETC.
- 17. THE CONTRACTOR SHALL VERIFY LOCATIONS OF ALL UNDERGROUND UTILITIES AND ELECTRICAL CONDUITS PRIOR TO STARTING ANY EXCAVATION OPERATIONS. SHOULD ANY CONDUITS BE ENCOUNTERED WHICH WERE NOT KNOWN TO EXIST, THE CONTRACTOR SHALL STOP WORK IN THAT AREA AND IMMEDIATELY NOTIFY THE ARCHITECT.
- 18. SWEEPING, BRUSHING, AND OTHER GENERAL CLEANING OF COMPLETED WORK AND THE REMOVAL OF DEBRIS, SURPLUS MATERIALS, TOOLS NOT IN ACTIVE USE, SCAFFOLDING AND OTHER EQUIPMENT NO LONGER NEEDED SHALL BE CARRIED OUT ON AN ONGOING BASIS. IN ADDITION, REMOVE STAINS, SPOTS, MARKS, AND DIRT FROM FINISH WORK. THE JOB IS TO BE MAINTAINED FREE OF RUBBISH. DISPOSE OF ALL RUBBISH IN ACCORDANCE WITH LOCAL ORDINANCES.
- 19. ALL HEIGHTS INDICATED ON REFLECTED CEILING PLANS ARE FROM TOP OF FINISHED FLOOR TO BOTTOM OF CEILING / FIXTURE SPECIFIED, U.O.N..
- 20. THE CONTRACTOR SHALL FURNISH & INSTALL ALL CLIPS, ANGLES AND MISC. STEEL TO SECURE FRAMING TO STRUCTURE
- 21. HINGE SIDE OF DOOR TO BE 4" FROM ADJACENT WALL OR AS OTHERWISE MENTIONED.
- 22. MASONRY OPENING ARE NOMINAL DIMENSIONS, CONTRACTOR TO ALLOW CLEARANCE AT OPENING TO INSTALL WINDOW SYSTEM, DOOR SYTEM OR OTHER ITEMS INSTALLED IN
- 23. ALL METAL FLASHING SHALL BE STAINLESS STEEL, UNLESS NOTED OTHERWISE.
- 24. AT LOCATION WHERE SHELF ANGLES ARE INSTALLED, INSTALL STAINLESS STEEL FLASHING, WEEPHOLES AND MORTAR NET.
- 25. ALL EXPOSED INTERIOR/EXTERIOR METAL ITEMS TO BE PRIMED AND PAINTED (INCLUDING GALVANIZED METALS) UNLESS OTHERWISE NOTED.
- 26 ALL STEEL LINTELS TO BE GALVANIZED AND PAINTED INCLUDING ALL EXTRA STEELS SPECIFIED HEREIN.
- 27 ALL EXPOSED CMU TO BE SPACKLED PRIMED AND PAINTED
- UNLESS OTHERWISE NOTED

 28 CLEANED & RECONDITIONED, ALL EXISTING LOCKERS AFTER WALL & FLOOR FINISHES ARE DONE.


	A1.115.	ABBRE		
T	ALUM. A.F.F. ALT. APPROX. ARCH. ARCH'L.		MISC. M.O. MLDG. M.O.H. MTD. MTL	MISCELLANEOUS MASONRY OPENING MOLDING MIRROR OPPOSITE HAND MOUNTED METAL
-	BD. BLDG. BOT.	BOARD BUILDING BOTTOM	MFD. MDF. MRD. MULL.	METAL FLOOR DECK MEDIUM DENSITY FIBERBOARD METAL ROOF DECK MULLION
	C.J. CLG. CU CLO. C.T. COL. C.M.U. CONC. CONST. CONT. DET. DIA.	CONTROL JOINT CEILING CONDENSING UNIT CLOSET CERAMIC TILE COLUMN CONCRETE MASONRY UNIT CONCRETE CONSTRUCTION CONTINUOUS DETAIL DIAMETER	N NAT. N.I.C. NO. N.T.S. O.A. O.A.I. O.C. OPNG. OPP. ORIG.	NORTH NATURAL NOT IN CONTRACT NUMBER NOT TO SCALE OVERALL OUTSIDE AIR INTAKE ON CENTER OPENING OPPOSITE ORIGINAL
	DIM. DN. DR. DWG.	DIMENSION DOWN DOOR DRAWING		OVERHEAD OVERFLOW DRAIN PARTITION
ı	ELEC. ELECT'L. ENCL. EL. ELEV. EQUIP. EQ. E.W.C. EXIST. E.T.R.	EACH ELECTRIC ELECTRICAL ENCLOSURE ELEVATION ELEVATOR EQUIPMENT EQUAL ELECTRIC WATER COOLER EXISTING EXISTING TO REMAIN EXPANSION	PASS. PLAS. PL. LAM. PL. PLYWD. PANL. PR. PTD. P.V.C. P.S.I.	PLYWOOD PANEL PAIR PAINTED POLYVINYL CHLORIDE
	EXT. E.J. E.O.S.	EXTERIOR EXPANSION JOINT EDGE OF SLAB ELEVATOR MACHINE ROOM	RB RCP	RADIUS RUBBER BASE REFLECTED CEILING PLAN
E	F.E. FDN. FIN. FL. FLR. FLUOR. FT. FTG.	FLOOR DRAIN FREIGHT ELEVATOR FOUNDATION FINISH FLOOR FLOOR FLOOR FLOOR FOOT / FEET FOOTING FIRE RETARDANT TREATED	REF. REFL. REQ'D. REINF. REV. R.H. RM.	ROOF DRAIN REFERENCE REFRIGERATOR REFLECTED REQUIRED REINFORCING REVISION RIGHT HAND ROOM ROUGH OPENING ROOF OVERFLOW DRAIN
	GL. GWB	GAUGE GALVANIZED GLASS GYPSUM WALL BOARD GYPSUM BOARD	SHO. SIM. SK SPECS.	SECTION SHOWER SIMILAR SKETCH SPECIFICATIONS
	HDWR. HDWD. H.M. H.P. HT.	HANDICAPPED HARDWARE HARDWOOD HOLLOW METAL HIGH POINT HEIGHT HEATING, VENTILATION, & AIR CONDITIONING	S/STL. STL. STD. STRUCT. STRUCT'L	SQUARE STAINLESS STEEL STEEL STANDARD STRUCTURE STRUCTURAL SUSPENDED
	HR. I.D.	INSIDE DIAMETER	T.O. TEL. TERR. TRANS.	TOP OF TELEPHONE TERRAZZO TRANSFORMER
	INCL. INFO.	INCH / INCHES INCLUDING INFORMATION INSULATION INVERT	U.L. UNFIN.	TO BE DETERMINED UNDERWRITER'S LABORATORY UNFINISHED
		JOINT LAMINATE LAVATORY	UTIL.	
	LG. L.P. LT.	LONG LOW POINT LIGHT	V.C.T. VERT. VEST. V.I.F.	VINYL BASE VINYL COMPOSITION TILE VERTICAL VESTIBULE VERIFY IN FIELD
	MACH. M.H. MAT'L MAX. MECH. MEMB.	MACHINE MANHOLE MATERIAL MAXIMUM MECHANICAL MEMBRANE	VOL. VTR W/ W.C. WDW.	VOLUME VENT THRU ROOF WITH WATER CLOSET WINDOW

W.F. WIDE FLANGE


W.O. WINDOW OPENING

MINIMUM

MIR. MIRROR

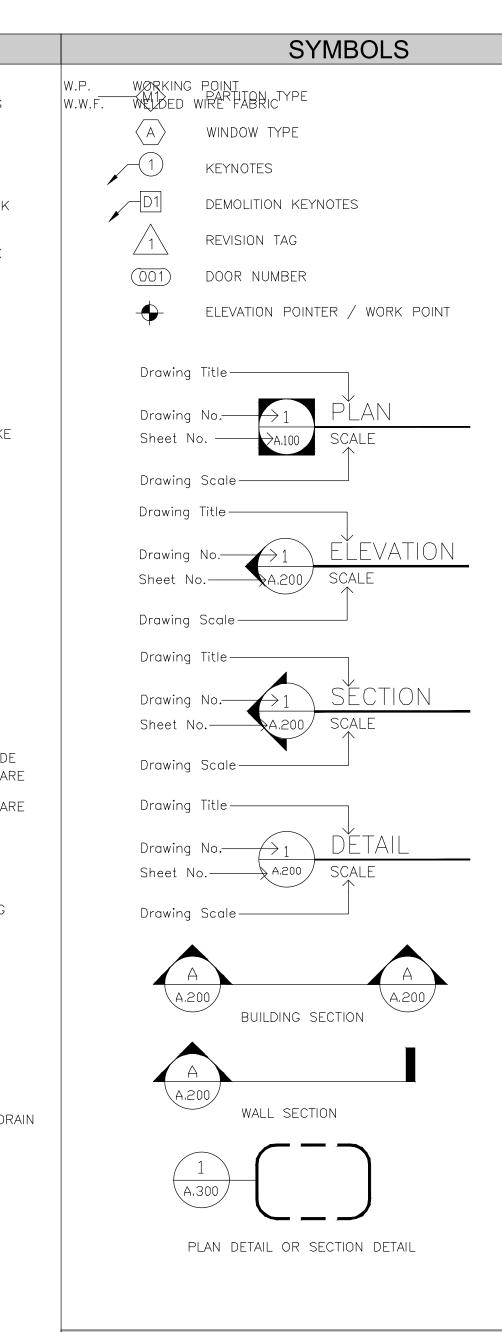


MATERIALS LEGEND CONCRETE BRICK OR FACEBLOCK LIMESTONE/GRANITE STEEL PLYWOOD WOOD STUD / WOOD BLOCKING RIGID INSULATION SHIM GYPSUM BOARD EARTH GRAVEL / POROUS FILL BATT INSULATION

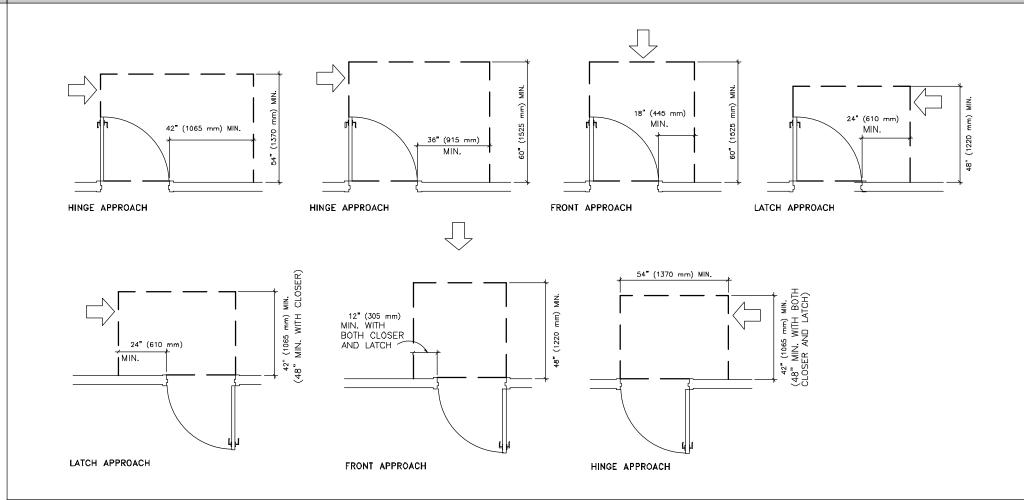


CLEAR WIDTH OF ACCESSIBLE DOORWAYS

ACCESSIBLE CLEARANCES AT SWINGING DOORS

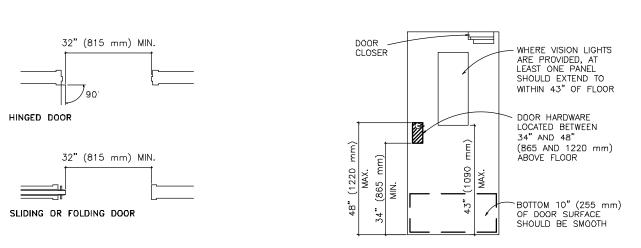



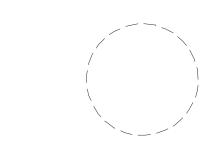

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GENERAL NOTES & ABBREVIATIONS

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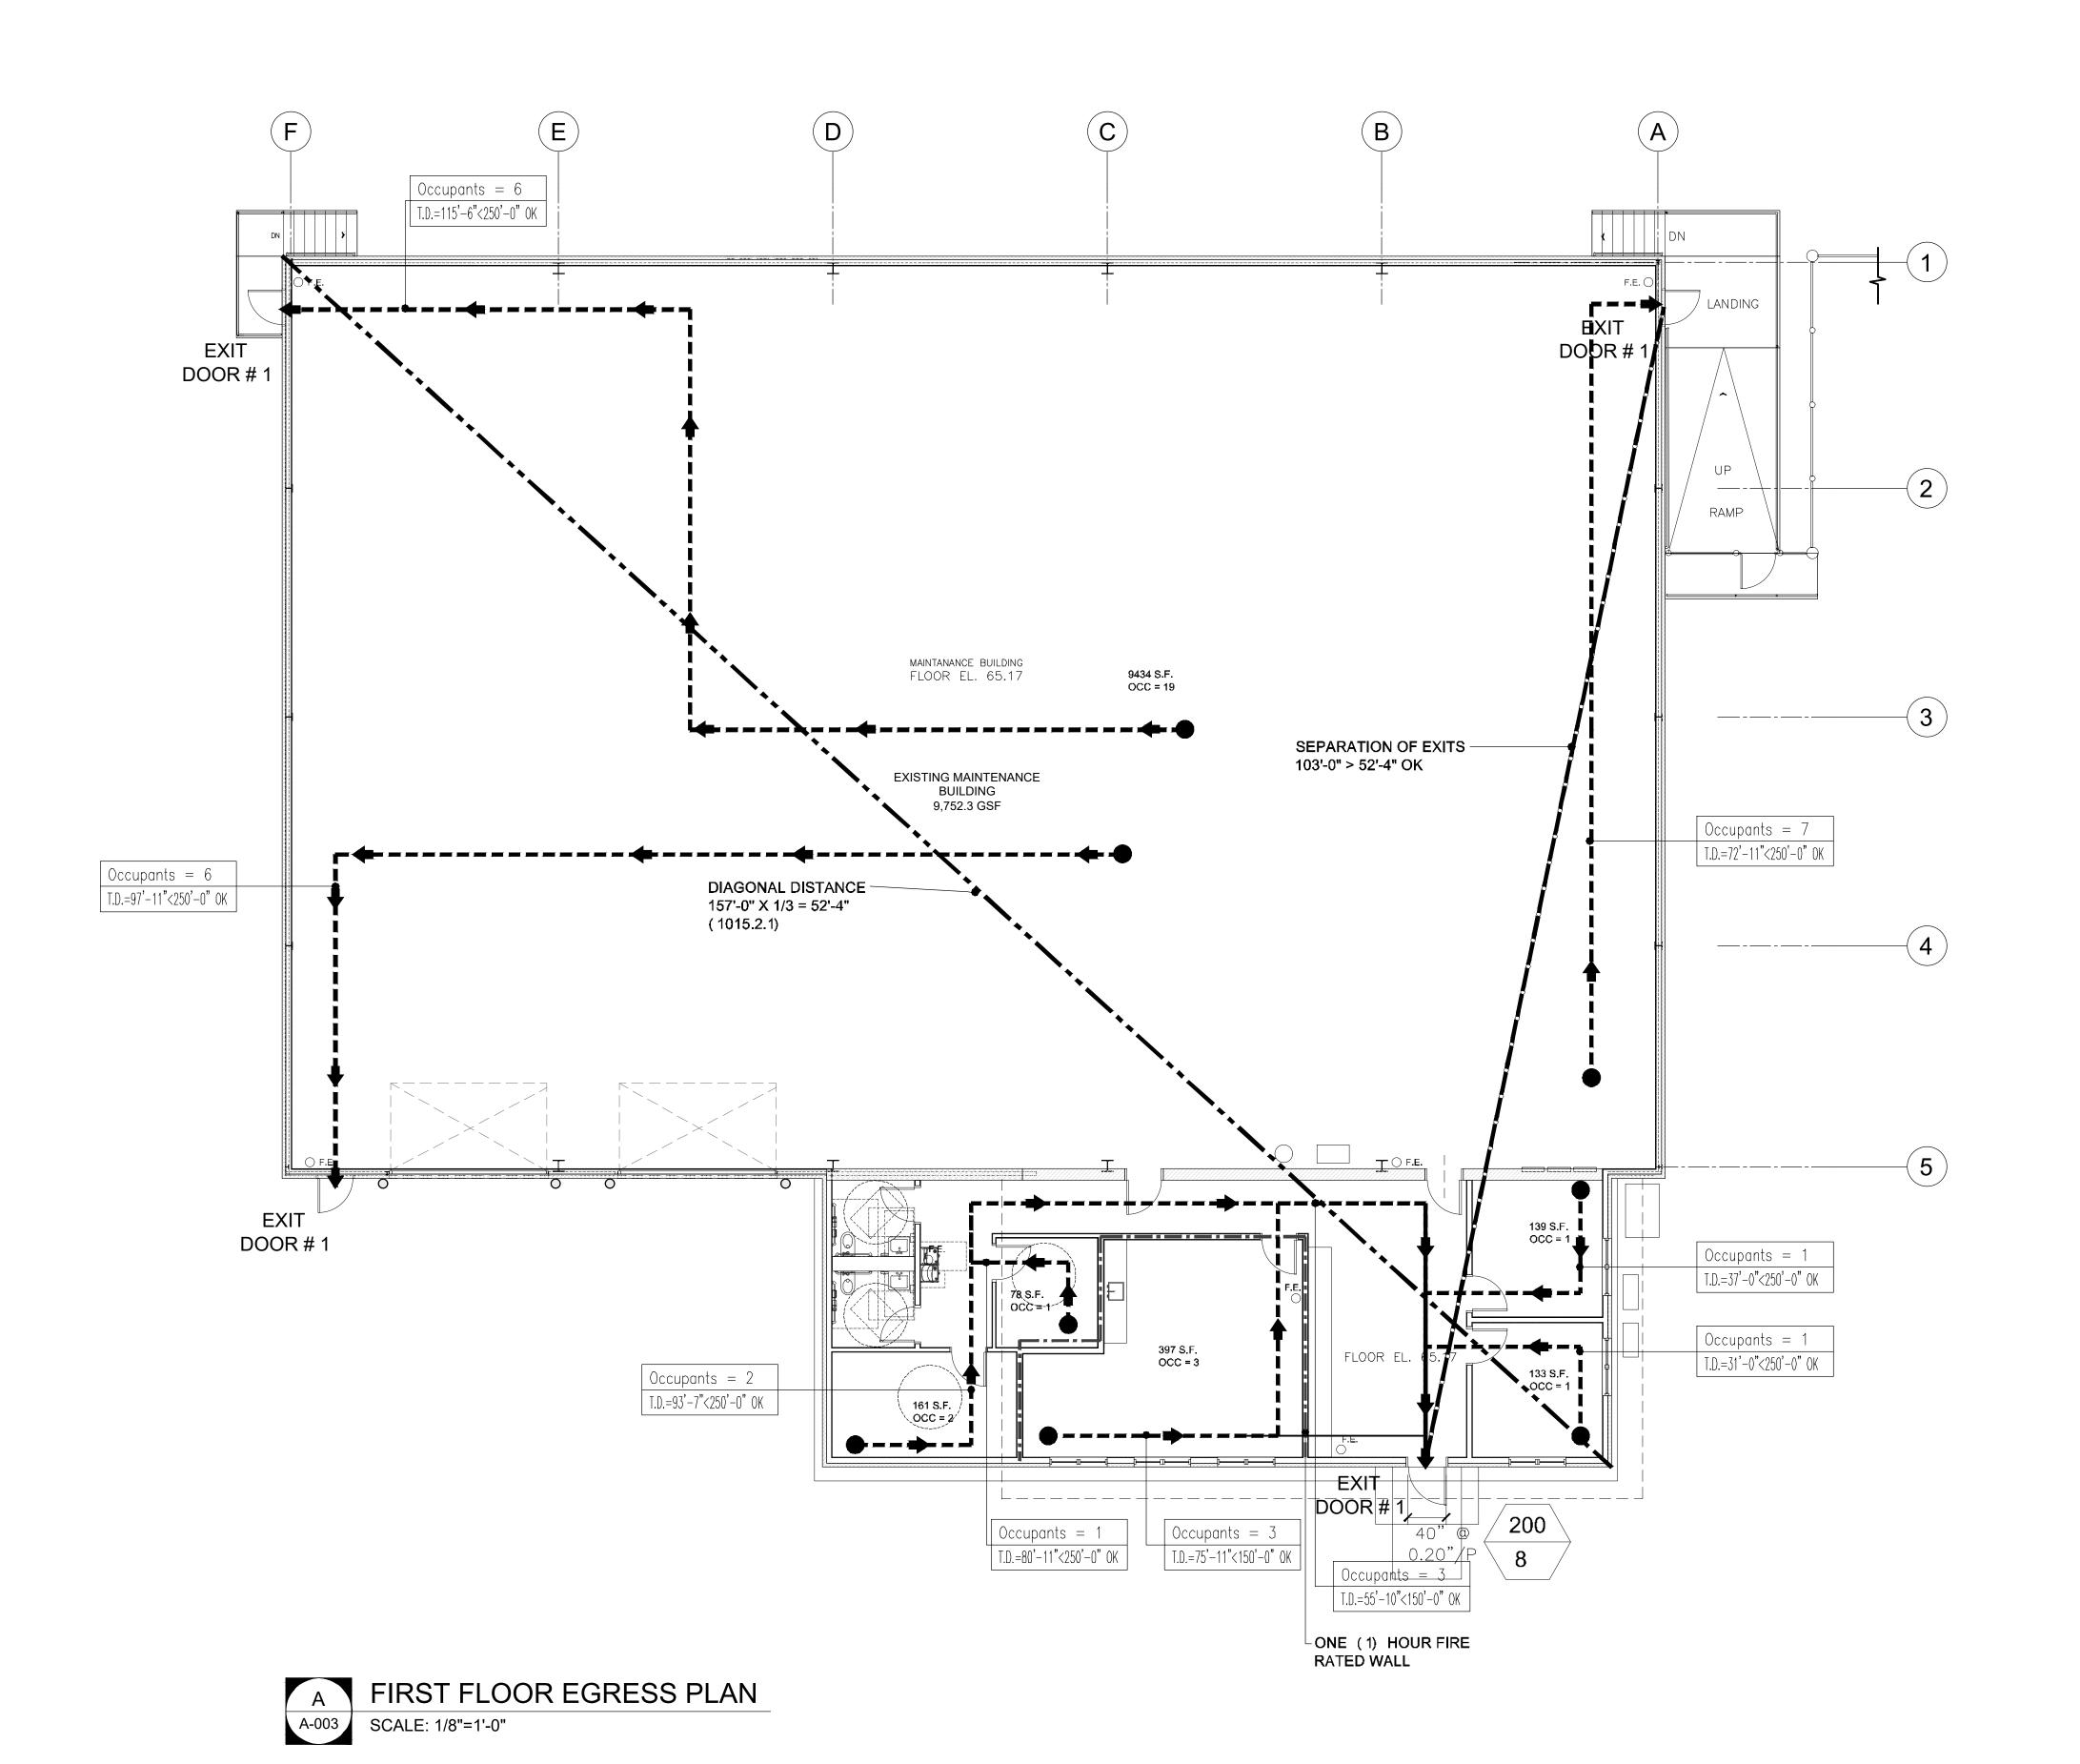
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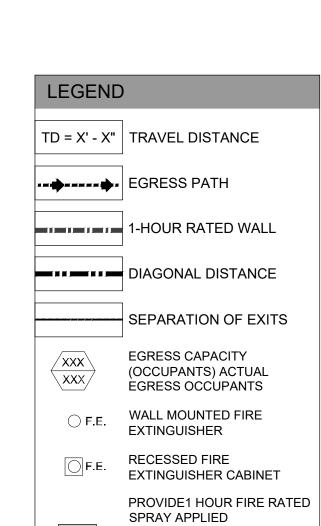
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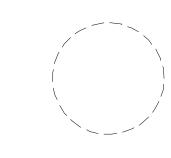
Drawing No.





FIREPROOFING (SFRM)
FLOOR ASSEMBLY - REFER
TO FLOOR CONSTRUCTION
TYPE FL-2 ON DWG A-301

NEW JERSEY | FLORIDA | NEW YORK 1084 Boute 22 West, Mountainside, NJ 07092 | Phone: (973) 379-0006 | www.nettaarchitects.com



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DATE REVISIONS BY CHKD

Date 04.09.24
Scale AS SHOWN
Drawn by JT
Checked by LU
Job No. 2241869

Drawing No.

01 7	ACES WITH ONE EX	XIT (TABLE 1006.2.1)			
OCCUPANCY	MAXIMUN	OCCUPANT LOAD			
GROUP B		49			
	MAX. COMMON PATH	OF EGRESS W/O SPRINKLER = 75'			
GROUP S-1		29			
	MAX. COMMON PATH	OF EGRESS W/O SPRINKLER = 100'			
OCCOI ANCI	SYSTEM				
OCCUPANCY	SPRINKLER SYSTEM	WITH SPRINKLER SYSTEM	REFER		
	200'	300' TABLE			
GROUP B					
GROUP S	300'	400'	TABLE		
GROUP S	300'	CE RATING (TABLE 102)			
GROUP S	300'		0.2)		
GROUP S CORRIDO	R FIRE-RESISTANO OCCUPANT LOAD SERVICED BY	CE RATING (TABLE 102) REQUIRED FIRE-RESISTAN	ICE RAT		
CORRIDO OCCUPANCY	OCCUPANT LOAD SERVICED BY CORRIDOR	CE RATING (TABLE 102) REQUIRED FIRE-RESISTAN (SPRINKLERED SYS)	0.2) ICE RAT		

CONSTRUCTION 1023.2			INTERIOR EXIT STAIRS SHALL BE CONSTRUCTED AS FIRE BARRIERS (SECTION 707) & HORIZ. ASSEMBLIES (SECTION 711) WITH A 1 HR FIRE RATING.					TION	IBC REFERENCE SECTION 1023.2						
		SOU	IND	TRA	NS	MIS	SIC)N ((SE	CTI	ON ⁻	1206	3)		
SOUND TRAN CLASS (REQU	IREMEI	VT								A	CTUAL		SECTION
IMPACT INS CLASS		SEPARAT DWELLIN DWELLIN	G UNIT	/DWELI		INIT	F	LOOR/ ASSEM	CEILIN IBLIES	G					1207
			50					50)				50		1207.2
			50					50)				50		1207.3
MINIMU	IM NUMB	BER O	F RE	QUI	RED	PLU	MBI	NG I	FIXT	URE	STA	ABLE	7.2	1.1 NA	TIONAL
			ST	AND	ARD	PLU	JMBI	NG	COE)E 20	021)				
USE GROUP	NUMBER PERSON	MBER OF		R CLC NALS)					ORIES		DRINK WATER FACIL	₹		AFETY HOWER	OTHER 1 SERVICE
	EACH S		MALE		FEMA		MALE		FEMA	ALE PROVE					SINK PER
			REQD	PROVE	REQD	PROVD	REQD	PROVD	REQD	PROVL	REQD	PROVE	REQD	PROVD	FLOOR
FOR FIRST	FLOOR LEVEL														
BUSINESS	REQUIRED I OF PLUMBII FIXTURES F OCCUPANTS	NG PER													
	1- 15 OCC		1	1	1	1	1	1	1	1	1	0	0	0	1 SERVICE
	16-50 00	CCS	+1		+1		+1		+1		PER 100 0CC.	0	0	0	SINK
] 000.				PER FLOOR
	EA. ADD'L 50 OVER 100 OCCS		+1		+1		+1		+1			0	1		
STORAGE (S-1 & S-2)	REQUIRED 1 OF PLUMBII FIXTURES P OCCUPANTS	NG 'ER													
	50 OR LES	S	1		1		1		1		1 PER		0	0	
	0CCS 51-100 00	CCS	+1		+1		+0		+0		500 0CC.		0	0	1 PROVIDE
	EA. ADD'L 100 OVER 100 OCCS		+1		+1		+1		+1					0	1ST FLR
T	O T A L			1		1		1		1	2			2	
	MIN. N	UMB	ER (OF I	ΞΧΙ	TS P	PER	STO	ORY	/ (T/	ABL	E 10	006.	.3.3)	

EA. ADD'L 100 OVER 100 OCCS	+1	1	+1	1	+1	1	+1	1	2		0	0		1ST FLR
MIN. NUMBER OF EXITS PER STORY (TABLE 1006.3.3)														
OCCUPANT LOAI	OCCUPANT LOAD MIN. NUMBER OF EXITS							IBC REFERENCE						
1-500						2								
501-1,000		3								TABLE 1006.3.3				
MORE THAN 1,000						4								
PERCENTAG	PERCENTAGE OF MAXIMUM ALLOWABLE QUANTITIES (TABLE 414.2.2)										E			
STORY	ALLO	WABI	LE Q	OF M. UANT DL ARE	ITY	(CON	JMBE TROL ER ST	ARE	AS	RA ⁻	RE-RESISTANCE ATING FOR FIRE BARRIERS IN HOURS		

100

ABOVE GRADE PLANE

	FIRE RESISTA	NT RATING REQU ELEMENTS (TA			RBUILDING		
		CONSTRUCTION CLASS	SIFICATION	II-B			
		CRITERION / I	DESIGNATIO	N	IBC REFERENCE		
		ALLOWABLE	ACTU	IAL			
PRIMAR`	Y STRUCTURAL FRAME	0-HR	1-H	R	TABLE 601		
BEARINO – EXTE – INTER		0-HR 0-HR	1-H 1-H		TABLE 601		
NON-BEARING WALLS & PARTITION TABLE 602 - EXTERIOR							
non-bi Partitic – inter		0-HR	1-HR*		TABLE 601		
FLOOR - INCL	CONSTRUCTION UDING SUPPORTING AND JOISTS	0-HR	0-HF	₹*	TABLE 601		
ROOF C	CONSTRUCTION UDING SUPPORTING AND JOISTS	0-HR	0-н	R	TABLE 601		
			* EXCEPT	PER OTH	ER SECTIONS OF CODE		
USE GRO	UP B 0-HR (SPR	INKLERED)	<u>I</u>				
	FIRE A	ND SMOKE PROTE (CHAPTE)		EATU	RES		
SEC.	TITLE		FIRE-RESISTANCE RATING ACTUAL FIRE-F REQUIREMENT RATIN				
704	FIRE-RESISTANCE RATING OF STRUCTURAL MEMBERS	PER TABLE 60	1		PER TABLE 601		
705	EXTERIOR WALLS	PER TABLE 602	2		PER TABLE 601		
706	FIRE WALLS	2-HR (BASED ON TYPE II					

(CHAPTER /)									
SEC.	TITLE	FIRE-RESISTANCE RATING REQUIREMENT	ACTUAL FIRE-RESISTANCE RATING						
704	FIRE—RESISTANCE RATING OF STRUCTURAL MEMBERS	PER TABLE 601	PER TABLE 601						
705	EXTERIOR WALLS	PER TABLE 602	PER TABLE 601						
706	FIRE WALLS	2-HR (BASED ON TYPE II CONSTRUCTION) (TABLE 706.4)	N/A						
707	FIRE BARRIERS	2-HR (TABLE 707.3.10)	N/A						
708	FIRE PARTITIONS	0-HR MIN. WHEN APPLICABLE	0-HR, BASED ON TABLE 1020.2, SPRINKLERED						
709	SMOKE BARRIERS	CORRIDOR WALLS PER TABLE 1020.1, 0-HR, A-3 & B USES	0-HR						
710	SMOKE PARTITIONS	1-HR	N/A						
711	HORIZONTAL ASSEMBLIES	PER CONSTRUCTION TYPE TABLE 601	PER TABLE 601						
713	SHAFT ENCLOSURES	CONNECT 4+ STORIES = 2-HR CONNECT LESS THAN 4 STORIES = 1-HR	1 – HR						
0	OPENING FIRE PROTECTION RATINGS TABLE 716.1 (2)								

			(-)
TYPE OF ASSEMBLY	REQUIRED ASSEMBLY RATING	MIN. FIRE DOOR AND FIRE SHUTTER RATING	DOOR VISION PANEL SIZEb
FIRE WALLS AND FIRE BARRIERS HAVING A REQUIRED FIRE—RESISTANCE RATING GREATER THAN ONE—HOUR	4-HR 3-HR 2-HR 1 1/2-HR	3-HR 3-HR * 1 1/2-HR 1 1/2-HR	SEE NOTE b SEE NOTE b 100 SQ. IN. 100 SQ. IN.
ENCLOSURE FOR SHAFTS, INTERIOR EXIT STAIRWAYS AND INTERIOR EXIT RAMPS	2-HR	1-1/2-HR	100 SQ. IN.
HORIZONTAL EXITS IN FIRE WALLS	4-HR 3-HR	3-HR 3a-HR	100 SQ. IN.
FIRE BARRIERS HAVING A REQUIRED FIRE RESISTANCE RATING OF ONE—HOUR: SHAFTS, EXIT ENCLOSURES AND EXIT PASSAGEWAY WALLS: OTHER FIRE BARRIERS:	1-HR 1-HR	1-HR 3/4-HR	100 SQ. IN. MAXIMUM SIZE TESTED
FIRE PARTITIONS CORRIDOR WALLS: OTHER FIRE PARTITIONS: * ONLY WHERE INDCIATED	1-HR 0.5-HR 0.5-HR*	1/3-HR 1/3-HR 3/4-HR*	MAXIMUM SIZE TESTED
EXTERIOR WALLS	3-HR 2-HR 1-HR	1 1/2-HR 1 1/2-HR 3/4-HR	100 SQ. IN. MAXIMUM SIZE TESTED
SMOKE BARRIERS	1-HR	1/3-HR	MAXIMUM SIZE TESTED

					TESTED
FIRE WINDOW ASSEMBLY FIRE PROTECTION RATINGS (TABLE 716.1 (3)					
TY	PE OF ASSEMBLY	REQUIRED ASSEMBLY RATING		FIRE WINDOW RATING	
	FIRE WALLS	ALL	NOT PE	RMITTED UNLESS EXCEPTION	
INTERIOR WALLS	FIRE BARRIERS	>1-HR 1-HR	NOT PE	RMITTED, UNLESS EXCEPTION	
WALLS	SMOKE BARRIERS	1-HR		3/4-HR	
	FIRE PARTITIONS	1-HR 0.5-HR		3/4-HR 1	/3-HR
EXTERIOR WALLS		>1-HR 1-HR 0.5-HR	1 1/2	2 –HR 3/4–HR	1/3-HR
	PARTY WALL	ALL		NOT PERMIT	TED

	(IADLL / 10.1 (3)				42" OR EXCEPTIONS	
TYPE OF ASSEMBLY		REQUIRED ASSEMBLY	MIN. FIRE WINDOW ASSEMBLY RATING	OPENESS LIMITATION	4" SPHERE TO 34" & 8" SPHERE FROM 34" TO 42" OR EXCEPTIONS	
		RATING	NOT PERMITTED UNLESS COMPLIES WITH	ROOF MECH. EQUIP.	10' FROM ROOF EDGE & EXTEND 30" PAST EQUIP. OPENESS —21" SPHERE	
TERIOR WALLS —	FIRE WALLS	ALL	EXCEPTION A	ROOF HATCH	10' FROM ROOF EDGE >30" & EXTEND NO LESS THAN 30 ENDING. OPENING PREVENT PASSAGE OF 21" SPHERE	
	FIRE BARRIERS	>1-HR 1-HR	NOT PERMITTED, UNLESS COMPLIES WITH EXCEPTION A			
	SMOKE BARRIERS	1-HR	3/4-HR	PORTABLE FIRE EXTINGUISHERS (SI		
	FIRE PARTITIONS	1-HR 0.5-HR	3/4-HR 1/3-HR	1 01	INTABLE FINE EXTINOUISHENG (SECT	
		>1-HR	4.4/0		ORDINARY (MODERATE) HAZARD OCCUPA	
EXTERIOR WALLS		1-HR 1/2-HR 3/4-HR 1/3-HR 0.5-HR		DISCRIPTION		
PARTY WALL		ALL	NOT PERMITTED		WALL MOUNTED	
	MAXI	MUM ALLOWAB	LE QUANTITY PER CONTROL	AREA OF HAZA	RDOUS MATERIALS (TABLE 307.1)	

	MAXIMOM ALLOWABLE QUANTITITIEN CONTINUE ANEA OF TIAZANDOUS MATERIALS (TABLE 507.1)								
MATERIAL	CLASS	GROUP WHEN MAX. ALLOWABLE QUANTITY IS EXCEEDED	STORAGE		USE CLOSED SYSTEMS		USE OPEN SYSTEMS		
			SOLID POUND (CUBIC FEET)	LIQUID GALLONS (POUNDS)	GAS (CUBIC FEET @ NTP)	SOLID POUND (CUBIC FEET)	LIQUID GALLONS (POUNDS)	SOLID POUND (CUBIC FEET)	LIQUID GALLONS (POUNDS)
FLAMMABLE LIQUID	1B AND 1C (ACETIC ACID, ACETONE, ETHANOL)	H-2 OR H-3	NA	10 ≤ 30	NA	NA	1 ≤ 30	NA	NA
OXIDIZER	(POTASSIUM PERMANGANATE)	H-2 OR H-3	1 ≤ 10	1 ≤ 10	NA	.5 ≤ 2	NA	.5 ≤ 2	NA

DOO	RS, GATES & TURNSTILES	S (SECTION 1010))
	ALLOWABLE	ACTUAL	IBC REFERENCE
SIZE OF DOORS	MIN. 32" WIDE MAX. 48" WIDE	3'-0" WIDE MIN. DOORS	1010.1.1
PROJECTION INTO SPACE	4" MAX FOR PROJECTIONS BETWEEN WITH OF 34"WX80"H	LESS THAN 4" PROJECTION	1010.1.1.1
DOOR SWING	SIDE HINGE OR EXCEPTION DIRECTION OF EGRESS > 50 PERSONS	SIDE HINGE	1010.1.2.1
REVOLVING DOORS	SEE IBONJ FOR FURTHER INFO.	N/A	1010.3.1
POWER OPERATED	SEE IBCNJ FOR FURTHER INFO.	N/A	1010.3.2
HORIZONTAL SLIDING	SEE IBCNJ FOR FURTHER INFO.	WILL COMPLY	1010.3.3
ACCESS CONTROLED	SEE IBCNJ FOR FURTHER INFO.	N/A	1010.2.11
SECURITY GRILLES	SEE IBCNJ FOR FURTHER INFO.	N/A	1010.3.4
FLOOR ELEVATIONS	SAME ELEVATION AT BOTH SIDES OF DOOR OR EXCEPTION		1010.1.4
DOOR LANDINGS	LENGTH MIN. 44", DOOR OPEN MAX 7" ONTO LANDING, OR EXCEPTIONS		1010.1.5
THRESHOLDS	.5" MAX . HT. OR EXCEPTIONS		1010.1.6
DOOR ARRANGEMENTS	48" MIN. BETWEEN DOORS PLUS DOOR SWING OR EXCEPTIONS		1010.1.7
DOOR OPERATIONS	READILY OPENABLE WITHOUT USE OF KEY OR EFFORT, OR EXCEPTION		1010.2
PANIC HARDWARE	SEE IBCNJ FOR FURTHER INFO.	AT EXIT DOORS ENTRANCE	1010.2.9

-		RAMPS (SECTION 1012)	
		REQUIREMENT	SECTION
	SLOPE	ADA- 1/12 PEDESTRIAN - 1/8	1012.2
	CROSS SLOPE	1/48	1012.3
	VERTICAL RISE	30" MAX	1012.4
	MINIMUM DIM	WIDTH - NOT LESS THAN CORRIDOR REQUIREMENTS, 36" MIN.	1012.5.1
		HEADROOM - MIN. 80"	1012.5.2
		RESTRICTION—PROJECTIONS PROHIBITED DOOR OPENING —MIN. LANDING 42"	1012.5.3
	LANDINGS	SLOPE-NOT GREATER THAN 1/48	1012.6.1
		WIDTH-MIN AS RAMP	1012.6.2
		LENGTH-60" MIN OR EXCEPTION	1012.6.3
	RAMP CONSTRUCTION	NON-SLIP, OUTDOORS-SHALL NOT ACCUMILATE WATER	1012.7
	HANDRAILS	RISE > 6" - BOTH SIDES	1012.8
	EDGE PROTECTION	CURB, RAIL, WALL— PREVENT 4" DIA. SPHERE OR EXCEPTION	1012.10
	GUARDS	ACCORDANCE W/ SECTION 1015	1012.09
		HANDRAILS (SECTION 1014)	

		HANDRAILS (SECTION 1014)	
		REQUIREMENT	SECTION
	WHERE REQUIRED	RAMPS & STAIRS -SECTION 1607.8, 1011.11 1012.8, 1014.2 THRU 1014.9	1014.1
	HEIGHT	ABOVE NOSING— NOT LESS THAN 34" NOT GREATER THAN 38" OR EXCEPTION	1014.2
1	GRASPBILITY	DIA. MIN 1.25" & MAX 2" OR EXCEPTION	1014.3
	CONTINUITY	CONTINUOUS W/O INTERUPTION OR EXCEPTION	1014.4
	EXTENTIONS	TOP RISER & BOTTOM RISER EXTEND 12" AS WELL AS 12" AT RAMPS	1014.6
	CLEARANCE	MIN. 1.5"	1014.7
	PROJECTIONS	NOT MORE THAN 4.5" INTO REQUIRED WIDTH	1014.8
	INTERMEDIATE	WITHIN 30"	1014.9
1		GUARDS (SECTION 1015)	

	GUANDS (SECTION 1013)				
	REQUIREMENT	SECTION			
WHERE REQUIRED	LANDINGS, STAIRWAYS WALKING SURFACE ETC > 30" OR EXCEPTION	1015.2			
	GUARDRAILS SHALL BE ADEQUATE STRENGTH AND ATTACHMENT IN ACCORDANCE WITH SECTION 1607.9				
HEIGHT	42" OR EXCEPTIONS	1015.3			
OPENESS LIMITATION	4" SPHERE TO 34" & 8" SPHERE FROM 34" TO 42" OR EXCEPTIONS	1015.4			
ROOF MECH. EQUIP.	10' FROM ROOF EDGE & EXTEND 30" PAST EQUIP. OPENESS -21" SPHERE	1015.6			
ROOF HATCH	10' FROM ROOF EDGE >30" & EXTEND NO LESS THAN 30" PAST HATCH ENDING. OPENING PREVENT PASSAGE OF 21" SPHERE	1015.7			
		1015.8			

ROOF HATCH	10' FROM ROOF EDGE >30" & EXTEND ENDING. OPENING PREVENT PASSAGE OF		1015.7		
			1015.8		
POI	RTABLE FIRE EXTINGUISH	ERS (SECTION 906)			
ORDINARY (MODERATE) HAZARD OCCUPANY					
	DISCRIPTION	TOTAL EXTI	NGUISHERS		
WALL MOUNTED 7			7		

BUILDING CODE INFORMATION				
PROJECT NAME:	DDITIONS AND ALTERATIONS BURLINGTON COUNTY MOSQUITO ONTROL BUILDING			
LOCATION:	10 HARTFORD ROAD, DELRAN TWP, BURLINGTON, NJ			
LOT & BLOCK NO.:	BLOCK 83, LOTS 11 & 12A			
ZONE:	C-2 (GENERAL COMMERCIAL)			
THE PRIMARY CODE REFERENCE WILL BE THE NEW JERSEY UNIFORM CONSTRUCTION CODE (N.J.A.C. 5:23 ET SEQ). THE UNIFORM CONSTRUCTION CODE ADOPTS SEVERAL MODEL CODES THAT ARE REFERENCED AS SUBCODES. THESE SUBCODES ARE AN INTEGRAL PART OF THE UNIFORM CONSTRUCTION CODE AND ARE AS FOLLOWS:				
SUBCODE				

CODE AND ARE AS FO	OLLOWS:	
SUBCODE	NATIONAL MODEL CODE	UCC REFERENCE
BUILDING	INTERNATIONAL BUILDING CODE 2021 NJ Edition	N.J.A.C. 5:23-3.14
ACCESSIBILITY	ANSI-A117.1 - 2017	N.J.A.C. 5.23-7
PLUMBING	NATIONAL STANDARD PLUMBING CODE 2021, NJ Edition	N.J.A.C. 5:23-3.15
ELECTRICAL	NATIONAL ELECTRICAL CODE (NFPA 70) 2020	N.J.A.C 5:23-3.16
ENERGY	INTERNATIONAL ENERGY CONSERVATION CODE / 2021	N.J.A.C. 5:23-3.18
MECHANICAL	INTERNATIONAL MECHANICAL CODE / 2021	N.J.A.C. 5.23-3.20

GENERAL BUILDING INFORMATION				
	CRITERION / DESIGNATION	IBC REFERENCE		
USE AND OCCUPANCY CLASSIFICATION	GROUP B — BUSINESS GROUP GROUP S—1 — MODERATE HAZARD STORAGE (VEHICLE REPAIR GARAGE)	SEC. 304, & 311.2		
CONSTRUCTION CLASSIFICATION	II-B	TABLES 504.3, 504.4, 506.2 & 601		
FIRE SUPPRESSION	YES	SEC. 903.2.1.3		

GENERAL BUILDING HEIGHTS & AREAS

INTERIOR WALL AND CEILING FINISH REQUIREMENTS BY OCCUPANCY (TABLE 803.13)

SPRINKLERED

REQUIRED SEPARATION OF OCCUPANCIES (TABLE 508.4)

ACTUAL

1-HR

1-HR

EXIT ENCLOSURES AND

EXIT PASSAGEWAYS

REQUIRED RATING

NO SEPARATION

REQUIRED

NO SEPARATION

REQUIRED

ALLOWABLE BUILDING HEIGHT AND AREA (CHAPTER 5)
GROUPS: B - BUSINESS S-1 - MODERATE HAZARD STORAGE CONSTRUCTION TYPE: II-B

OVERALL ACTUAL BUILDING INFORMATION: STORIES: 1-STORY HEIGHT: 27'-7.5"' ± HIGH TO TOP OF PARAPET WALL

RENOVATION AREAS: FIRST FLOOR LEVEL RENO: 11,549 S.F. TOTAL AREA: 11,549 S.F.

GROUP B - BUSINESS CONSTRUCTION TYPE: II-B ALLOWABLE HEIGHT: 75' H SPRINKLERED (TABLE 504.3) ALLOWABLE STORIES: 4-STORIES (TABLE 504.4) ALLOWABLE AREA = 14,500 S.F. (GROUP B - "NS" TABLE 506.2) (WITHOUT THE ADDITION OF AN

ALLOWABLE FRONTAGE INCREASE, SEE BELOW) GROUP S-1 -MODERATE HAZARD STORAGE CONSTRUCTION TYPE: II-B ALLOWABLE HEIGHT: 75' (TABLE 504.3)

ALLOWABLE STORIES: 4-STORIES (TABLE 504.4) ALLOWABLE AREA = 17,500 S.F. (GROUP S-1 - "NS" TABLE 506.2)

SEPARATED USES ALLOWABLE AREAS X USE GROUP ACTUAL AREA X USE GROUP ALLOWABLE AREA PROVIDED: B 1,797 SF S-1 9,752 SF ALLOWED: B 92,000 SF S-1 70,000 SF


GROUP

В

OCCUPANCY

B/S-1



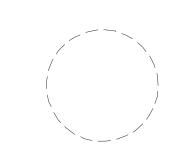

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SHEET CONTENTS:

BUILDING CODE INFORMATION

PROJECT TITLE:

ADDITIONS AND ALTERATIONS BURLINGTON COUNTY DEPT. OF PUBLIC WORKS 10 HARTFORD ROAD, DELRAN TWP. BURLINGTON CO. NJ

SUBMISSION: 2025.03.12 - ISSUED FOR BID

DATE REVISIONS BY CHKD CORRIDORS ROOMS AND ENCLOSED

SPACE

IBC REFERENCE

TABLE 508.4

TABLE 508.4

04.09.24 AS SHOWN Scale JT Drawn by Checked by LU 2241869 Job No.

Drawing No.



Has Heat Pump:

COMcheck Software Version COMcheckWeb

Envelope Compliance Certificate

Project Information

Energy Code: 2021 IECC Project Title: Warehouse Building Location: Burlington, New Jersey Climate Zone: Project Type: Addition Vertical Glazing / Wall Area: 6% All Electric: false false Is Renewable: Has Battery: false false Has Charger: true

Construction Site: 10 Hartford Road Delran, New Jersey 08075

Burlington County Department of 10 Hartford Road Delran Township, New Jersey 08075 Designer/Contractor: Larry Uher Netta Architects 1084 West Route 22 Mountainside, New Jersey 07092 973-379-0006 luher@nettaarchitects.com

Efficiency Packages Description Credit

Building Area Floor Area 1-Office (Office) : Nonresidential

Envelope Assemblies

Envelope Assemblies						
Assembly	Gross Area or Perimeter	Cavity R-Value	Cont. R-Value	Proposed U-Factor	Budget U- Factor _(a)	
Roof: Roof, [Bldg. Use 1 - Office]	1800	(444)	33.5	0.029	0.032	
Floor: Floor, Vertical 3 ft., [Bldg. Use 1 - Office] (c)	153		10.0	0.510	0.520	
NORTH Entrance Wall: Entrance Wall, Single Layer Mineral Fiber (compressed at girt), [Bldg. Use 1 - Office]	890	19.0	23.0	0.034	0.052	
Door: , Swinging, [Bldg. Use 1 - Office]	21	<u> 2-2</u> 8	200	0.360	0.370	
Lab Window 1 of 3: , Perf. Specs.: Product ID Kawneer Nx-3500 with solarban 60, SHGC 0.33, [Bldg. Use 1 - Office] (b)	17		<u>- 110</u> 0	0.470	0.450	

ject Title:	Warehouse Building	Report date: 01/13/25
a filename:		Page 1 of 21

Assembly	Gross Area or Perimeter	Cavity R-Value	Cont. R-Value	Proposed U-Factor	Budget U- Factor _(a)
Lab Window 1 of 3 1: , Perf. Specs.: Product ID Kawneer Nx-3500 with solarban 60, SHGC 0.33, [Bldg. Use 1 - Office] (b)	17	2	1232	0.470	0.450
Lab Window 1 of 3 2: , Perf. Specs.: Product ID Kawneer Nx-3500 with solarban 60, SHGC 0.33, [Bldg. Use 1 - Office] (b)	17			0.470	0.450
Office 01 Window: , Perf. Specs.: Product ID Kawneer Nx-3500 with solarban 60, SHGC 0.33, [Bldg. Use 1 - Office] (b)	17	1212		0.470	0.450
EAST East Wall: East Wall, Single Layer Mineral Fiber (compressed at girt), [Bldg. Use 1 - Office]	380	19.0	23.0	0.034	0.052
<u>NEST</u> West Wall: West Wall, Single Layer Mineral Fiber (compressed at girt), [Bldg. Use 1 - Office]	380	19.0	23.0	0.034	0.052
Office 02 Window 1: , Perf. Specs.: Product ID Kawneer Nx-3500 with solarban 60, SHGC 0.33, [Bldg. Use 1 - Office] (b)	17	222	222	0.470	0.450
Office 01 Window 2: , Perf. Specs.: Product ID Kawneer Nx-3500 with solarban 60, SHGC 0.33, [Bldg. Use 1 - Office] (b)	17	(222)	h 	0.470	0.450
(a) Budget U-factors are used for software baselir (b) Fenestration product performance must be ce (c) Slab-On-Grade proposed and budget U-factors Envelope PASSES: Design 13% better than code	rtified in accord s shown in table	ance with I	NFRC and re	na na militar para na manana m	
Compliance Statement: The proposed envelope des specifications, and other calculations submitted with designed to meet the 2021 IECC requirements in CO	this permit app	lication. Th	he proposed	l envelope sy	stems have been
isted in the Inspection Checklist.					

Report date: 01/13/25


Report date: 01/13/25

Page 5 of 21

Page 2 of 21

Project Information						
Energy Code:	2021 IECC					
Project Title:	Warehouse Building					
Project Type:	Addition					
Construction Site:	Owner/Agent:	Designer/0	Contractor:			
10 Hartford Road	Burlington County Department of	Larry Uh				
Delran, New Jersey 08075	Public Works	Netta Arc				
	10 Hartford Road Delran Township, New Jersey 0807		st Route 22 side, New J		92	
	Delitari Township, New Jersey 0007	973-379-	0006		<i>,</i>	
		luher@ne	ettaarchited	ts.com		
Efficiency Packages						
Description		Credit				
Allowed Interior Lighting	g Power		•3			
	A	В	С		D	
Are	ea Category I	Floor Area (ft2)	Allowed Watts / ft		Allowed Watts	
1-Lab (Common Space Types:Lab	oratory For Medical/Industrial/Research)	395	1.33		525	
2-Lobby & Hallway (Common Space		552	0.84		464	
3-Office - 01 (Common Space Typ	es:Office - Enclosed)	133	0.74		98	
4-Office - 02 (Common Space Typ	es:Office - Enclosed)	133	0.74		98	
5-Men Locker Rm (Common Space	e Types:Locker Room)	156	0.52		81	
6-Women Locker Rm (Common Sp		81	0.52		42	
7-Unisex Bathrm 104 (Common S	7.0	48	0.63		30	
8-Unisex Bathrm 105 (Common S	pace Types:Restrooms)	48	0.63	1-44-	30	
		10	al Allowed W	raus =	1370	
Proposed Interior Lighti		В	С	D	E	
Fixture ID : Descripti	A on / Lamp / Wattage Per Lamp / Ballast	Lamps/	# of	Fixture	(C X D)	
т		Fixture	Fixture	Watt.		
	Laboratory For Medical/Industrial/Researc					
2x4: 2x4: LED:	Connect Transplation Connection	0	7	33	233	
2-Lobby & Hallway (Common ! 2x4: 2x4: LED:	Space Types:Lobby - General)	0	6	33	200	
2x2: 2x2: LED:		0	5	23	117	
3-Office - 01 (Common Space	Types:Office - Enclosed)	1				
2x4: 2x4: LED:		0	2	33	67	
4-Office - 02 (Common Space 2x2: 2x2: LED:	Types:Office - Enclosed)	0	4	23	93	
5-Men Locker Rm (Common S	pace Types:Locker Room)	Ü	্র	20	55	
Project Title: Warehouse Buildi	na		6	Report dat	e: 01/13/	



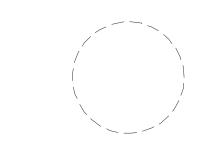

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BUILDING COMPLIANCE

INFORMATION

ADDITIONS AND ALTERATIONS

BURLINGTON COUNTY DEPT. OF

PUBLIC WORKS

10 HARTFORD ROAD, DELRAN TWP.

BURLINGTON CO. NJ

BY CHKD

2025.03.12 - ISSUED FOR BID

SHEET CONTENTS:

PROJECT TITLE:

SUBMISSION:

DATE REVISIONS

A Fixture ID : Description / Lamp / Wattage Per Lamp / Ballast	B Lamps/ Fixture	C # of Fixture	D Fixture Watt.	(C X D)
2x4: 2x4: LED:	0	2	33	67
6-Women Locker Rm (Common Space Types:Locker Room) 2x4: 2x4: LED:	0	1	33	33
7-Unisex Bathrm 104 (Common Space Types:Restrooms) 2x4: 2x4: LED:	0	ĭ	33	33
8-Unisex Bathrm 105 (Common Space Types:Restrooms) 2x4: 2x4: LED:	0	1	33	33

	Total Proposed Watts = 8
Proposed Interior Lighting Controls	
Fixture	Lighting Control
1-Lab (Common Space Types:Laboratory For Medical/Ir	ndustrial/Research)
2x4: 2x4: LED:	Occupancy Sensor, Manual Control
2-Lobby & Hallway (Common Space Types:Lobby - Gen	neral)
2x4: 2x4: LED:	Occupancy Sensor, Manual Control
2x2: 2x2: LED:	Occupancy Sensor, Manual Control
3-Office - 01 (Common Space Types:Office - Enclosed)	
2x4: 2x4: LED:	Occupancy Sensor, Manual Control
4-Office - 02 (Common Space Types:Office - Enclosed)	
2x2: 2x2: LED:	Occupancy Sensor, Manual Control
5-Men Locker Rm (Common Space Types:Locker Room	1
2x4: 2x4: LED:	Occupancy Sensor, Manual Control
6-Women Locker Rm (Common Space Types:Locker Ro	oom)
2x4: 2x4: LED:	Occupancy Sensor, Manual Control
7-Unisex Bathrm 104 (Common Space Types:Restroom	ns)
2x4: 2x4: LED:	Occupancy Sensor, Manual Control
8-Unisex Bathrm 105 (Common Space Types:Restroom	ns)
2x4: 2x4: LED:	Occupancy Sensor, Manual Control

Interior Lighting Compliance Statement

Name - Title

Data filename:

Compliance Statement: The proposed interior lighting design represented in this document is consistent with the building plans, specifications, and other calculations submitted with this permit application. The proposed interior lighting systems have been designed to meet the 2021 IECC requirements in COMcheckWeb and to comply with any applicable mandatory requirements listed in the Inspection Checklist.

Project Title:	Warehouse Building	Report date: 01/13/25

	or Lighting Con	npııaı	nce (Jerti	ficat	e
Project Information						
Energy Code: Project Title: Project Type: Exterior Lighting Zone	2021 IECC Warehouse Building Addition 3 (Other (LZ3))					
Construction Site: 10 Hartford Road Delran, New Jersey 08075	Owner/Agent: Burlington County Departn Public Works 10 Hartford Road Delran Township, New Jers		Mountain 973-379-	er chitects st Route 22 sside, New J	ersey 070	92
Efficiency Packages						
Description		8	Credit	3		
A Area/Surface Cate Entry Facade Lighting (Illuminated		Andrew Section 2011	C Allowed Watts /	Tradable Wattage		E ed Watt X C)
Life y racase Lighting (munimated	ratea of facade wall of surface)	o itz	Total Tradab Base Site Al	le Watts (a)	=	0 500 1
	illowed between tradable areas/surfac to 500 watts may be applied toward o		both non-tr	adable and	tradable	
areas/surfaces.			220	122	7 <u>22</u>	120
	ng Power		В	C # of	D Fixture	(C X I
Proposed Exterior Lighti	ng Power A on / Lamp / Wattage Per Lamp / Balla	ast	Lamps/ Fixture	Fixture	Watt.	
Proposed Exterior Lighting Fixture ID : Description Entry Facade Lighting (Illumina)	A on / Lamp / Wattage Per Lamp / Balla ated area of facade wall or surface	V4.50.900)	Fixture n-tradable	0.000 100 000 000 000 000 000 000 000 00	Watt.	20
Proposed Exterior Lighti Fixture ID : Description	A on / Lamp / Wattage Per Lamp / Balla ated area of facade wall or surface	V4.50.900)	Fixture n-tradable	0.000 100 000 000 000 000 000 000 000 00	Watt.	20
Proposed Exterior Lighting Fixture ID : Description Entry Facade Lighting (Illumina)	A on / Lamp / Wattage Per Lamp / Balla ated area of facade wall or surface e: LED:	V4.50.900)	Fixture n-tradable	Wattage 6	Watt.	0,000
Proposed Exterior Lightic Fixture ID : Description Entry Facade Lighting (Illumina Exterior Sconce: Exterior Sconce) Proposed Exterior Lighting	A on / Lamp / Wattage Per Lamp / Balla ated area of facade wall or surface e: LED:	V4.50.900)	Fixture n-tradable 0 Total Trad	Wattage 6	Watt. 34 sed Watts =	0,000
Proposed Exterior Lightic Fixture ID : Description Entry Facade Lighting (Illumina Exterior Sconce: Exterior Sconce) Proposed Exterior Lighting	A on / Lamp / Wattage Per Lamp / Balla ated area of facade wall or surface be LED: ng Controls	e, 6 ft2): Nor	Fixture n-tradable 0 Total Trad	Wattage 6 dable Propos hting Cont	Watt. 34 sed Watts =	0,000

Project Title: Warehouse Building

Project Title: Warehouse Building

Data filename:

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Data filename:

Exterior Lighting PASSES: Design 0.0% better than code Exterior Lighting Compliance Compliance Statement: The proposed exterior lighting design represented in this document is consistent with the building plans, specifications, and other calculations submitted with this permit application. The proposed exterior lighting systems have been designed to meet the 2021 IECC requirements in COMcheckWeb and to comply with any applicable mandatory requirements listed in the Inspection Checklist. Name - Title Project Title: Warehouse Building Report date: 01/13/25 Data filename: Page 6 of 21



COMcheck Software Version COMcheckWeb **Mechanical Compliance Certificate**

Project Information

2021 IECC Energy Code: Warehouse Building Project Title: Burlington, New Jersey Location: Climate Zone: Project Type: Addition

Construction Site: 10 Hartford Road Delran, New Jersey 08075

Owner/Agent: **Burlington County Department of** Public Works 10 Hartford Road Delran Township, New Jersey 08075

Designer/Contractor: Larry Uher Netta Architects 1084 West Route 22 Mountainside, New Jersey 07092 973-379-0006 luher@nettaarchitects.com

Credit

Efficiency Packages Description

Mechanical Systems List

Quantity System Type & Description

2 TRANE NTXWPH06B112AA (Single Zone): Split System Heat Pump Heating Mode: Capacity = 14 kBtu/h, Proposed Efficiency = 11.90 HSPF2, Required Efficiency = 7.50 HSPF2

Cooling Mode: Capacity = 9 kBtu/h, Proposed Efficiency = 32.20 SEER2, Required Efficiency = 14.30 SEER2 Proposed Part Load Efficiency = 0.00 , Required Part Load Efficiency = 0.00

Mechanical Compliance Statement

Compliance Statement: The proposed mechanical design represented in this document is consistent with the building plans, specifications, and other calculations submitted with this permit application. The proposed mechanical systems have been designed to meet the 2021 IECC requirements in COMcheckWeb and to comply with any applicable mandatory requirements listed in the Inspection Checklist.

Name - Title

Project Title: Warehouse Building

Data filename:

Signature

Scale Drawn by Checked by LU


Report date: 01/13/25 Page 7 of 21


2241869 Job No. Drawing No.

JT


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AS SHOWN




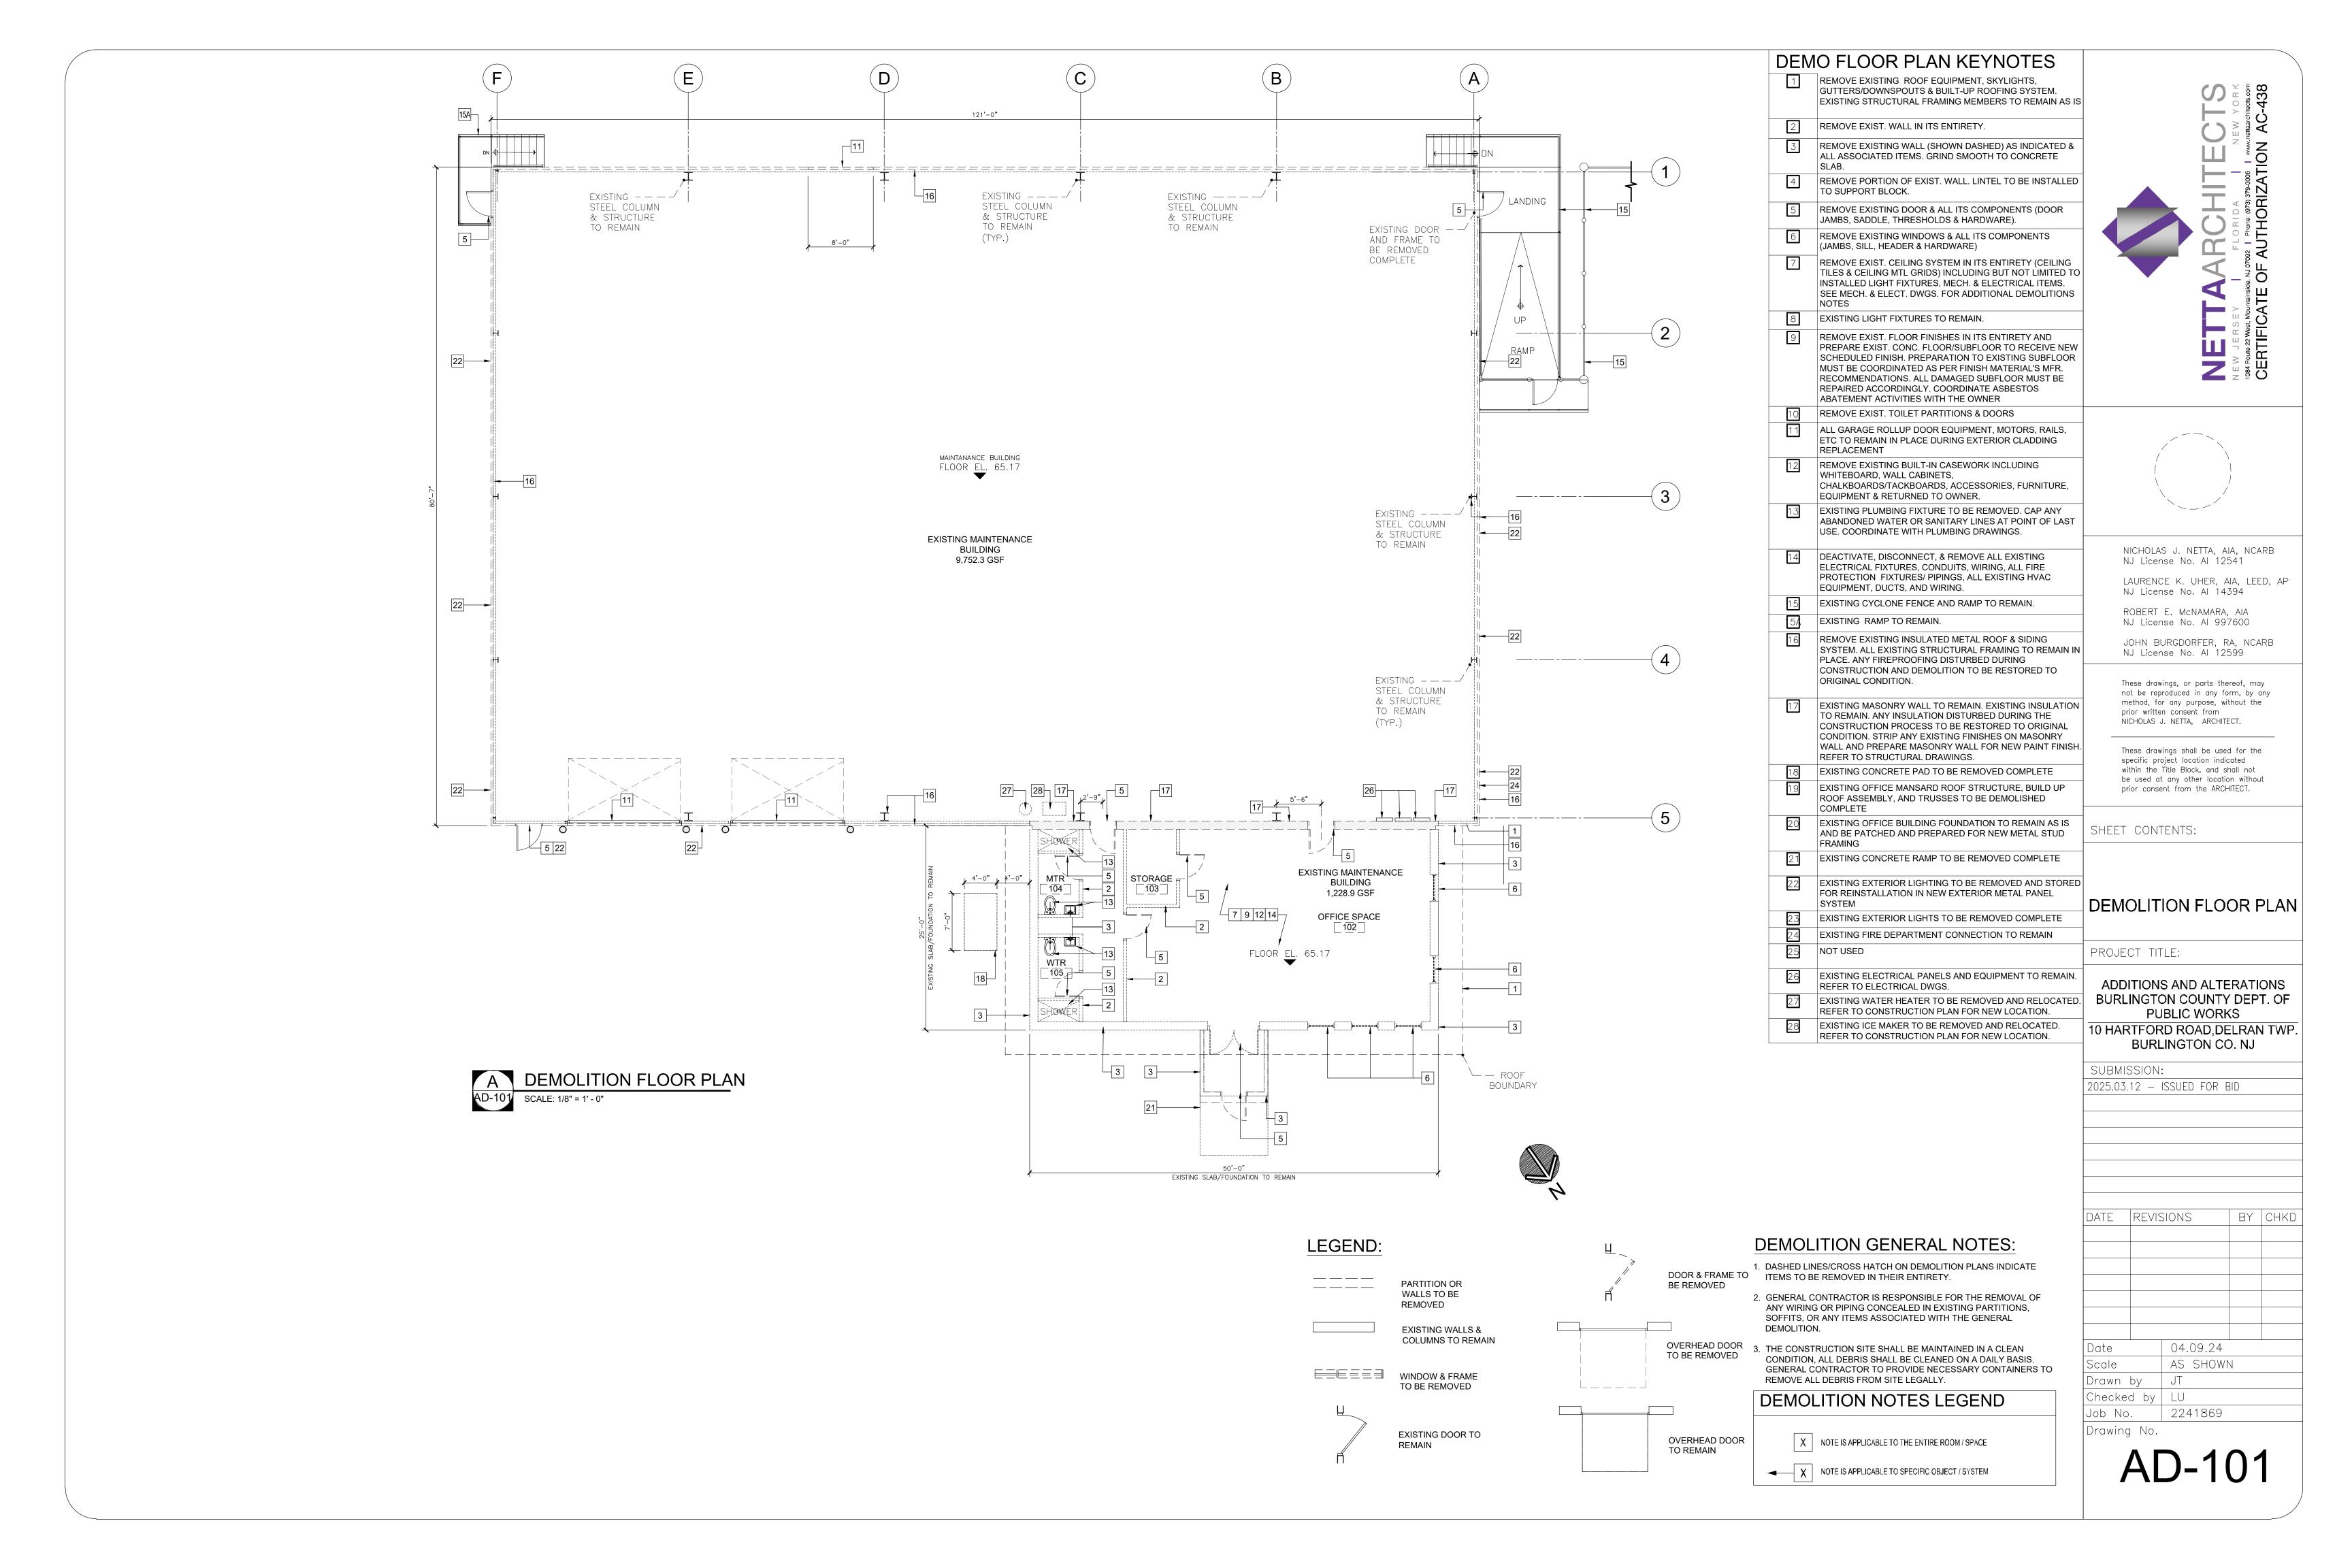

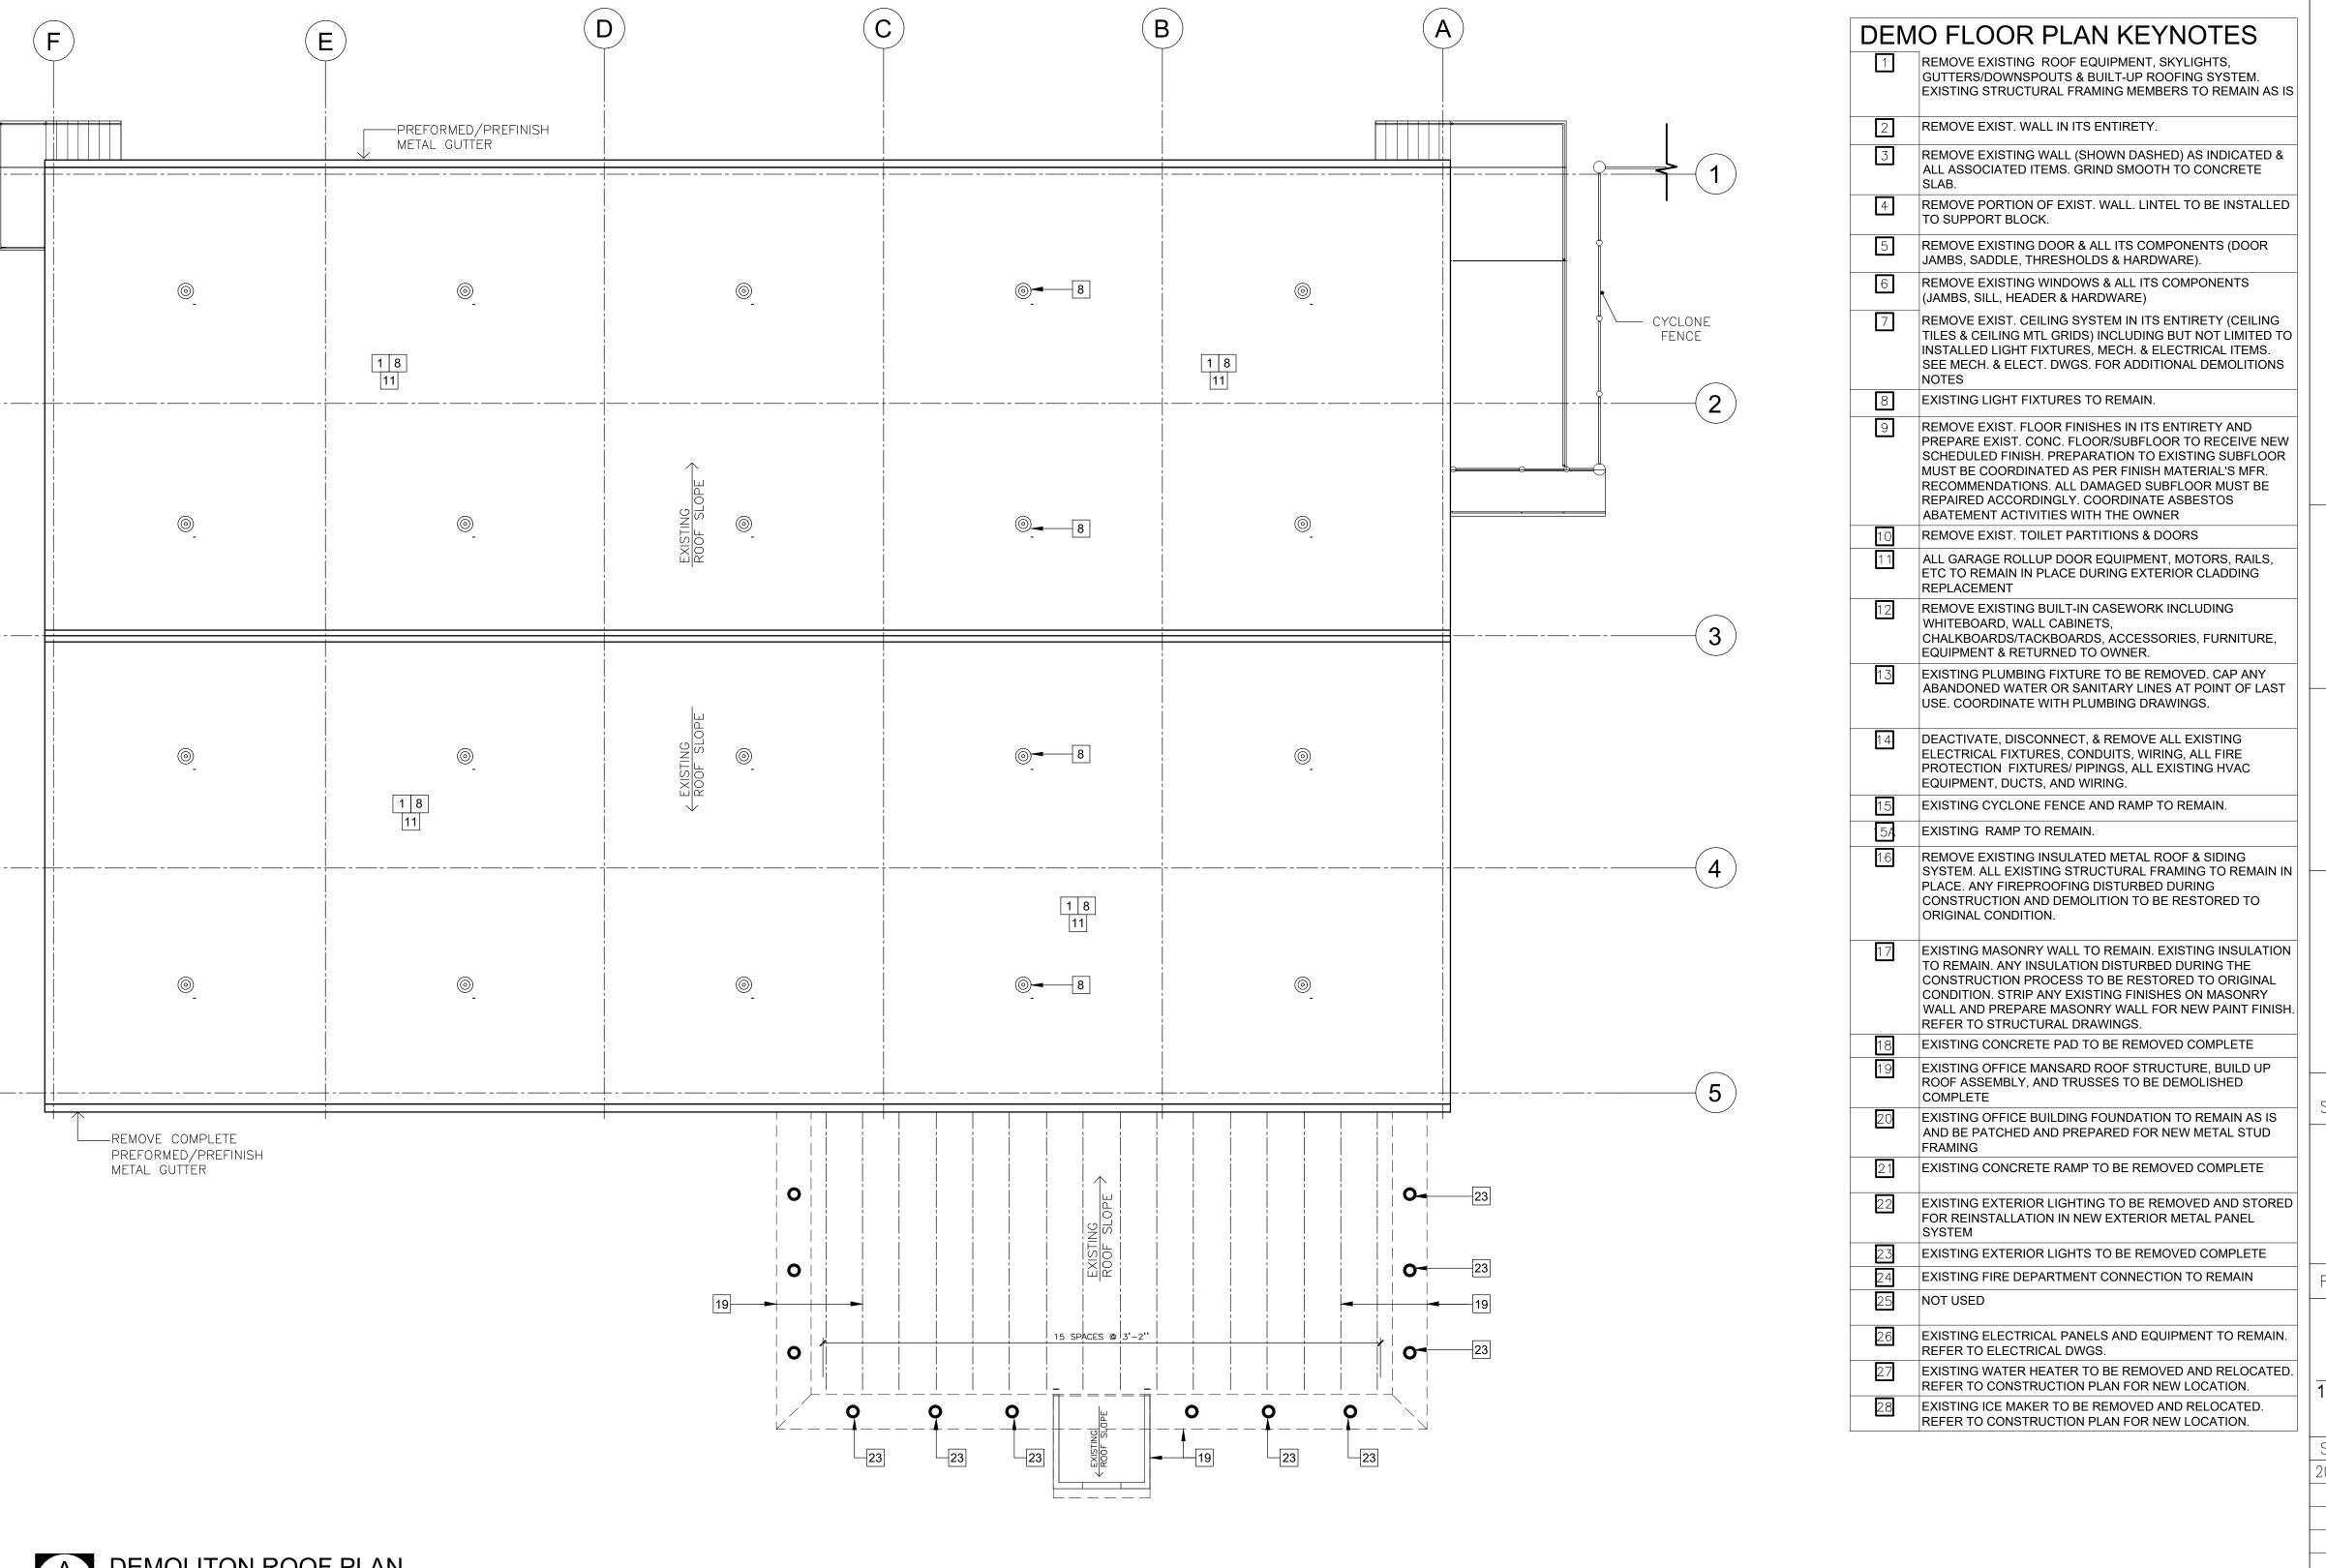A DEMOLITON ROOF PLAN
AD-103 SCALE: 1/8" = 1' - 0"



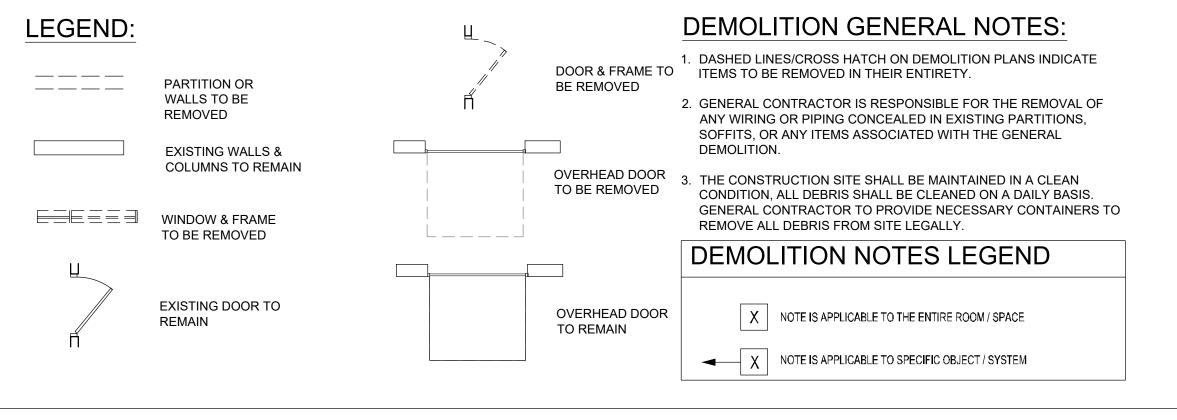

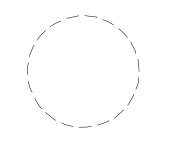

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NICHOLAS J. NETTA, ARCHITECT.

SHEET CONTENTS:

EXISTING STRUCTURAL AND ROOF PLAN

PROJECT TITLE:


ADDITIONS AND ALTERATIONS
BURLINGTON COUNTY DEPT. OF
PUBLIC WORKS
10 HARTFORD ROAD, DELRAN TWP.

BURLINGTON CO. NJ

SUBMISSION:
2025.03.12 - ISSUED FOR BID


Date O4.09.24
Scale AS SHOWN
Drawn by JT
Checked by LU
Job No. 2241869
Drawing No.

AD-103

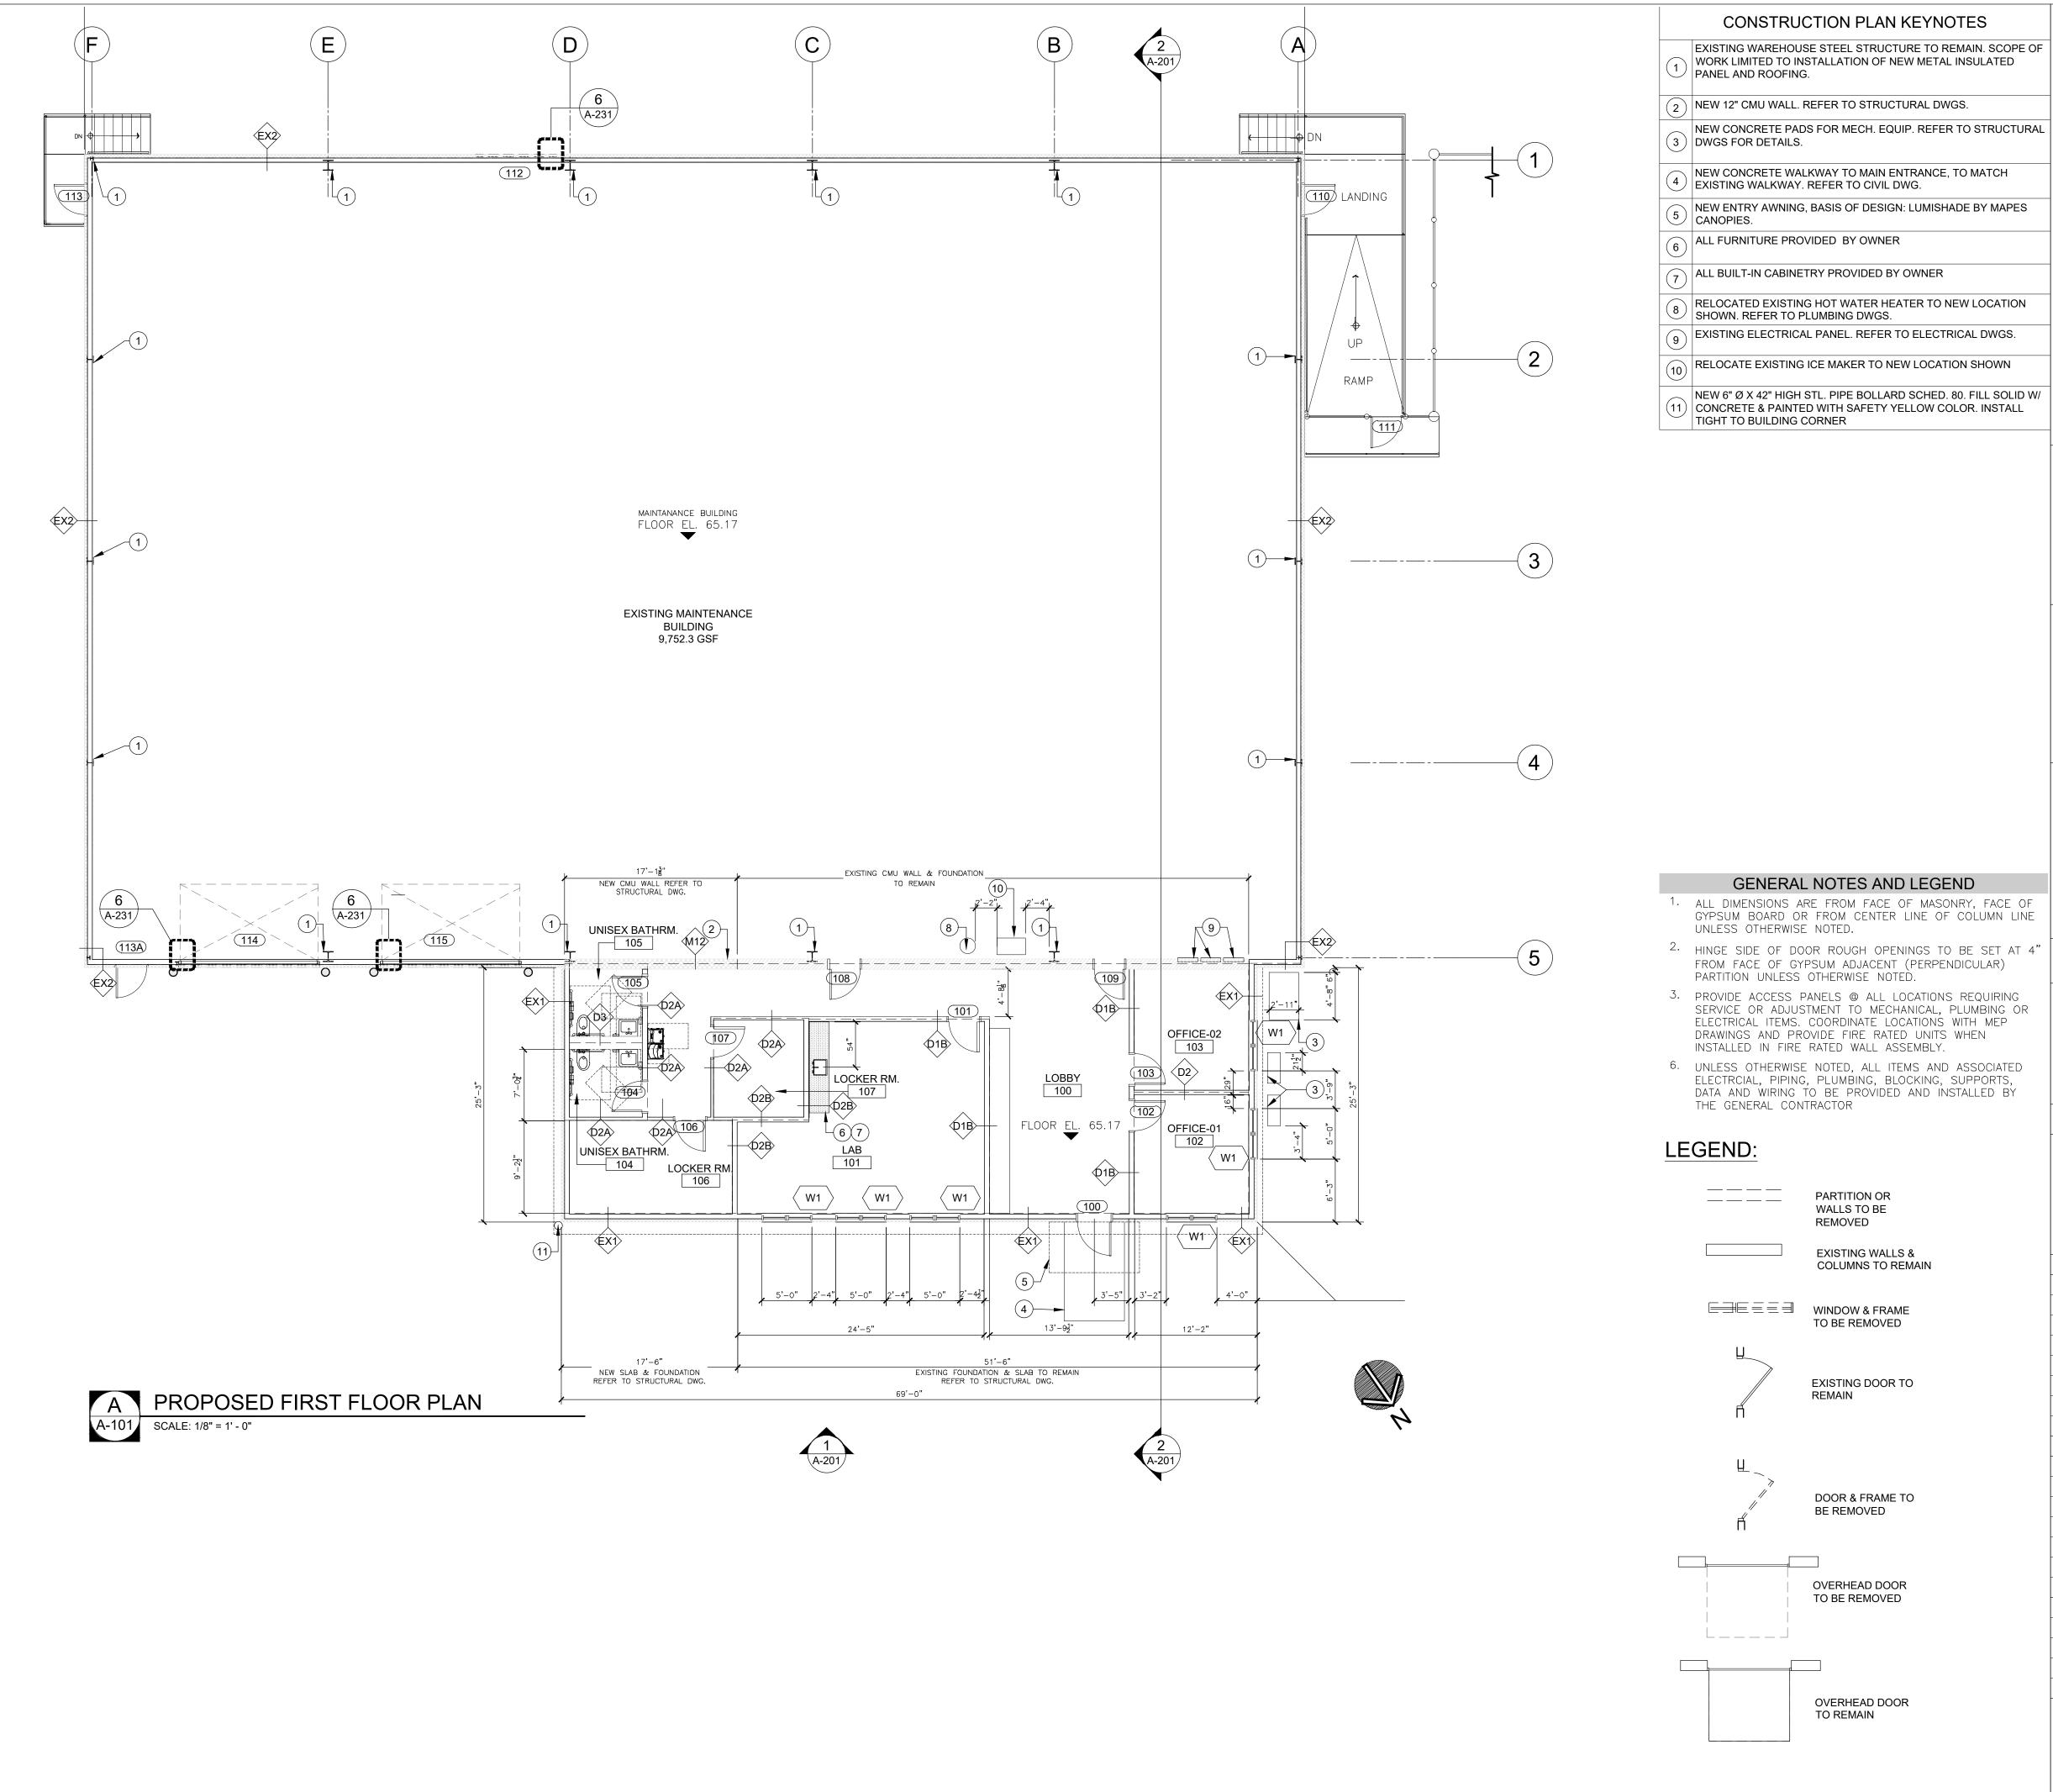

- NEW CONCRETE PADS FOR MECH. EQUIP. REFER TO STRUCTURAL

- NEW 6" Ø X 42" HIGH STL. PIPE BOLLARD SCHED. 80. FILL SOLID W/ (11) CONCRETE & PAINTED WITH SAFETY YELLOW COLOR. INSTALL

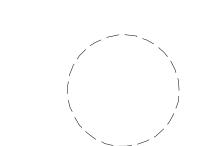

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SHEET CONTENTS:

PROPOSED FLOOR PLAN

PROJECT TITLE:

ADDITIONS AND ALTERATIONS BURLINGTON COUNTY DEPT. OF PUBLIC WORKS 10 HARTFORD ROAD, DELRAN TWP. BURLINGTON CO. NJ

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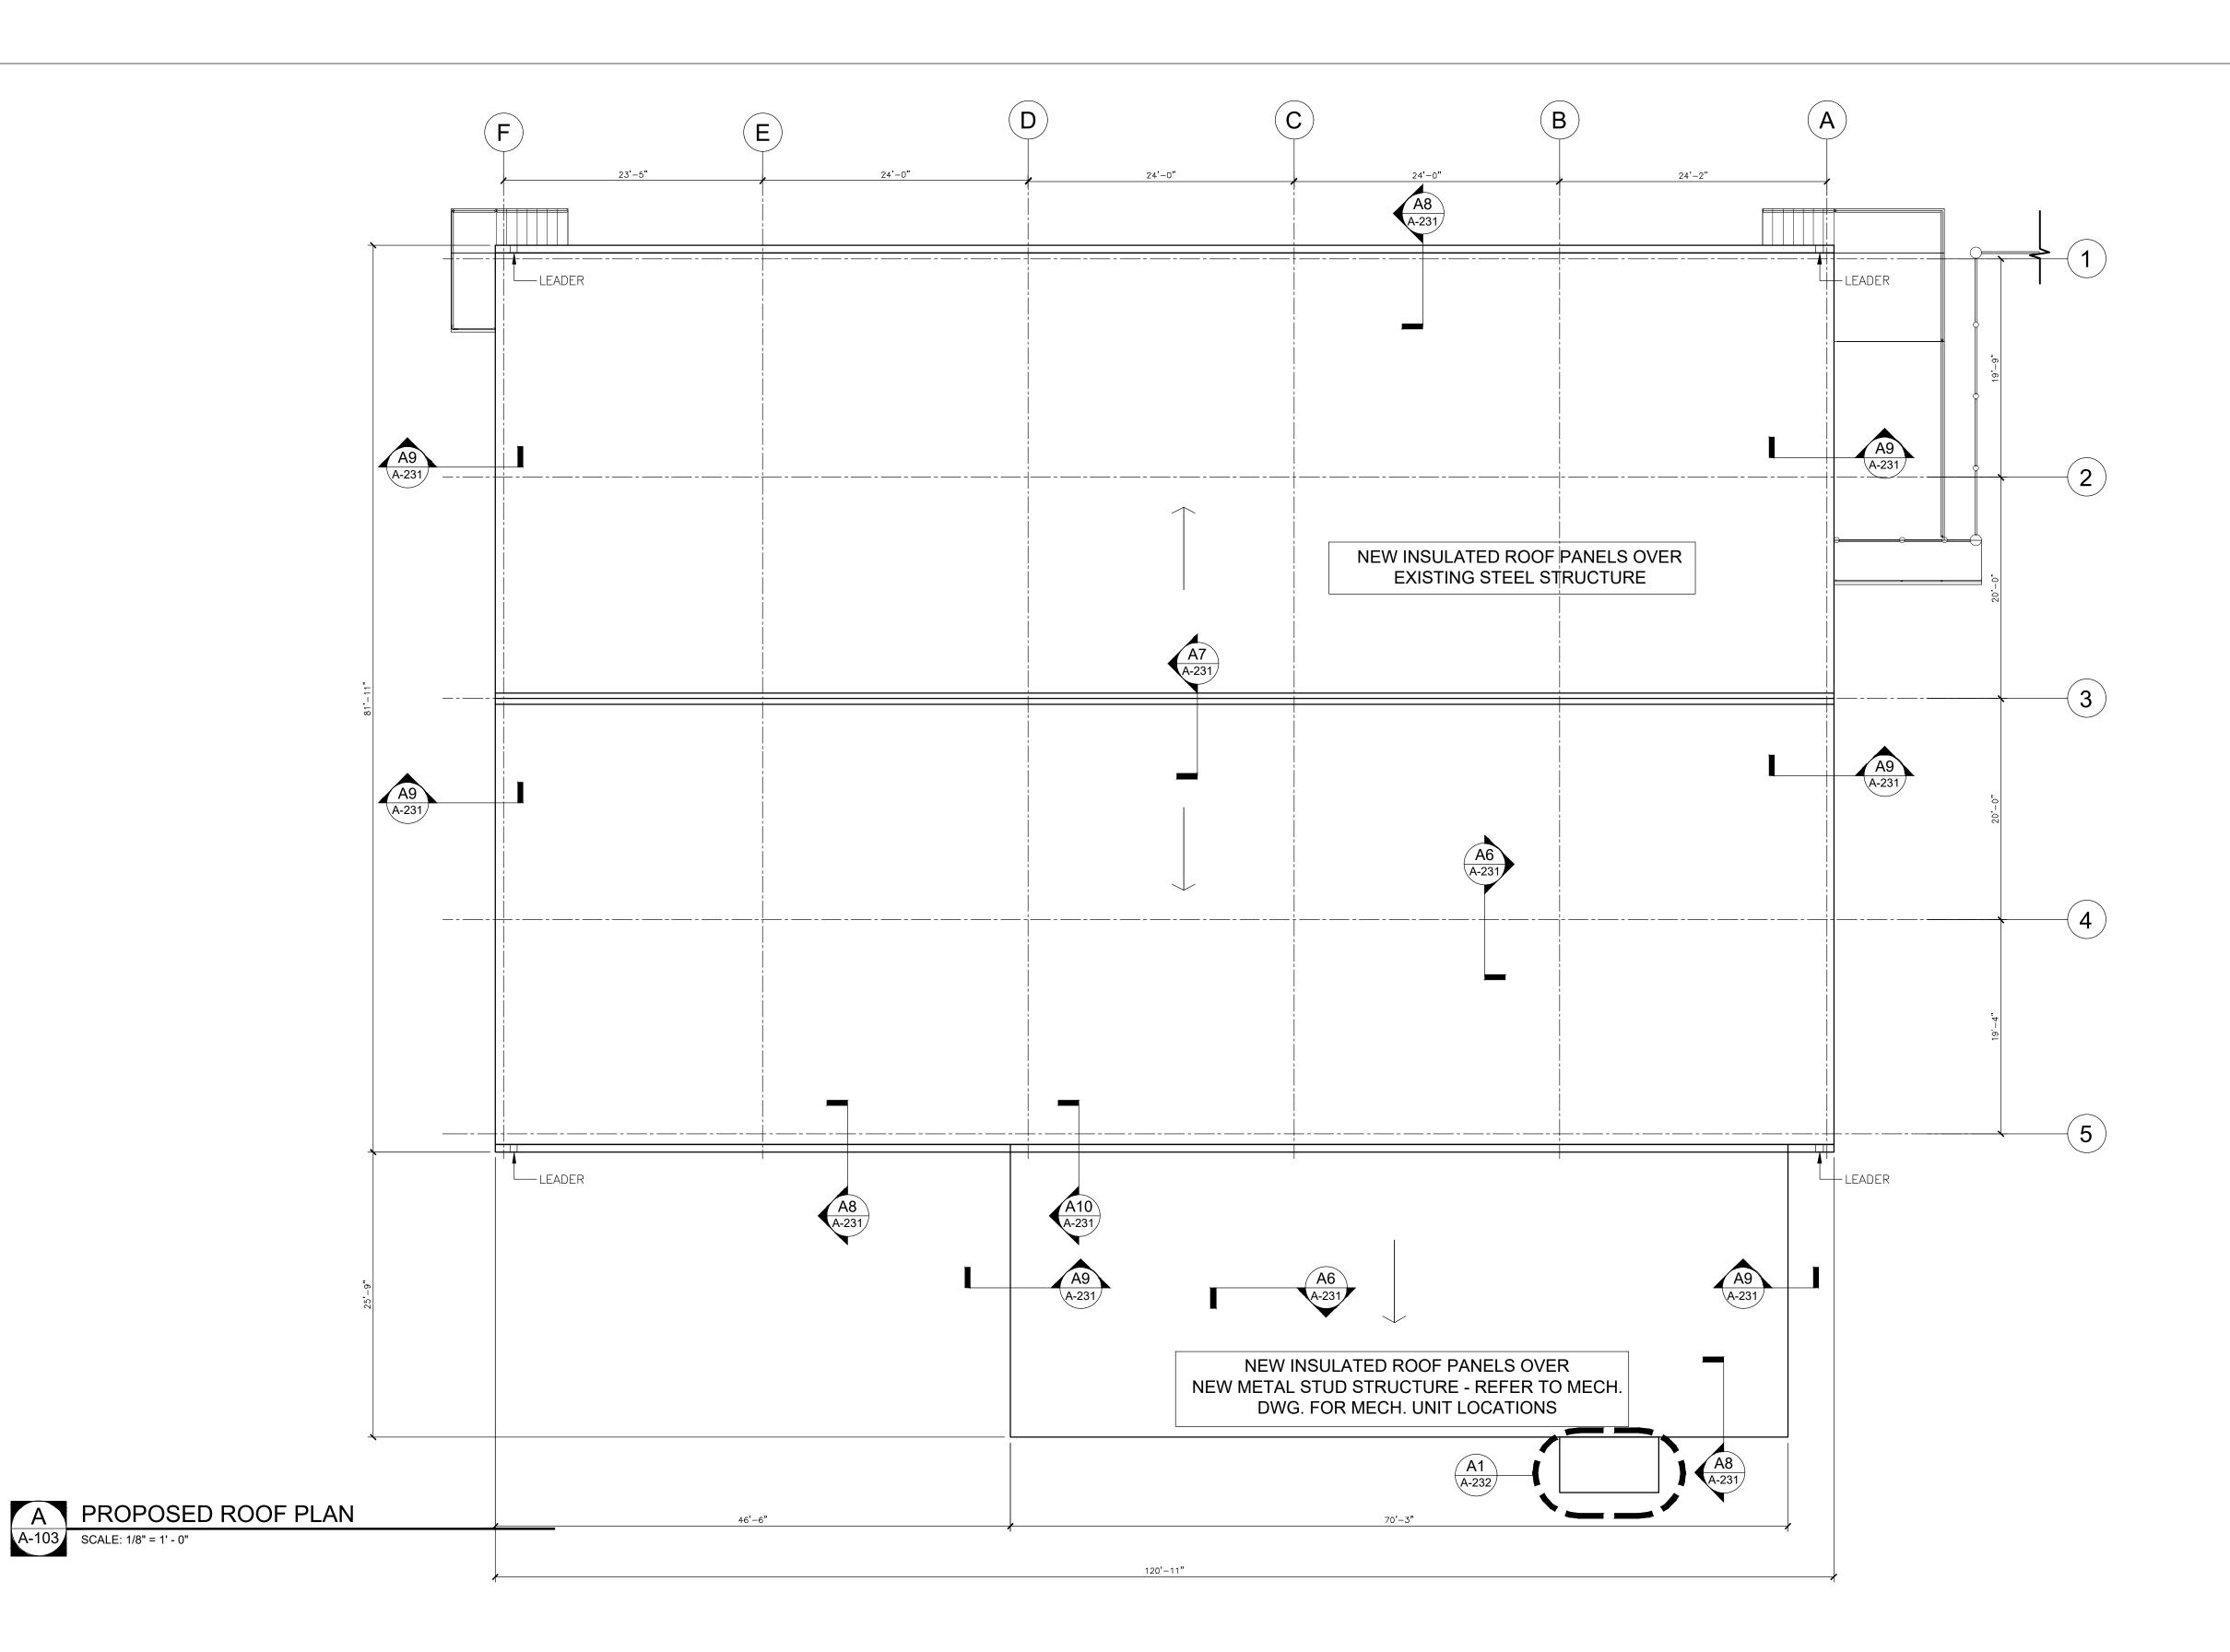
DATE REVISIONS

04.09.24 AS SHOWN Scale


BY CHKD

JT Drawn by Checked by LU Job No. 2241869

Drawing No.





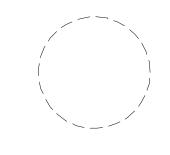

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SHEET CONTENTS:

ROOF PLAN

PROJECT TITLE:

ADDITIONS AND ALTERATIONS
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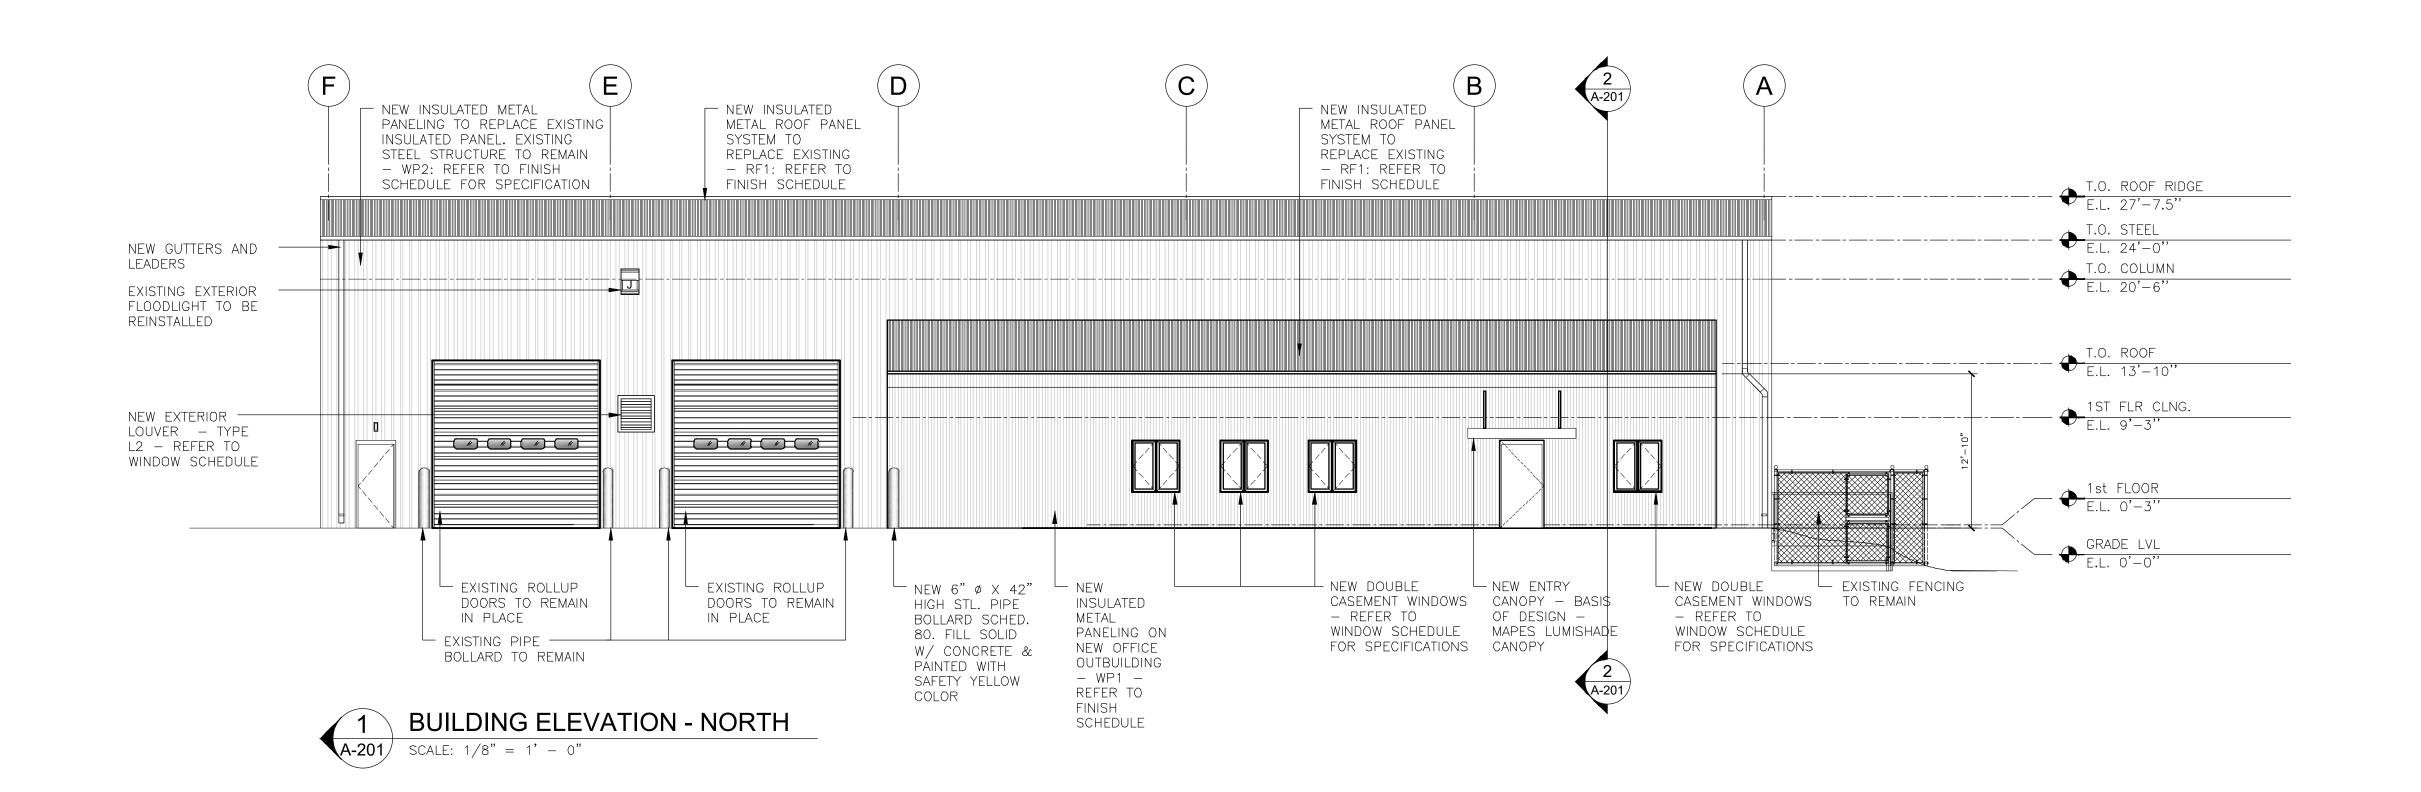
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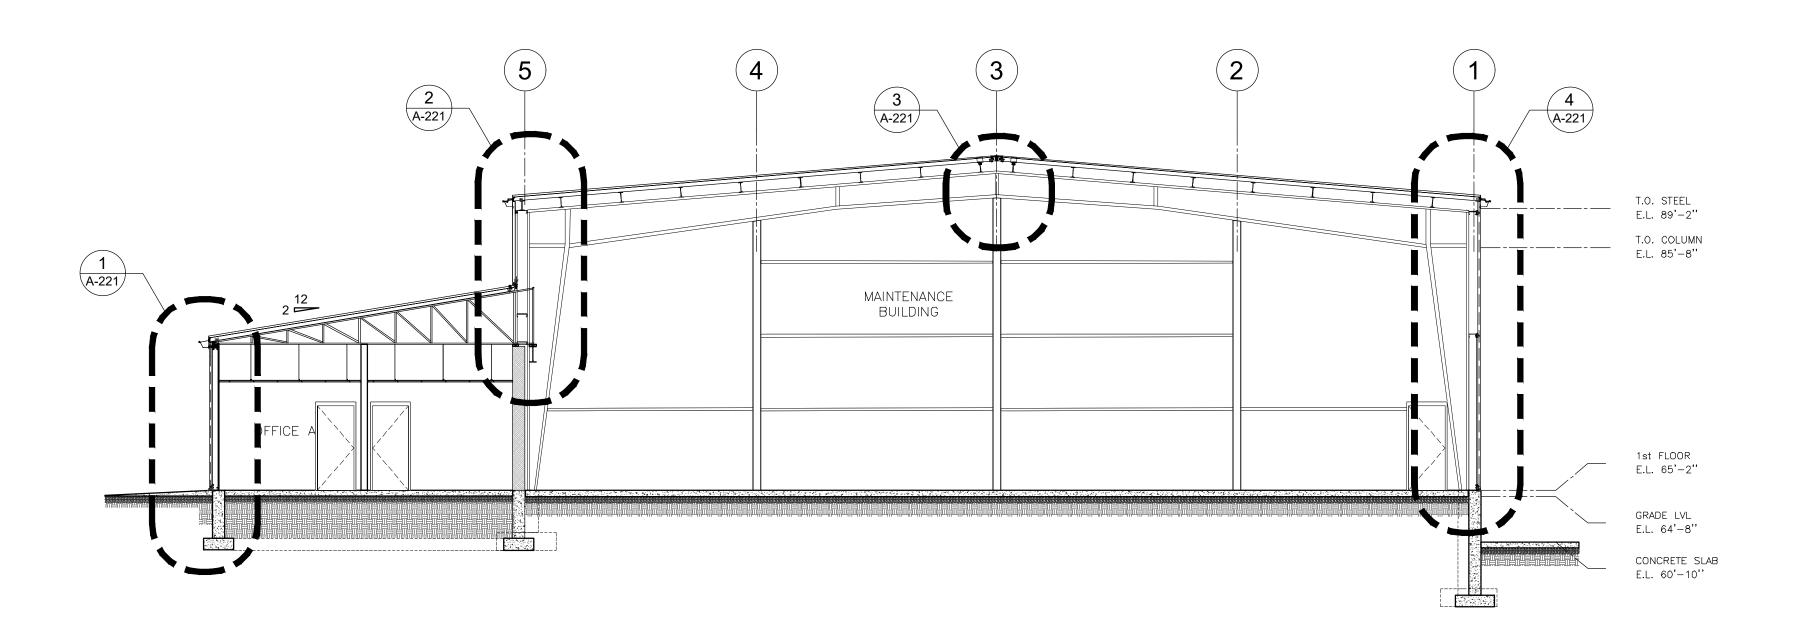
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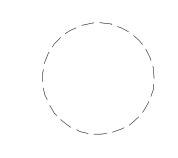
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Scale AS SHOWN
Drawn by JT
Checked by LU
Job No. 2241869
Drawing No.











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SHEET CONTENTS:

NORTH BUILDING ELEVATION AND SECTION

PROJECT TITLE:

ADDITIONS AND ALTERATIONS
BURLINGTON COUNTY DEPT. OF
PUBLIC WORKS

10 HARTFORD ROAD, DELRAN TWP.
BURLINGTON CO. NJ

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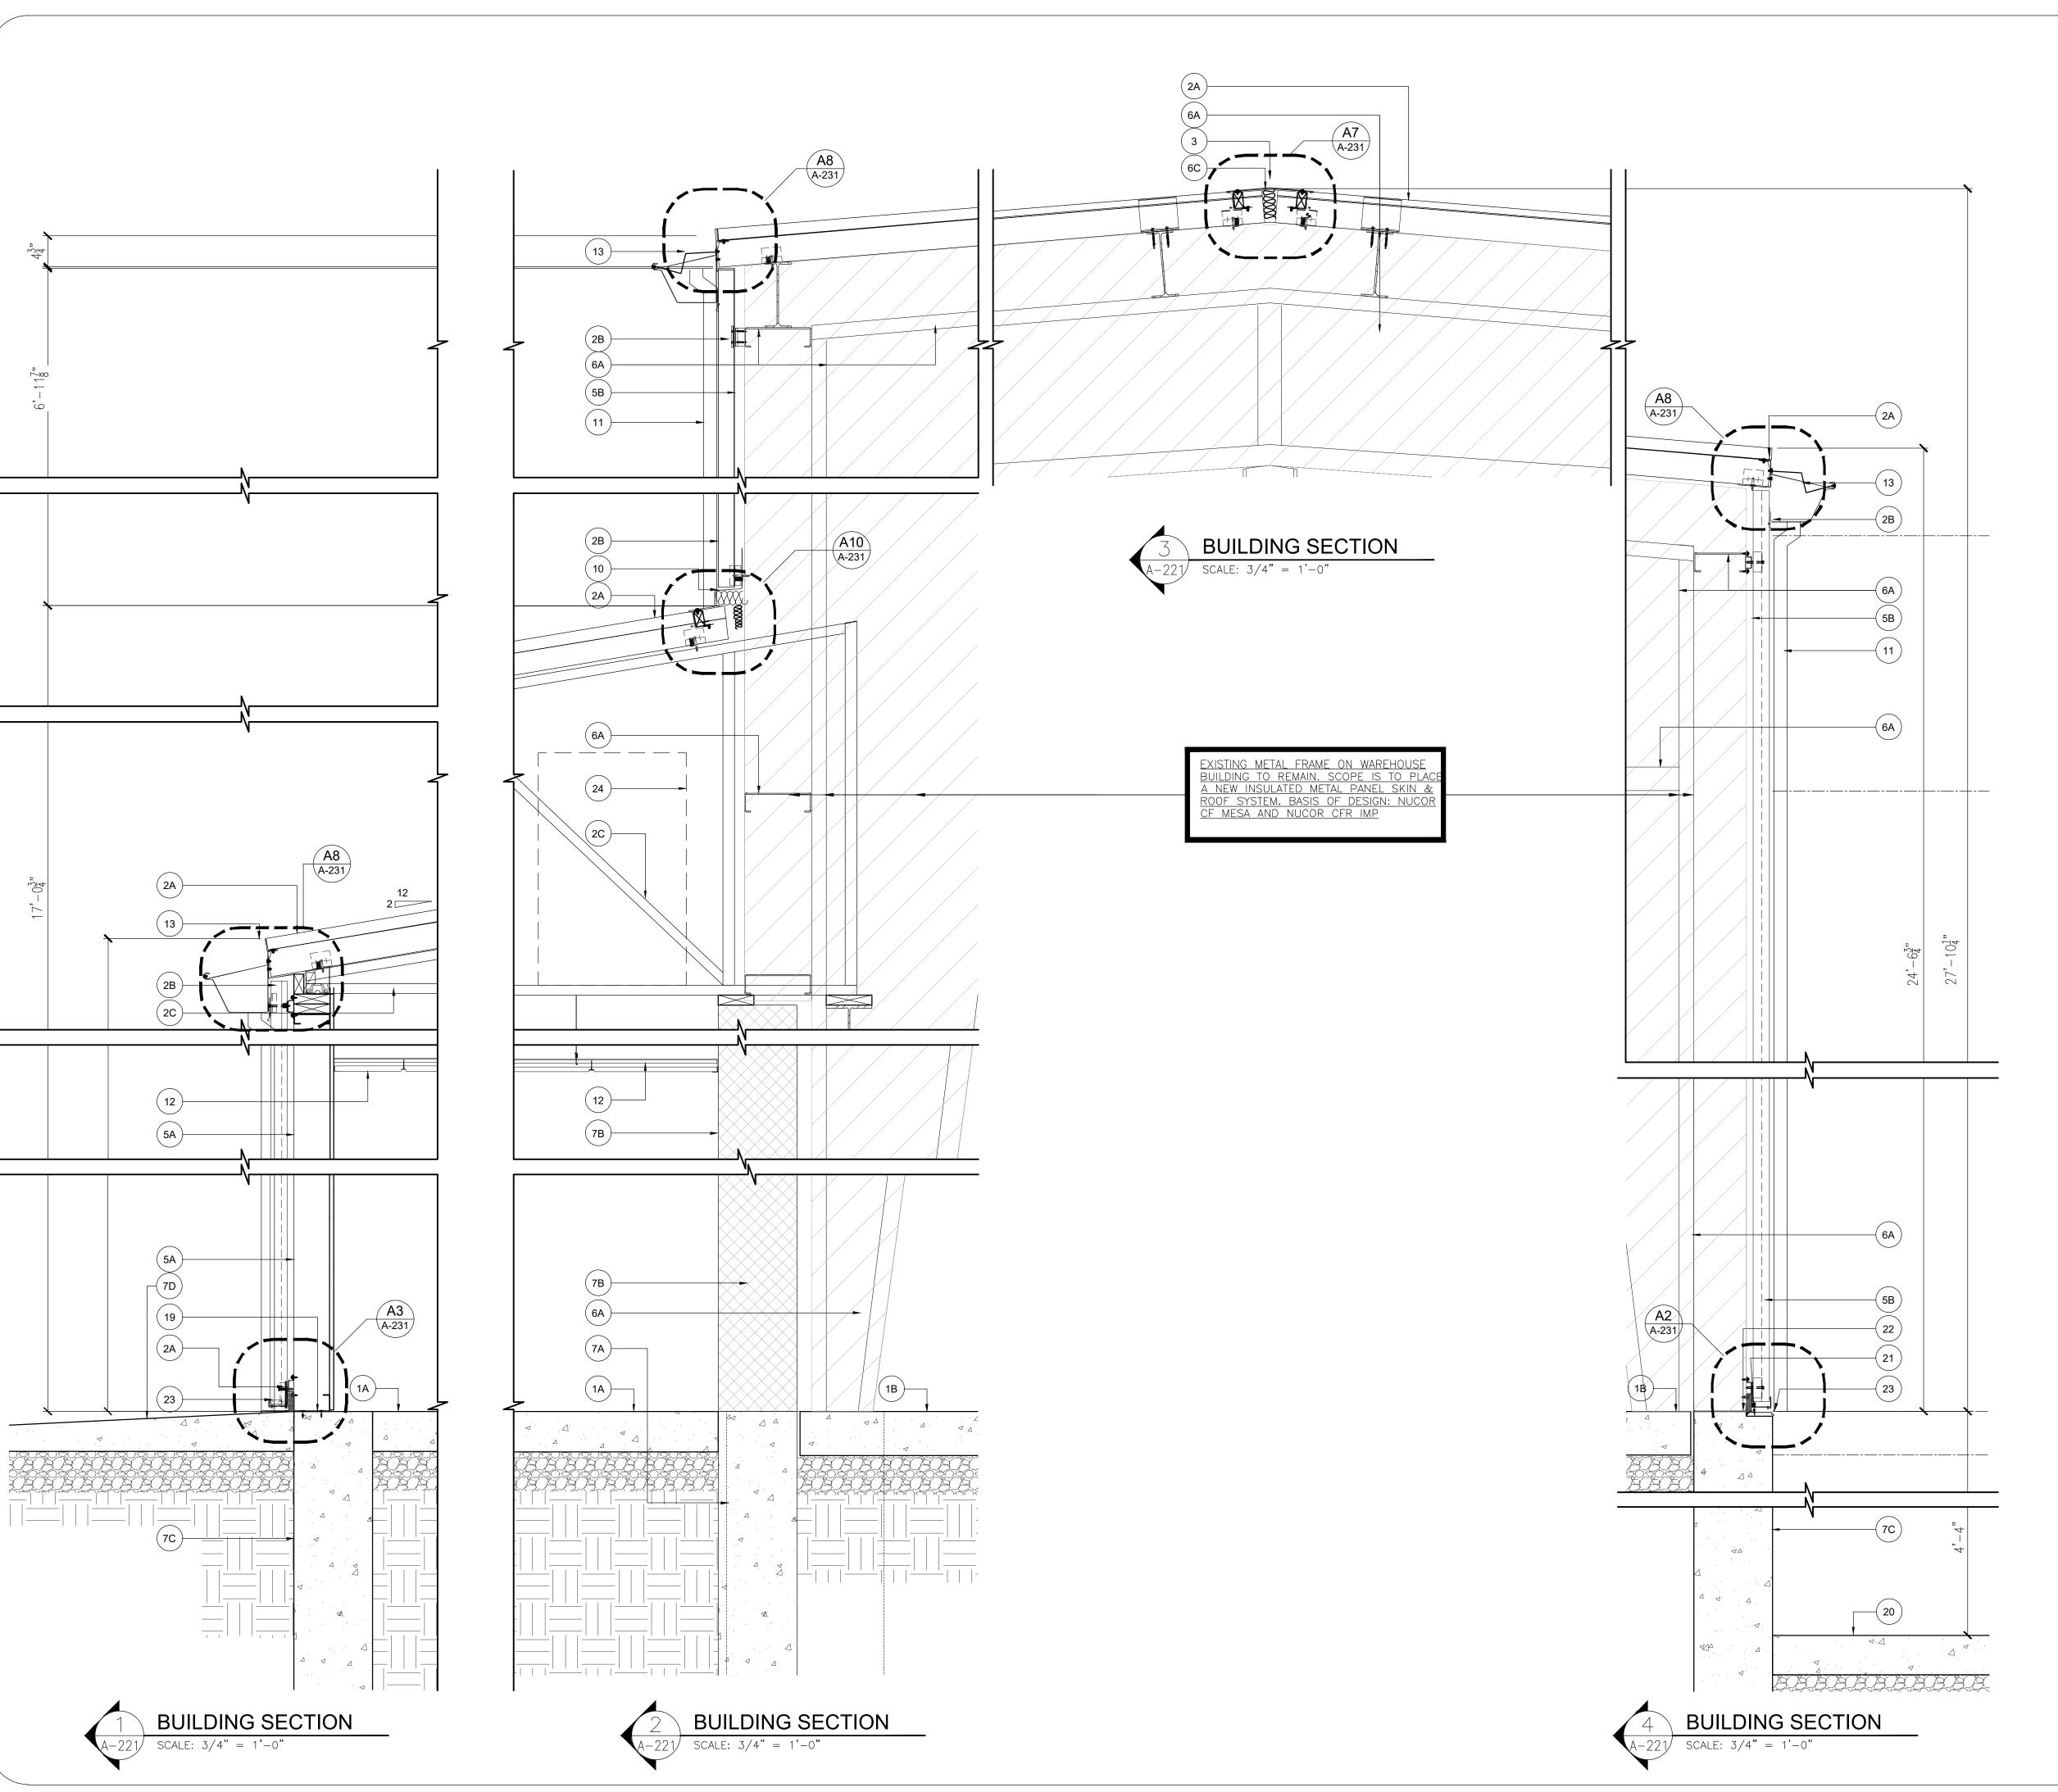
Date 04.09.24
Scale AS SHOWN
Drawn by JT
Checked by LU

BY CHKD

Drawing No.

A-201

2241869



KEYNOTES THIS DRAWING

- (1A) EXISTING CONCRETE SLAB: REFER TO STRUCT'L. DWGS.
- TYP. FLOOR CONSTRUCTION "FA2". GARAGE TYP. FLOOR CONSTRUCTION REFER TO STRUCT'L DWGS.
- NEW 4" THICK INSULATED METAL ROOFING SYSTEM, NUCOR


 CENTRIA VERSAPANEL ROOF OR APPROVED EQUAL REFER TO FINISH SCHEDULE
- (2B) NEW 2.5" THICK INSULATED METAL WALL SYSTEM, NUCOR CENTRIA VERSAWALL OR APPROVED EQUAL WP2: REFER TO FINISH SCHEDULE
- NEW LIGHT GAUGE METAL PREFABRICATED ROOF TRUSS, REFER TO STRUCTURAL DWGS.
- 3 RIDGE CAP AS PER INSULATED METAL ROOF MFR REFER TO ROOF PLAN
- 4 MECHANICAL LOUVER REFER TO MECHANICAL DRAWINGS
- (5A) EXT. WALL TYPE "EX-1"

SPECIFICATION

- (5B) EXT. WALL TYPE "EX-2"
- EXISTING STEEL REFER TO STRUCT'L DWGS. ALL EXISTING STEEL TO BE STRIPPED OF EXISTING INSULATION AND SAND BLASTED SMOOTH IN PREPARATION FOR NEW PAINT COATING. REFER TO FINISH SCHEDULE FOR PAINT
- 6C FIELD FILL COMPRESSIBLE OR SPRAY IN INSULATION
- 6D FIELD APPLY SEALANT AT ALL INSULATED METAL PANEL JOINTS AS PER MFR
- (7A) CONC. FOUNDATION WALL. REFER TO STRUCT'L. DWGS.
- (7B) CMU WALL WITH REINF. REFER TO STRUCT'L DWGS.
- (C) EXISTING FOUNDATION WALL. REFER TO STRUCTURAL DWGS.
- NEW CONCRETE WALKWAY TO MAIN BUILDING ENTRANCE
- (8) NOT USED
- 9 NOT USED
- (10) COUNTERFLASHING
- 11) NEW 4"x5" PREFINISH ALUM. WATER LEADER. COLOR TO MATCH METAL INSULATED PANEL
- (12) CEILING REFER TO FINISH SCHEDULE DWGS.
- GUTTER TO MATCH INSULATED METAL PANEL AND ROOF SYSTEM COLOR, WITH OPTIONAL SUPPORT ANGLE. FASTENERS TO MATCH
- SYSTEM COLORS. REFER TO ROOF PLAN.

 (14) COMPACTED GRAVEL & EARTHFILL
- (15) EXISTING BEAM (WF)/COLUMN (H).
- 6"ø x 42" HIGH STL, PIPE BOLLARD SCHED, 80. FILL SOLID WITH CONCRETE AND PAINTED WITH SAFETY YELLOW COLOR.
- (17) STL. PLATE. SEE STRUCT'L. DWGS.
- (7B) GALV. STEEL FRAMING REFER TO STRUCTURAL DWGS.
- (18) CONTINUOUS GALV. STEEL ANGLE REFER TO STRUCTURAL DWGS.
- (19) CONTINUOUS BASE ANGLE SEALED TO SLAB, FASTENED AS PER MFR. SPEC.
- (20) NEW ACT CEILING SEE FINISH SCHEDULE FOR SPECIFICATION
 (20) EXISTING CONCRETE SLAB TO REMAIN
- (20) EXISTING CONCRETE SLAB TO REMAIN
- (21) FLUSH WALL PANEL BASE WITH BASE TRIM.
 (22) INSULATED METAL PANEL HIDDEN JOINT FASTENERS
- (22) INSULATED METAL PANEL HIDDEN JOINT FASTENERS
- 23 INSULATED METAL PANEL FLUSH BASE CONDITION SEE DTL A2/A231
- NEW PROPOSED LOCATION OF MECH. UNITS REFER TO MECH.



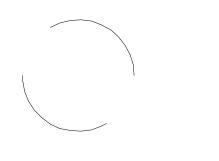

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SHEET CONTENTS:

WALL SECTIONS

PROJECT TITLE:

ADDITIONS AND ALTERATIONS
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10 HARTFORD ROAD, DELRAN TWP.
BURLINGTON CO. NJ


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DATE REVISIONS BY CHKD


Date 04.09.24

Scale AS SHOWN
Drawn by JT
Checked by LU
Job No. 2241869

Drawing No.



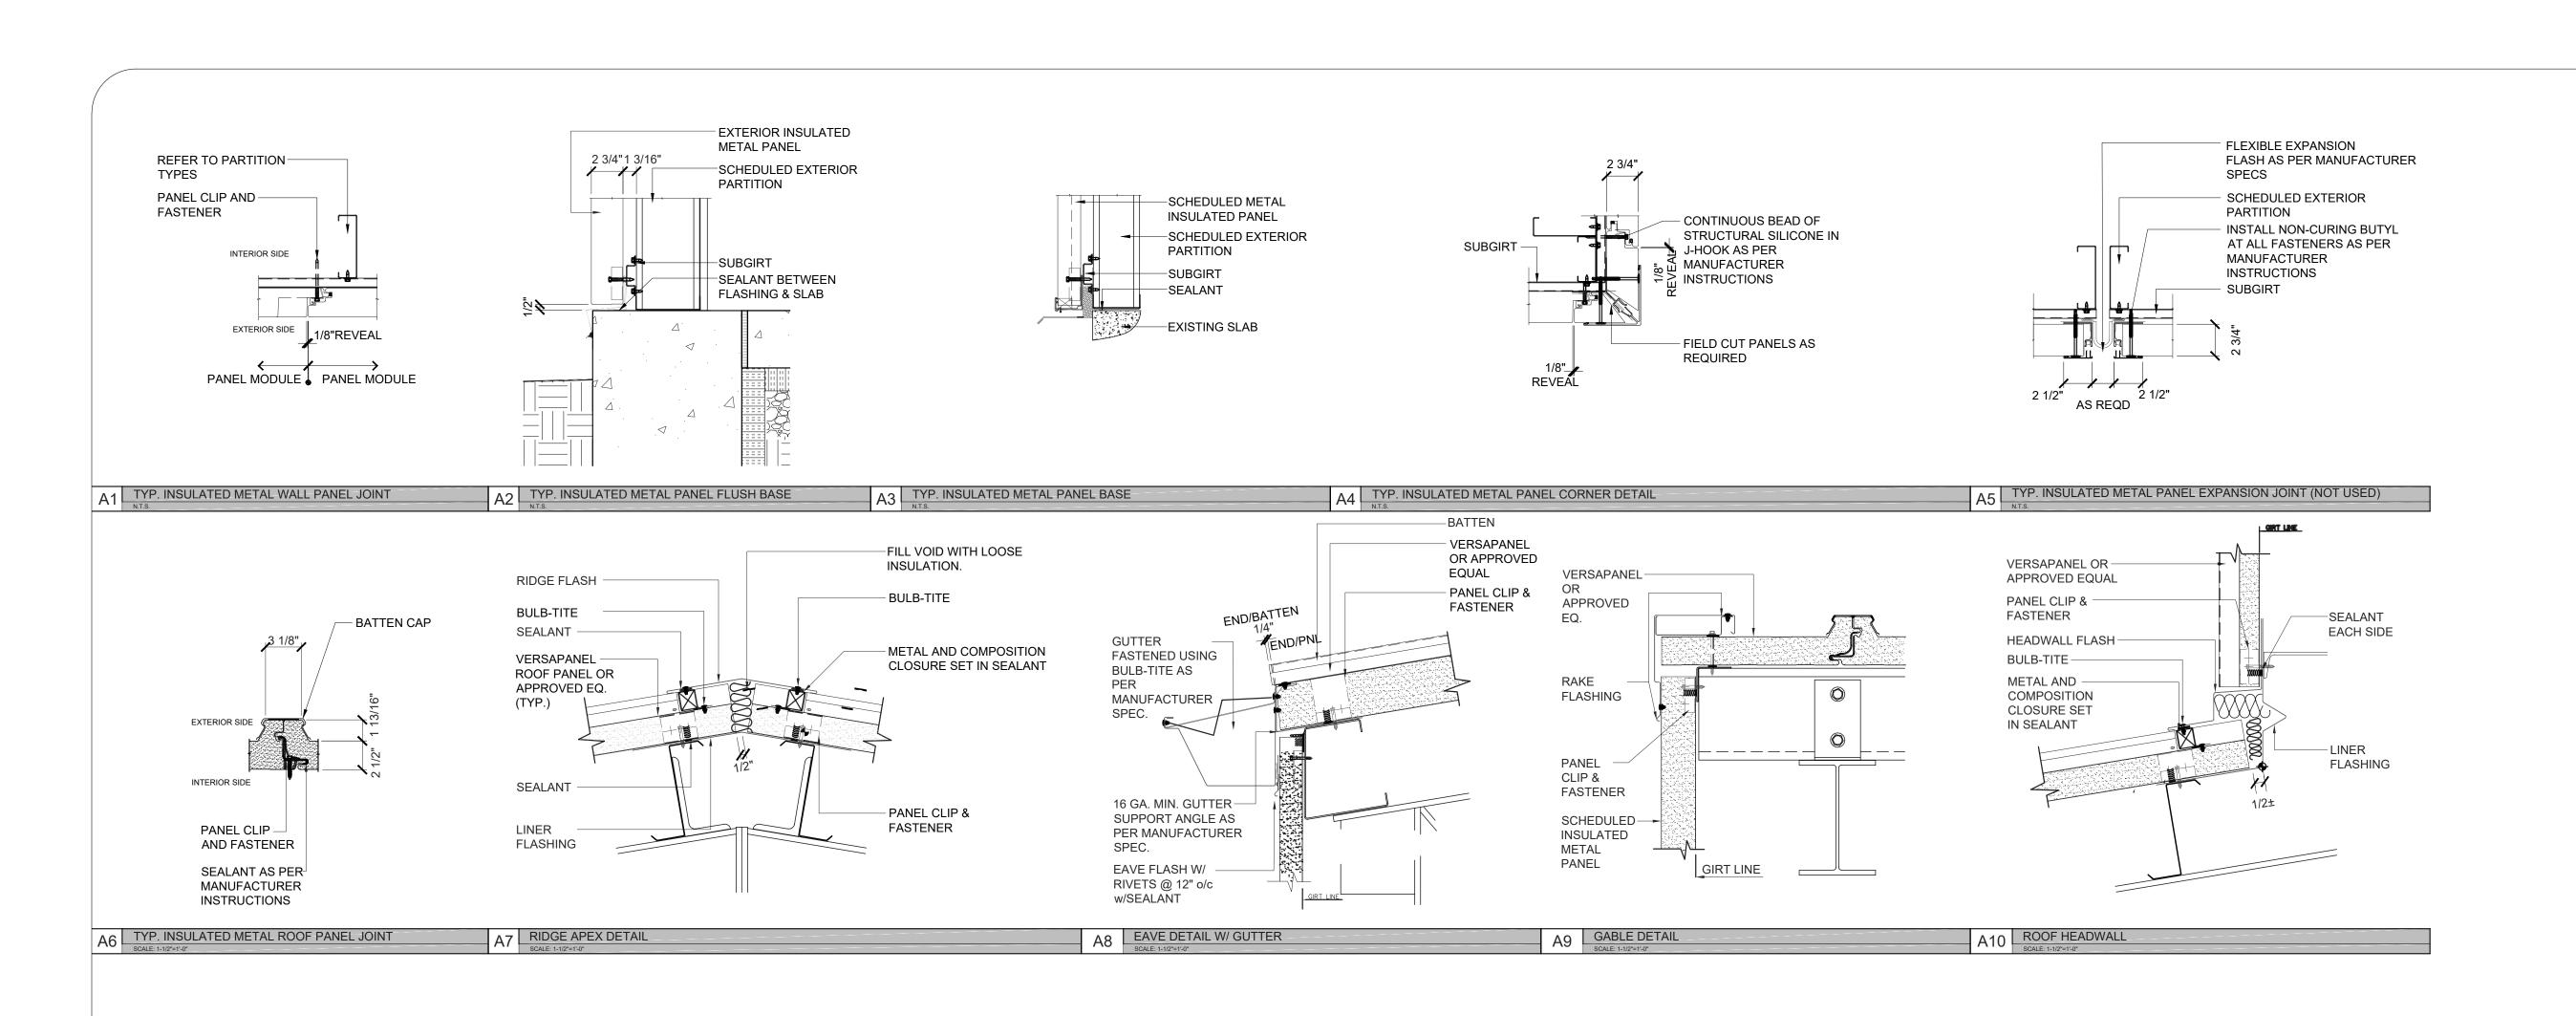

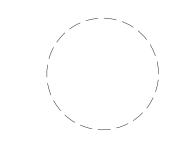

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SHEET CONTENTS:

TYPICAL METAL INSULATED PANEL DETAILS

PROJECT TITLE:


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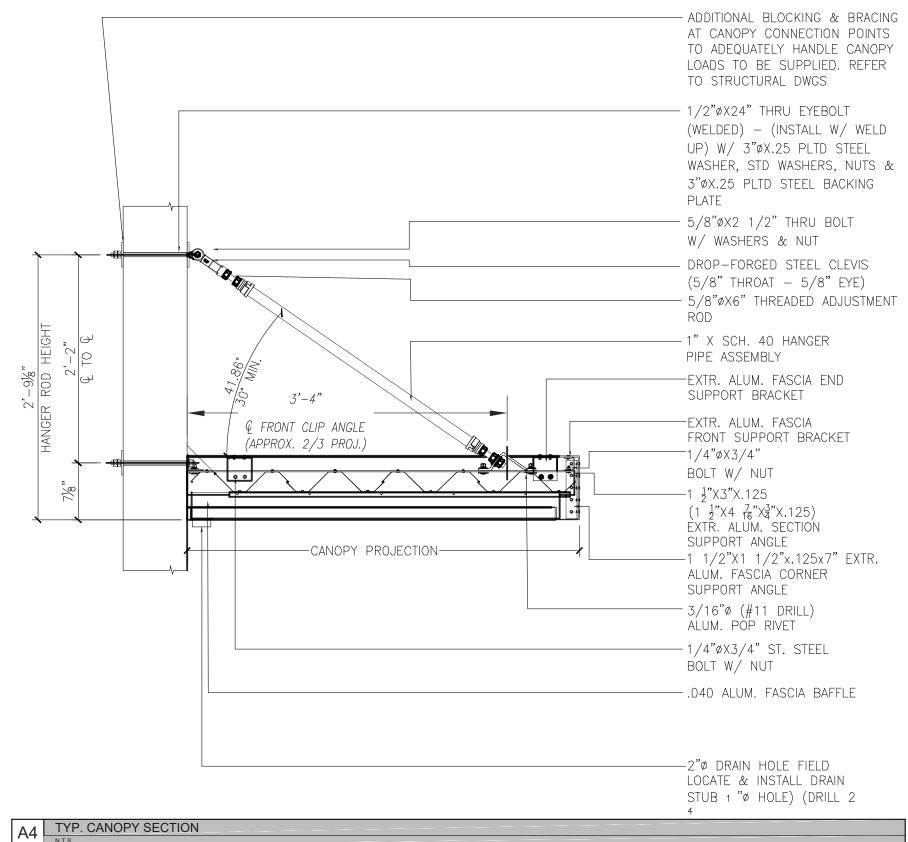
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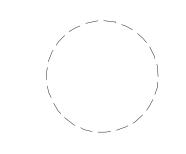
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Date	04.09.24		
Scale	AS SHOWN	1	
Drawn by	JT		
Checked by	LU		
Job No.	2241869		
Drawing No.			







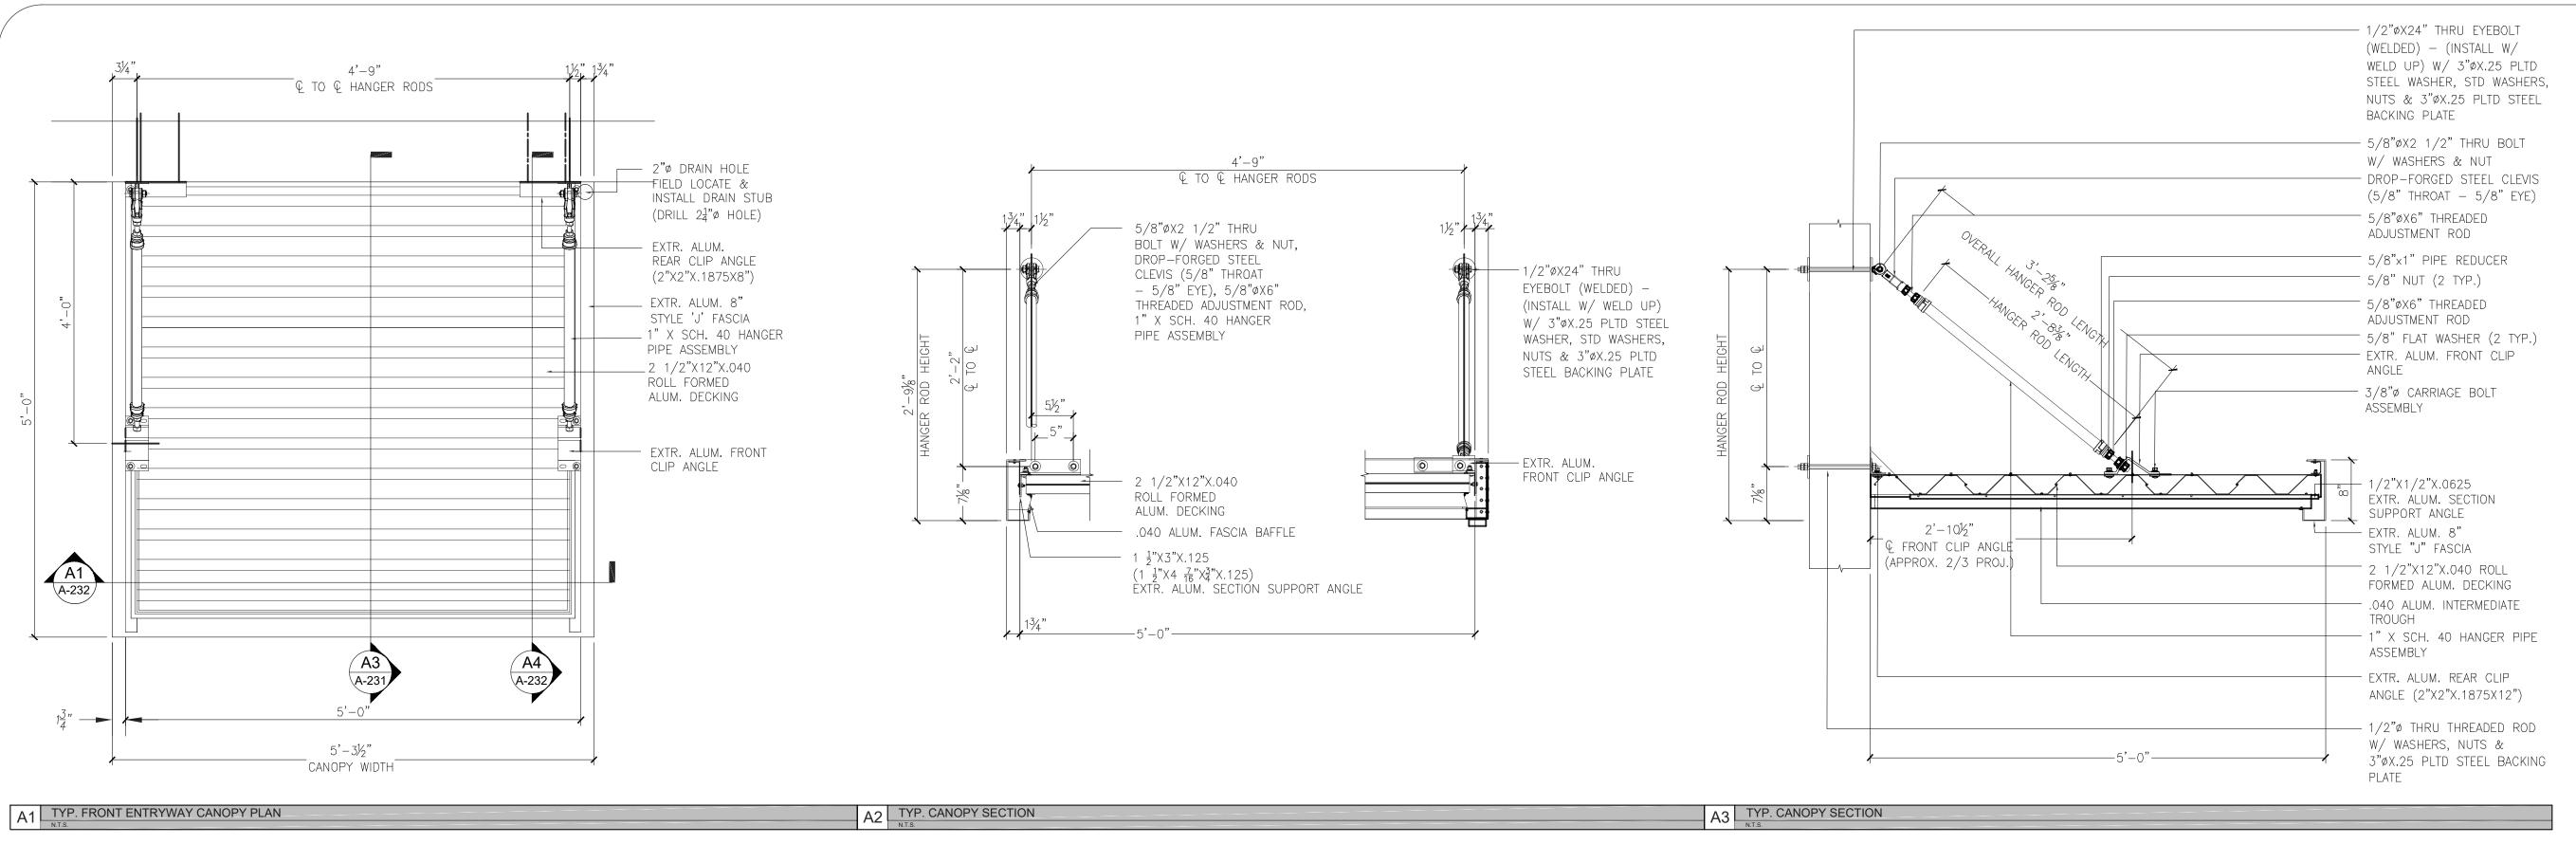

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SHEET CONTENTS:

TYPICAL FRONT ENTRYWAY EXTERIOR CANOPY DETAILS

PROJECT TITLE:

SUBMISSION:


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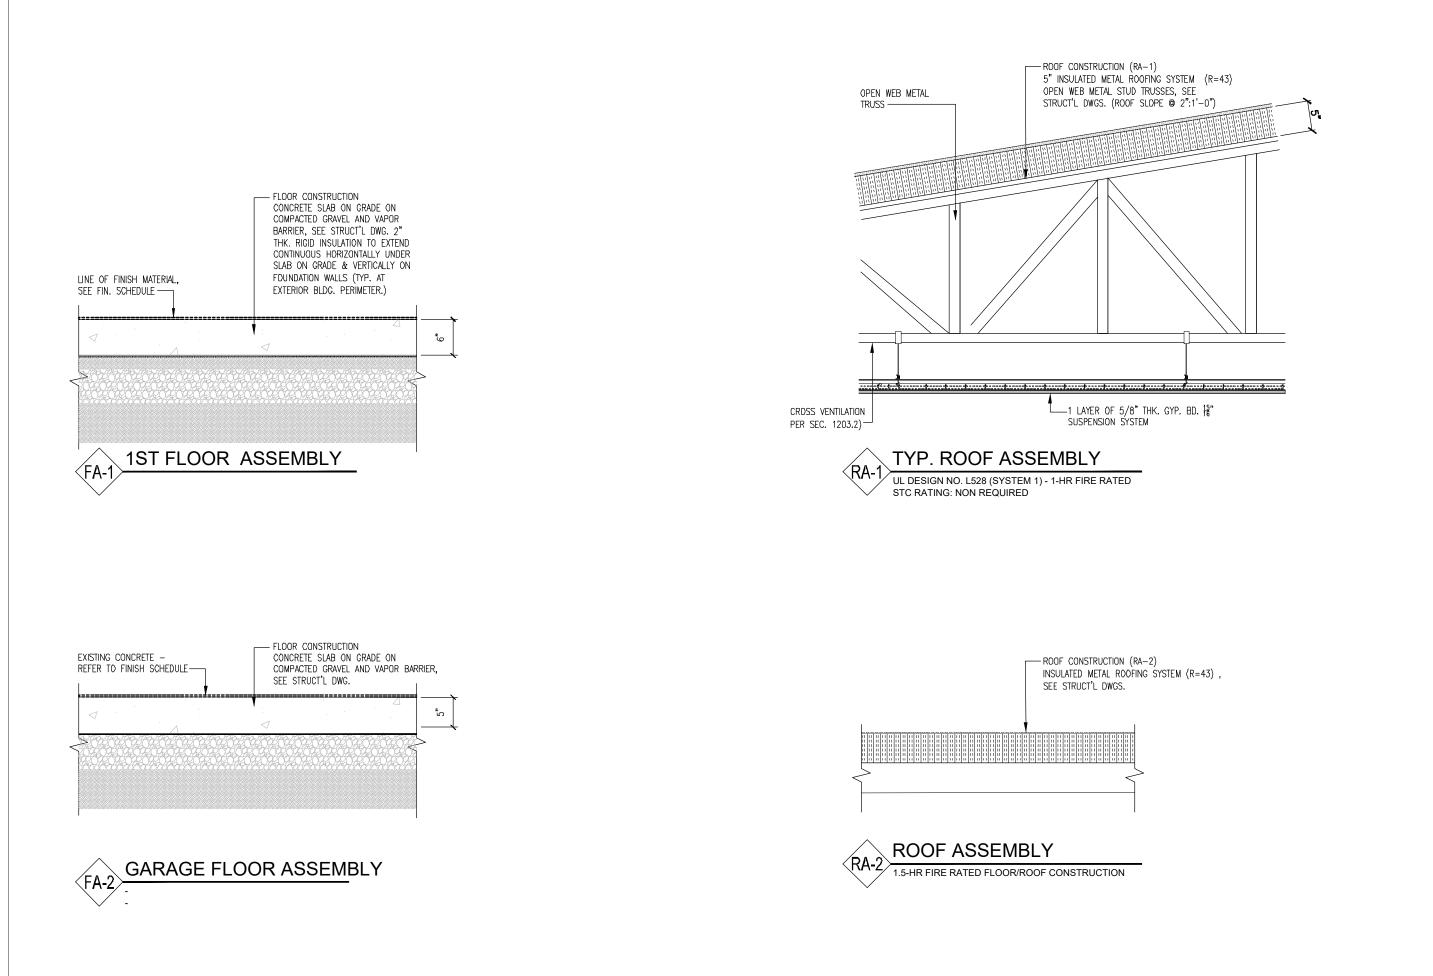
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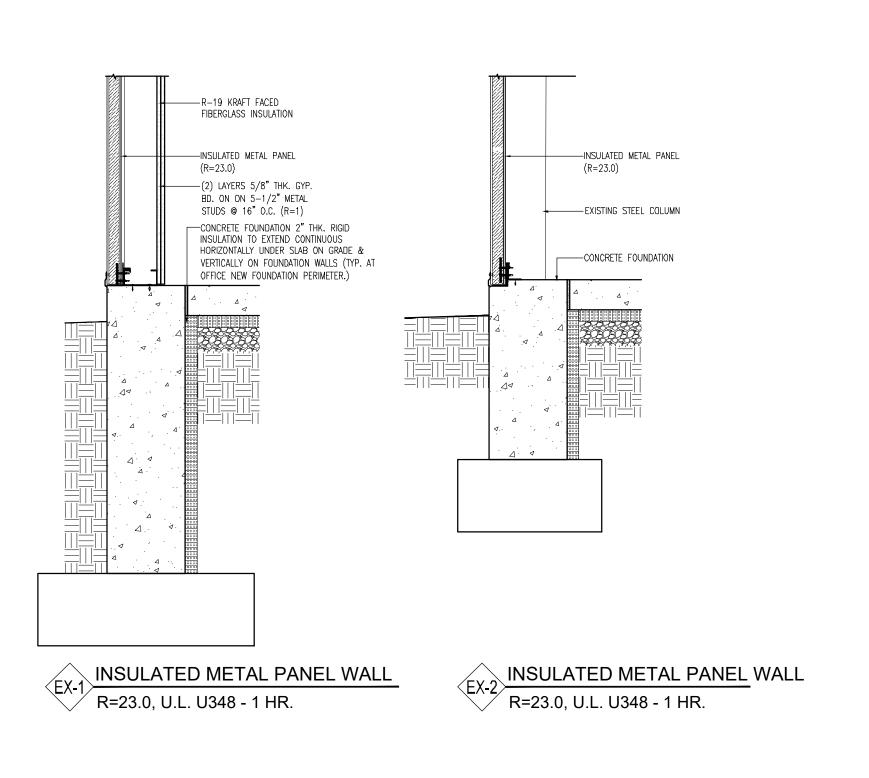


INTERIOR WALL TYPES

FLOOR / ROOF ASSEMBLY

SCALE: 1" = 1'-0"




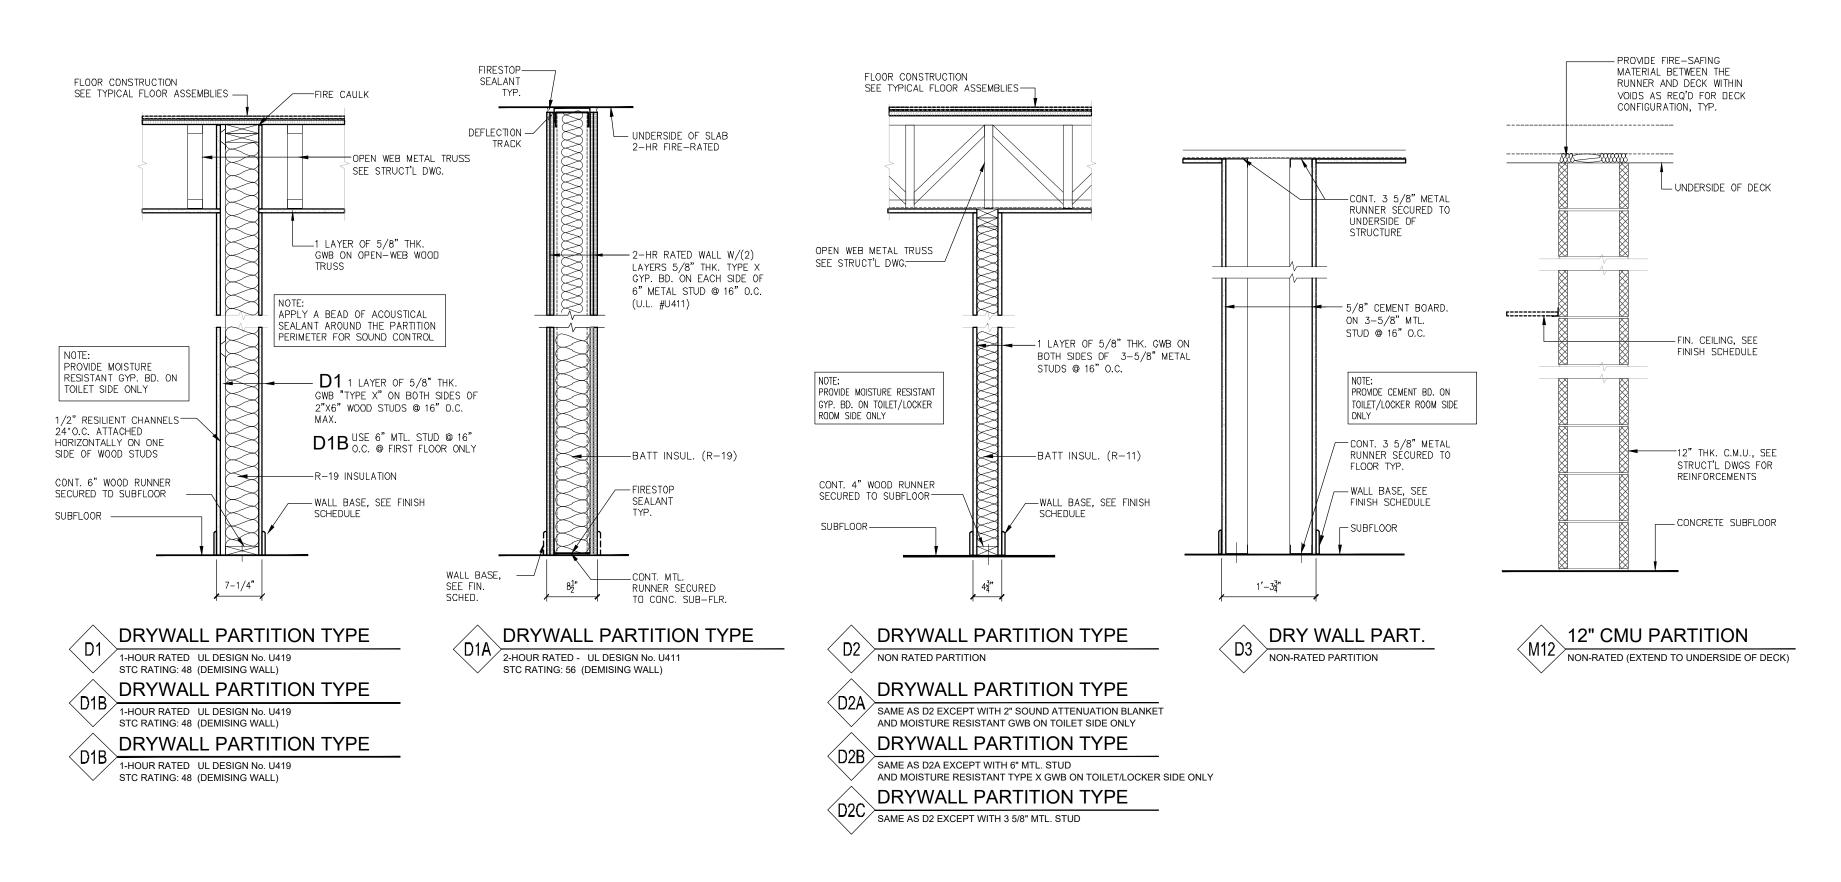

EXTERIOR WALL TYPES

SCALE: 1" = 1'-0"

NEW JERSEY | FLORIDA | NEW YOI 1084 Route 22 West, Mountainside, NJ 07092 | Phone: (973) 379-0006 | www.nettaarchitects.
CERTIFICATE OF AUTHORIZATION AC-45

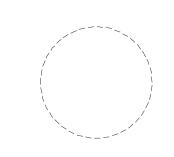

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SHEET CONTENTS:

PARTITION TYPES

PROJECT TITLE:

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BURLINGTON CO. NJ

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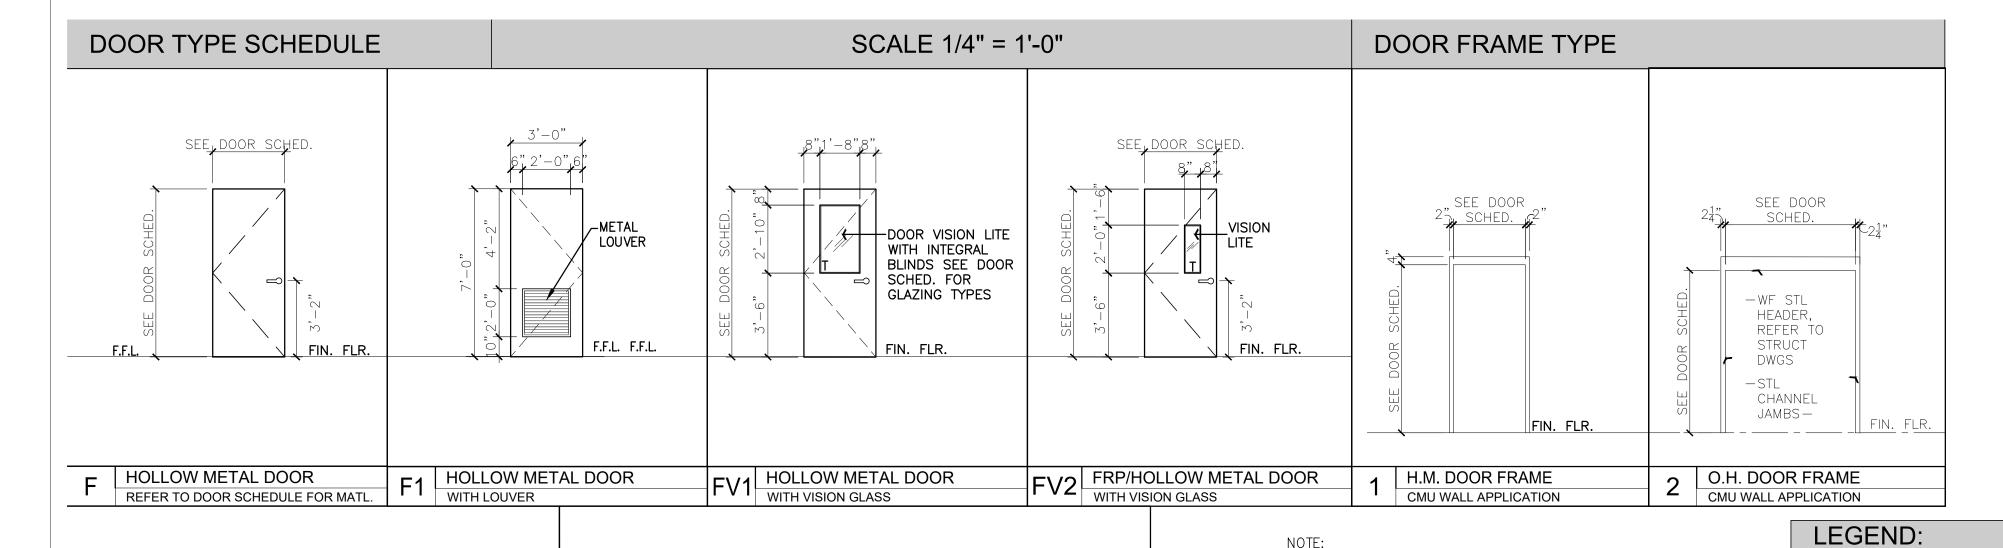
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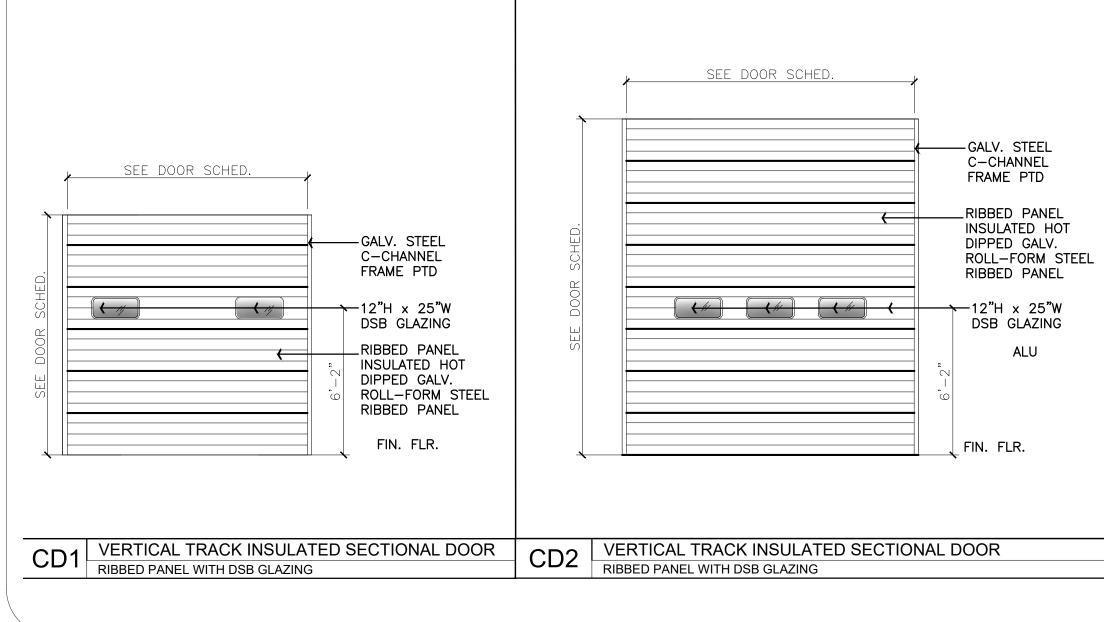
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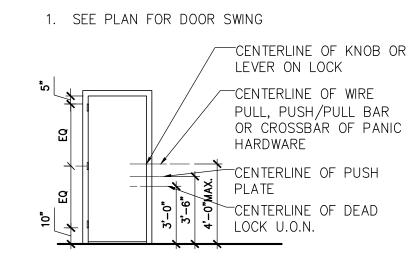
	DOOR A									RAND	AND FRAME SCHEDULE								
DOOR	DOOR L	OCATION			D	000R					F	RAME	<u> </u>		SI	LL		HDWR.	REMARKS
NO.	FROM	ТО	WD	HGT	THK	MAT'L.	FIN	TYPE	GL	MAT'L.	FIN.	TYPE	JAMB	HEAD	MAT'L.	TYPE	RATING	SET	
100	LOBBY	BLDG. EXTERIOR	3'-0"	7'-0"	1¾"	H.M.	PT	F	_	H.M.	DP1	1	J3	НЗ	AL	S2	_	1.0	
101	HALLWAY	LABORATORY	3'-0"	7'-0"	13/4"	H.M.	PT	FV1	Т	H.M.	DP1	1	J1	H1	AL	_	_	2.0	
102	LOBBY	OFFICE-01	3'-0"	7'-0"	1¾"	Н.М.	PT	F	_	H.M.	DP1	1	J1	H1	_	_	_	4.0	
103	LOBBY	OFFICE-02	3'-0"	7'-0"	1¾"	H.M.	PT	F	_	H.M.	DP1	1	J1	H1	_	_	_	4.0	
104	HALLWAY	UNISEX BATHROOM	3'-0"	7'-0"	1¾"	H.M.	PT	F	_	H.M.	DP1	1	J1	H1	AL	S5	_	3.0	
105	HALLWAY	UNISEX BATHROOM	3'-0"	7'-0"	1¾"	H.M.	PT	F	_	H.M.	DP1	_	J1	H1	AL	S5	_	3.0	
106	HALLWAY	MEN'S LOCKER RM.	3'-0"	7'-0"	13/4"	Н.М.	PT	F	Т	H.M.	DP1	1	J1	H1	AL	S5	_	3.0	
107	HALLWAY	WOMEN'S LOCKER RM.	3'-0"	7'-0"	1¾"	Н.М.	PT	F	_	H.M.	DP1	1	J1	H1	AL	S5	_	3.0	
108	GARAGE	HALLWAY	3'-0"	7'-0"	1¾"	Н.М.	PT	F	_	H.M.	DP1	1	J2	H2	AL	S2	_	1.0	EXISTING OPENING
109	GARAGE	HALLWAY	3'-0"	7'-0"	1¾"	H.M.	PT	F	_	H.M.	DP1	1	J2	H2	AL	S2	_	1.0	EXISTING OPENING
110	GARAGE	BLDG. EXTERIOR	3'-0"	7'-0"	1¾"	H.M.	PT	F	_	H.M.	DP1	1	J6	Н6	AL	S2	-	1.0	NEW DOOR/FRAME TO INSTALL @ SAME LOCATION
111	RAMP	BLDG. EXTERIOR	_										_	_					EXISTING GATE DOOR IN EXISTING CYCLONE FENCE TO REMAIN
112	GARAGE	BLDG. EXTERIOR	8'-0"	8'-0"									J5	Н5					SECTIONAL OVERHEAD DOORS — ELECTRIC—HIGH—LIFT
113	GARAGE	BLDG. EXTERIOR	3'-0"	7'-0"	1¾"	H.M.	PT	F	_	H.M.	DP1	1	J6	Н6	AL	S2	_	1.0	NEW DOOR/FRAME TO INSTALL @ SAME LOCATION
113A	GARAGE	BLDG. EXTERIOR	3'-0"	7'-0"	1¾"	Н.М.	PT	F	_	H.M.	DP1	1	J6	Н6	AL	S2	_	1.0	NEW DOOR/FRAME TO INSTALL @ SAME LOCATION
114	GARAGE	BLDG. EXTERIOR	14'-0"	16'-0"									J5	H5					EXISTING SECTIONAL OVERHEAD DOORS — ELECTRIC—HIGH—LIFT
115	GARAGE	BLDG. EXTERIOR	14'-0"	16'-0"									J5	H5					EXISTING SECTIONAL OVERHEAD DOORS — ELECTRIC—HIGH—LIFT

* NOTE: 1. ALL EXISTING DOOR FRAMES & DOORS SHALL BE CLEAN, SANDED BEFORE APPLYING NEW PAINT & SEALED FINISH.

- 2. CLEAN ALL INTERIOR WINDOWS INCLUDING GLASS, ALUMINUM FRAMES & SILLS.
- 3. ALL EXISTING INTERIOR DOORS TO BE CLEAN & PAINTED TO MATCH COLORS OF NEW DOORS.
- 4. ALL FRP DOORS & FRAMES & OVERHEAD DOORS & FRAMES COLORS TO BE DETERMINE (TBD)








HARDWARE NOTES:

NOTE:

- 1. REFER TO HARDWARE SCHEDULE FOR NUMBER OF HINGES REQUIRED. 2. ALL HARDWARE MOUNTING SHALL MEET APPLICABLE HANDICAPPED ACCESS CODES. COORDINATE AND VERIFY ALL MOUNTING HEIGHTS WITH LOCAL CODE JURISDICTIONS, HANDICAPPED CODES AND PROJECT DESIGN REQUIREMENTS.
- 3. HOLLOW DOORS , COORDINATE CONCEALED HARDWARE WITH THE MINIMUM STILE AND RAIL DIMENSIONS AND DOOR AND HARDWARE SPECIFICATIONS. ALLOW DEPTH OF THE HARDWARE PLUS THE MINIMUM REQUIRED RAIL OR STILE AS SPECIFIED BY AWI.
- 4. ALL HARWARE, LEVERS, CLOSERS, SADDLES, ETC. TO MEET A.D.A. ACCESSIBILITY REQUIREMENTS.

AL	ALUMINUM
CA	CLEAD AMODIZED ALUMINUM
COLA.	COLORED ANODIZED ALUMINUM
CLR	CLEAR
CG	CHAINLINK GATE
CSG	CHAINLINK SLIDING GATE
FRP	FIBER-REINFORCED PANEL
FRG	FIRE RATED GLAZING
DP1	SCHEDULE DOOR FRAME PAINT
G.A. STL.	GALVANIZED STEEL
GL	GLASS
H.M.	HOLLOW METAL
PC	POWDER COATED
PT	PAINT - SEE FIN. SCHED.
RB	RUBBER
STL.	STEEL
S/STL	STAINLESS STEEL
ST	STONE
Т	TEMPERED GLASS
TBD	TO BE DETERMINE
T.I.	TEMPERED INSULATING GLASS
WD	SLID CORE WOOD DOOR
WM	WIRE MESH
WT	WIRED TEMPERED GLASS



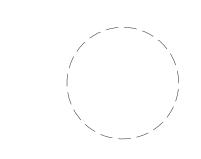

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SHEET CONTENTS:

DOOR SCHEDULE

PROJECT TITLE:


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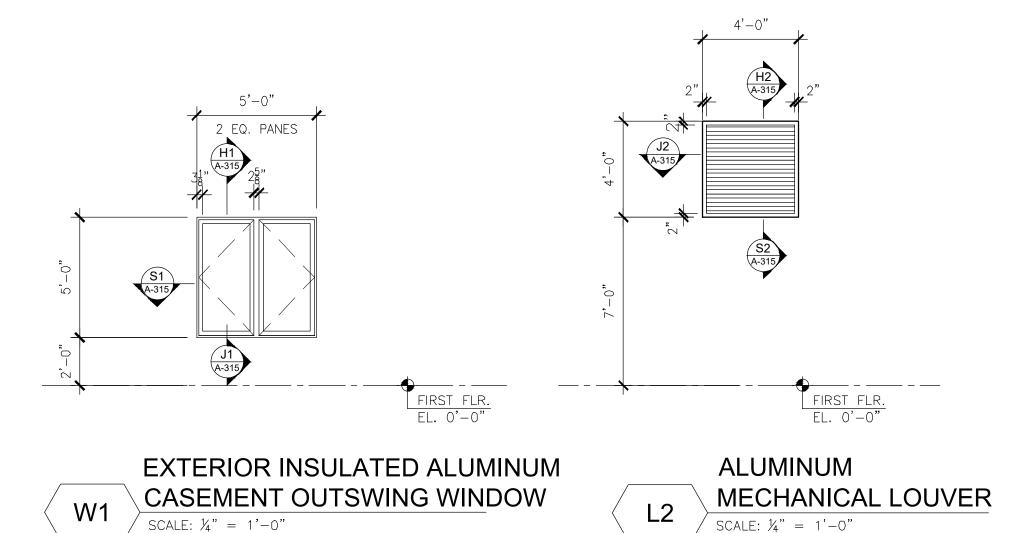
Drawing No.

ADDITIONS AND ALTERATIONS BURLINGTON COUNTY DEPT. OF PUBLIC WORKS 10 HARTFORD ROAD, DELRAN TWP. BURLINGTON CO. NJ

2025.03.12 - ISSUED FOR BID


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Checked	d by	LU		
Job No.		2241869		



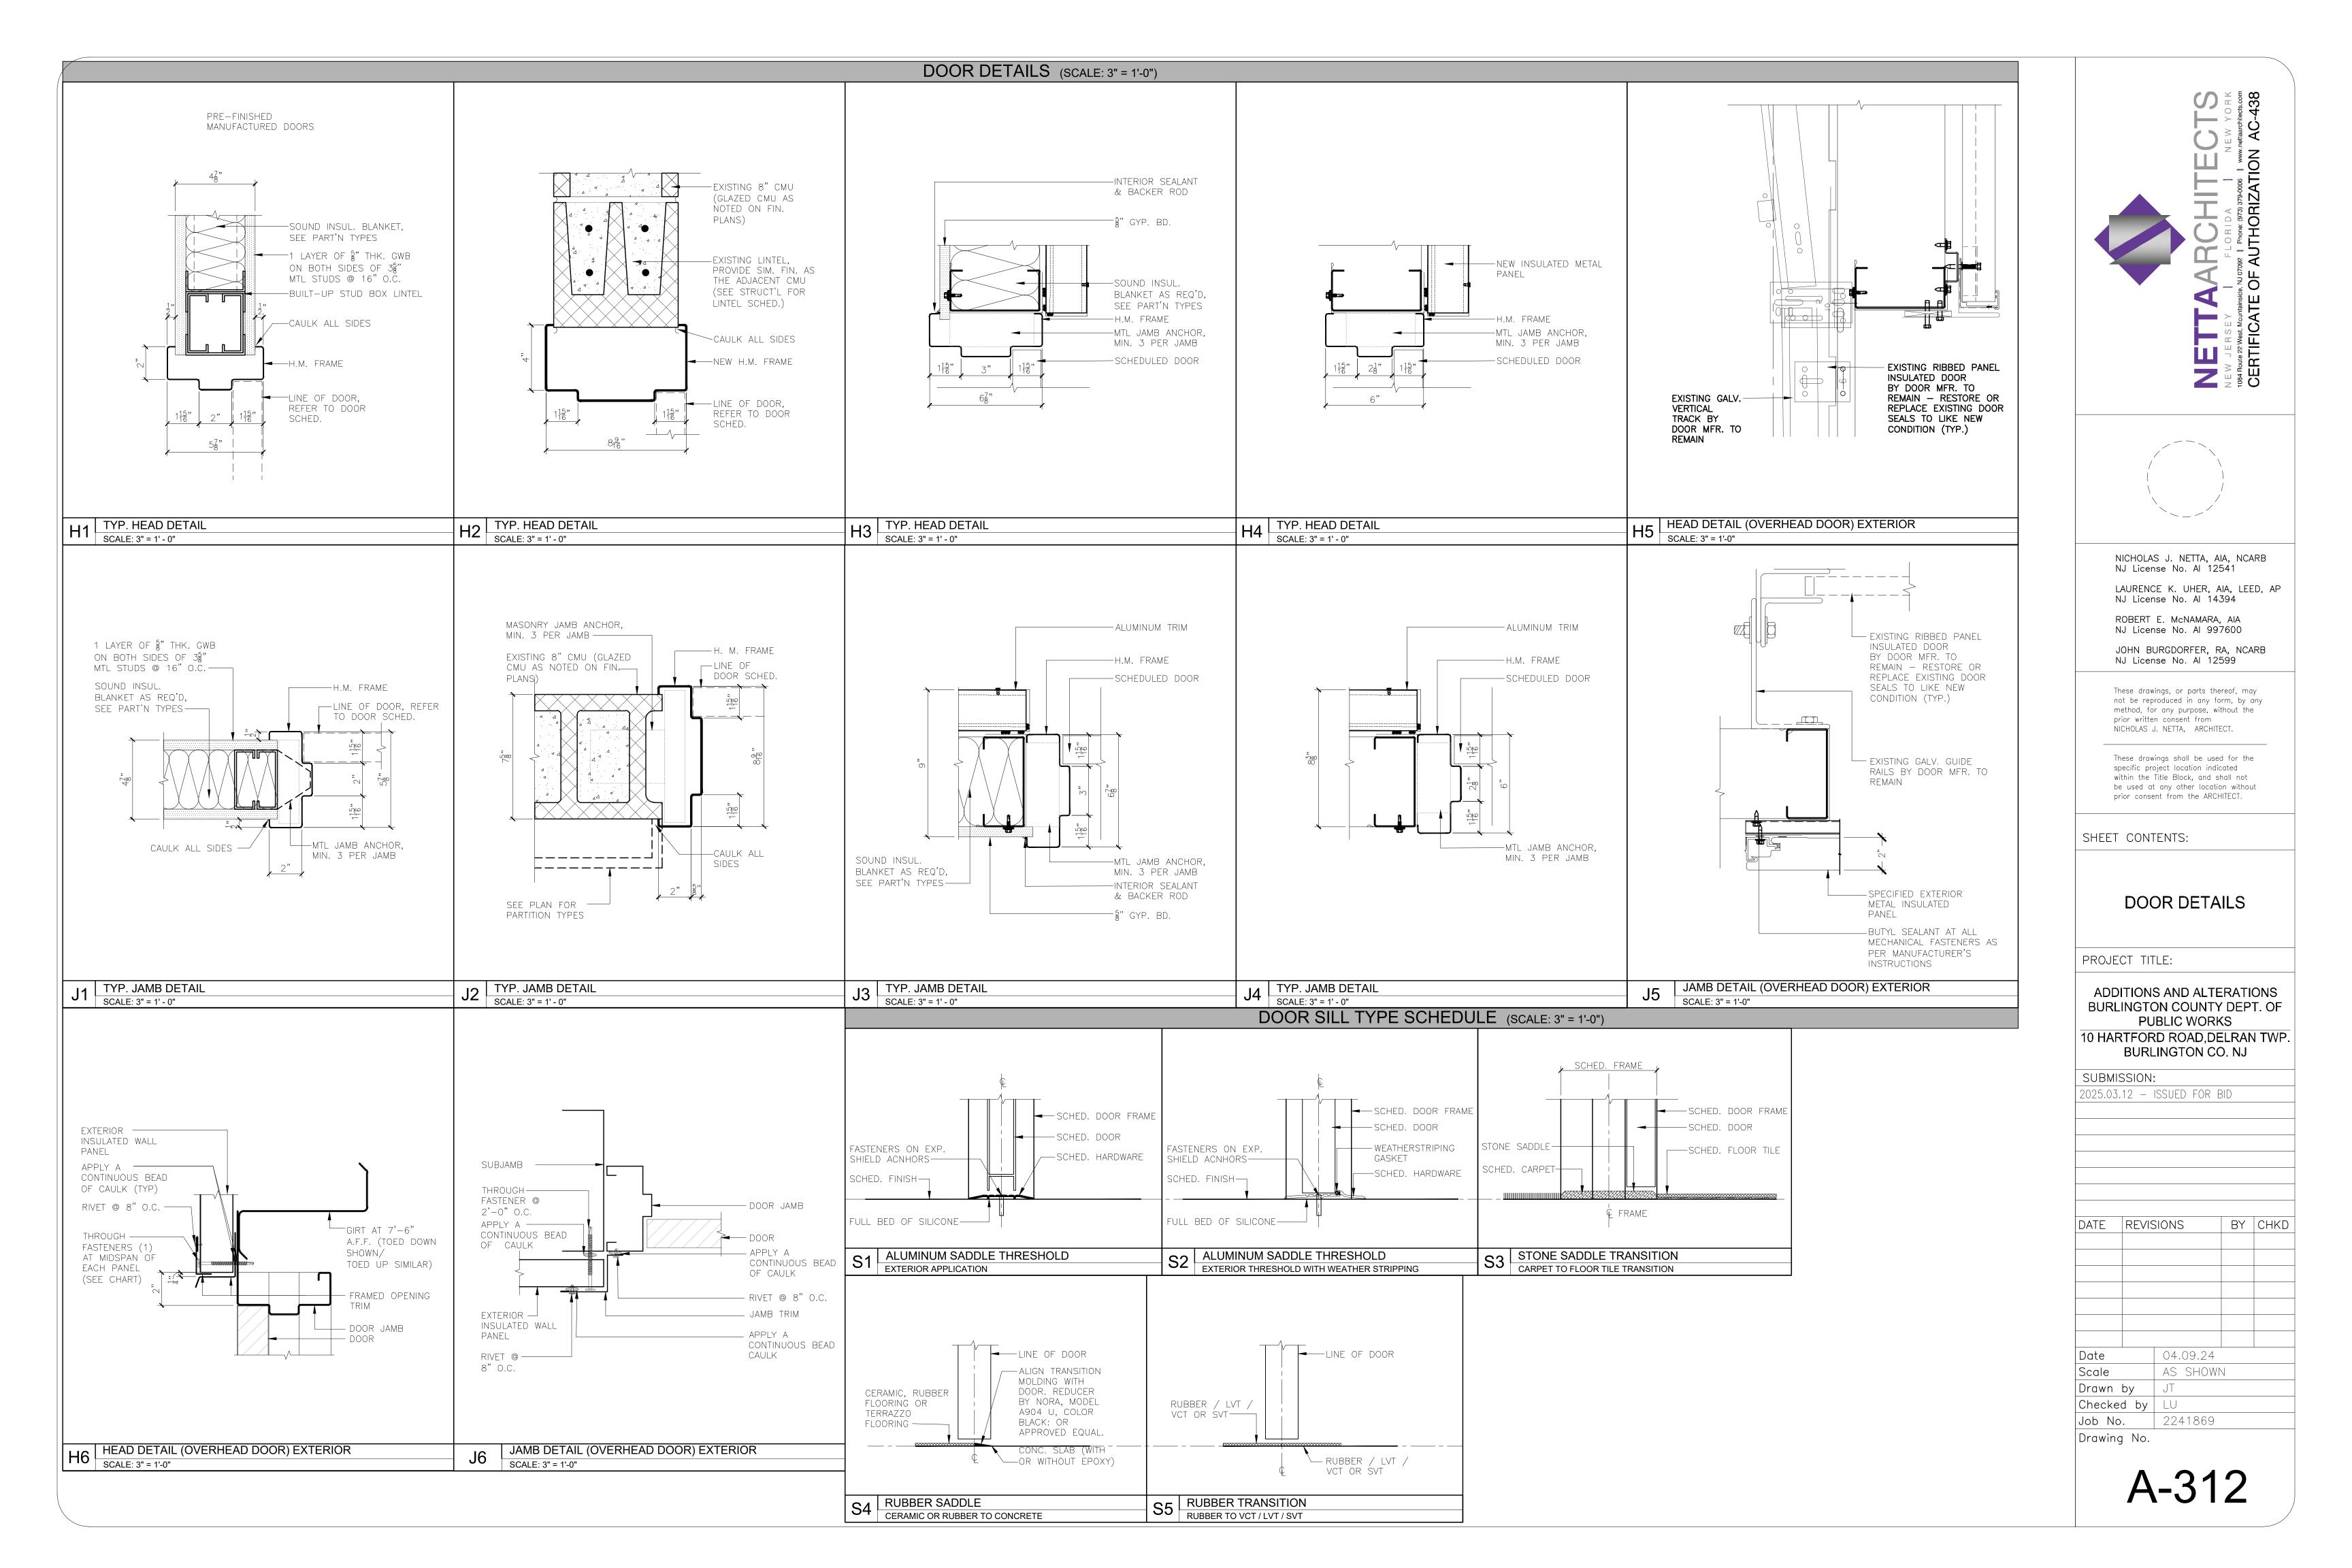


PROVIDE ALUM. BIRD SCREEN

KAWNEER AA6400 OR APPROVED EQUAL

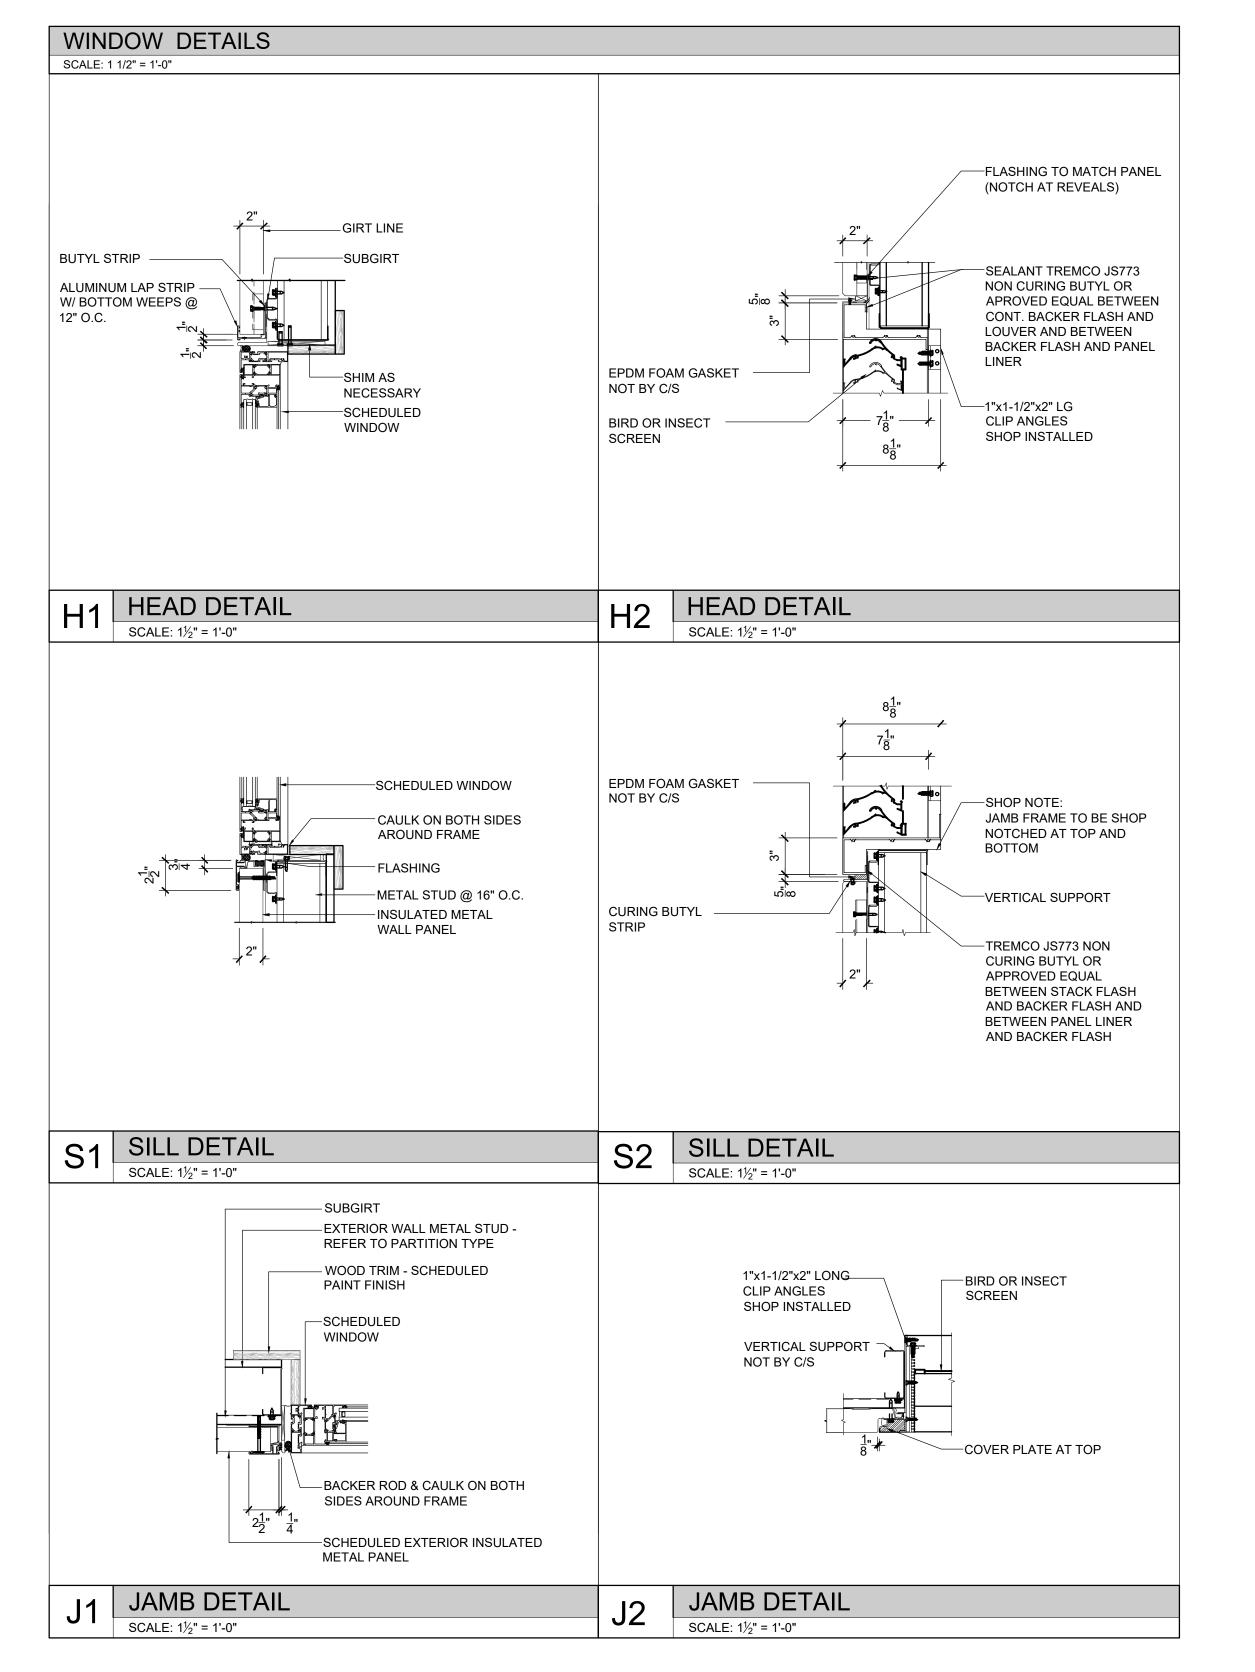



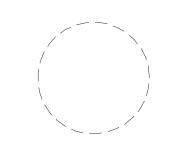

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ROBERT E. McNAMARA, AIA NJ License No. AI 997600

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SHEET CONTENTS:

WINDOW TYPES & DETAILS

PROJECT TITLE:

ADDITIONS AND ALTERATIONS
BURLINGTON COUNTY DEPT. OF
PUBLIC WORKS

10 HARTFORD ROAD, DELRAN TWP.

BURLINGTON CO. NJ


SUBMISSION: 2025.03.12 - ISSUED FOR BID

DATE REVISIONS BY CHKD

Date 04.09.24
Scale AS SHOWN

Drawn by JT
Checked by LU
Job No. 2241869

Drawing No.

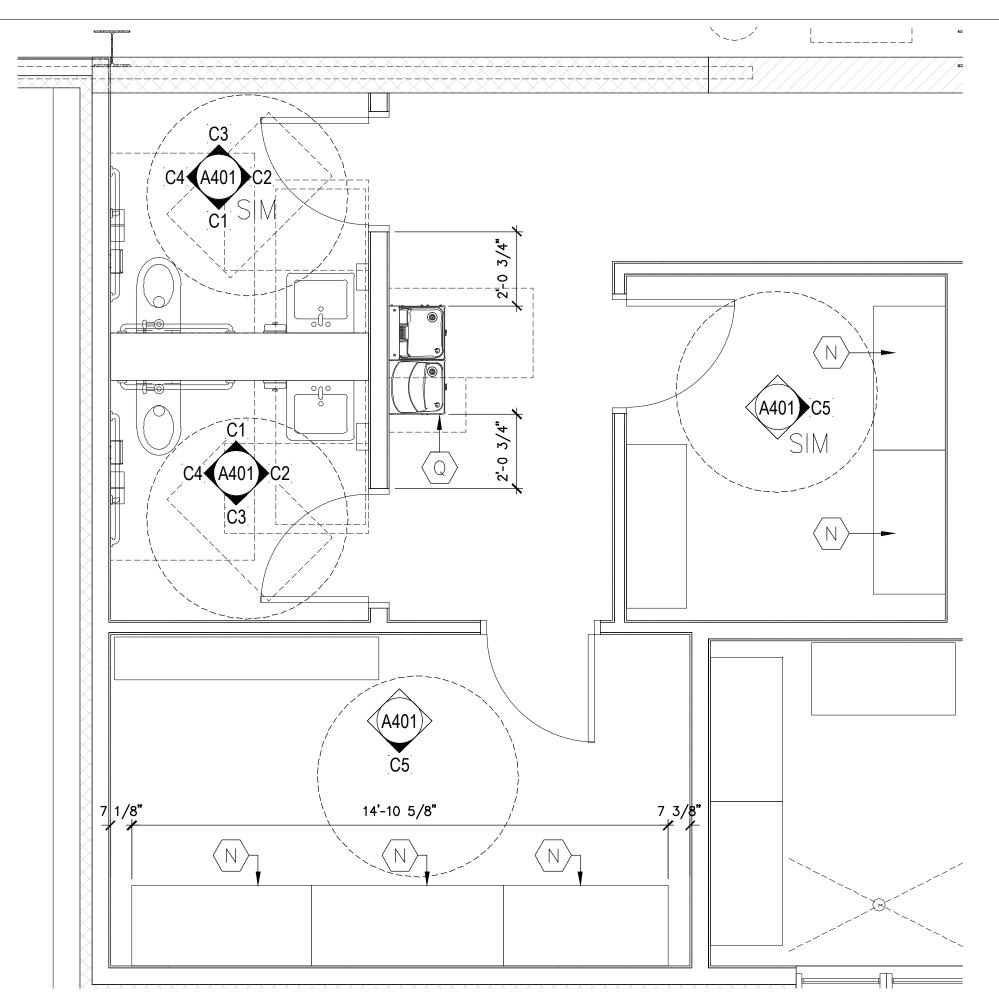



	В	ASIS OF DESIGN FO	OR TOILET A	CCESSOF	RIES
ГЕМ	PRODUCT NAME	DESCRIPTION	MANUFACTURER	MODEL #	REMARKS
(A1)	TOILET PARTITIONS (TP1*)	FLOOR-MOUNTED OVERHEAD-BRACED	ASI		SEE FINISH SCHEDULE
A2>	URINAL SCREENS (TP1*)	24"x55" WALL HUNG	ASI		SEE FINISH SCHEDULE
A3>	LOCKER BENCHES	1 1/2" THK. X 12" X 5'-0" WIDE FIXED SOLID PLASTIC BENCHES TO MATCH COLOR OF LOCKERS	SCRANTON PRODUCTS		SEE FINISH SCHEDULE
B1	18" GRAB BARS	1½" O.D. ST/STL. WITH CONCEALED MOUNTING	BOBRICK	B-5806 x 18	STAINLESS STL. SATIN FINISH
B2>	36" GRAB BARS	1½" O.D. ST/STL. WITH CONCEALED MOUNTING	BOBRICK	B-5806 x 36	STAINLESS STL. SATIN FINISH
B3>	42" GRAB BARS	1½" O.D. STAINLESS STL. WITH CONCEALED MOUNTING	BOBRICK	B-5806 x 42	STAINLESS STL. SATIN FINISH
<u>C</u>	TOILET TISSUE DISPENSER	SURFACE-MOUNTED DOUBLE ROLL TOILET TISSUE DISPENSER	BOBRICK	B-6867	STAINLESS STL. SATIN FINISH
D	PAPER TOWEL DISPENSER	SURFACE-MOUNTED DISPENSER & WASTE RECEPTACLE	BOBRICK	B-76867	STAINLESS STL. SATIN FINISH
F	WASTE RECEPTACLE	FLOOR STANDING WITH ST. STL. COVER	BOBRICK	B-2250	STAINLESS STL. SATIN FINISH
G	SOAP DISPENSER	AUTOMATIC WALL-MOUNTED SOAP DISPENSER	BOBRICK	B-2012	STAINLESS STL. SATIN FINISH
J1>	MIRROR	TEMPERED GLASS W/ POLISH ST/STL. CHANNEL FRAME	BOBRICK	B-2908 18"x24"	*SEE WALL ELEVATIONS
J1>	MIRROR	TEMPERED GLASS W/ POLISH ST/STL. CHANNEL FRAME	BOBRICK	B-2908 18"x24"	*SEE WALL ELEVATIONS
	TOILET SEAT COVER DISPENSER	ConturaSeries® SURFACE-MOUNTED SEAT-COVER DISPENSER ST/STL.	BOBRICK	B-4221	SATIN FINISH, PROVIDED BY OWNER
M	TOILET SEAT	Stronghold COMMERCIAL HEAVY-DUTY TOILET SEAT	KOHLER	K-4731-C	WHITE
N	TWO (2) TIER LOCKERS	12"W X 12" D X 36" H HORIZONTAL TWO (2) TIER LOCKERS WITH IN-DOOR COMBINATION LOCKS, LOCKER BASE, LOUVERS & SLOPE TOP	SCRANTON PRODUCTS		SEE FINISH SCHEDULE
Q	BOTTLE FILLING STATION W/ FILTERED LZ	EZH2O BOTTLE FILLING STATION WITH FILTERED SINGLE LZ COOLER	ELKAY	LVRCTL8WSK	STAINLESS FINISH, TYPICAL FOR ALL DRINKING STATIONS

1. ALL ACCESSIBLE FACILITIES ON THESE PLANS HAVE BEEN DESIGNED TO MEET ALL STATE, COUNTY, AND MUNICIPALITY CODES APPLICABLE. 2. BUILDING ENTRANCE SHALL BE ON AN ACCESSIBLE ROUTE WITH NO CHANGE IN LEVEL OF MORE THAN 1/2" ALONG ROUTE AND MAXIMUM LEVEL CHANGE OF 3/4" AT SLIDING EXTERIOR DOORS ONLY
3. ALL ENTRY DOORS IN UNITS SHALL PROVIDE A CLEAR OPENING OF 32" WIDE WHEN DOOR IS OPEN AT 90 DEGREES.

COOLER


- 3. ALL ENTRY DOORS IN UNITS SHALL PROVIDE A CLEAR OPENING OF 32" WIDE WHEN DOOR IS OPEN AT 90 DEGREES.


 4. LIGHT SWITCHES, ELECTRICAL OUTLETS, THERMOSTATS, AND OTHER ENVIRONMENTAL CONTROLS ARE TO BE LOCATED WITH OPERABLE PARTS NO HIGHER THAN 48" AND NO LOWER THAN 15" ABOVE THE FINISHED FLOOR. IF REACH IS OVER AN OBSTRUCTION, SUCH AS A CABINET, HEIGHT SHALL BE 44" FOR FORWARD APPROACH (NOTE: OBSTRUCTIONS MAY NOT EXTEND MORE THAN 25" FROM WALL).

 5. BATHROOMS SHALL BE PROVIDED WITH REINFORCEMENT IN WALLS TO ALLOW LATER INSTALLLATION OF GRAB BARS AROUND THE TOILET, SUCH REINFORCEMENT SHALL BE INSTALLED ACCORDING TO THE ILLUSTRATIONS SHOWN, PARALLEL APPROACH BY A WHEELCHAIR MUST BE PROVIDED IN FRONT OF LAVATORIES. IF PARALLEL APPROACH BY A OWIECHCHAIR MUST BE REMOVABLE TO ALLOW FORWARD APPROACH KNEE CLEARANCE. WHERE DOOR SWINGS INTO BATHROOM THERE MUST BE A CLEAR FLOOR SPACE OF 30"×48" TO POSITION A WHEELCHAIR WITHIN BATHROOM. TOILET SHOULD BE INSTALLED SO AS TO ALLOW A GRAB BAR TO BE INSTALLED ON ONE SIDE OF FIXTURE. REFER TO DIAGRAMS ON THIS SHEET.


 6. IN LIEU OF THE FACT THAT ALL ACCESSIBLITY CODES CHANGE AND ARE INTERPRETED DIFFERENTLY BY NOTIFICATION OF ACCESSIBLE FACILITIES. EXACTLY WHO WILL BE THE FINAL AUTHORITY REGARDING THE DESIGN. THE CONTRACTOR DETERMINE, PRIOR TO CONSTRUCTION IN WRITING, SHALL HAVE THE MARK OF THE FINAL AUTHORITY INCLUDING BUT NOT LIMITED TO, NAME, TITLE, ADDRESS, PHONE NUMBER, AND SIGNATURE.

 7. LAVATORN COUNTED TO DESIGN. THE CONTRACTOR DETERMINE, PRIOR TO CONSTRUCTION IN WRITING, SHALL HAVE THE MARK OF THE FINAL AUTHORITY INCLUDING BUT NOT LIMITED TO, NAME, TITLE, ADDRESS, PHONE NUMBER, AND SIGNATURE.
- 7. LAVATORY COUNTERTOP HEIGHT TO BE 34" A.F.F. WITH A MINIMUM CLEARANCE OF 29" A.F.F. TO THE BOTTOM OF THE APRON. ALL LAVATORIES TO HAVE SKIRTS. 8. FAUCETS TO BE LEVER OPERATED, PUSH TYPE, OR ELECTRONICALLY CONTROLLED MECHANISMS. IF SELF-CLOSING VALVES ARE USED THE FAUCET SHALL REMAIN OPEN FOR AT LEAST 10 SECONDS.
 9. ALL ACCESSIBLE TOILET STALL DOORS MUST HAVE A SELF-CLOSING FEATURE OR PULL LATCH MOUNTED AT THE CENTER OF THE PARTITION DOOR.

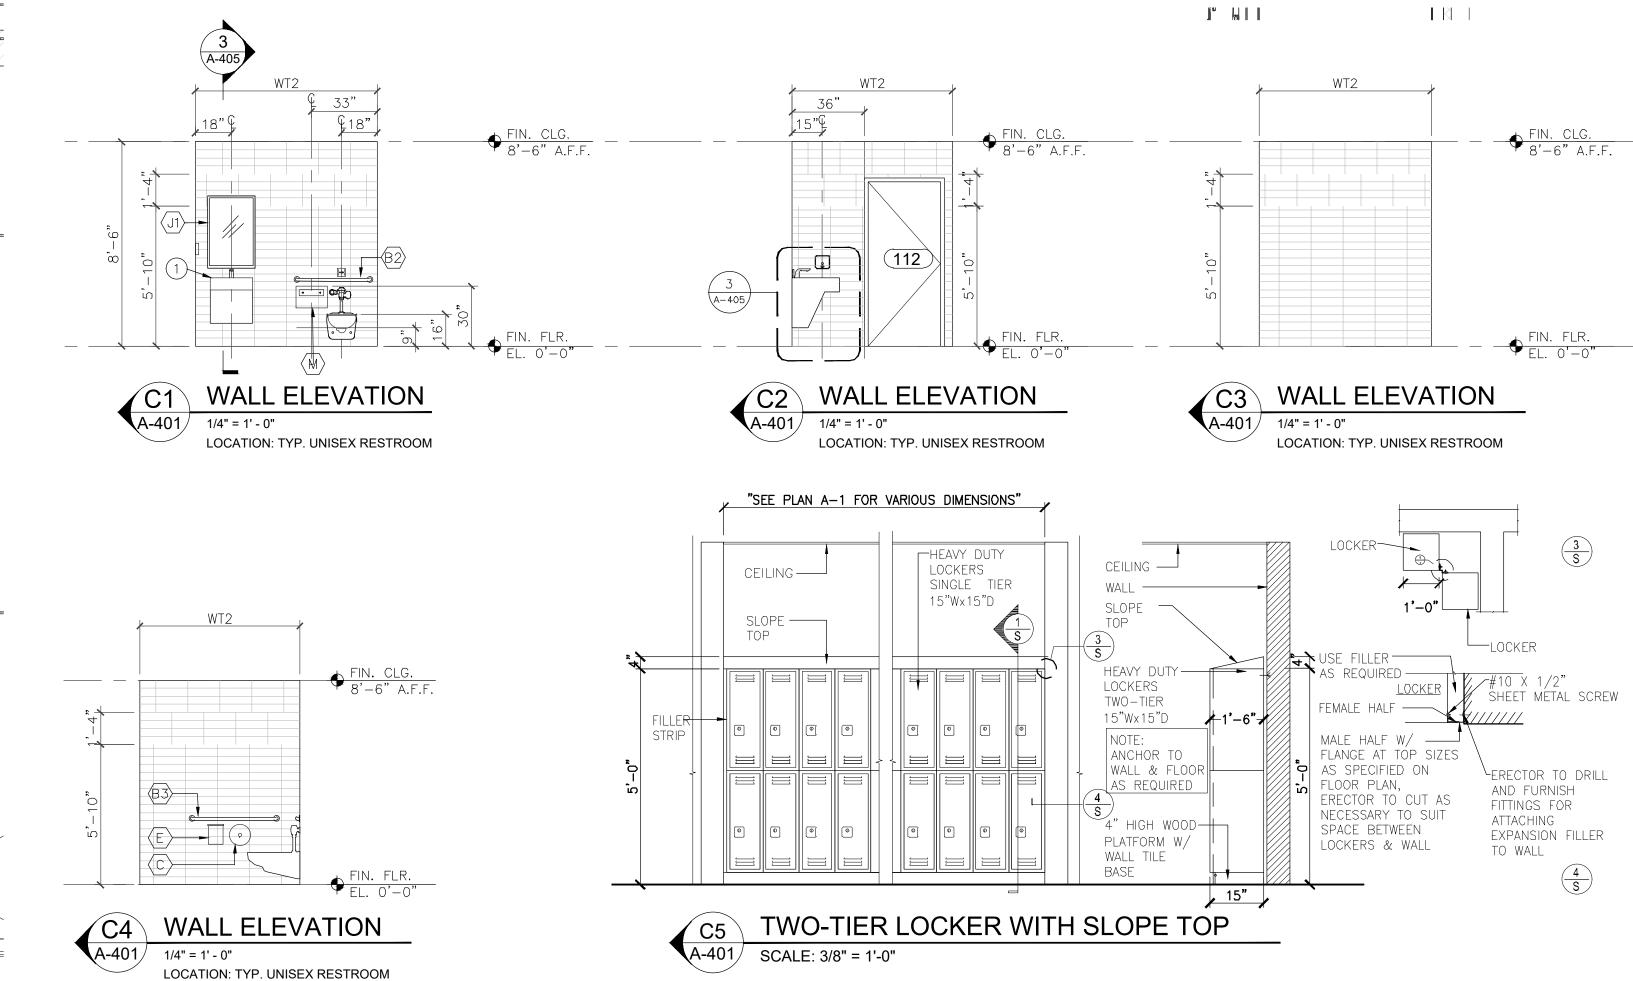

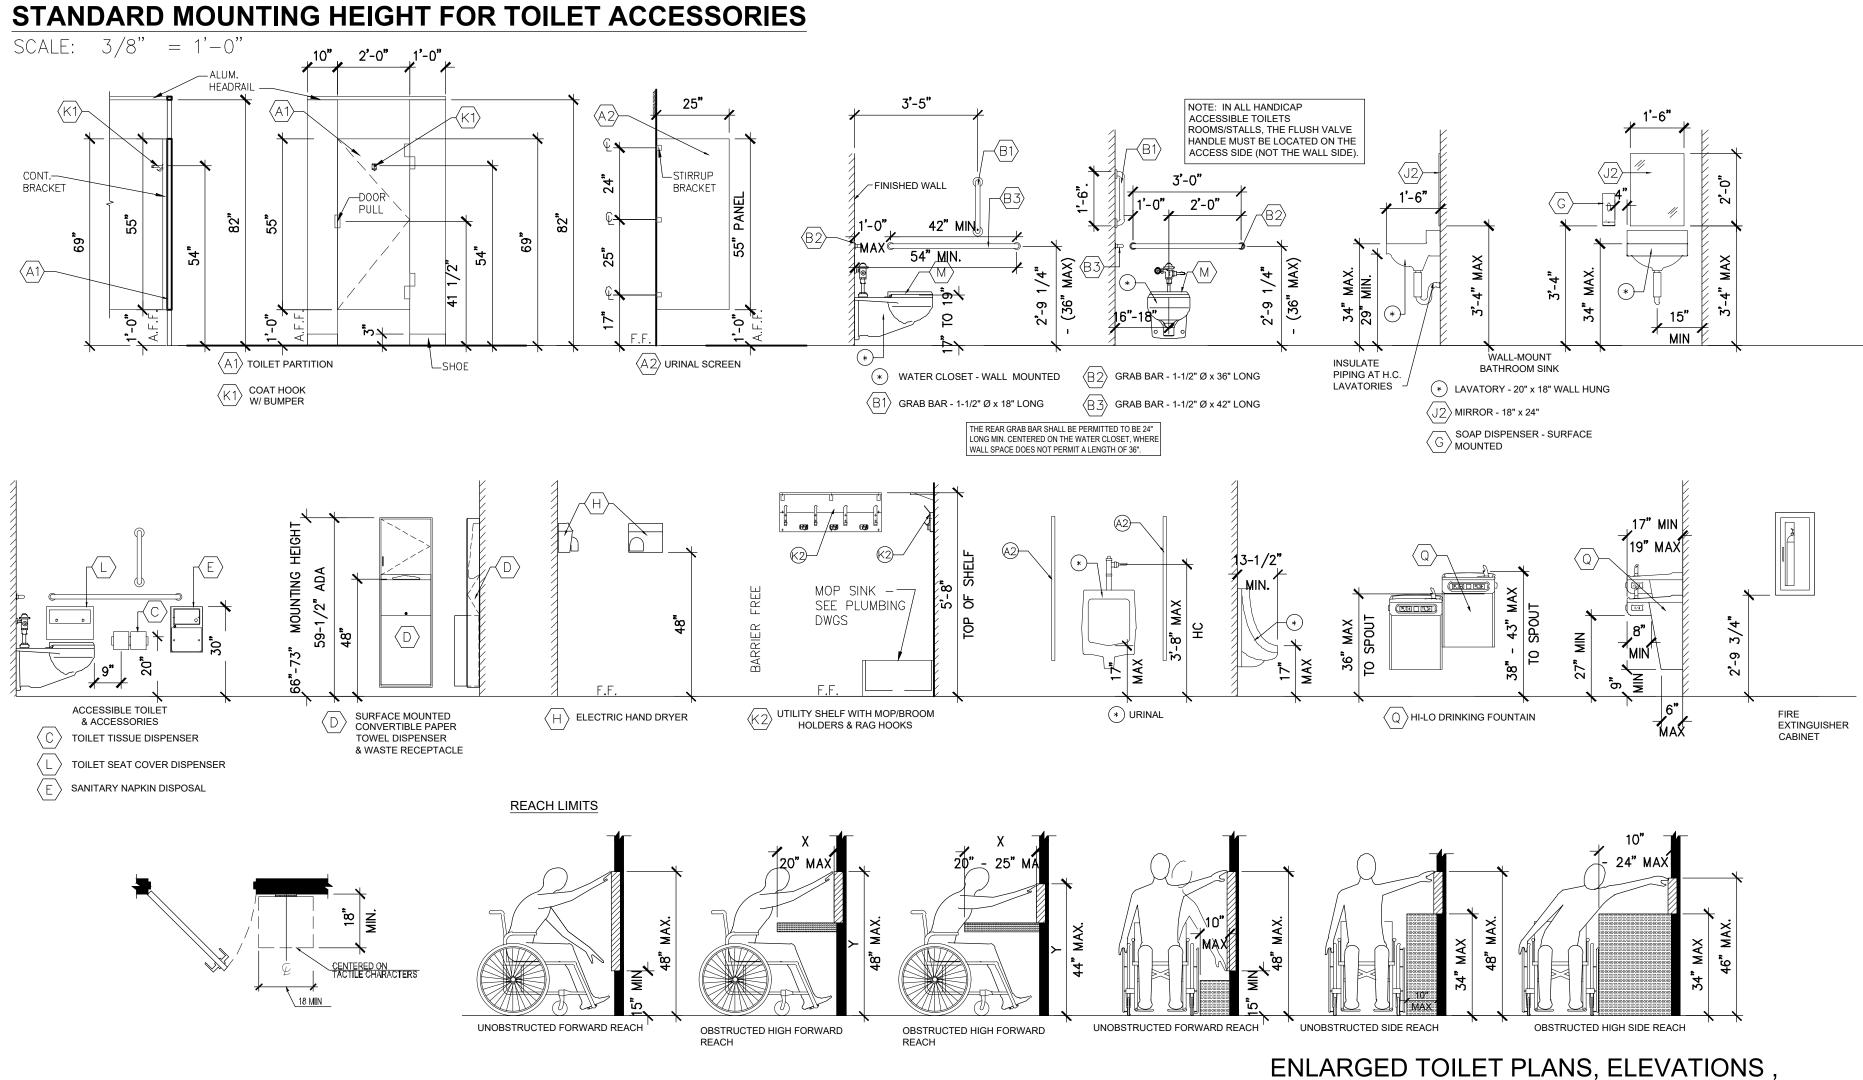



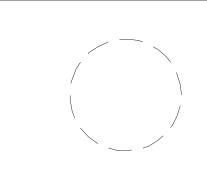

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SHEET CONTENTS:

ENLARGED TOILET PLANS & ELEVATIONS

PROJECT TITLE:

ADDITIONS AND ALTERATIONS BURLINGTON COUNTY DEPT. OF PUBLIC WORKS 10 HARTFORD ROAD, DELRAN TWP.

BURLINGTON CO. NJ

SUBMISSION:

2025.03.12 - ISSUED FOR BID

REVISIONS


BY CHKD

04.09.24 Scale AS SHOWN JT Drawn by

Checked by LU 2241869 Job No.

Drawing No.

SCHEDULE & MOUNTING HEIGHTS

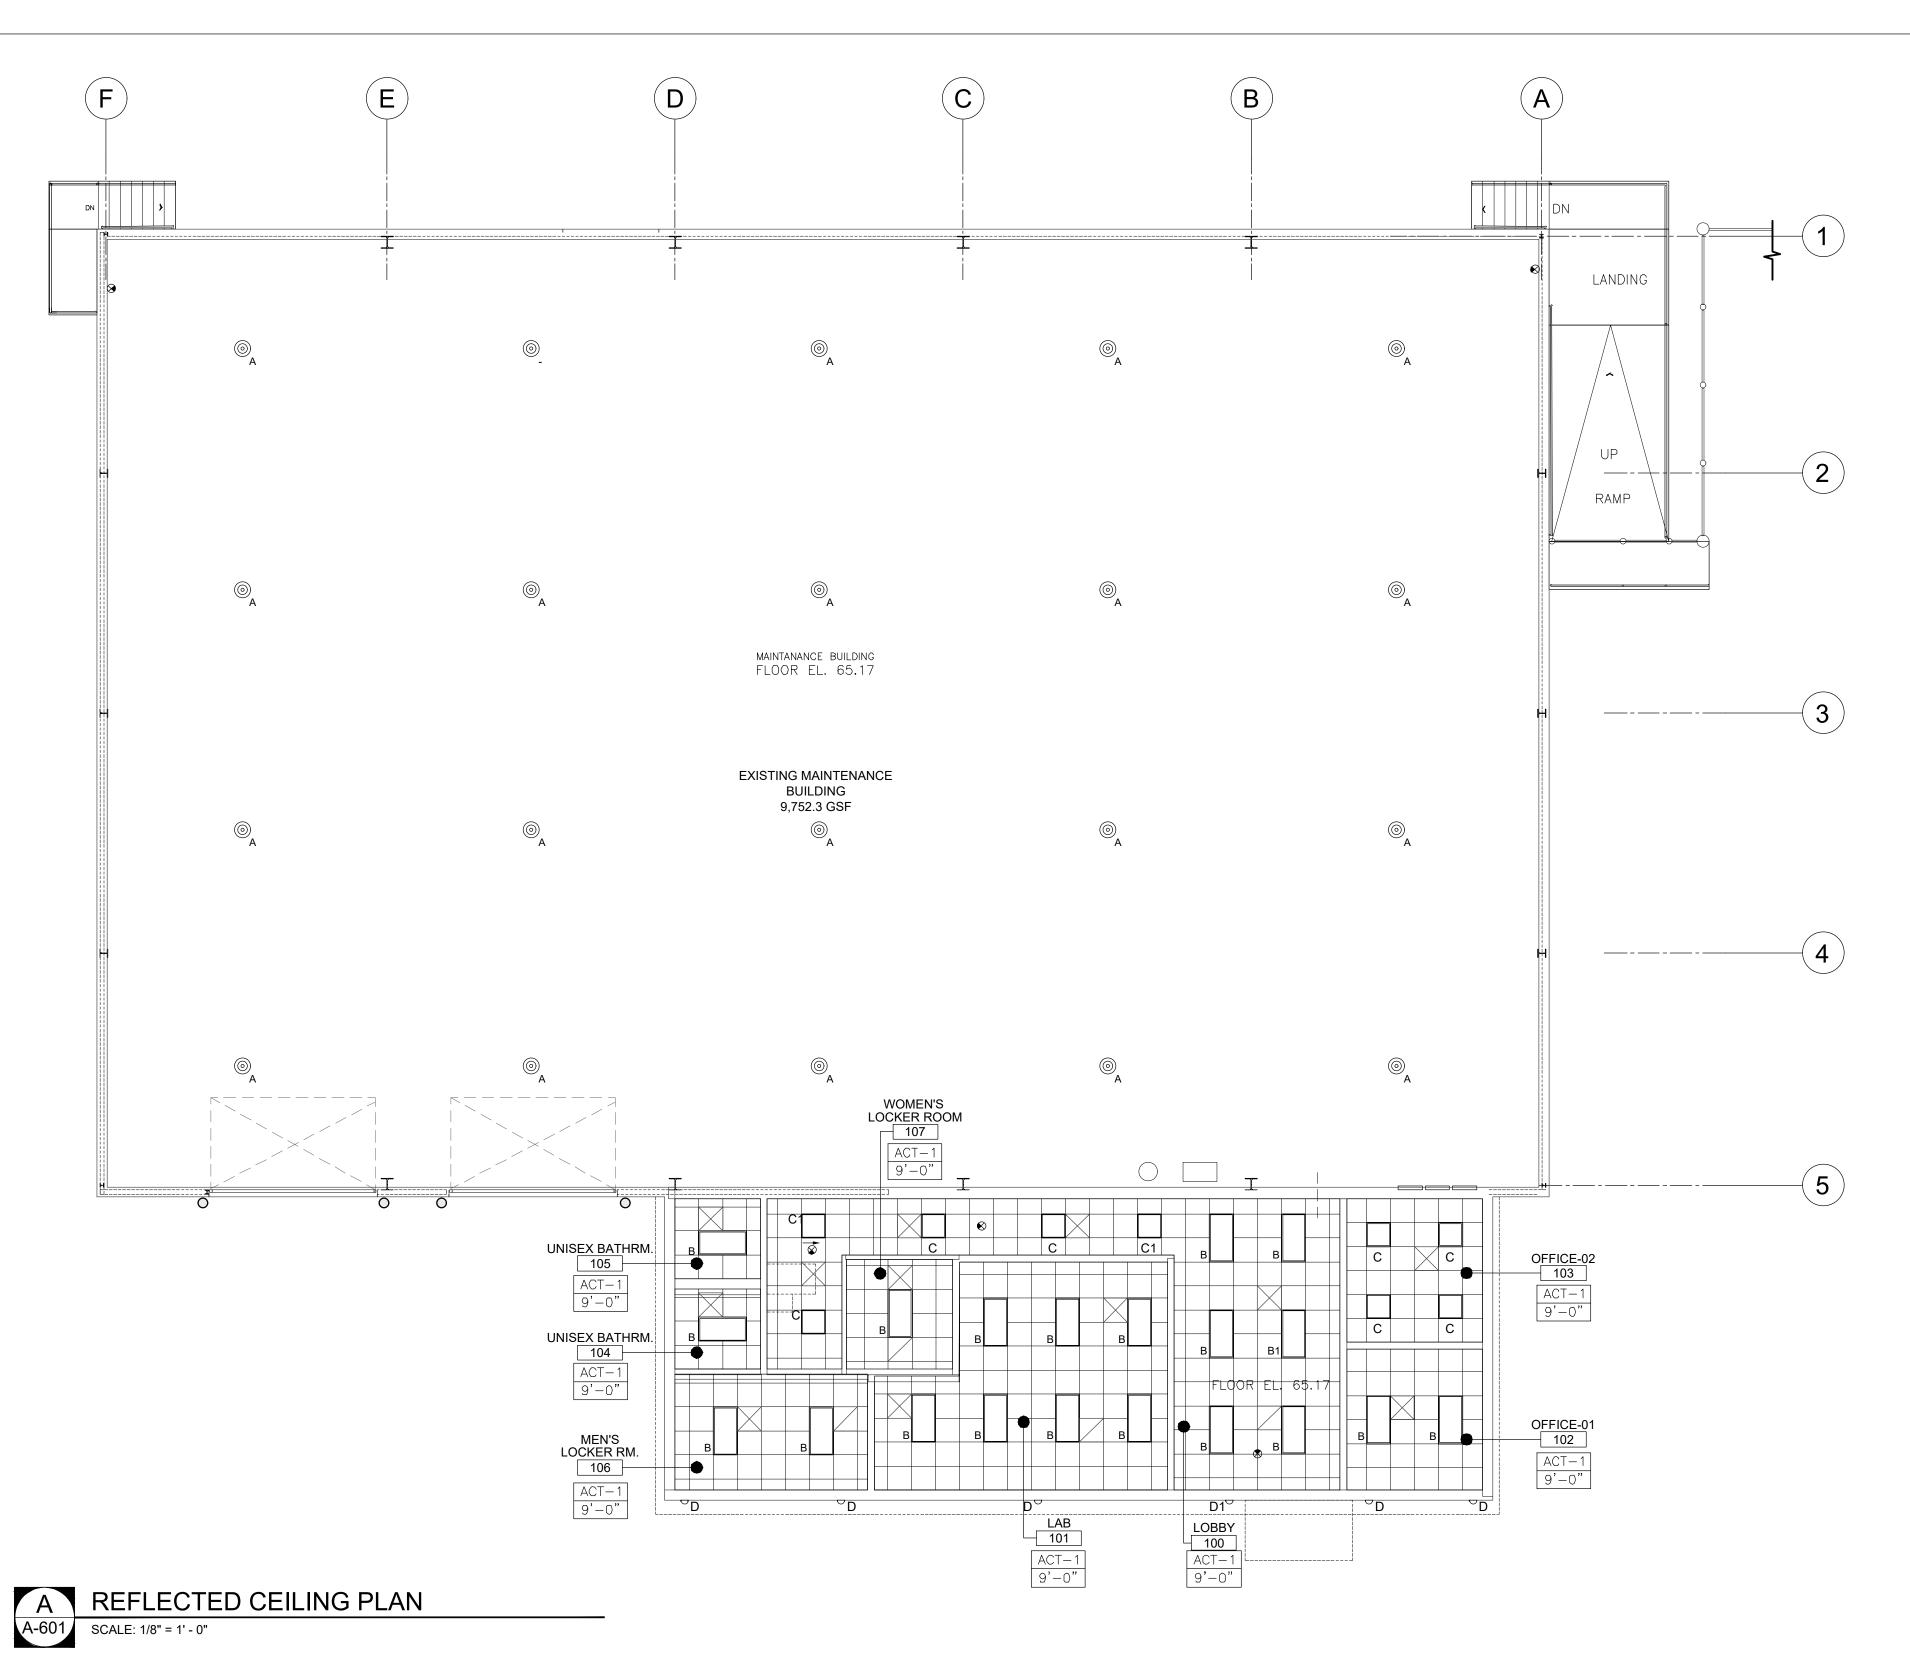




LUMINAI	RE **REFER TO LI	IGHTING FIXTU	JRE CUTSHEETS FOR COMPLETE CATALOG NUMBERS**							
Symbol	Arrangement	Fixture Type	Fixture Description	Manufacturer	Catalog Number	ССТ	LLF	Total Watts	Delivered Lumens	Filename
	Single	В	2X4 RECESSED TROFFER, SELECTABLE CCT & OUTPUT, CALCULATED W/ LOW OUTPUT	NORA LIGHTING	NPDBLSW-E24-/334-W	3500	0.900	33.26	4602	NPDBLSW-E24334W 36W 3500KIES
	Single	B1	2X4 RECESSED TROFFER, SELECTABLE CCT & OUTPUT, CALCULATED W/ LOW OUTPUT & BATTERY BACKUP	NORA LIGHTING	NPDBLSW-E24-/334-W-EM	3500	0.900	33.26	4602	NPDBLSW-E24334W 36W 3500KIES
	Single	С	2X2 RECESSED TROFFER, SELECTABLE CCT & OUTPUT, CALCULATED W/ LOW OUTPUT	NORA LIGHTING	NPDBLSW-E22-/334-W	3500	0.900	23.37	3127	NPDBLSW-E22334W 25W 3500KIES
	Single	C1	2X2 RECESSED TROFFER, SELECTABLE CCT & OUTPUT, CALCULATED W/ LOW OUTPUT & BACKUP	BATTERWORA LIGHTING	NPDBLSW-E22-/334-W-EM	3500	0.900	23.37	3127	NPDBLSW-E22334W 25W 3500KIES
	Single	D	EXTERIOR SCONCE LIGHTING	COOPER LIGHTING	GAW-SA1C-740-U-5WQ-BK	4000		34	3880	
\Box	Single	D1	EXTERIOR SCONCE LIGHTING W/ BATTERY BACKUP	COOPER LIGHTING	GAW-SA1C-740-U-5WQ-BK-CBP	4000		34	3880	
(4)	Single	А	EXISTING LIGHTING FIXTURE TO REMAIN							
⊗	Single	EX	TELESIS UNIVERSAL LED EDGELIT EXIT SIGN	EVENLITE	TEXZ-EM-R-URC			RED 2.5 Watts		

GENERAL NOTE: GC TO INSTALL MANUAL ON OCCUPANCY SENSORS IN ROOMS IN ADDITION TO MANUAL WALL SWITCHES. REFER TO ELECTRICAL DRAWINGS FOR MORE INFORMATION.

NEW JERSEY | FLORIDA | NEW YO 1084 Route 22 West, Mountainside, NJ 07092 | Phone: (973) 379-0006 | www.nettaarchitects
CERTIFICATE OF AUTHORIZATION AC-45

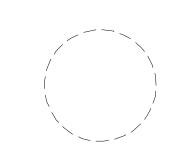

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SHEET CONTENTS:

REFLECTED CEILING PLAN

PROJECT TITLE:

ADDITIONS AND ALTERATIONS
BURLINGTON COUNTY DEPT. OF
PUBLIC WORKS

10 HARTFORD ROAD, DELRAN TWP.
BURLINGTON CO. NJ

SUBMISSION:

2025.03.12 - ISSUED FOR BID

DATE REVISIONS

ate 04.09.24

BY CHKD

Scale AS SHOWN
Drawn by JT
Checked by LU
Job No. 2241869

Drawing No.

GENERAL NOTES

A. ROOF LIVE LOAD 20 PSF

B. FLOOR LIVE LOAD 150 PSF

DEAD LOAD:

LIVE LOAD:

A. STRUCTURAL AND BUILDING COMPONENTS SELF WEIGHT

3. WIND LOADING PER IBC 2021 - NEW JERSEY EDITION:

A. BASIC WIND VELOCITY (V): 126 MPH

B. EXPOSURE CATEGORY: C. RISK CATEGORY:

4. SEISMIC LOADING PER IBC 2021 - NEW JERSEY EDITION:

A. RESPONSE ACCELERATOR: $S_S = 0.185$ $S_{DS} = 0.197$ $S_{I} = 0.048$ $S_{DI} = 0.076$

B. SEISMIC DESIGN CATEGORY: B C. SEISMIC SITE CLASSIFICATION: D D. IMPORTANCE FACTOR I_E: 1.25

5. SNOW LOADING PER IBC 2021 - NEW JERSEY EDITION:

A. GROUND SNOW LOAD: 25 PSF B. IMPORTANCE FACTOR: 1.1

6. SPECIAL LOADS:

A. HANDRAILS/GUARDRAILS: IN COMPLIANCE WITH THE PROVISIONS OF IBC 2021 - NEW JERSEY EDITION SEE PROJECT SPECIFICATIONS.

FOUNDATIONS

- 1. ALL EXISTING FILL MATERIALS, CONSISTING OF GRAVEL, BRICK FRAGMENTS, CONCRETE CHIPS. WOOD CHIPS, AND DEMOLITION DEBRIS SHALL BE REMOVED IN THE REGIONS OF ALL FOUNDATIONS AND UNDER AREAS OF SLAB-ON-GRADE.
- 2. THE SLAB ON GRADE SHALL REST ON A MINIMUM OF 6 INCHES OF COMPACTED GRANULAR FILL.
- 3. PROOF ROLL SLAB SUBGRADE UNDER THE DIRECTION OF THE INSPECTION AGENCY. REMOVE ALL UNSUITABLE AREAS AND REPLACE WITH COMPACTED STRUCTURAL FILL MATERIALS. COMPACT FILL TO AT LEAST 95 PERCENT OF THE MAXIMUM DENSITY AS DETERMINED BY THE ASTM D 1557 MODIFIED PROCTOR TEST.
- 4. EDGES OF FOOTINGS SHALL NOT BE PLACED AT A GREATER THAN 1 (VERTICAL) TO 2 (HORIZONTAL) SLOPE WITH RESPECT TO ANY ADJACENT FOOTING OR EXCAVATION.
- 5. ALL ADJACENT COLUMN FOOTINGS THAT ABUT SHALL BE SEPARATED BY A PAPER
- 6. BACKFILLING AGAINST WALLS SHALL NOT BE DONE UNTIL CONCRETE HAS BEEN CURED TO ATTAIN SUFFICIENT STRENGTH (7 DAYS MINIMUM) AND WALLS ARE PROPERLY SHORED AND/OR BRACED. BACKFILL FOUNDATION WALLS WITH EARTH ON BOTH SIDES OF THE WALL BY ALTERNATELY PLACING BACKFILL ON EACH SIDE SO THAT HEIGHT OF BACKFILL DOES NOT DIFFER BY MORE THAN 1'-6" FROM OTHER SIDE.
- 7. THE CONTRACTOR SHALL SAFEGUARD AND PROTECT ALL EXCAVATIONS AND ALL EXCAVATIONS SHALL BE KEPT FREE OF WATER.
- 8. NO HORIZONTAL JOINTS SHALL BE PLACED IN WALLS EXCEPT AS SHOWN ON THE DRAWINGS WITHOUT APPROVAL OF THE ENGINEER.
- 9. THE CONTRACTOR SHALL REFER TO THE ARCHITECTURAL, PLUMBING, MECHANICAL, AND ELECTRICAL DRAWINGS FOR ALL LOCATIONS OF TRENCHES, PITS, CONDUITS, ETC NOT SHOWN ON THE STRUCTURAL DRAWINGS.

FOUNDATION CONCRETE

1. ALL CONCRETE SHALL BE NORMAL WEIGHT STRUCTURAL CONCRETE HAVING A DESIGN COMPRESSIVE STRENGTH AT 28 DAYS AS FOLLOWS:

A. FOOTINGS 4,000 PSI B. WALLS AND PIERS 4,000 PSI C. SLAB-ON-GRADE 4,000 PSI

- 2. NO CONCRETE SHALL BE PLACED UNTIL CONCRETE DESIGN MIXES HAVE BEEN SUBMITTED FOR EACH CLASS OF CONCRETE NOTED ABOVE AND HAVE BEEN APPROVED BY THE ENGINEER.
- 3. REINFORCING STEEL SHALL BE DEFORMED BARS OF INTERMEDIATE GRADE NEW BILLET STEEL CONFORMING TO CURRENT REQUIREMENTS OF ASTM A 615, GRADE 60. LAP BARS 40 DIAMETER UNLESS OTHERWISE SHOWN. ALL HOOKS SHALL BE STANDARD HOOKS, UNLESS OTHERWISE NOTED.
- 4. WELDED WIRE FABRIC SHALL CONFORM TO ASTM A 185.
- 5. ALL MESH SHALL BE SPLICED SO THAT THE OVERLAP OF THE OUTERMOST CROSS WIRES OF EACH ADJOINING SHEET IS NOT LESS THAN THE SPACING OF THE CROSS WIRES PLUS 2 INCHES, UNLESS NOTED OTHERWISE.
- 6. FOR ALL SLABS ON GRADE WHERE NOT OTHERWISE SPECIFIED, USE 6x6-W2.9xW2.9
- 7. MINIMUM STEEL PROTECTION, UNLESS OTHERWISE SHOWN, SHALL BE 1-INCH FOR INTERIOR FACE OF WALLS, 2 INCHES FOR EXTERIOR FACE OF WALLS, 3 INCHES FOR FOOTINGS AND OTHER STRUCTURAL CONCRETE DEPOSITED AGAINST GROUND, 2 INCHES FOR CONCRETE PERMANENTLY EXPOSED TO EARTH OR WEATHER.
- 8. ALL STRUCTURAL MEMBERS SHALL BE POURED FOR THEIR FULL DEPTHS IN ONE OPERATION. CONSTRUCTION JOINTS, SUCH AS DAY'S POUR JOINTS, SHALL BE LOCATED IN THE MIDDLE THIRD OF THE SPAN, MAIN REINFORCING TO RUN THROUGH THE JOINT, KEY AND ROUGHEN JOINTS TO EXPOSE AGGREGATE. CONTRACTOR SHALL SUBMIT DRAWING INDICATING CONSTRUCTION JOINT LOCATIONS FOR APPROVAL.
- 9. NO CONCRETE SHALL BE PLACED IN WATER.
- 10. ALL SLABS ON GRADE SHALL HAVE THICKENINGS, DEPRESSIONS, OPENINGS, ETC. AS SHOWN ON OR AS REQUIRED BY VARIOUS TRADES.
- 11. REFER TO ARCHITECTURAL DRAWINGS AND/OR SPECIFICATIONS FOR CONCRETE
- 12. FOR ADDITIONAL CONCRETE WORK NOT SHOWN ON STRUCTURAL DRAWINGS, SEE ARCHITECTURAL DRAWINGS.

SUPERSTRUCTURE CONCRETE

1. ALL CONCRETE SHALL BE NORMAL WEIGHT STRUCTURAL CONCRETE HAVING A DESIGN COMPRESSIVE STRENGTH AS FOLLOWS:

A. COLUMNS 4,000 PSI B. SLABS, BEAM 4,000 PSI C. WALLS 4,000 PSI

HOOKS, UNLESS OTHERWISE NOTED.

- 2. NO CONCRETE SHALL BE PLACED UNTIL CONCRETE DESIGN MIXES HAVE BEEN SUBMITTED FOR EACH CLASS OF CONCRETE NOTED ABOVE AND HAVE BEEN APPROVED BY THE ENGINEER.
- 3. REINFORCING STEEL SHALL BE DEFORMED BARS OF INTERMEDIATE GRADE NEW BILLET STEEL CONFORMING TO CURRENT REQUIREMENTS OF ASTM A 615, GRADE 60. LAP BARS 40 DIAMETER UNLESS OTHERWISE SHOWN. ALL HOOKS SHALL BE STANDARD
- 4. MINIMUM STEEL PROTECTION, UNLESS OTHERWISE SHOWN, SHALL BE 3/4-INCH FOR SLABS, 1-INCH FOR INTERIOR FACE OF WALLS, 2-INCH FOR EXTERIOR FACE OF WALLS, 1 1/2-INCH FOR BEAM STIRRUPS AND COLUMN TIES, 2-INCH FOR VERTICAL COLUMN REINFORCING.
- 5. ALL STRUCTURAL MEMBERS SHALL BE POURED FOR THEIR FULL DEPTHS IN ONE OPERATION. CONSTRUCTION JOINTS, SUCH AS DAY'S POUR JOINTS, SHALL BE LOCATED IN THE MIDDLE THIRD OF THE SPAN, MAIN REINFORCING TO RUN THROUGH THE JOINT, KEY AND ROUGHEN JOINTS TO EXPOSE AGGREGATE. CONTRACTOR SHALL SUBMIT DRAWING INDICATING CONSTRUCTION JOINT LOCATIONS FOR APPROVAL.
- 6. NO OPENINGS SHALL BE MADE IN ANY STRUCTURAL MEMBER, UNLESS SPECIFICALLY SHOWN ON THE STRUCTURAL DRAWINGS, WITHOUT APPROVAL FROM THE ENGINEER. NO SLEEVES SHALL BE PLACED HORIZONTALLY OR VERTICALLY IN BEAMS OR JOISTS, UNLESS SPECIFICALLY SHOWN ON THE STRUCTURAL DRAWINGS, WITHOUT APPROVAL FROM THE ENGINEER.
- 7. CONTRACTOR SHALL SUBMIT A COORDINATED DRAWING SHOWING ALL SLEEVES, OPENINGS, BLOCKOUTS, ETC., AS REQUIRED BY ALL TRADES, FOR APPROVAL, PRIOR TO PLACING CONCRETE IN THAT AREA.
- 8. ALL SLABS SHALL HAVE THICKENINGS, DEPRESSIONS, OPENINGS, ETC. AS SHOWN HEREIN OR ON ARCHITECTURAL, MECHANICAL, ELECTRICAL, AND PLUMBING DRAWINGS.
- 9. WELDED WIRE FABRIC SHALL CONFORM TO ASTM A 185.
- 10. ALL MESH SHALL BE SPLICED SO THAT THE OVERLAP BETWEEN OUTERMOST CROSS WIRES OF EACH SHEET IS NOT LESS THAN THE SPACING OF THE CROSS WIRES PLUS 2 INCHES, UNLESS OTHERWISE SHOWN ON DRAWINGS.
- 11. FOR ALL SLABS WHERE NOT OTHERWISE SPECIFIED USE STYLE 6x6-W2.9xW2.9 W.W.F.
- 12. FOR ADDITIONAL CONCRETE WORK NOT SHOWN ON STRUCTURAL DRAWINGS, SEE ARCHITECTURAL DRAWINGS.
- 13. REFER TO ARCHITECTURAL DRAWINGS AND/OR SPECIFICATIONS FOR CONCRETE FINISHES.

- 1. HOLLOW CONCRETE MASONRY UNITS ASTM C90, GRADE N, TYPE 1 NORMAL WEIGHT 1900 PSI NET AREA COMPRESSIVE.
- 2. MORTAR SHALL BE ASTM C270, TYPE S FOR ALL REINFORCED MASONRY, EXTERIOR WALLS AND WALLS BELOW GRADE.
- 3. GROUT SHALL BE ASTM C476, 28 DAY COMPRESSIVE STRENGTH OF 3,000 PSI.
- 4. REINFORCING STEEL GRADE 60 REINFORCING BARS.
- 5. HORIZONTAL JOINT REINFORCEMENT ASTM A951.
- 6. STRENGTH OF MASONRY ASSEMBLY I'm = 1.500 PSI.
- 7. CONSTRUCTION SHALL CONFORM TO SPECIFICATIONS FOR MASONRY STRUCTURES, ACI
- 8. REINFORCING METAL TIES AND ANCHORS SHALL BE PROTECTED FROM CONTACT WITH SOIL AND BEFORE BEING PLACED SHALL BE FREE FROM LOOSE RUST AND OTHER COATINGS THAT WILL DESTROY OR REDUCE THE BOND. MINIMUM LAP SHALL BE 48 BAR DIAMETERS FOR REBAR AND 6" FOR JOINT REINFORCEMENT.
- 9. SHOP DRAWINGS SHOWING ALL BAR REINFORCING IN ELEVATION (1/8" TO 1'-0" MINIMUM SCALE) SHALL BE SUBMITTED AND REVIEWED PRIOR TO CONSTRUCTION.
- 10. ALL MASONRY WALLS TO HAVE 9 GAGE TRUSS TYPE HORIZONTAL REINFORCEMENT AT 16 INCHES ON CENTER.
- 11. MASONRY UNITS SHALL BE STEAM CURED. A MINIMUM OF 28 DAYS AT THE TIME OF DELIVERY AND CONTINUOUSLY PROTECTED FROM EXPOSURE TO RAIN OR OTHER SOURCES OF WATER FROM TIME OF CASTING TO FINAL PLACEMENT IN WALL. MASONRY UNITS SHALL BE DRY, FREE FROM SOIL, ICE AND FROST WHEN LAID IN WALL. SEE ACI 530.1 FOR COLD AND HOT WEATHER CONSTRUCTION AND WALL PROTECTION REQUIREMENTS.

LIGHT GAGE METAL FRAMING

- 1. ALL GALVANIZED MATERIAL SHALL CONFORM TO THE FOLLOWING:
- A. STUDS AND JOISTS OF 12, 14, AND 16 GAGE: ASTM A 446, GRADE D, FY=50,000 PSI MINIMUM
- B. STUDS AND JOISTS OF 18 AND 20 GAGE, TRACKS, BRIDGING, AND ACCESSORIES:
- ASTM 446, GRADE A, FY=33,000 PSI MINIMUM.

GALVANIZED COATING CONFORMING TO ASTM A 525. WOOD FRAMING

1. PROVIDE ALL WOOD FRAMING MATERIALS AS SHOWN ON THE PLANS FOR COMPLETE

2. ALL GALVANIZED MATERIAL SHALL BE FORMED FROM STEEL HAVING A MINIMUM G-60

- 2. PROVIDE ALL MISCELLANEOUS WOOD FRAMING AND/OR BRACING AS REQUIRED FOR SUPPORT OF MECHANICAL, ELECTRICAL, PLUMBING OR MISCELLANEOUS APPURTENANCES.
- 3. ALL WOOD SHALL BE MINIMUM OF GRADE NO. 2 OR BETTER UNLESS OTHERWISE
- 4. ALL ROOF SHEATHING SHALL BE INSTALLED WITH PANEL CLIPS.
- 5. PRE-MANUFACTURED WOOD ROOF TRUSSES SHALL BE PROVIDED AS SHOWN ON THE DRAWINGS TO MEET REQUIRED OPENINGS FOR MISCELLANEOUS EQUIPMENT. TRUSS MANUFACTURER SHALL SUBMIT DESIGN DRAWINGS AND CALCULATIONS THAT COMPLY WITH REQUIRED DESIGN LOADS FOR APPROVAL PRIOR TO CONSTRUCTION PLANS AND CALCULATIONS SHALL BE SIGNED AND SEALED BY LICENSED NEW JERSEY PROFESSIONAL ENGINEER.

DEMOLITION NOTES

- 1. REMOVE EXISTING CONSTRUCTION AS SHOWN ON PLANS. SEE SECTIONS AND DETAILS FOR EXTENT OF STRUCTURE TO BE REMOVED.
- 2. EXISTING STRUCTURAL STEEL FRAMING SHALL REMAIN UNLESS SPECIFICALLY NOTED ON PLAN TO BE REMOVED.
- 3. CONCRETE ENCASEMENT AROUND REMAINING STEEL WILL REMAIN, UNLESS NOTED OTHERWISE.
- 4. IF FIELD CONDITIONS DIFFER FROM THOSE SHOWN ON DRAWINGS. NOTIFY ENGINEER BEFORE PROCEEDING WITH DEMOLITION.

EXISTING CONSTRUCTION

1. ALL DIMENSIONS AND ELEVATIONS OF EXISTING STRUCTURES SHOWN ON THE DRAWINGS ARE OBTAINED FROM AVAILABLE SOURCES AND ARE NOT GUARANTEED TO BE TRUE AND EXACT. THE CONTRACTOR SHALL VERIFY THESE DIMENSIONS AND ELEVATIONS BY ACTUAL FIELD MEASUREMENTS PRIOR TO FABRICATION OF ANY MATERIALS AND START OF WORK AND IMMEDIATELY REPORT ANY DISCREPANCIES TO THE ENGINEER.

- 1. CONTRACTOR SHALL VERIFY CONDITIONS IN THE FIELD AND IMMEDIATELY NOTIFY ENGINEER OF ANY CONDITIONS NOT AS ASSUMED; HE SHALL TAKE FIELD MEASUREMENTS AS REQUIRED AND BE RESPONSIBLE FOR SAME.
- 2. CONTRACTOR SHALL COORDINATE WITH ALL RELATED TRADES FOR DETAILING, FABRICATION, AND ERECTION PRIOR TO SUBMITTING SHOP DRAWINGS FOR APPROVAL.
- 3. ALL STRUCTURAL WORK SHALL BE COORDINATED WITH ARCHITECTURAL, MECHANICAL, ELECTRICAL, PLUMBING, ETC. REQUIREMENTS. DISCREPANCIES AND/OR INTERFERENCE SHALL BE REPORTED TO THE ENGINEER IMMEDIATELY.
- 4. GENERAL CONTRACTOR TO PROVIDE APPROPRIATE NUMBER OF COPIES OF ONE COMPLETE COORDINATED DRAWING SHOWING ALL SLEEVES, CONDUIT BOXOUT, DUCT OPENINGS, ETC. AS REQUIRED FOR ALL TRADES FOR ENGINEER'S APPROVAL. THIS SHALL BE DONE A MINIMUM OF TWO WEEKS PRIOR TO POURING AFFECTED SLABS, COLUMNS, OR FOOTINGS.
- 5. NO OPENINGS SHALL BE MADE IN ANY STRUCTURAL MEMBER UNLESS SPECIFICALLY SHOWN ON THE STRUCTURAL DRAWINGS OR OTHER APPROVAL FROM THE ENGINEER.
- 6. SUPPORT DETAILS FOR ARCHITECTURAL, MECHANICAL, ELECTRICAL, AND PLUMBING EQUIPMENT IS BASED UPON AVAILABLE INFORMATION OF MANUFACTURER. CONTRACTOR SHALL COORDINATE REQUIREMENTS OF ACTUAL EQUIPMENT AND SHALL PROVIDE ANY ADDITIONAL REQUIRED FRAMING.

ABBREVIATIONS		
E.F.	EACH FACE	
WF1	WALL FOOTING	
CMU	CONCRETE MASONRY UNIT	
V.I.F.	VERIFY IN THE FIELD	
O.C.	ON CENTER	
E.W.	EACH WAY	
T&B	TOP & BOTTOM	
AL	ALUMINUM	
CS	CARBON STEEL	
SS	STAINLESS STEEL	
CL	CENTER LINE	
GALV.	GALVANIZED	
T.O.M.	TOP OF MASONRY	


STRUC	STRUCTURAL DRAWING LIST					
DRAWING #	DRAWING TITLE					
S-100	STRUCTURAL COVER SHEET					
S-101	FOUNDATION PLAN					
S-102	TOP OF SLAB PLAN					
S-103	LINTEL PLAN					
S-104	ROOF FRAMING PLAN					
S-201	STRUCTURAL COVER SHEET					



NJ PROFESSIONAL ENGINEER LIC. No. 34559

VERNICK ENGINEERS AND AFFILIATES FROM ALL CLAIMS RESULTING THEREFROM



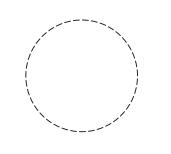

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JOHN BURGDORFER, RA, NCARB

ROBERT E. McNAMARA, AIA NJ License No. Al 997600

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SHEET CONTENTS:


STRUCTURAL **COVER SHEET**

PROJECT TITLE:

RENOVATION FOR MAINTENANCE BUILDING **BURLINGTON COUNTY** 10 HARTFORD ROAD, DELRAN TWP. BURLINGTON CO. NJ

SUBMIS	SSION:					
XXX						
DATE	REVIS	SIONS	BY	CHKD		
Date		04.09.24				
Scale						
Drawn by		J.G.				
Checked	d by					
Job No.		2241869				

Drawing No.

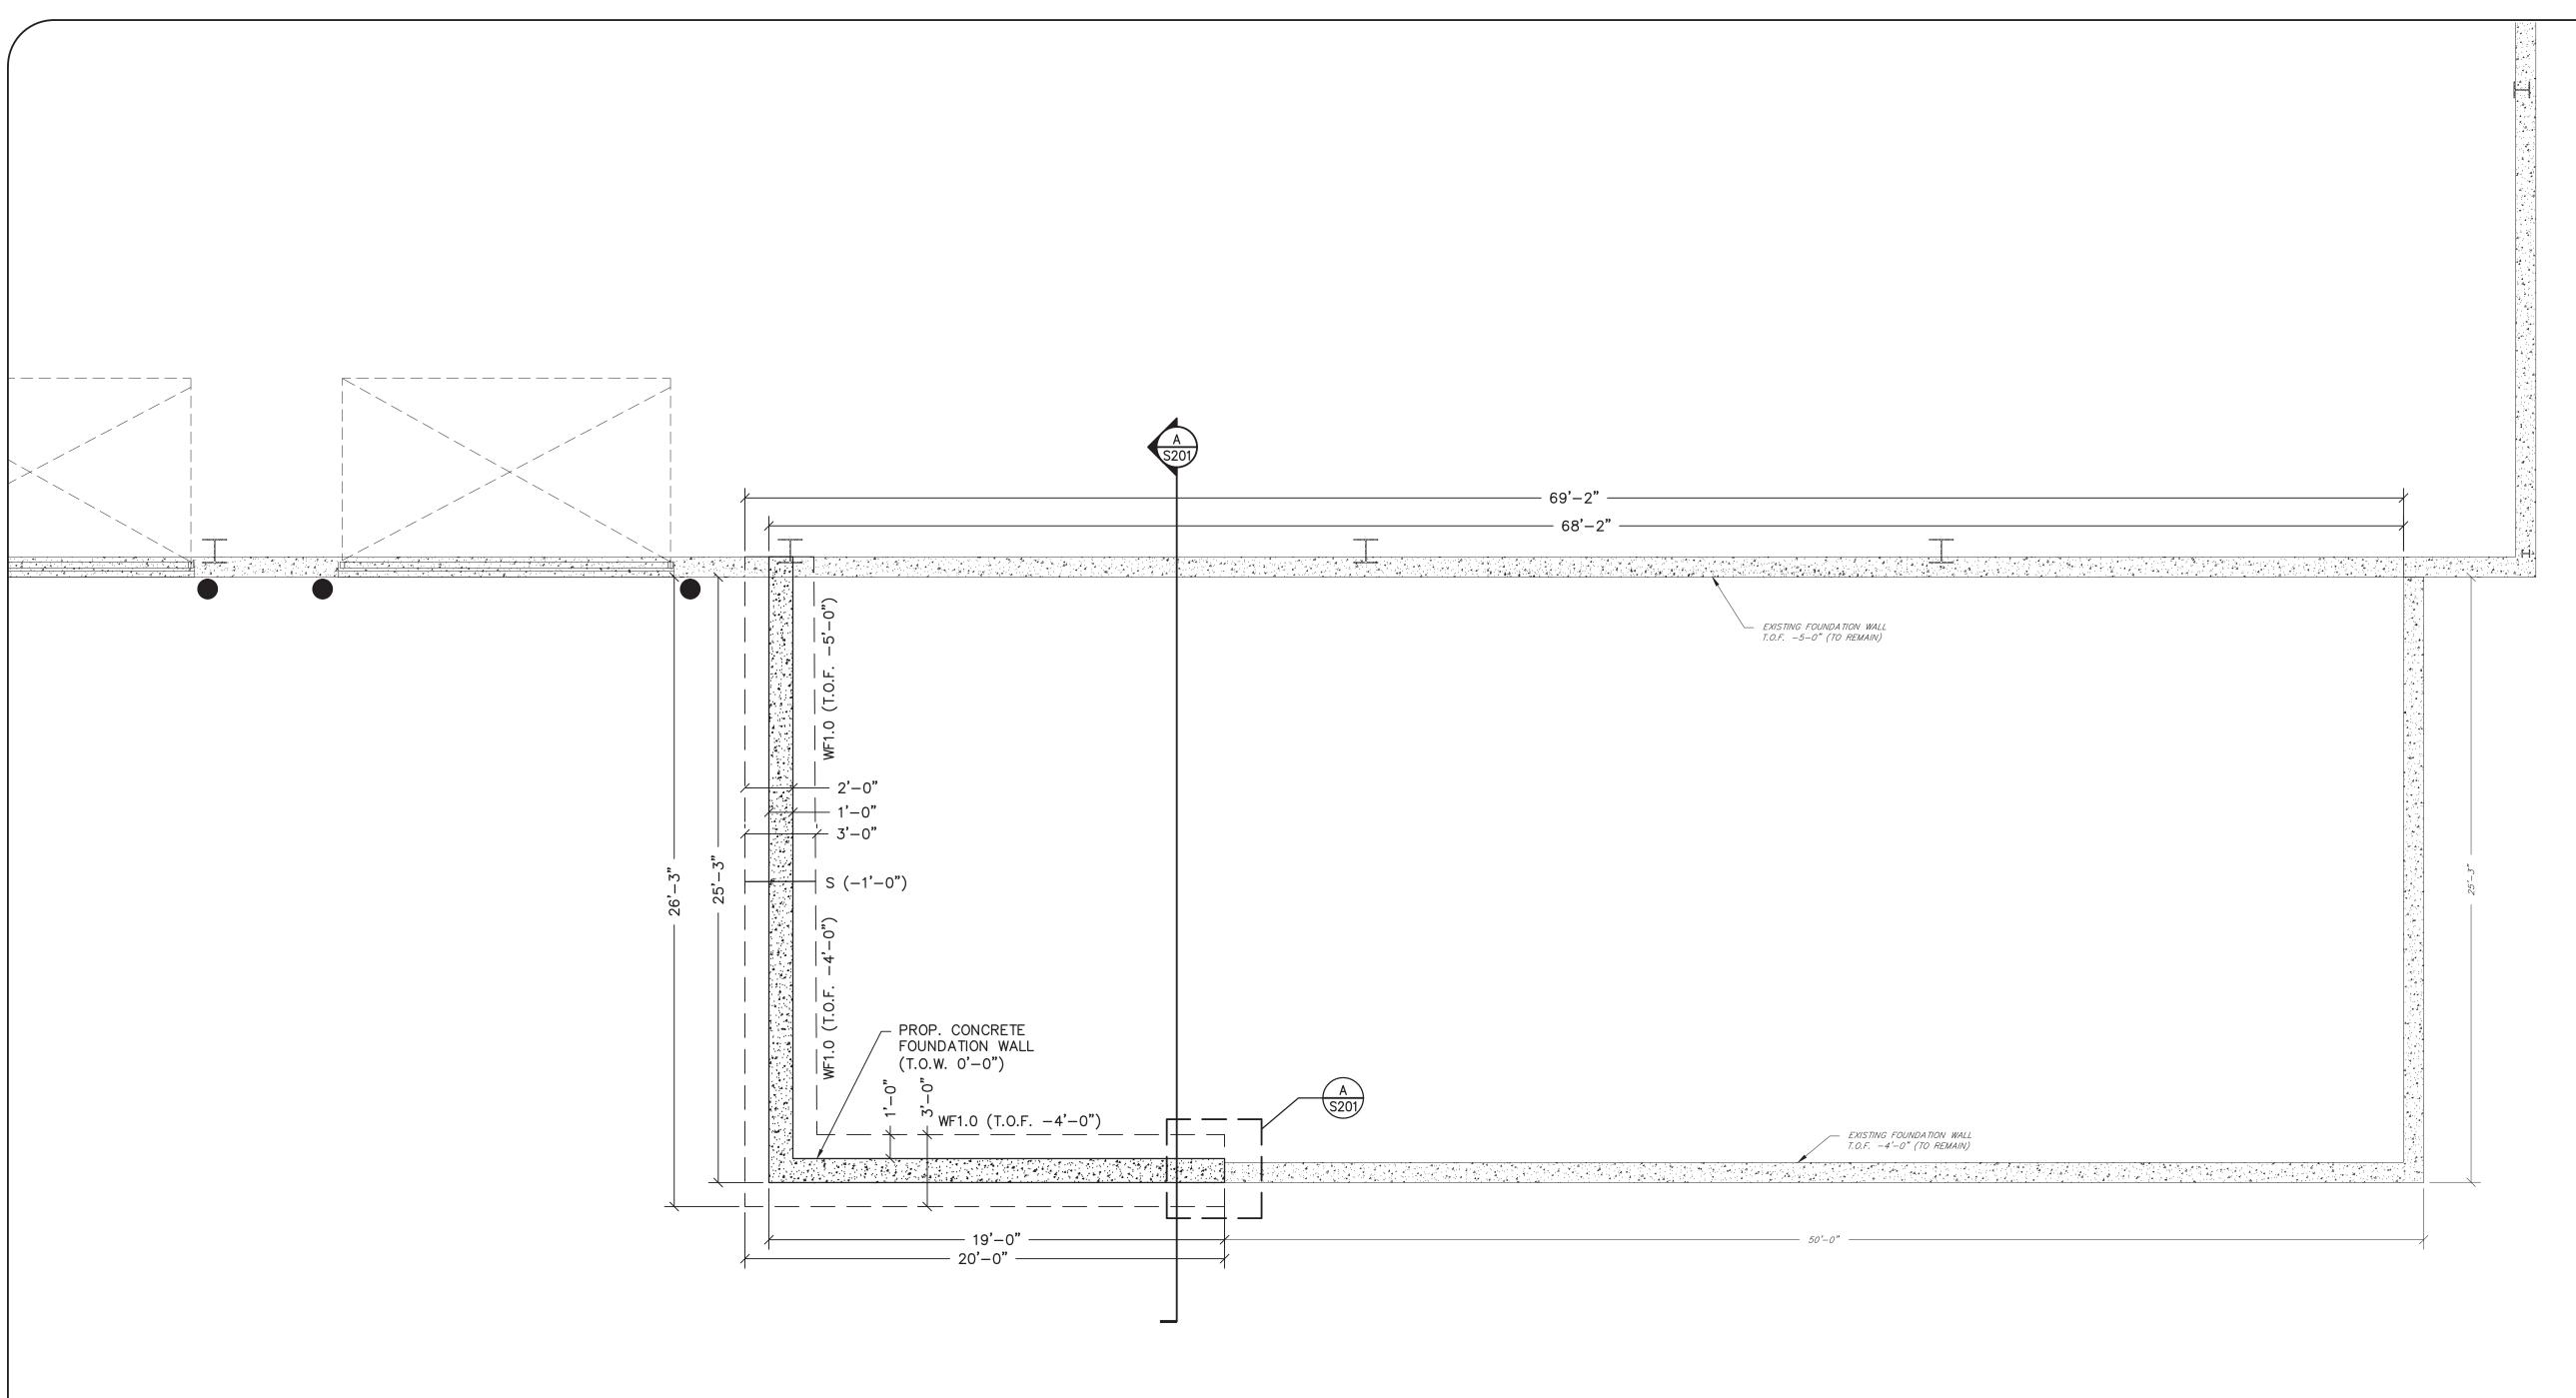




(____) INDICATES T/FTG. EL. SUBTRACTED FROM F.F., T/F.F. @ EL. 0'-0" (= XX.XX ON CIVIL DRAWINGS) SECTIONS SHOWN IN PLAN APPLY TO SIMILAR CONDITIONS THROUGHOUT THE BLDG.

ALL EXISTING FOOTING ELEVATIONS TAKEN FROM TEST PIT ANALYSIS AND MEMORANDUM DATED 6-11-2024. CONTRACTOR SHALL VERIFY IN FIELD AT CONNECTION

WALL FOOTING SCHEDULE


WF1.0 $3'-0"W \times 1'-0"$ THICK W/#5@12" O.C., T&B, & #5@12" O.C. T&B CONTINUOUS

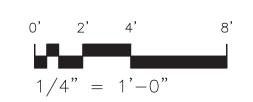




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DATE: 03-12-2025 KENNETH C. RESSLER NJ PROFESSIONAL ENGINEER LIC. No. 34559



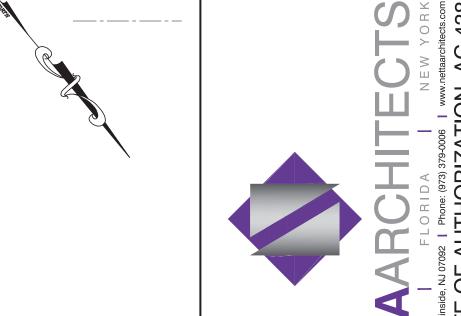
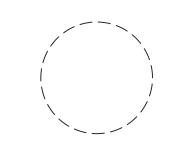
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SHEET CONTENTS:

FOUNDATION PLAN

PROJECT TITLE:


SUBMISSION:

RENOVATION FOR MAINTENANCE BUILDING **BURLINGTON COUNTY** 10 HARTFORD ROAD, DELRAN TWP. BURLINGTON CO. NJ


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SHEET CONTENTS:

TOP OF SLAB PLAN

PROJECT TITLE:

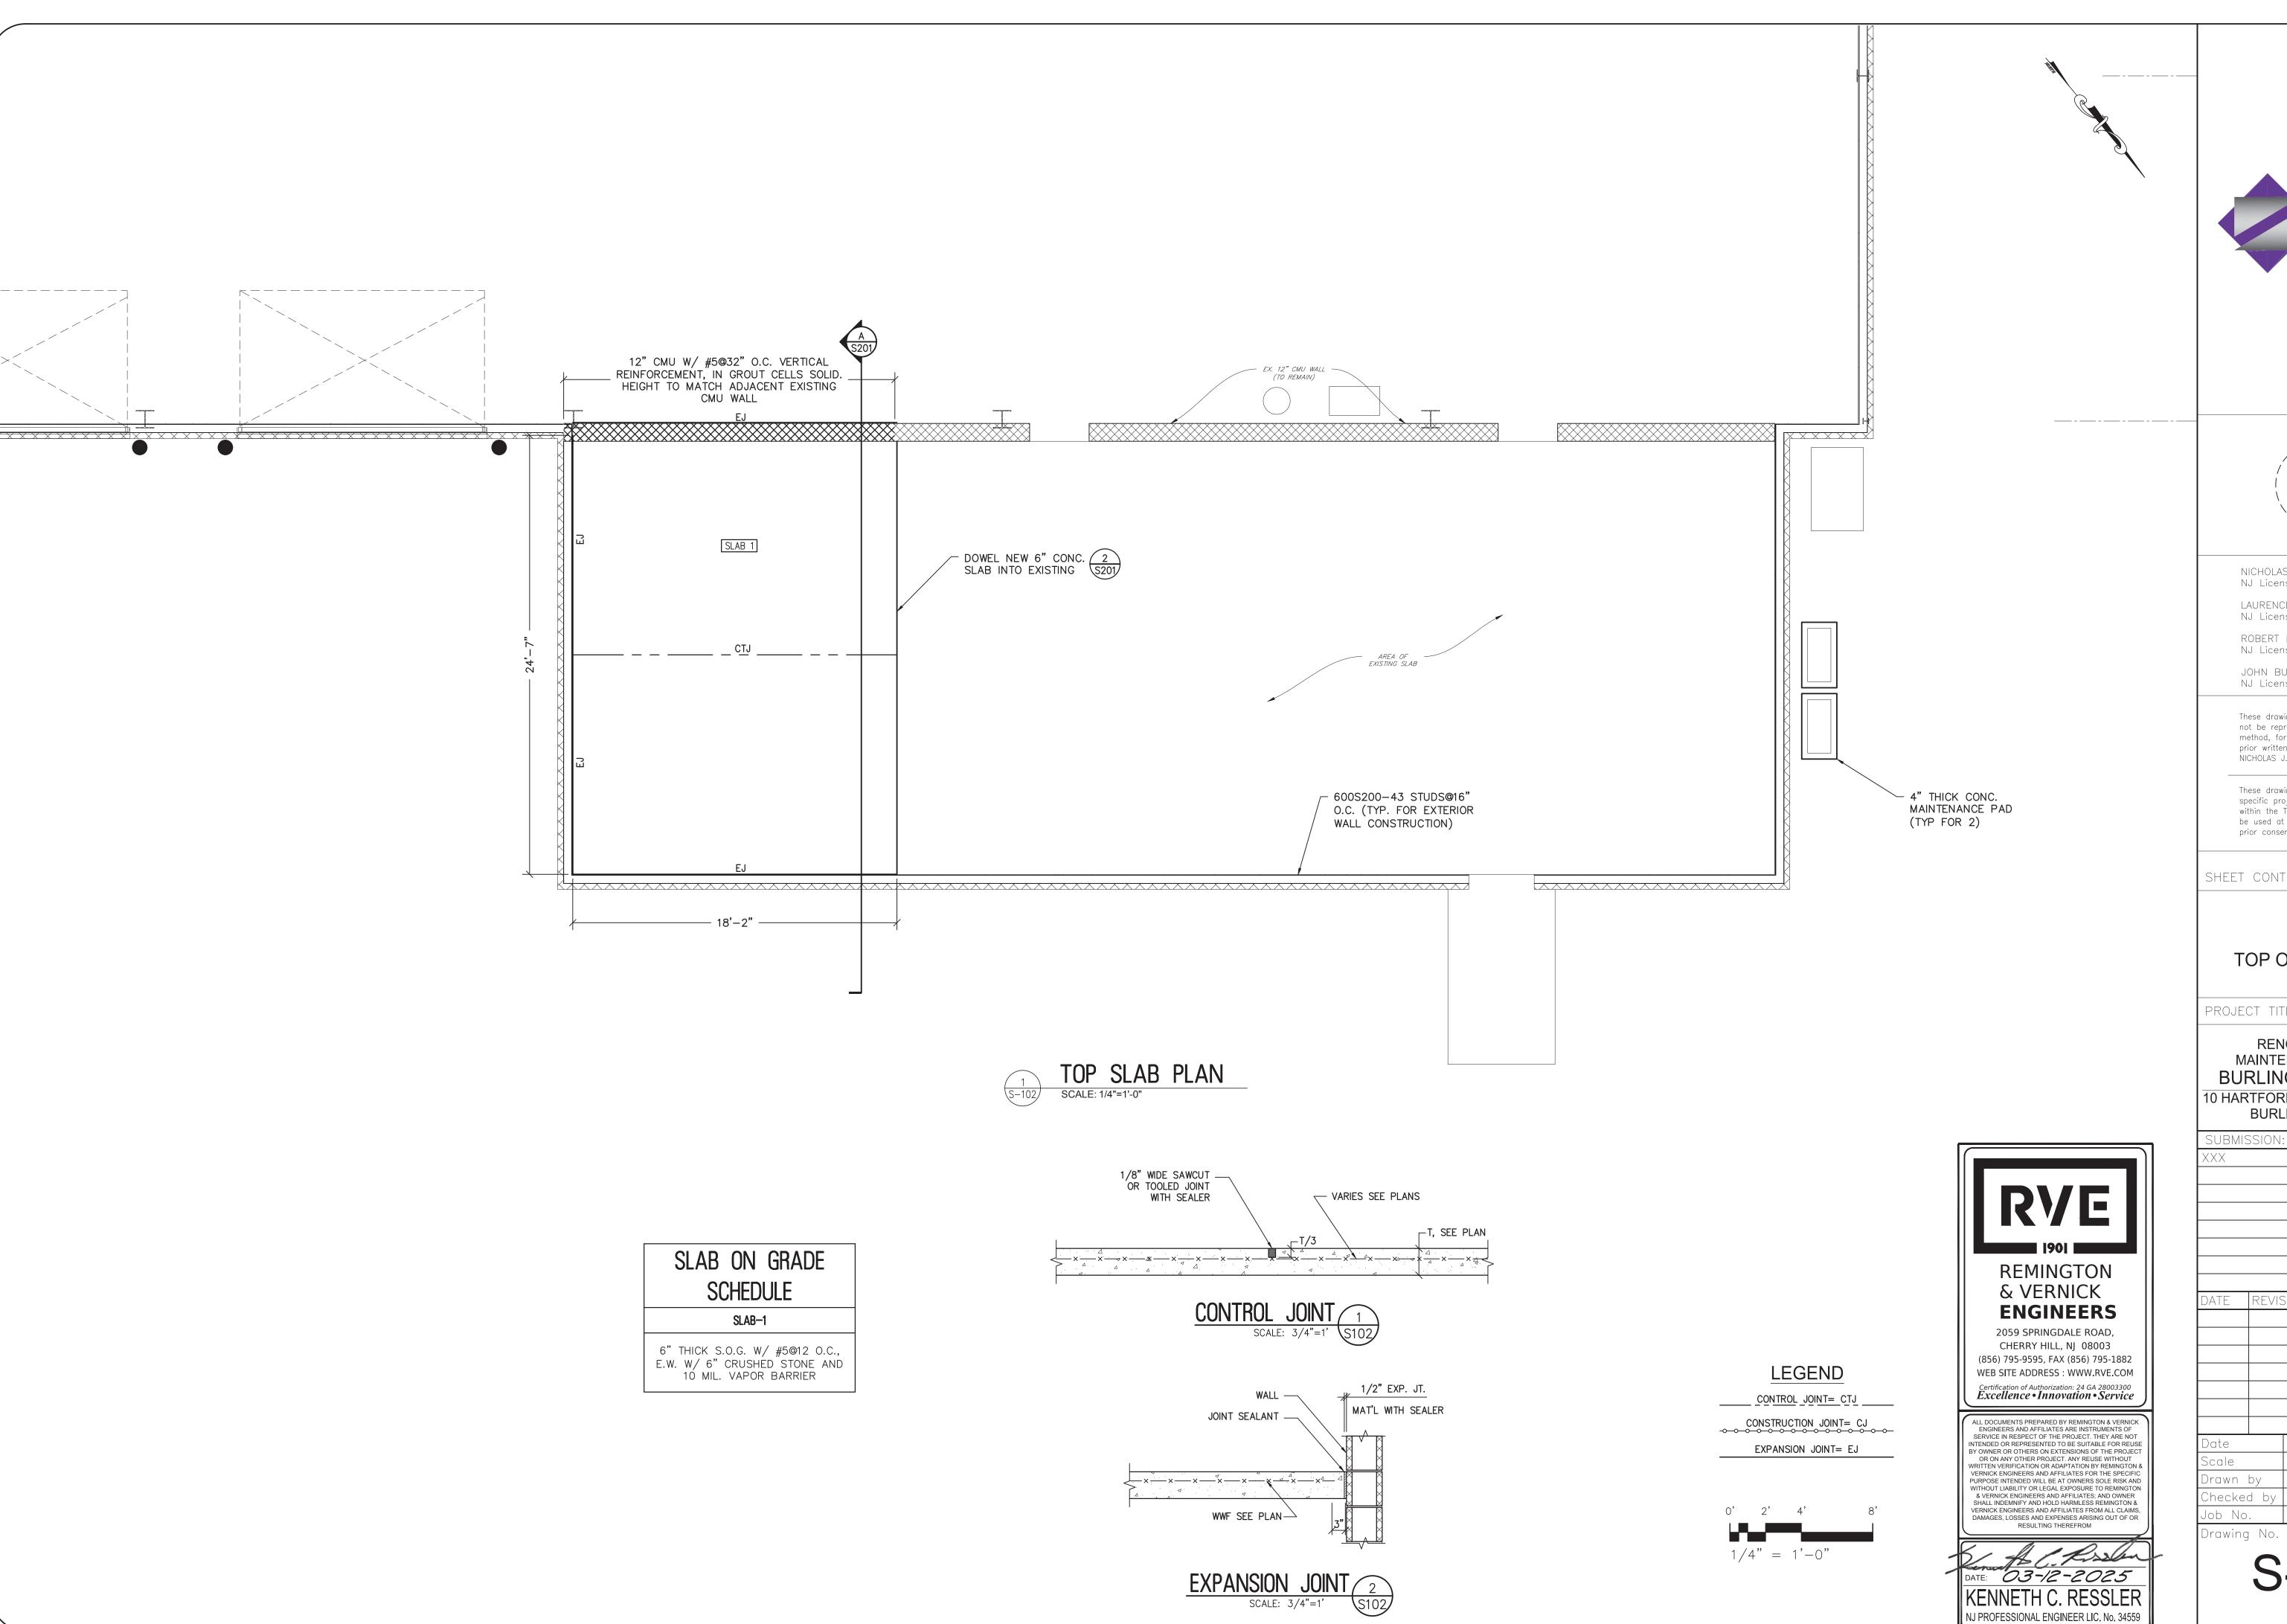
RENOVATION FOR MAINTENANCE BUILDING **BURLINGTON COUNTY** 10 HARTFORD ROAD, DELRAN TWP. BURLINGTON CO. NJ


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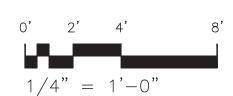
Drawing No.

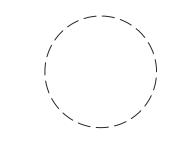S-102

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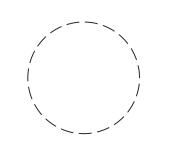


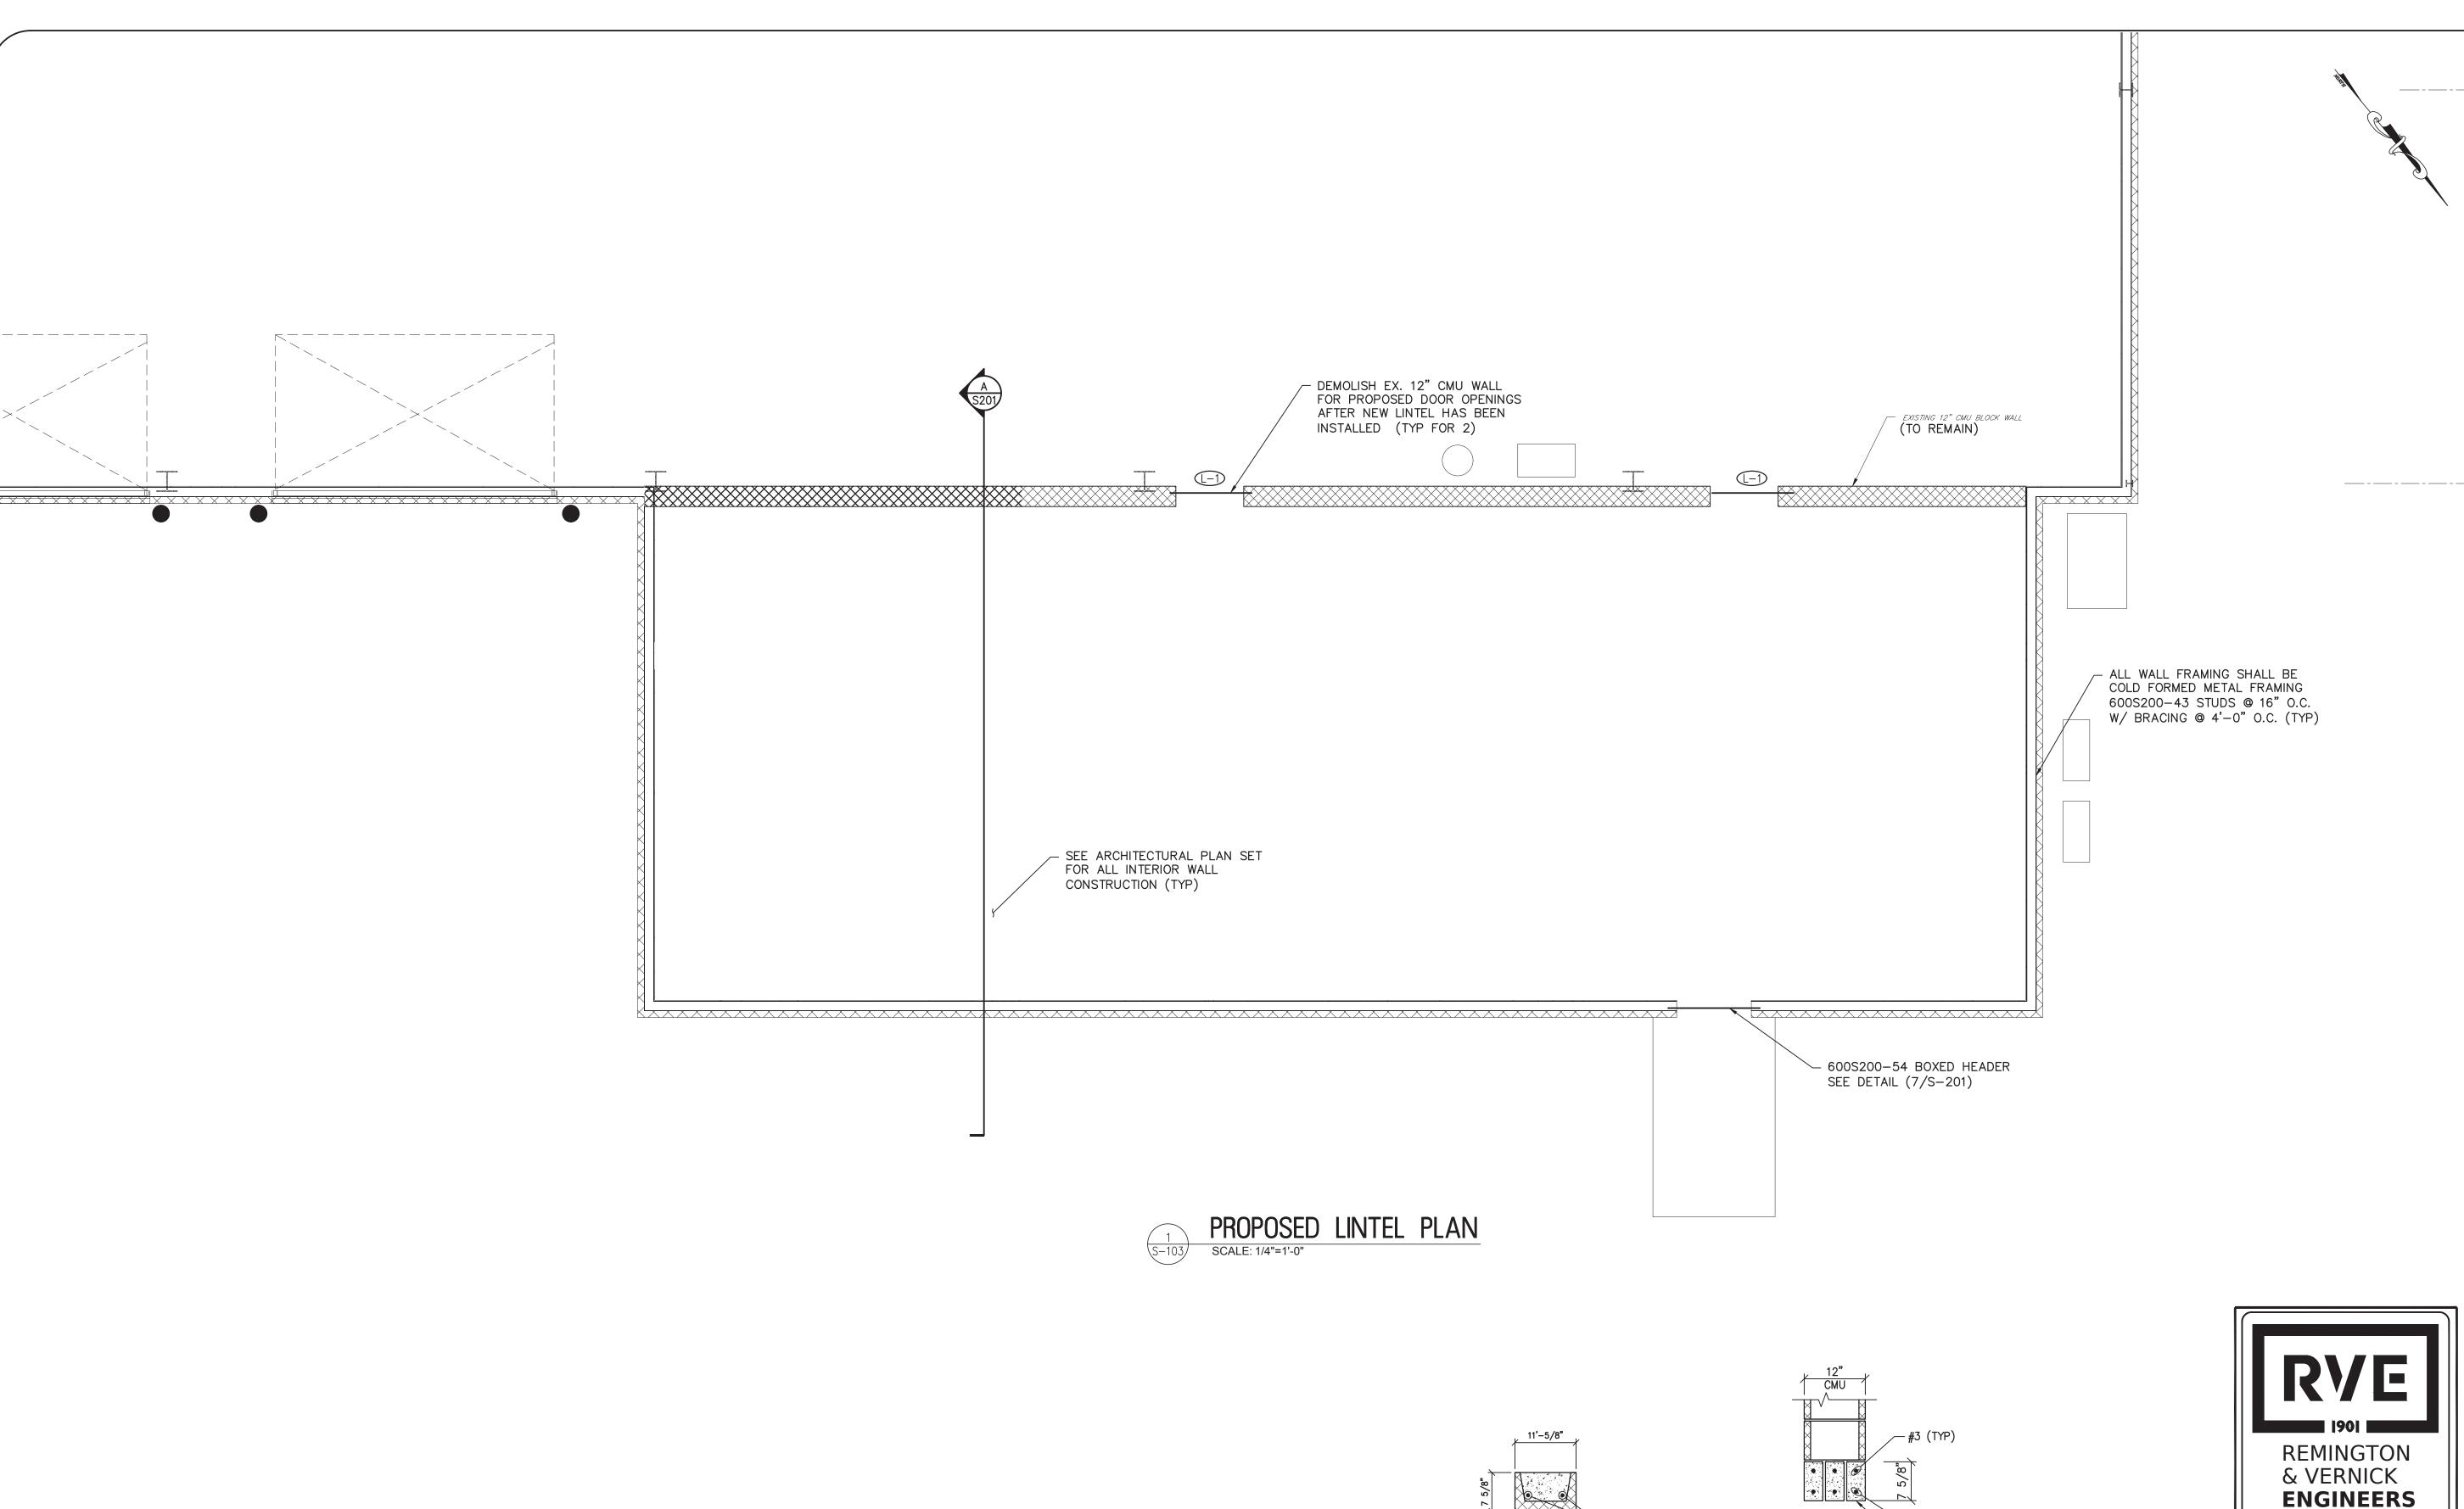

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SHEET CONTENTS:

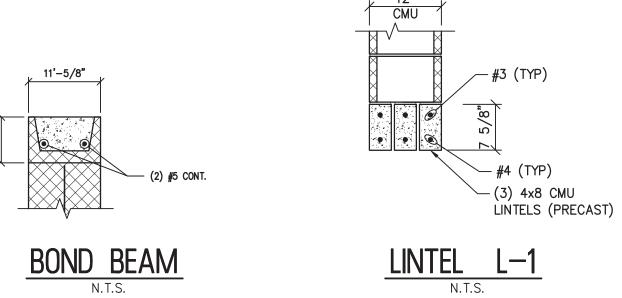LINTEL FLOOR PLAN


PROJECT TITLE:

SUBMISSION:


RENOVATION FOR MAINTENANCE BUILDING **BURLINGTON COUNTY** 10 HARTFORD ROAD, DELRAN TWP. BURLINGTON CO. NJ

DATE RE	-VIS	SIONS	BY	CHKD	
Date		04.09.24			
Scale					
Drawn by		J.G.			
Checked by					
Job No.		2241869			
Drawing N	10.				


S-103

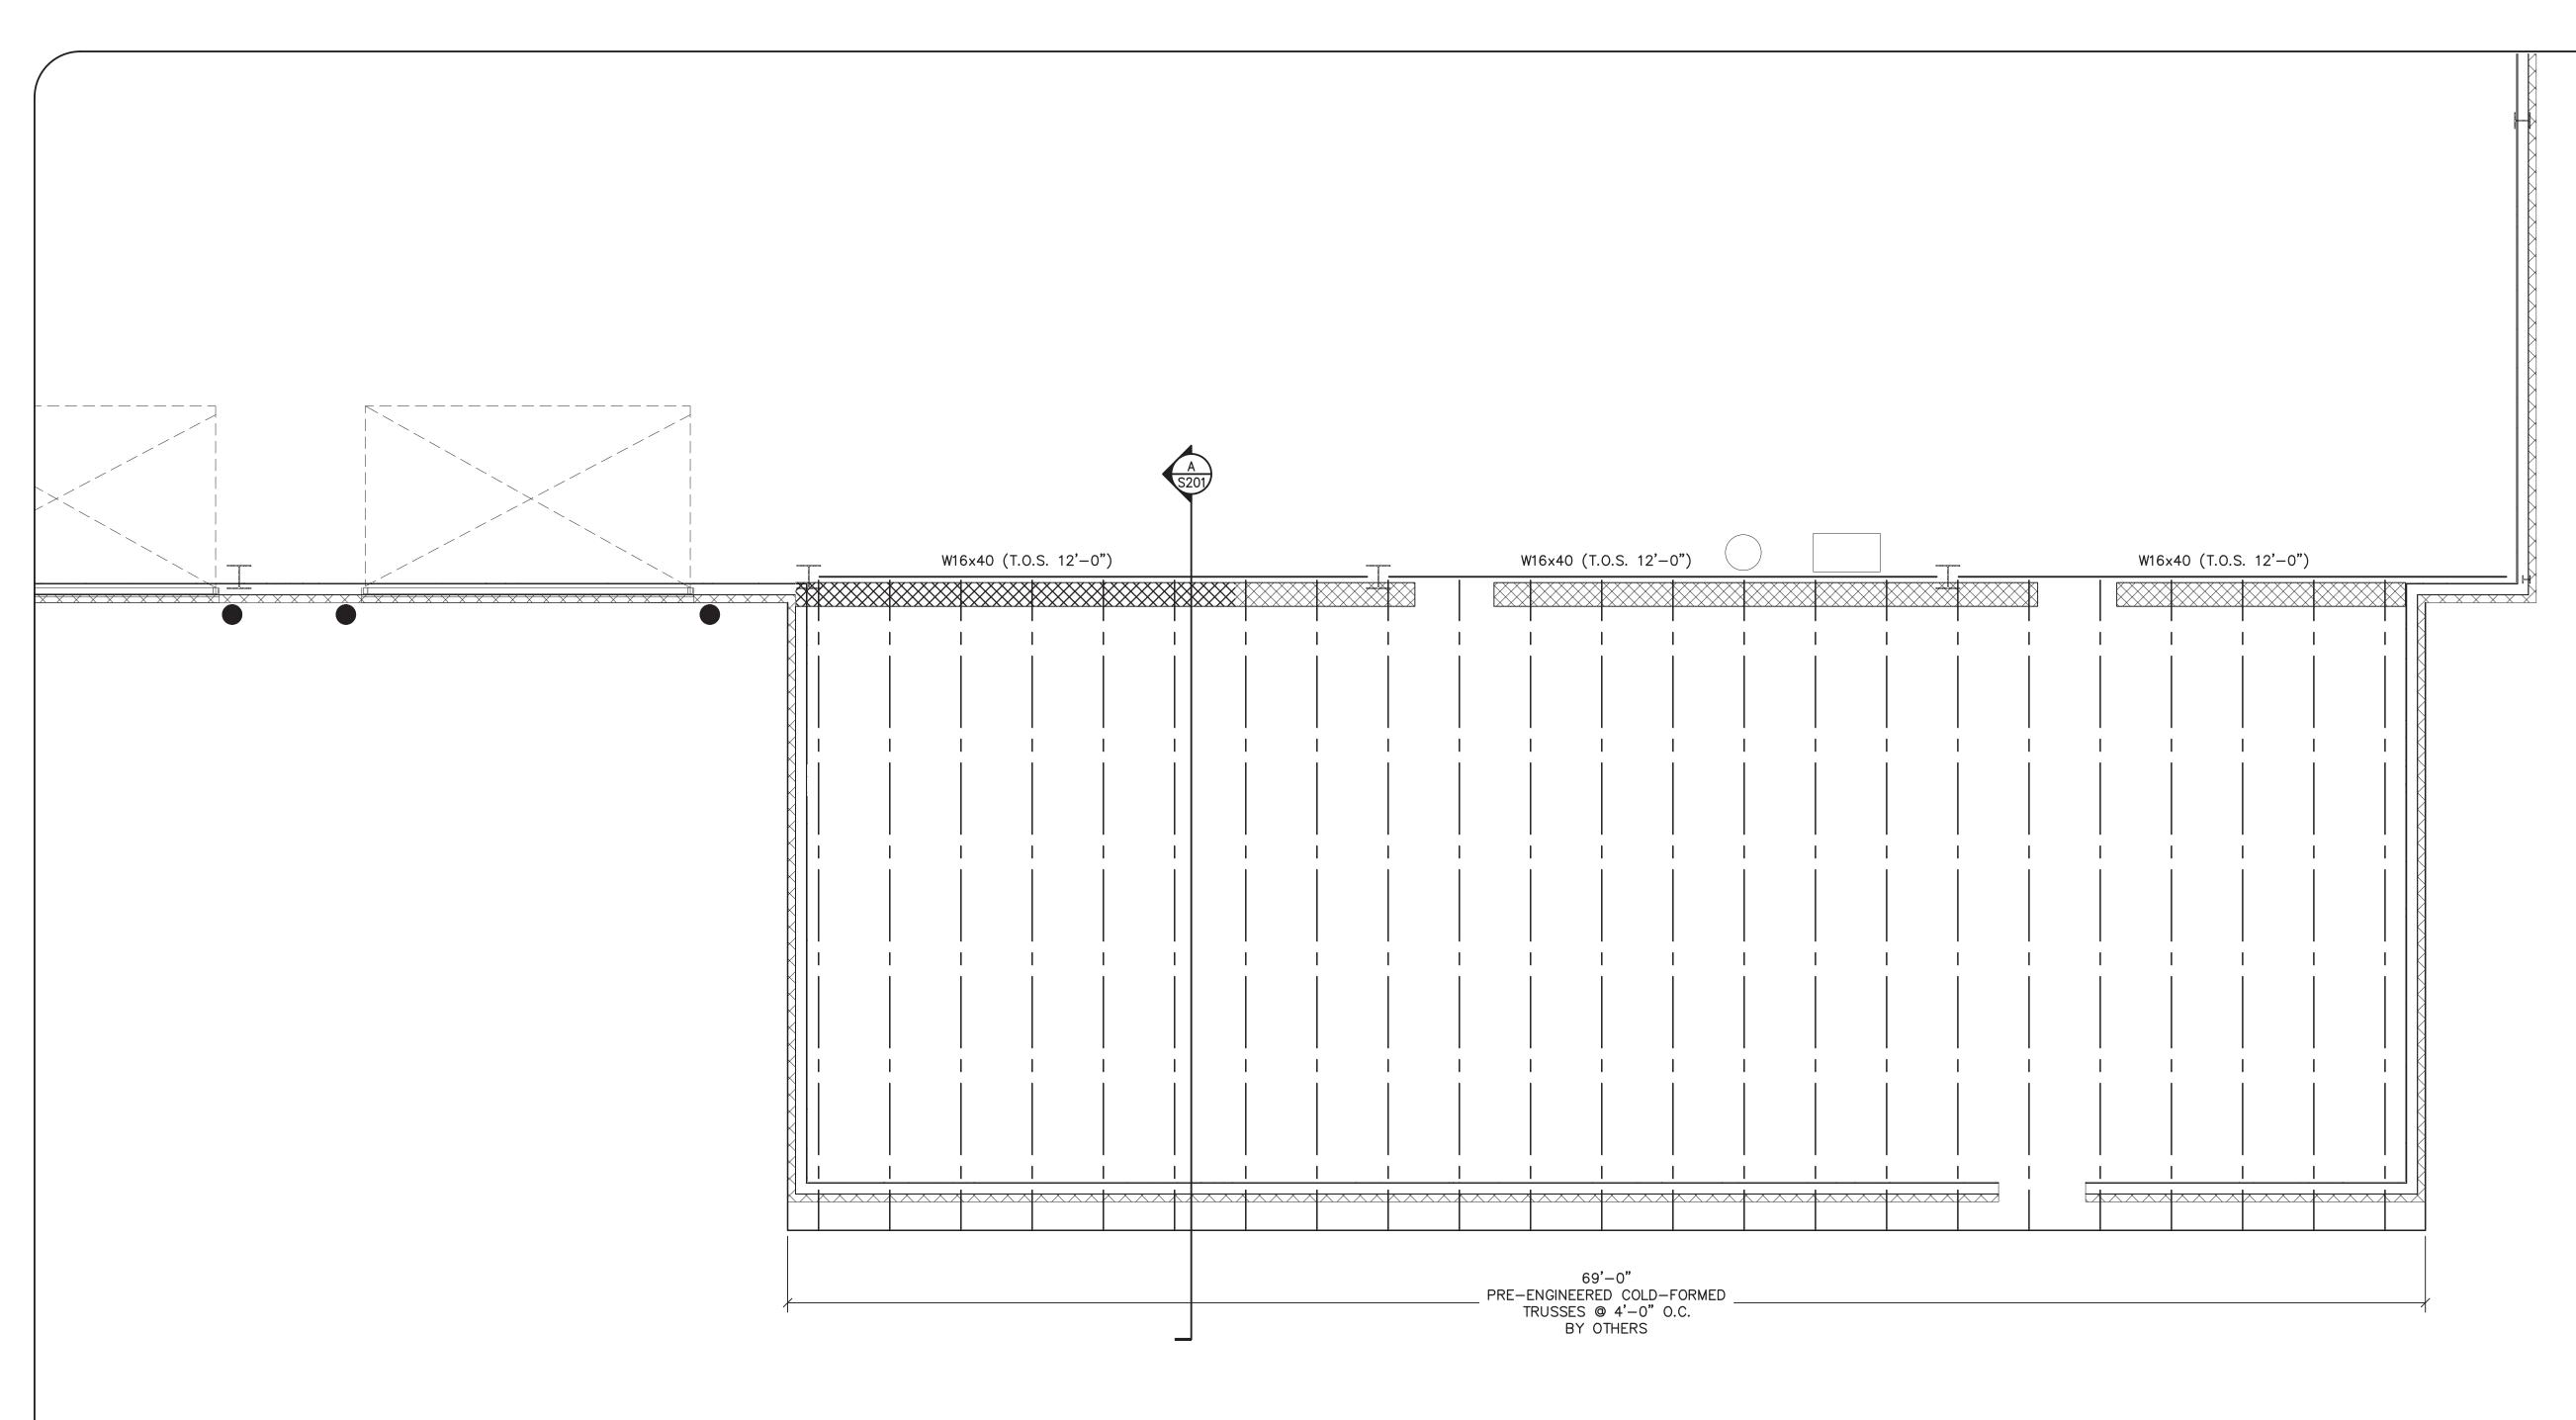


ROOF FRAMING PLAN
SCALE: 1/4"=1'-0"

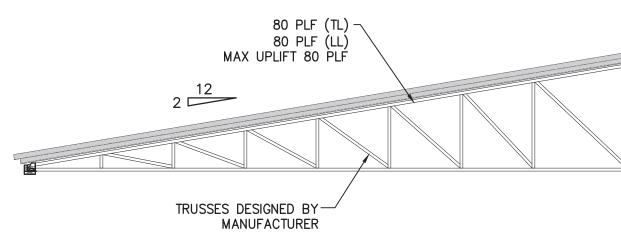

TRUSS LOADING DIAGRAM

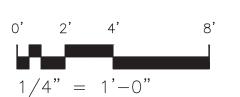

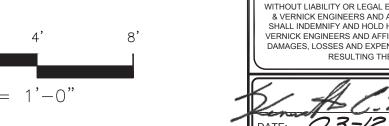

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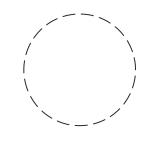
REMINGTON

ENGINEERS

2059 SPRINGDALE ROAD, CHERRY HILL, NJ 08003 (856) 795-9595, FAX (856) 795-1882 WEB SITE ADDRESS: WWW.RVE.COM Certification of Authorization: 24 GA 28003300 Excellence • Innovation • Service

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ROOF FRAMING PLAN


PROJECT TITLE:

RENOVATION FOR MAINTENANCE BUILDING **BURLINGTON COUNTY** 10 HARTFORD ROAD, DELRAN TWP. BURLINGTON CO. NJ

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Drawing No.




GENERAL NOTES

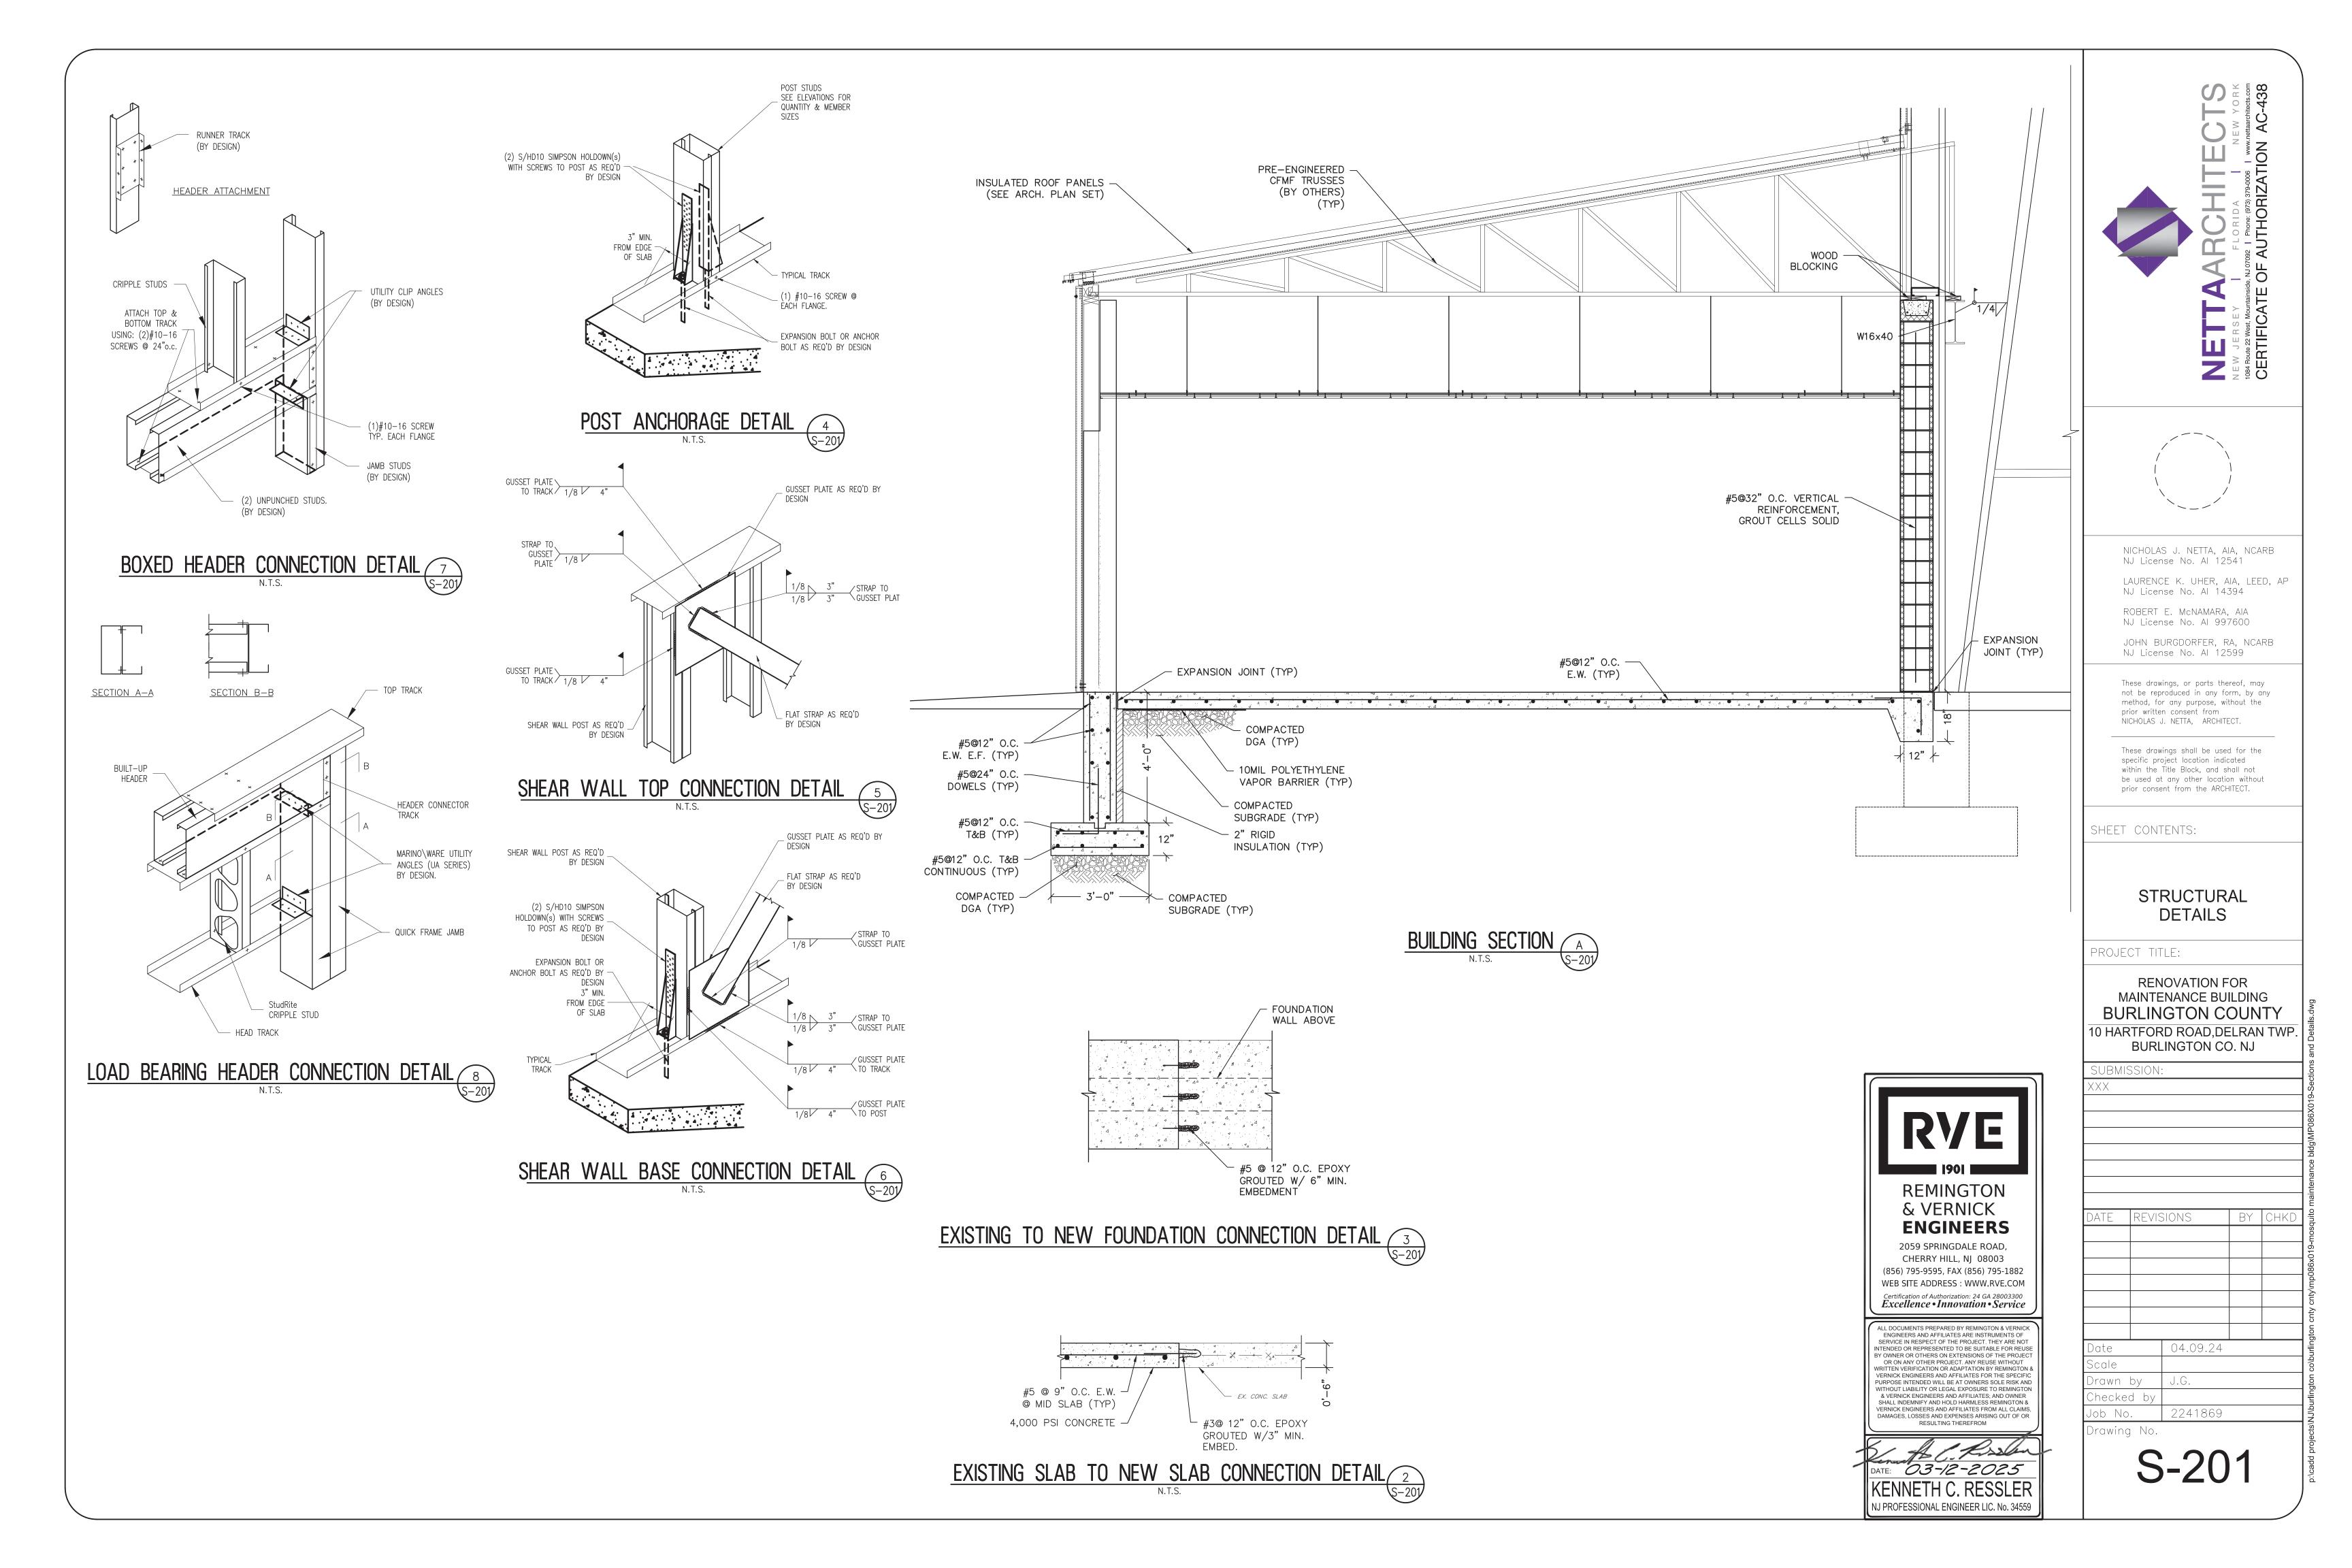
- (ALL GENERAL NOTES, SYMBOLS & ABBREVIATIONS MAY NOT BE USED ON THIS PROJECT)
- 1. EXAMINE JOB SITE AND VERIFY ALL SITE CONDITIONS PRIOR TO SIGNING CONTRACT. BRING ANY DISCREPANCY BETWEEN THE CONTRACT DOCUMENTS AND THE ACTUAL FIELD CONDITIONS TO THE ATTENTION OF THE ARCHITECT/ENGINEER.
- 2. THE LOCATION OF EXISTING UTILITIES IS SHOWN IN AN APPROXIMATE WAY ONLY. THE CONTRACTOR SHALL DETERMINE THE EXACT LOCATION OF ALL EXISTING UTILITIES BEFORE COMMENCING WORK. THE CONTRACTOR SHALL PAY FOR AND REPAIR ALL DAMAGES CAUSED BY FAILURE TO EXACTLY LOCATE AND PRESERVE ANY AND ALL UTILITIES UNLESS OTHERWISE INDICATED.
- . THE DRAWINGS ARE DIAGRAMMATIC. COORDINATE IN THE FIELD, WITH THE ARCHITECT AND WITH ALL TRADES, THE EXACT LOCATION OF EQUIPMENT, FIXTURES, VALVES, THERMOSTATS, ETC. AND ROUTING OF PIPING, DUCTWORK, CONDUIT,
- 4. PERFORM WORK IN ACCORDANCE WITH RULES, REGULATIONS, STANDARDS, CODES, ORDINANCES, AND LAWS OF LOCAL, STATE AND FEDERAL GOVERNMENTS AND OTHER AUTHORITIES HAVING JURISDICTION AND BE RESPONSIBLE FOR
- COMPLIANCE THEREWITH 5. OBTAIN ALL NECESSARY APPROVALS, PERMITS AND INSPECTIONS. PAY ALL ASSOCIATED FEES.
- 6. GUARANTEE ALL SYSTEMS AND WORK FOR A PERIOD OF ONE (1) YEAR FROM DATE OF FINAL ACCEPTANCE. GUARANTEE REFRIGERATION COMPRESSORS FOR FIVE (5) YEARS.
- . BEFORE STARTING FABRICATION/ WORK SUBMIT TO ARCHITECT/ENGINEER FOR APPROVAL SIX (6) COMPLETE SETS OF SHOP DRAWINGS AND PRODUCT DATA FROM MANUFACTURERS, SUPPLIERS, ETC.
- 8. ALL MATERIALS SHALL BE NEW AND OF COMMERCIAL GRADE AND BEAR THE UNDERWRITER'S LABEL WHERE APPLICABLE.
- 9. LOCATE ALL EXISTING UTILITIES AND MAKE SERVICEABLE CONNECTIONS TO SAME.
- 10. OBTAIN APPROVAL FROM THE BUILDING OWNER'S REPRESENTATIVE PRIOR TO ANY INTERRUPTION OF BUILDING SYSTEMS. COORDINATE ACCEPTABLE WORKING HOURS WITH SAME. 11. REMOVE ALL ABANDONED EQUIPMENT, FIXTURES, DUCTWORK, PIPING, CONDUIT, ETC. CAP ALL PIPING ABANDONED IN
- 12. ALL CUTTING AND PATCHING IS BY RESPECTIVE CONTRACTORS. CORE DRILL OR SAW CUT ALL MASONRY AND RESTORE
- ALL SURFACES TO ORIGINAL CONDITION. PAINTING AND FINISHING ARE BY THE GENERAL CONTRACTOR.
- 13. PIPING AND SPECIALTIES a. ALL PIPING SHALL CONFORM TO THE REQUIREMENTS OF THE ANSI SAFETY CODE AND BE FREE FROM ALL DEFECTS.
- b. PROVIDE SLEEVES FOR PIPING THROUGH MASONRY. FIRE RATED WALLS AND SMOKE PARTITIONS. SLEEVES SHALL BE 22 GAUGE OR HEAVIER STEEL. SCHEDULE 40 IN BEARING WALLS. SIZE SLEEVES TO ACCOMMODATE PIPE INSULATION WHERE APPLICABLE. PROVIDE UL LISTINGS FOR SLEEVE PACKING.
- c. PROVIDE PIPE HANGERS TO SUPPORT PIPING FROM BUILDING STRUCTURE TO MAINTAIN REQUIRED SLOPE, PROVIDE FOR EXPANSION AND CONTRACTION, ISOLATE VIBRATION AND RELIEVE EQUIPMENT AND SPECIALTIES FROM STRAIN. SPACE HANGERS ACCORDING TO APPLICABLE CODES AND MANUFACTURER'S RECOMMENDATIONS. d. IDENTIFY ALL PIPING WITH SEMIRIGID OR ADHESIVE PLASTIC INDICATION MARKERS, EXCEPT WITHIN INACCESSIBLE
- CHASES. MARKERS SHALL SHOW DIRECTION OF FLOW. MARKERS SHALL BE LOCATED NEXT TO EACH VALVE, AT EACH BRANCH, ON BOTH SIDES OF PIPE PASSAGE THROUGH WALLS AND ON ALL HORIZONTAL PIPING AT 20' MAXIMUM INTERVALS.
- e. ROUTE ALL PIPING CONCEALED IN WALLS, ABOVE CEILING AND BELOW FLOOR UNLESS OTHERWISE NOTED. RUN PARALLEL WITH BUILDING LINES.
- f. PROVIDE DRAIN VALVES & PLUGS AT ALL LOW POINTS SUCH THAT PIPING SYSTEMS CAN BE DRAINED. PROVIDE MANUAL AIR VENT VALVES AT ALL HIGH POINTS IN THE SYSTEM.
- g. PROVIDE BACKFLOW PREVENTION DEVICES AT ALL EQUIPMENT AS REQUIRED BY CODE. UNLESS STATED OTHERWISE PROVIDE CHECK VALVE AND SHUT-OFF VALVE BOTH RATED FOR 250°F DOWN STREAM OF BACKFLOW PREVENTER ON MAKE UP WATER LINE FOR HYDRONIC HEATING HOT WATER SYSTEMS.
- h. PROVIDE DIELECTRIC UNIONS AT ALL JUNCTIONS OF DISSIMILAR METALS.
- i. ALL SHUTOFF VALVES, CONTROL VALVES, ETC. ARE FULL LINE SIZE UNLESS OTHERWISE NOTED.
- j. INSTALL PIPING ON WARM SIDE OF BUILDING INSULATION. DO NOT INSTALL PIPING WHERE SUBJECT TO FREEZING. k. ALL PIPING INSULATION SHALL BE CONTINUOUS THROUGH WALLS AND CEILING OPENINGS, SLEEVES AND PIPE
- I. TEST ALL PIPING IN ACCORDANCE WITH APPLICABLE CODES, STANDARDS, AND INSPECTOR'S REQUIREMENTS PRIOR
- TO INSULATION OR ENCLOSING. m. BALANCE ALL HYDRONIC DEVICES FOR FLOW RATES NOTED ON DRAWINGS. PROVIDE BALANCING REPORT TO
- ARCHITECT/ENGINEER. n. UNLESS STATED OTHERWISE IN THE CONTRACT SPECIFICATIONS, PROVIDE A MINIMUM OF ONE (1) ONE AND A HALF (1-1/2") INCH THICK LAYER OF PREFORMED MINERAL FIBER PIPE INSULATION WITH PREFORMED MINERAL FIBER FITTINGS ON ALL
- DOMESTIC HOT AND COLD WATER PIPING, HYDRONIC HEATING AND CHILLED WATER SUPPLY AND RETURN PIPING, REFRIGERANT PIPING AND CONDENSATE DRAIN PIPING. INCLUDE A FIELD APPLIED FOIL AND PVC JACKET WITH VAPOR RETARDER AS PART OF THE INSULATION ASSEMBLY.
- O. UNLESS STATED OTHERWISE ALL UNDERGROUND PIPING SHALL BE INSTALLED WITH POLYETHYLENE ENCASEMENT (PE) FOR CORROSION RESISTANCE.
- p. UNLESS STATED OTHERWISE ALL FUEL GAS VENT PIPING TO BE SA-53GrB CARBON STEEL. ALL VENT PIPING TO BE PRIMED AND FINISH PAINTED IN A COLOR ACCEPTABLE TO THE OWNER.
- 14. DUCTWORK AND SPECIALTIES a. ALL DUCTWORK TO BE IN ACCORDANCE WITH S.M.A.C.N.A. "H.V.A.C. DUCT CONSTRUCTION STANDARDS", LATEST
- EDITION. PRESSURE CLASS "B".
- b. ALL DUCTWORK TO BE CONSTRUCTED OF GALVANIZED SHEETMETAL.
- c. PROVIDE 45 DEGREE COLLARS TO ALL BRANCH CONNECTIONS. PROVIDE TURNING VANES AT ALL ELBOWS 12"x6" OR LARGER. PROVIDE STANDARD RADIUS ELBOWS AT ALL ELBOWS SMALLER THAN 12"x6".
- d. PROVIDE ALL VOLUME DAMPERS REQUIRED TO BALANCE THE SYSTEMS, INSTALL VOLUME DAMPERS AT BRANCH
- TAKE-OFFS FROM TRUNK. e. PROVIDE CURTAIN TYPE FIRE DAMPERS WHEREVER DUCT PENETRATES FIRE RATED PARTITIONS. UNITS SHALL
- PROVIDE NOT LESS THAN 90% FREE AREA. PROVIDE ACCESS DOORS AT ALL FIRE DAMPERS.
- f. TEST DUCT SYSTEMS FOR AIR TIGHTNESS AND ABSENCE OF AUDIBLE LEAKS BEFORE ENCLOSURE. q. BALANCE ALL AIR DEVICES FOR AIR QUANTITIES NOTED ON DRAWINGS. PROVIDE BALANCING REPORT TO
- ARCHITECT/ENGINEER.
- h. FLEXIBLE DUCTS: ALL FLEXIBLE DUCTS SHALL BE IN COMPLIANCE WITH THE LATEST EDITION OF THE INTERNATIONAL MECHANICAL CODE.
- i. COORDINATE ALL EQUIPMENT CONNECTIONS WITH MANUFACTURER'S CERTIFIED DRAWINGS. COORDINATE AND PROVIDE ALL PIPING TRANSITIONS REQUIRED FOR FINAL EQUIPMENT CONNECTIONS TO FURNISHED EQUIPMENT. FIELD VERIFY AND COORDINATE ALL DUCT AND PIPING DIMENSIONS BEFORE FABRICATION.
- . PROVIDE FIRE DAMPERS IN THE DUCTWORK IN ACCORDANCE WITH ALL APPLICABLE CODES AND THE CONTRACT
- k. UNLESS STATED OTHERWISE IN THE CONTRACT SPECIFICATIONS, PROVIDE A MINIMUM OF ONE (1) TWO AND ONE HALF (2-1/2") INCH THICK LAYER OF MINERAL FIBER BLANKET INSULATION ON ALL NEW INDOOR ROUND AND RECTANGULAR SUPPLY AIR. EXHAUST AIR, RETURN AIR AND OUTDOOR AIR DUCTWORK. INCLUDE A FIELD APPLIED PAPER AND FOIL JACKET WITH VAPOR RETARDER AS PART OF THE INSULATION ASSEMBLY.
- I. UNLESS STATED OTHERWISE IN THE CONTRACT SPECIFICATIONS, PROVIDE A MINIMUM OF ONE (1) TWO (2") INCH THICK LAYER OF MINERAL FIBER BOARD INSULATION ON ALL NEW OUTDOOR ROUND AND RECTANGULAR SUPPLY AIR, EXHAUST AIR, RETURN AIR AND OUTDOOR AIR DUCTWORK. INCLUDE A WEATHERPROOF FIELD APPLIED 22 GAUGE ALUMINUM JACKET WITH VAPOR RETARDER AS PART OF THE INSULATION ASSEMBLY. COORDINATE FINISH COLOR OF EXTERIOR JACKET WITH THE OWNER.
- m. UNLESS OTHERWISE NOTED ALL EXPOSED SUPPLY, RETURN AND EXHAUST AIR DUCTWORK SHALL BE PRIMED AND PAINTED. COLOR TO BE DETERMINED BY THE ENGINEER / OWNER.
- 15. EQUIPMENT
- a. VERIFY ALL ELECTRICAL CHARACTERISTICS WITH ELECTRICAL CONTRACTOR BEFORE ORDERING EQUIPMENT.
- b. ALL MECHANICAL EQUIPMENT AND APPLIANCE INSTALLATIONS SHALL BE IN COMPLIANCE WITH THE LATEST EDITION OF THE INTERNATIONAL MECHANICAL CODE, AS WELL AS WITH MANUFACTURER'S RECOMMENDATIONS,
- c. ALL ELECTRICAL POWER WIRING IS BY ELECTRICAL CONTRACTOR. ALL CONTROL WIRING IS BY RESPECTIVE CONTRACTOR.
- d. PROVIDE OWNER WITH OPERATION AND MAINTENANCE MANUALS FOR INSTALLED EQUIPMENT. INCLUDE CONTRACTOR'S, SUPPLIER'S AND MANUFACTURER'S NAMES, ADDRESS AND TELEPHONE NUMBERS.
- e. SUPPLY STARTERS AND DISCONNECTS WITH EQUIPMENT.
- f. PROVIDE CONCRETE PADS FOR FLOOR MOUNTED EQUIPMENT. PADS SHALL BE A MINIMUM 4" HIGH AND SHALL EXTEND 6" BEYOND EQUIPMENT ON ALL SIDES.
- q. LABELING: ALL MECHANICAL EQUIPMENT AND APPLIANCES SHALL BEAR LABELING IN COMPLIANCE WITH THE LATEST VERSION OF THE INTERNATIONAL MECHANICAL CODE.
- h. UNLESS NOTED OTHERWISE. ALL HYDRONIC SYSTEMS BOILER/ CHILLED WATER SHALL BE PROVIDED WITH A NEW BLADDER TYPE EXPANSION TANK AS REQUIRED. TANK TO BE SIZED FOR EACH SYSTEM BASED UPON TANK MANUFACTURER'S RECOMMENDATIONS.
- i. UNLESS OTHERWISE NOTED CONTRACTOR IS RESPONSIBLE TO FURNISH AND INSTALL PROPYLENE GLYCOL ANTI FREEZE FOR ALL HYDRONIC HEATING AND COOLING SYSTEMS. THE CONTRACTOR SHALL SUPPLY A 35% CONCENTRATION OF PROPYLENE GLYCOL IN SOLUTION FOR CHILLED WATER COOLING SYSTEMS AND A 25% CONCENTRATION OF PROPYLENE GLYCOL IN SOLUTION FOR HOT WATER HEATING SYSTEMS. PROPYLENE GLYCOL ANTI FREEZE SHALL BE COMPATIBLE WITH ALL MATERIALS OF THE HYDRONIC SYSTEM (PIPING, VALVES, PUMPS, CHILLER, BOILER, ETC.) AS WELL AS ALL TERMINAL EQUIPMENT.
- 16. AUTOMATIC TEMPERATURE AND SAFETY CONTROLS
- a. PROVIDE ALL WIRING, RELAYS, CONTACTS, TRANSFORMERS, ETC. REQUIRED TO DELIVER A COMPLETE OPERABLE
- b. THERMOSTATS SHALL BE 24 HOUR/7 DAY PROGRAMMABLE WITH FAN "OFF/ON/AUTO" AND SYSTEM "HEAT/COOL/AUTO/OFF" SWITCHES. VERIFY OPERATION OF ALL FUNCTIONS.

- 17. FIRE PROTECTION
- a. THE QUANTITY AND LOCATION OF SPRINKLERS SHOWN ON THE DRAWINGS ARE APPROXIMATE AND INTENDED FOR SCHEMATIC PURPOSES ONLY. THE FIRE PROTECTION CONTRACTOR SHALL BE RESPONSIBLE FOR FURNISHING, INSTALLING AND COMMISSIONING ALL NECESSARY SPRINKLERS, PIPE, EQUIPMENT AND APPURTENANCES NECESSARY, IN FULL ACCORDANCE WITH THE NFPA AND APPROVED BY THE ENGINEER AND ALL AUTHORITIES HAVING JURISDICTION.
- b. THE FIRE PROTECTION CONTRACTOR SHALL PROVIDE DETAILED DESIGN DRAWINGS. HYDRAULIC CALCULATIONS. PIPING. FITTINGS, SPRINKLERS, ALARM AND MONITORING DEVICES, SIGNAGE AND APPURTENANCES COMPLETE AND IN FULL ACCORDANCE WITH ALL APPLICABLE BUILDING CODES AND NFPA 13 & 14. ALL WIRING OF DEVICES SHALL BE DONE BY ELECTRICAL CONTRACTOR.
- c. ALL SPRINKLER HEADS SHALL BE LOCATED AT THE CENTER POINT OF ALL ACOUSTICAL CEILING TILES.
- 18. ALL EXISTING PLUMBING, HVAC AND ELECTRICAL EQUIPMENT AND MATERIALS THAT ARE EITHER EXPOSED OR CONCEALED AND THAT INTERFERE WITH ALTERED EXISTING BUILDING ARRANGEMENTS AND NEW SYSTEMS SHALL BE REMOVED, RELOCATED, REROUTED, OR ABANDONED. DRAWINGS GENERALLY INDICATE MAJOR ITEMS OF EXISTING MATERIALS AND EQUIPMENT THAT ARE AFFECTED. IT IS NOT POSSIBLE TO INDICATE ALL RELATED ACCESSORIES, SPECIALTIES AND OTHER MINOR ITEMS; HOWEVER, THEIR REMOVAL, RELOCATION, REROUTING AND ABANDONMENT SHALL ALSO BE INCLUDED IN THIS WORK.
- 19. EXISTING CONCEALED PLUMBING, HVAC AND ELECTRICAL EQUIPMENT AND MATERIALS THAT ARE TO REMAIN BUT BECOME EXPOSED DUE TO RENOVATION WORK, SHALL BE RELOCATED AND RECONNECTED AS PART OF THIS WORK.
- 20. PLUMBING DRAWINGS ARE DIAGRAMMATIC. ALL DEVICES & FITTINGS MAY NOT BE SHOWN ON THE DRAWINGS FOR CLARITY. PROVIDE CLEANOUTS NEAR THE BASE OF ALL VERTICAL WASTE & STORM WATER STACKS IN ACCORDANCE
- WITH THE LATEST EDITION OF THE NATIONAL STANDARD PLUMBING CODE. 21. GUARDS SHALL BE PROVIDED WHERE APPLIANCES, EQUIPMENT, FANS OR OTHER COMPONENTS THAT REQUIRE SERVICE AND ROOF HATCH OPENINGS ARE LOCATED WITHIN 12 FEET OF A ROOF EDGE OR OPEN SIDE OF A WALKING SURFACE AND SUCH EDGE OR OPEN SIDE IS LOCATED MORE THEN 30 INCHES ABOVE THE FLOOR, ROOF OR GRADE BELOW. THE GUARD SHALL EXTEND NOT LESS THEN 30 INCHES BEYOND EACH END OF SUCH APPLIANCES. EQUIPMENT, FANS. COMPONENTS AND ROOF HATCH OPENINGS AND THE TOP OF THE GUARD SHALL BE LOCATED NOT LESS THEN 42 INCHES ABOVE THE ELEVATED SURFACE ADJACENT TO THE GUARD. THE GUARD SHALL BE CONSTRUCTED SO AS TO PREVENT THE PASSAGE OF A 21 INCH-DIAMETER SPHERE AND SHALL COMPLY WITH THE LOADING REQUIREMENTS FOR GUARDS SPECIFIED IN THE LATEST EDITION OF THE INTERNATIONAL BUILDING CODE.
- 22. PROVIDE FOR ALL MECHANICAL EQUIPMENT FAN AND MOTOR PULLEYS, SHEAVES, BELTS AND LABOR REQUIRED TO BALANCE THE NEW AND EXISTING MECHANICAL EQUIPMENT TO THE SPECIFIED SUPPLY, RETURN, EXHAUST AND OUTSIDE AIR FLOWS SHOWN ON THE CONTRACT DOCUMENTS AT NO ADDITIONAL COST TO THE OWNER. THE TESTING. ADJUSTING AND BALANCING CONTRACTOR SHALL BE RESPONSIBLE FOR PROVIDING ALL REQUIRED PULLEYS, SHEAVES AND BELTS EVEN IF THEY ARE NOT PROVIDED WITH THE EQUIPMENT BY THE MANUFACTURER.
- 23. UNLESS OTHERWISE NOTED CONTRACTOR IS RESPONSIBLE TO FURNISH AND INSTALL ALL CONNECTION/ TRANSITION DUCTS BETWEEN NEW HVAC EQUIPMENT (UNIT VENTILATORS, BLOWER COILS, FAN COILS, AIR HANDLERS, ETC.) AND NEW OR EXISTING OUTSIDE AIR LOUVERS. CONTRACTOR IS ALSO RESPONSIBLE FOR REINFORCING ANY OUTSIDE AIR LOUVER OPENING THAT IS CREATED OR ENLARGED TO ACCOMMODATE THE NEW INSTALLATION.
- 24. UNLESS SPECIFICALLY DIRECTED OTHERWISE THE CONTRACTOR SHALL SUBMIT PRE-DEMOLITION/ PRE-CONSTRUCTION VIDEOS AND/ OR PHOTOGRAPHS OF THE EXISTING CONDITIONS IN THE PROPOSED AREA OF WORK TO THE ENGINEER FOR REVIEW PRIOR TO START OF DEMOLITION / CONSTRUCTION WORK.

	MECHANICAL AB	BREVIA	ATIONS
CTS CU CUH CWS	ACCESS DOOR ADJACENT ABOVE FINISHED FLOOR AIR HANDLER UNIT ACCESS PANEL BOILER BELOW FINISHED FLOOR BACKFLOW PREVENTOR BOILER FEED UNIT BOTTOM OF DUCT BOTTOM OF LOUVER CONDENSATE CAST IRON CEILING EXHAUST GRILLE CEILING EXHAUST GRILLE CEILING EXHAUST REGISTER CUBIC FEET PER HOUR CUBIC FEET PER MINUTE CLEANOUT ON GRADE CONDENSATE PIPING CONTINUED CONDENSATE PUMP CEILING RETURN GRILLE CEILING RETURN GRILLE CEILING RETURN REGISTER CIRCUIT SETTER VALVE COOLING TOWER SUPPLY CONDENSING UNIT CABINET UNIT HEATER COLD WATER SUPPLY CONDENSER WATER SUPPLY/RETURN DRINKING FOUNTAIN DRAINAGE FIXTURE UNITS DOWN EXHAUST AIR ELECTRIC BASEBOARD HEATER EXHAUST FAN ELECTRIC WATER HEATER EXHAUST FAN ELECTRIC WATER HEATER EXISTING FLEXIBLE CONNECTION/FAN COIL FLOOR CLEANOUT FLOOR DRAIN FLOOR RETURN REGISTER GAS PIPING GRAVITY VENTILATOR HOSE BIBB HAND DAMPER HEAT PUMP HOT WATER HEATER HANDICAPPED WATER CLOSET HOT WATER GENERATOR HOT WATER HEATER HANDICAPPED WATER CLOSET HOT WATER GENERATOR HOT WATER HEATER HANDICAPPED WATER CLOSET HOT WATER HEATER HOT WATER HEATER HOT WATER HEATER HOT WATER HEATER HOT WATER GENERATOR HOT WATER HEATER HOT WATER GENERATOR HOT WATER RETURN HOT WATER SUPPLY HEAT EXCHANGER LOVER LAVATORY LINEAR BAR GRILLE LINEAR DIFFUSER LINEAR FEET	T TAG TOD TP	TUB TRANSFER AIR GRILLE TOP OF DUCT TRAP PRIMER

MECHANICAL SYMBOLS EQUIPMENT MARK (TYPE FC, NUMBER 1) PRESSURE GAUGE SECTION INDICATOR GAUGECOCK (SECTION B2 ON DWG. -THERMOMETER DETAIL INDICATOR (DETAIL B2 ON DWG. - -) PRESSURE TEMPERATURE TAP KEY NOTE INDICATOR (REFERS TO NOTES ON SAME SHEET) EXISTING HYDRONIC CONTROL VALVE REVISIONS INDICATOR HOSE BIBB DRAIN VALVE INSULATED PIPE PIPE RISER (RISER HWS-11 ON DWG. - -) VERTICAL VALVE DUCT RISER (RISER E-1 ON DWG. - -) CIRCUIT SETTER (A/150 S)DIFFUSER/REGISTER/GRILLE MARK (TYPE A, 150 CFM, DIRECTION) FLOW METER (MAGNETIC) DOOR UNDERCUT FLOW METER (VENTURI) TRANSFER AIR BALL JOINT DIAMETER SUCTION DIFFUSER CONNECTION TO EXISTING PIPE ANCHOR POINT OF DISCONNECTION PIPE GUIDE 516x10 € FLAT OVAL DUCT DIMENSION UNION \$\delta \text{16x10} \delta \text{ INSIDE DUCT DIMENSION (IN INCHES, FIRST DIMENSION IS AS VIEWED)} **₹** ∷_} Sound Lined Ductwork CAP AND VALVED SUPPLY DUCT TURNED UP CONCENTRIC REDUCER SUPPLY DUCT TURNED DOWN ECCENTRIC REDUCER STRAIGHT INVERT RETURN/EXHAUST DUCT TURNED UP ECCENTRIC REDUCER STRAIGHT CROWN RETURN/EXHAUST DUCT TURNED DOWN -(M)(SEE CONNECTED PIPING FOR TYPE OF SERVICE) SQUARE ELBOW (WITH TURNING VANES) CHAIN OPERATOR ROUND ELBOW MOTOR OPERATOR SPIN-IN WITH VOLUME DAMPER FOR ROUND DUCT TAKE OFF WITH VOLUME DAMPER FOR RECTANGULAR DUCT OPEN END DUCT WITH WMS CO I CO CO CLEANOUT EXISTING DUCT WORK OR EQUIPMENT FD - FLOOR DRAIN WITH P-TRAP DUCT WORK TO BE REMOVED & EXISTING FUNNEL DRAIN DUCTWORK TO BE CAPPED EXISTING DUCTWORK TO BE RELOCATED FLEXIBLE DUCTWORK (SINGLE LINE) DOUBLE CHECK VALVE TYPE BACKFLOW PREVENTER WITH GATE VALVES FLEXIBLE DUCTWORK (DOUBLE LINE) wwwWITH GATE VALVES SUPPLY DIFFUSER REDUCED PRESSURE ZONE BACKFLOW PREVENTER WITH BALL VALVES SUPPLY AIR DIFFUSER WITH 3 DIRECTION DISCHARGE (BLACK TRIANGLE INDICATED BLANK OFF) RETURN/EXHAUST REGISTER OR GRILLE DOUBLE CHECK VALVE TYPE BACKFLOW PREVENTER WITH BALL VALVES SLOT DIFFUSER WITH PLENUMS — HB HOSE BIBB EXHAUST FAN ELECTRIC BASEBOARD WATER HAMMER ARRESTOR **VOLUME DAMPER (MANUAL)** PITCH PIPE DOWN IN DIRECTION OF ARROW BACKDRAFT DAMPER TEE TURN UP —(')— FIRE DAMPER TEE TURNED DOWN MOTORIZED DAMPER O PIPE TURNED UP MOTORIZED SMOKE/FIRE DAMPER C----- PIPE TURNED DOWN CARBON MONOXIDE SENSOR KEY SWITCH **THERMOSTAT** BUSHING **HUMIDISTAT** FLEXIBLE PIPE CONNECTION S **SENSOR** MANUAL AIR VENT DUCT DETECTOR CONCEALED SPRINKLER HEAD BALL VALVE ——— PENDANT SPRINKLER HEAD SHUTOFF VALVE (SEE SPECS. FOR TYPE) UPRIGHT SPRINKLER HEAD **BUTTERFLY VALVE** SIDEWALL SPRINKLER HEAD **₩** GATE VALVE EMERGENCY BOILER SHUTOFF ———— DOMESTIC COLD WATER PIPE SOUND ATTENUATOR PRESSURE/TEMPERATURE TEST PLUG - BLIND FLANGE END CONNECTION — AW — ACID WASTE PIPING LOCK SHIELD GATE VALVE — FO — FUEL OIL PIPING GLOBE VALVE '//// PIPING TO BE DEMOLISHED ——BF—— BOILER FEED PIPING — S — STEAM PIPING — C — STEAM CONDENSATE PIPING

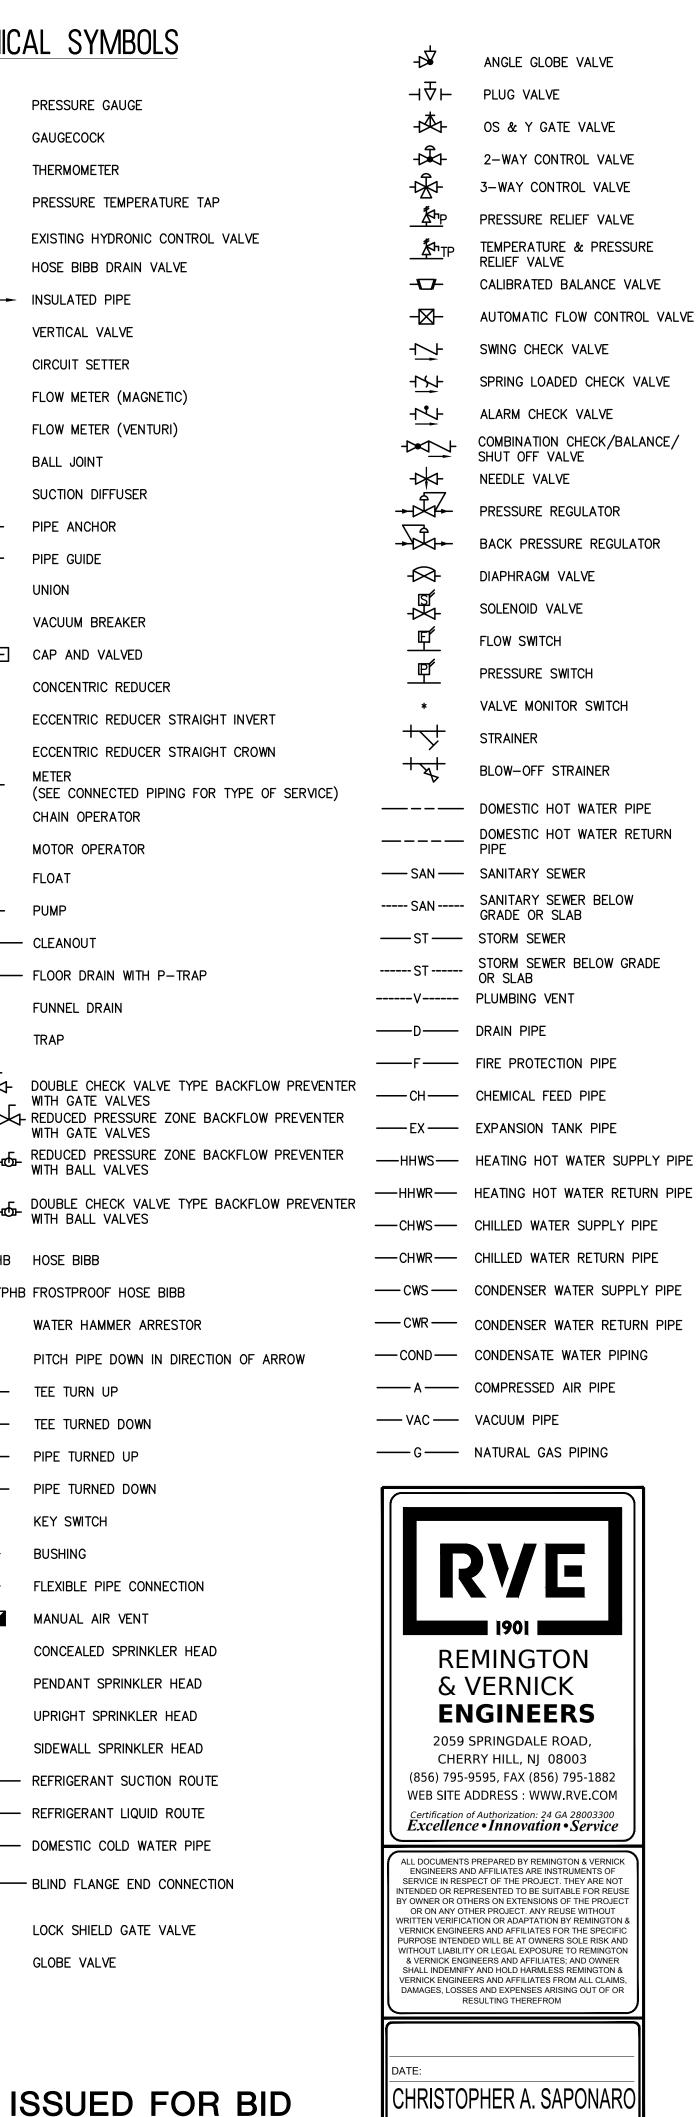

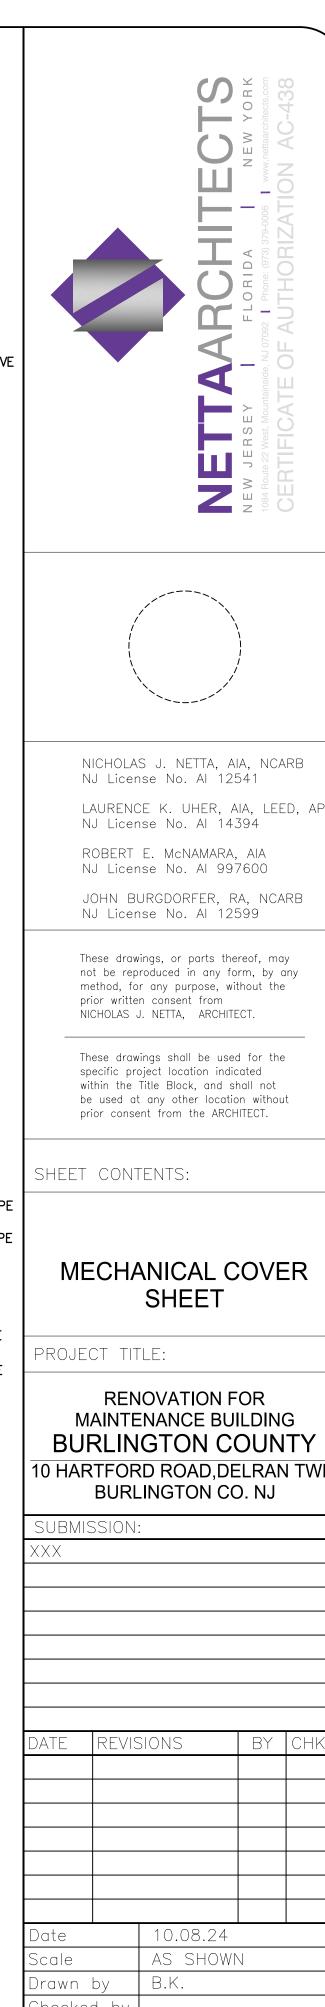

MAINTENANCE BUILDING **BURLINGTON COUNTY** 10 HARTFORD ROAD.DELRAN TWP.


Checked b 2241869 ob No.

NICHOLAS J. NETTA, AIA, NCARB LAURENCE K. UHER, AIA, LEED, AP

CHRISTOPHER A. SAPONARC NJ PROFESSIONAL ENGINEER LIC. No. 40059


DATE: 01-10-2025

Drawing No.

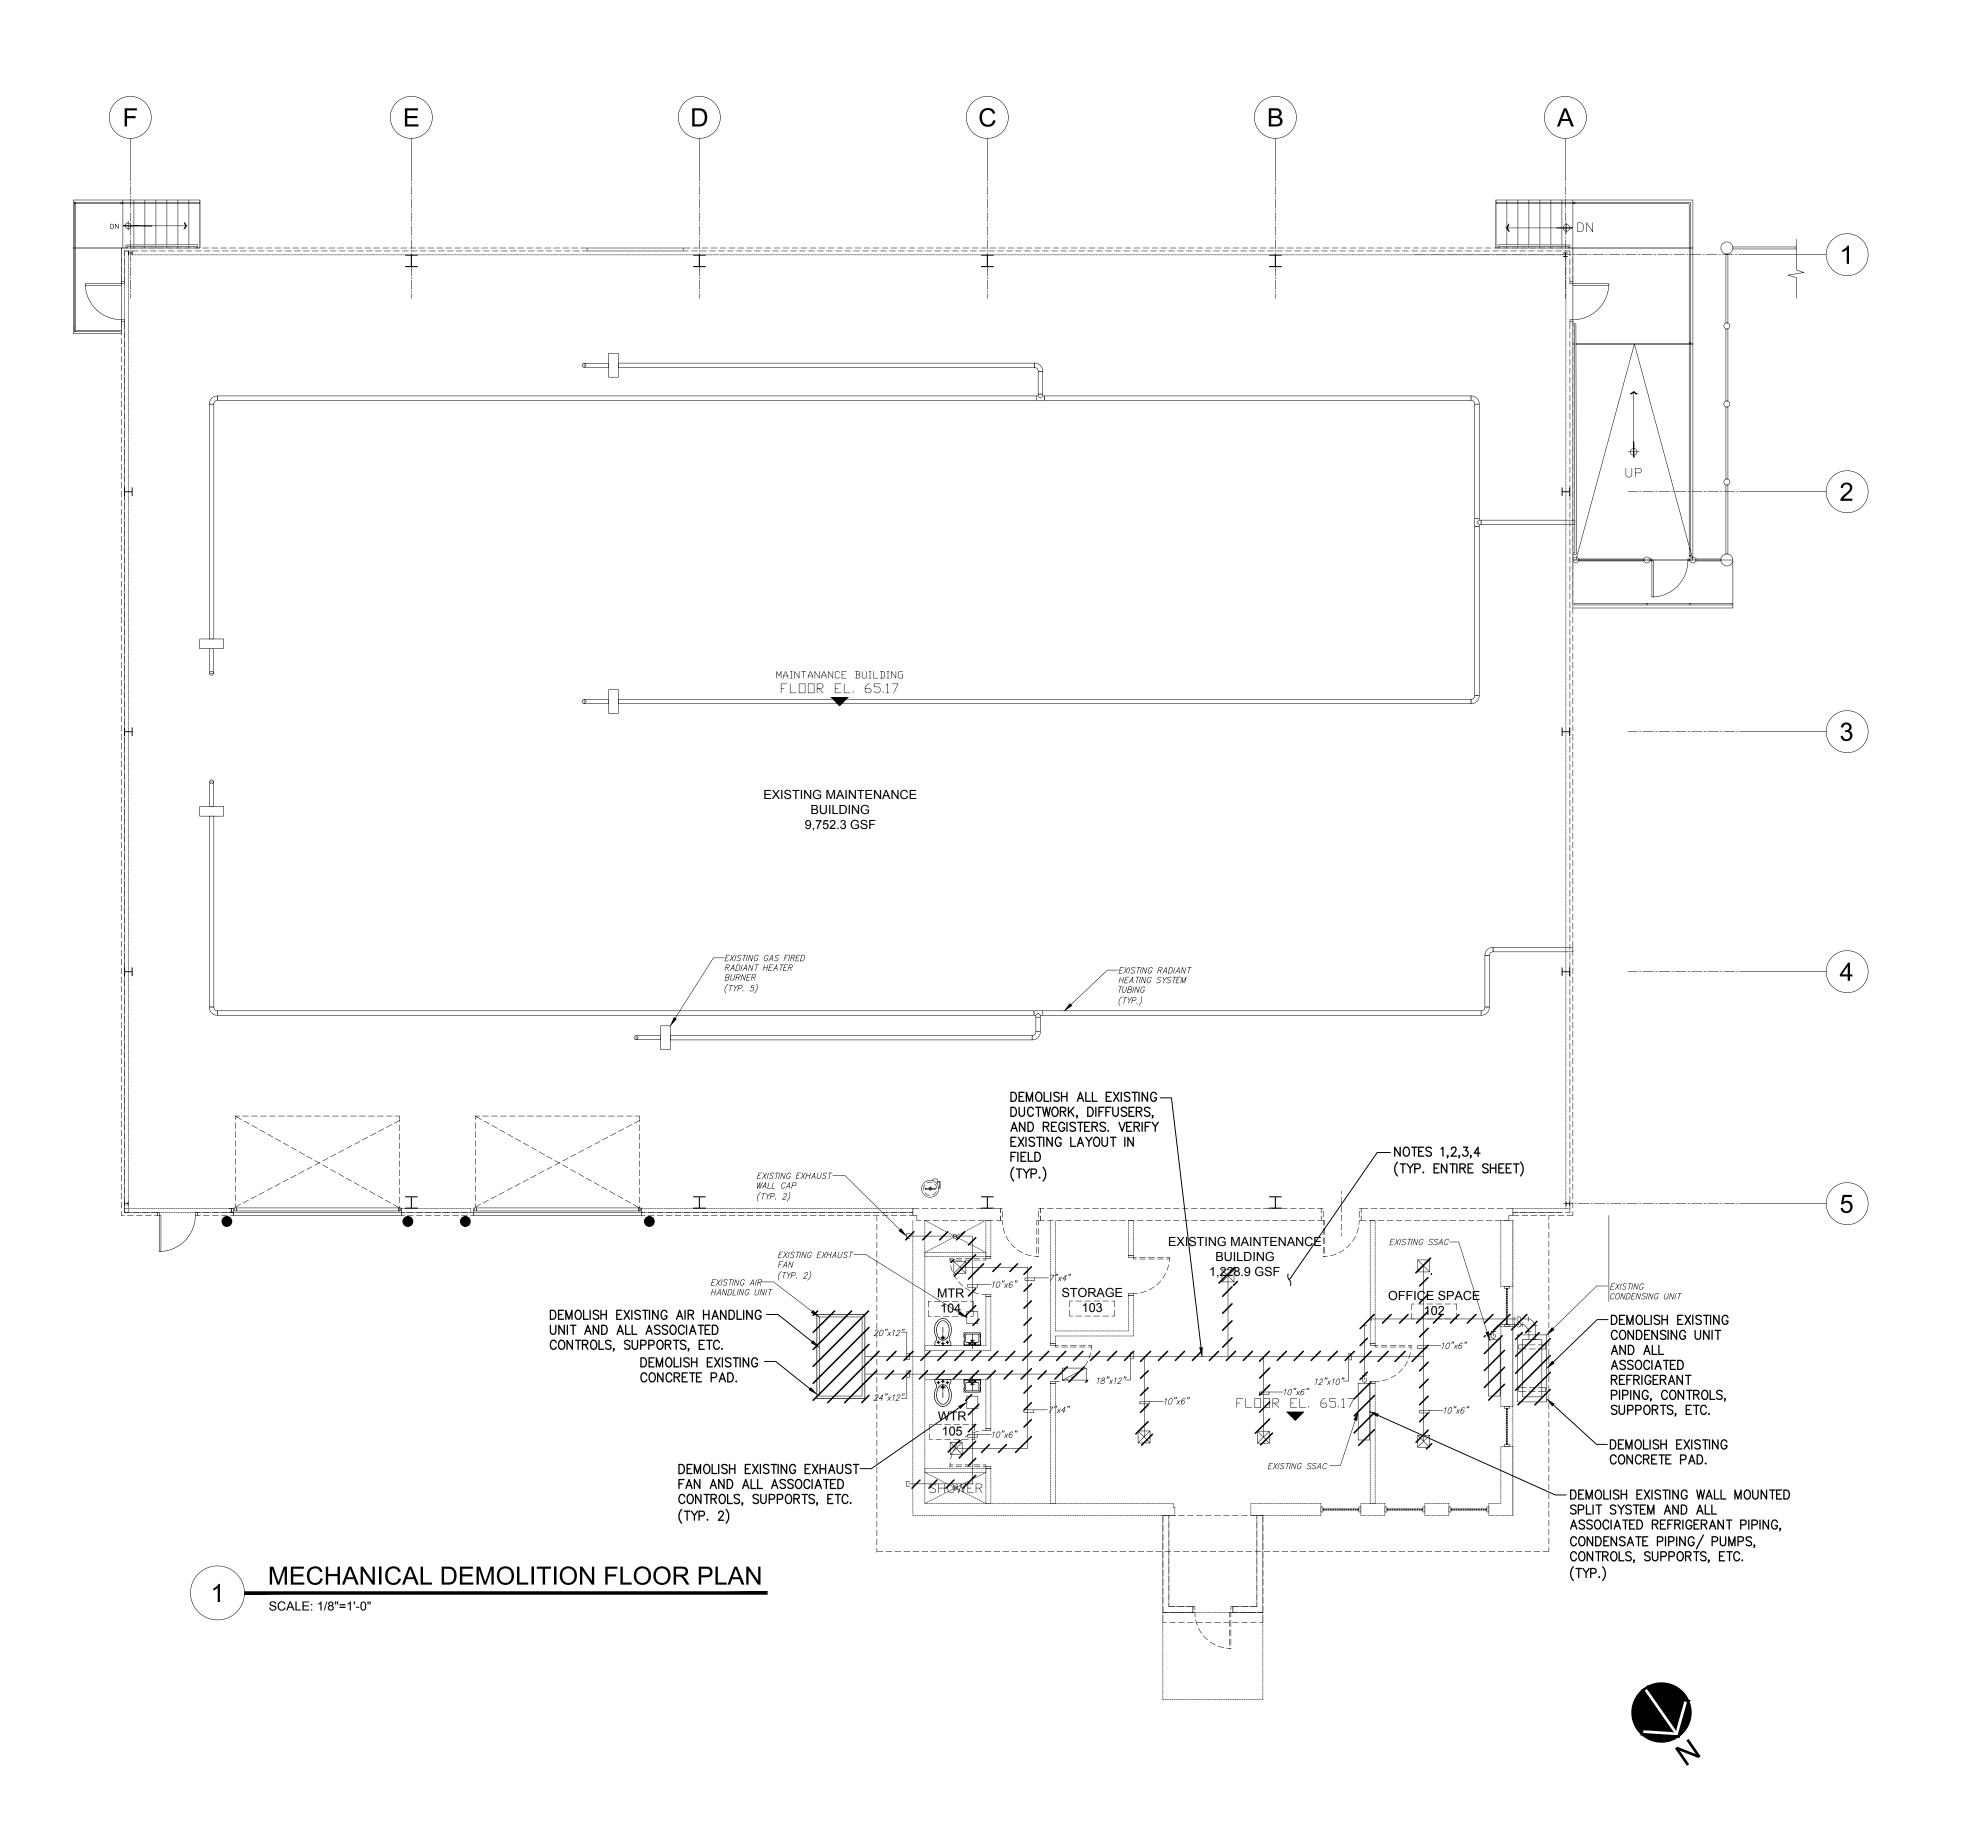

NOTES

- ALL NOTES, SYMBOLS, AND ABBREVIATIONS ON DRAWING M-1.0 APPLY TO THIS DRAWING.
- 2. THIS DEMOLITION PLAN HAS BEEN PROVIDED AS A GUIDE. HOWEVER, ALL DEMOLITION REQUIRED TO SUCCESSFULLY COMPLETE THIS PROJECT SHALL BE INCLUDED IN THE SCOPE OF WORK. IT IS THE INTENT OF THE PLANS AND SPECIFICATIONS TO SECURE A COMPLETELY INTERCONNECTED AND FUNCTIONING SYSTEM AND IF ANY WORKMANSHIP OR MATERIALS BE REQUIRED WHICH ARE OBVIOUSLY NECESSARY TO CARRY OUT THE FULL INTENT AND MEANING OF THE PLANS AND SPECIFICATIONS OR TO BE REASONABLY INFERRED THEREFROM, THE COST OF SUCH WORKMANSHIP OR MATERIALS SHALL BE INCLUDED IN THE SCOPE OF WORK.
- COORDINATE THE DEMOLITION OF THE EXISTING MECHANICAL EQUIPMENT WITH OWNER.
 OWNER SHALL RESERVE THE RIGHT TO MAINTAIN SALVAGED EQUIPMENT. ALL
 EQUIPMENT NOT RETAINED BY THE OWNER SHALL BE DISPOSED OF BY THE
 CONTRACTOR.
- 4. COORDINATE THE DEMOLITION OF THE EXISTING MECHANICAL EQUIPMENT WITH THE ELECTRICAL CONTRACTOR. SEE THE ELECTRICAL DRAWINGS AND SPECIFICATIONS FOR ADDITIONAL DETAILS.
- 5. DEMOLISH EXISTING AIR HANDLING UNIT AND ALL ASSOCIATED DUCTWORK, DUCT INSULATION, GRILLES/ REGISTERS/ DIFFUSERS, DAMPERS AND DUCT MOUNTED DEVICES. DEMOLISH EXISTING ELECTRIC CABINET UNIT HEATER AND ALL ASSOCIATED DUCTWORK, DUCT INSULATION, GRILLES/ REGISTERS/ DIFFUSERS, DAMPERS, DUCT MOUNTED DEVICES, CONTROLS, CONTROLS, CONTROLS, CONTROL WIRING, ETC.
- 6. DEMOLISH EXISTING RETURN AIR DUCTWORK, DUCT INSULATION, GRILLES/ REGISTERS/ DIFFUSERS, DAMPERS, DUCT MOUNTED DEVICES, CONTROLS, CONTROL WIRING, ETC. DEMOLISH EXISTING RETURN AIR DUCTWORK, DUCT INSULATION, GRILLES/ REGISTERS/ DIFFUSERS, DAMPERS, DUCT MOUNTED DEVICES, CONTROLS, CONTROL WIRING, ETC.

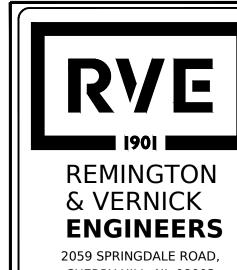


2059 SPRINGDALE ROAD,
CHERRY HILL, NJ 08003
(856) 795-9595, FAX (856) 795-1882
WEB SITE ADDRESS: WWW.RVE.COM
Certification of Authorization: 24 GA 28003300
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DATE

CHRISTOPHER A. SAPONARO
NJ PROFESSIONAL ENGINEER LIC. No. 40059

ETTAARAHTE V JERSEY | FLORIDA | NE Oute 22 West, Mountainside, NJ 07092 | Phone: (973) 379-0006 | www.net



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LAURENCE K. UHER, AIA, LEED, AP NJ License No. AI 14394

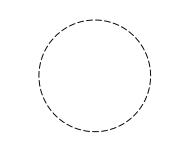ROBERT E. McNAMARA, AIA NJ License No. AI 997600

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SHEET CONTENTS:

MECHANICAL DEMOLITION FLOOR PLAN

PROJECT TITLE:

SUBMISSION:

RENOVATION FOR
MAINTENANCE BUILDING
BURLINGTON COUNTY


10 HARTFORD ROAD, DELRAN TWP.
BURLINGTON CO. NJ

ATE	REVISIONS	BY	CHKD
ate	10.08.24		•

Date 10.08.24
Scale AS SHOWN
Drawn by B.K.
Checked by
Job No. 2241869
Drawing No.

M-1.1

ISSUED FOR BID
DATE: 01-10-2025

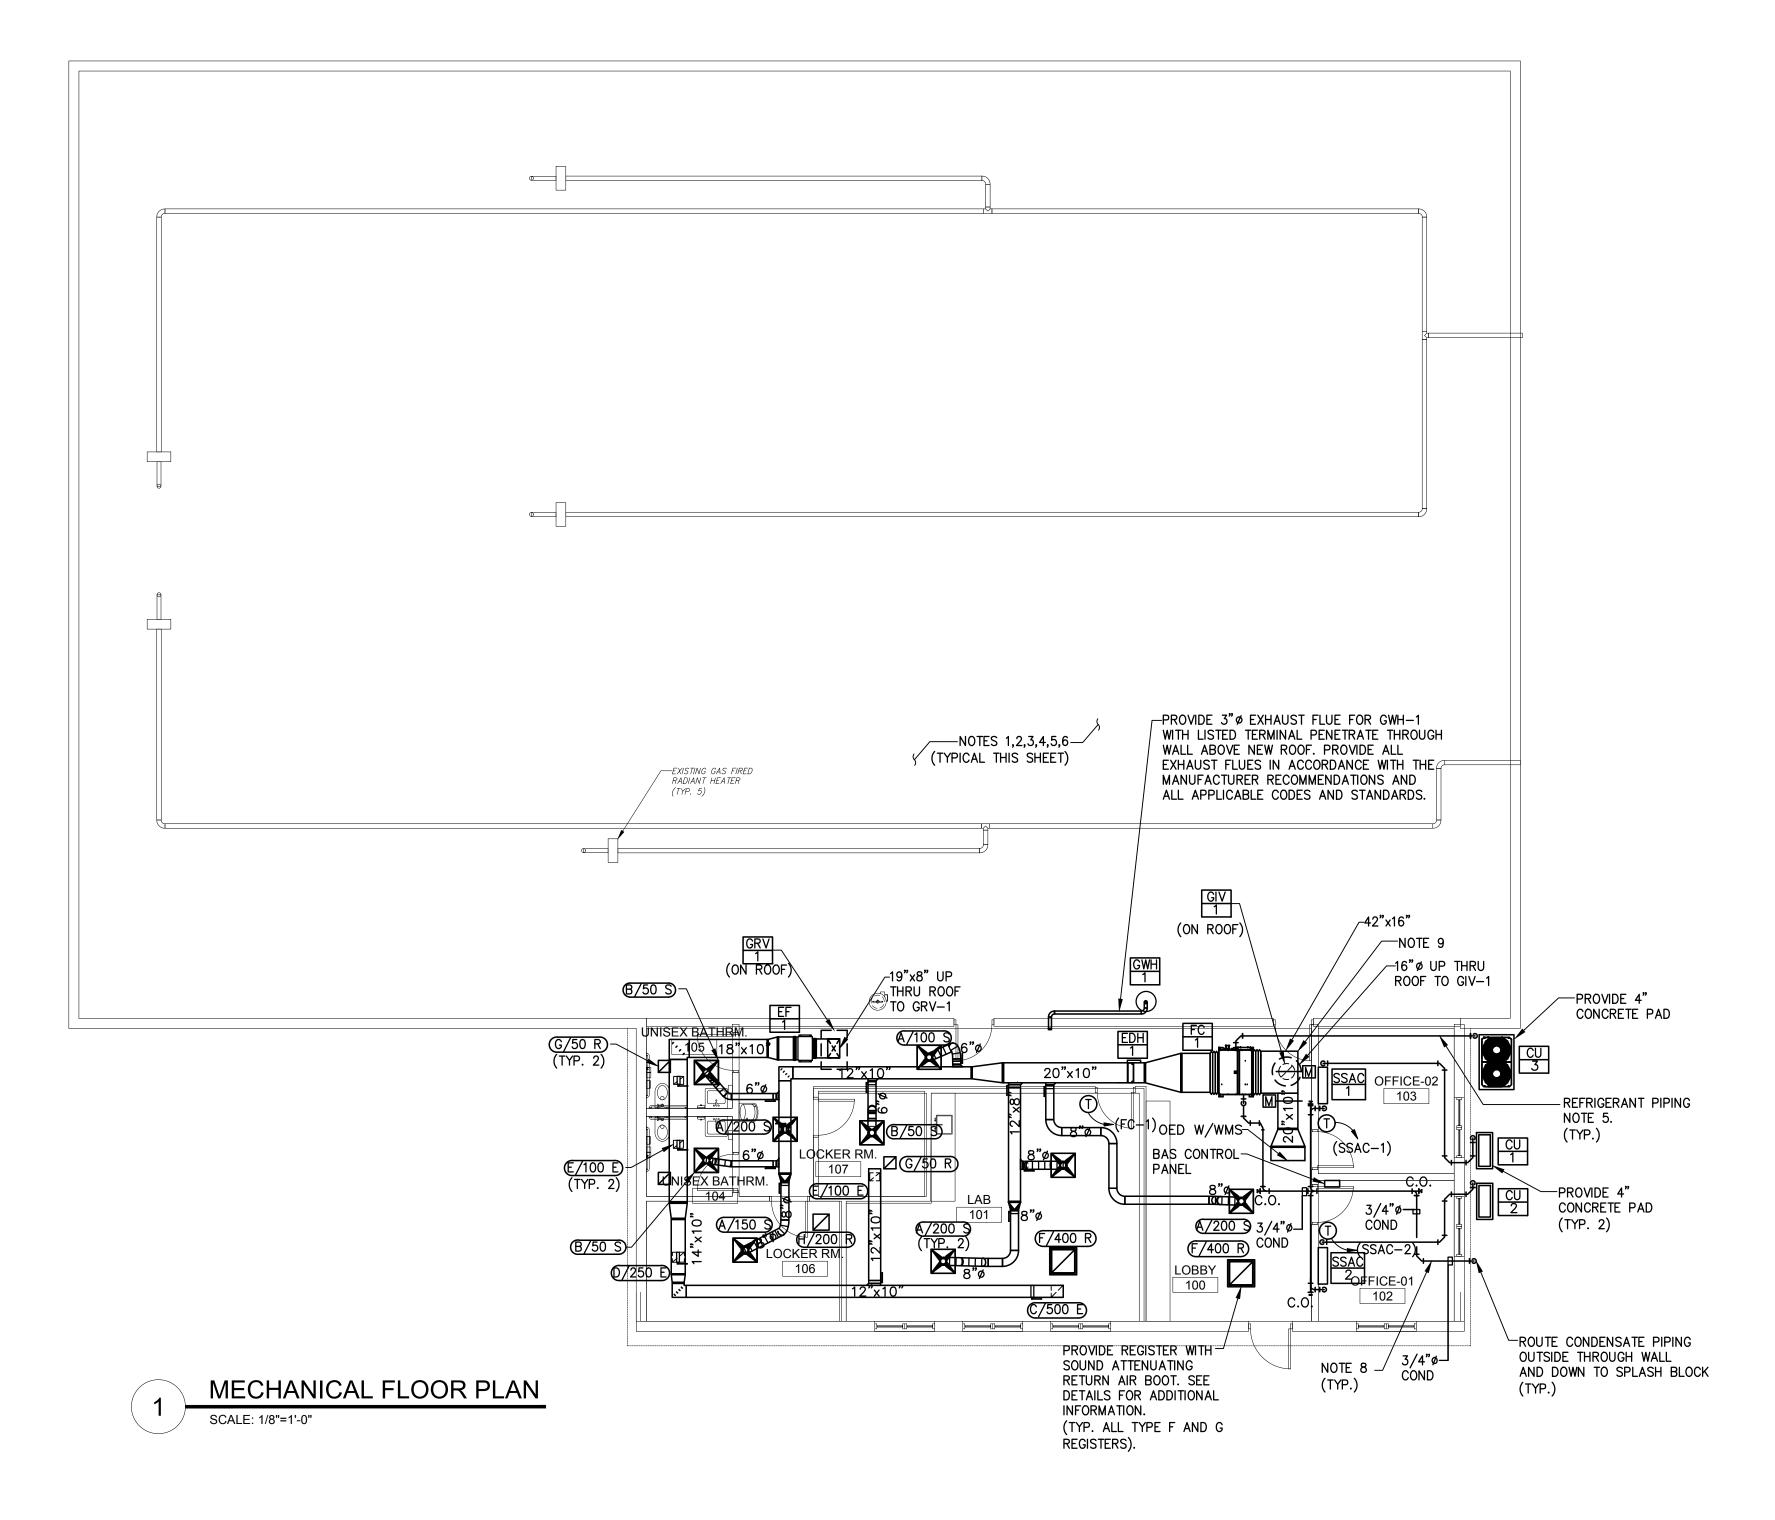

NOTES:

- 1. ALL NOTES, SYMBOLS, AND ABBREVIATIONS ON DRAWING M-1.0 APPLY TO THIS DRAWING.
- 2. THIS NEW WORK PLAN HAS BEEN PROVIDED AS A GUIDE TO CONVEY THE DESIGN INTENT. ALL NEW WORK REQUIRED TO SUCCESSFULLY COMPLETE THIS PROJECT SHALL BE INCLUDED IN THE SCOPE OF WORK. IT IS THE INTENT OF THE PLANS AND SPECIFICATIONS TO SECURE A COMPLETELY INTERCONNECTED AND FUNCTIONING SYSTEM AND IF ANY WORKMANSHIP OR MATERIALS BE REQUIRED WHICH ARE OBVIOUSLY NECESSARY TO CARRY OUT THE FULL INTENT AND MEANING OF THE PLANS AND SPECIFICATIONS OR TO BE REASONABLY INFERRED THEREFROM, THE COST OF SUCH WORKMANSHIP OR MATERIALS SHALL BE INCLUDED IN THE SCOPE OF WORK. ALL EXISTING SYSTEMS NOT SPECIFICALLY SHOWN OR NOTED TO BE REMOVED/MODIFIED ON THE DRAWINGS SHALL REMAIN IN SERVICE AND BE UNDISTURBED.
- 3. DUCTWORK ROUTINGS SHOWN ARE APPROXIMATE. THE CONTRACTOR SHALL BE RESPONSIBLE FOR FINAL ROUTINGS IN THE FIELD TO AVOID INTERFERENCES.

 CONTRACTOR TO COORDINATE DUCTWORK/UNIT INSTALLATION WITH ALL STRUCTURAL STEEL, ELECTRICAL CONDUIT, SYSTEMS WIRING/CABLE, CLOCK SYSTEM, FIRE PROTECTION PIPING, PLUMBING PIPING (SANITARY DRAINAGE, ROOF DRAINAGE, DOMESTIC HOT/COLD WATER AND GAS PIPING), ETC. AS REQUIRED. ALL MODIFICATIONS MADE TO THE NEW DUCTWORK OR PIPING TO RESOLVE INTERFERENCES SHALL BE PROVIDED BY THE CONTRACTOR AT NO ADDITIONAL COST TO THE OWNER. SEE DIVISION 16 DRAWINGS AND SPECIFICATIONS FOR ADDITIONAL REQUIREMENTS.
- 4. CONTRACTOR TO PROVIDE FIRE STOPPING SLEEVES AS REQUIRED FOR ALL PROPOSED CORRIDOR/ FIREWALL/FLOOR/ROOF PENETRATIONS.

PROVIDE REFRIGERATION PIPING IN ACCORDANCE WITH MANUFACTURERS RECOMMENDATIONS. ALL PIPE ROUTINGS SHOWN ARE APPROXIMATE. REFRIGERATION PIPING SHOWN ON THIS PLAN REFLECTS BOTH SUCTION AND LIQUID PIPING. THE CONTRACTOR SHALL BE RESPONSIBLE TO FIELD COORDINATE ALL FINAL PIPE ROUTINGS IN THE FIELD TO AVOID INTERFERENCES AT NO ADDITIONAL COST TO THE OWNER. CONTRACTOR SHALL FIELD VERIFY FINAL LENGTH OF ALL HORIZONTAL AND VERTICAL REFRIGERANT PIPING RUNS (INCLUDING ALL FITTINGS) BETWEEN EQUIPMENT FOR PIPE SIZE CONFIRMATION. PROVIDE ALL VALVES, FILTERS, AND OTHER ACCESSORIES AS RECOMMENDED BY THE EQUIPMENT MANUFACTURER. ALL REFRIGERATION SUCTION PIPING SHALL BE INSULATED — SEE DIVISION 23 SPECIFICATIONS FOR ADDITIONAL INFORMATION.

- 6. NOT ALL INLINE DEVICES (VALVES, DAMPERS, REDUCERS, GAUGES, ETC.) HAVE BEEN SHOWN ON THE PLANS FOR CLARITY. SEE PIPING DETAILS ON MECHANICAL DETAIL DRAWINGS FOR ADDITIONAL INFORMATION. THE CONTRACTOR SHALL PROVIDE ALL INLINE DEVICES (VALVES, DAMPERS, REDUCERS, GAUGES, ETC.) AS REQUIRED TO COMPLETE THE INSTALLATION EVEN IF NOT SPECIFICALLY SHOWN ON THE PLANS OR DETAILS.
- 7. LOCATION OF ALL CEILING MOUNTED GRILLES, REGISTERS AND DIFFUSERS SHOWN ON THIS SHEET ARE APPROXIMATE. CONTRACTOR SHALL FIELD ADJUST ALL LOCATIONS BASED ON THE CEILING GRID LAYOUT AS REQUIRED TO COMPLETE THE INSTALLATION AT NO ADDITIONAL COST TO THE OWNER
- PROVIDE A MINIMUM HORIZONTAL SLOPE OF NO LESS THAN 1/8" EVERY 12" FOR CONDENSATE LINES.
- 9. CONTRACTOR TO INSTALL FIELD FABRICATED MIXING BOX WITH RA/OA DAMPERS.




DATE:

CHRISTOPHER A. SAPONARO

NJ PROFESSIONAL ENGINEER LIC. No. 40059

RESULTING THEREFROM



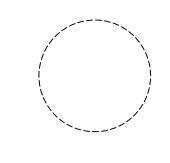

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LAURENCE K. UHER, AIA, LEED, AP NJ License No. AI 14394

ROBERT E. McNAMARA, AIA NJ License No. AI 997600

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SHEET CONTENTS:

MECHANICAL FLOOR PLAN

PROJECT TITLE:

SUBMISSION:

RENOVATION FOR
MAINTENANCE BUILDING
BURLINGTON COUNTY

10 HARTFORD ROAD, DELRAN TWP.
BURLINGTON CO. NJ

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)ate		10.08.24		
Scale		AS SHOWN	V	
)rawn	by	B.K.		

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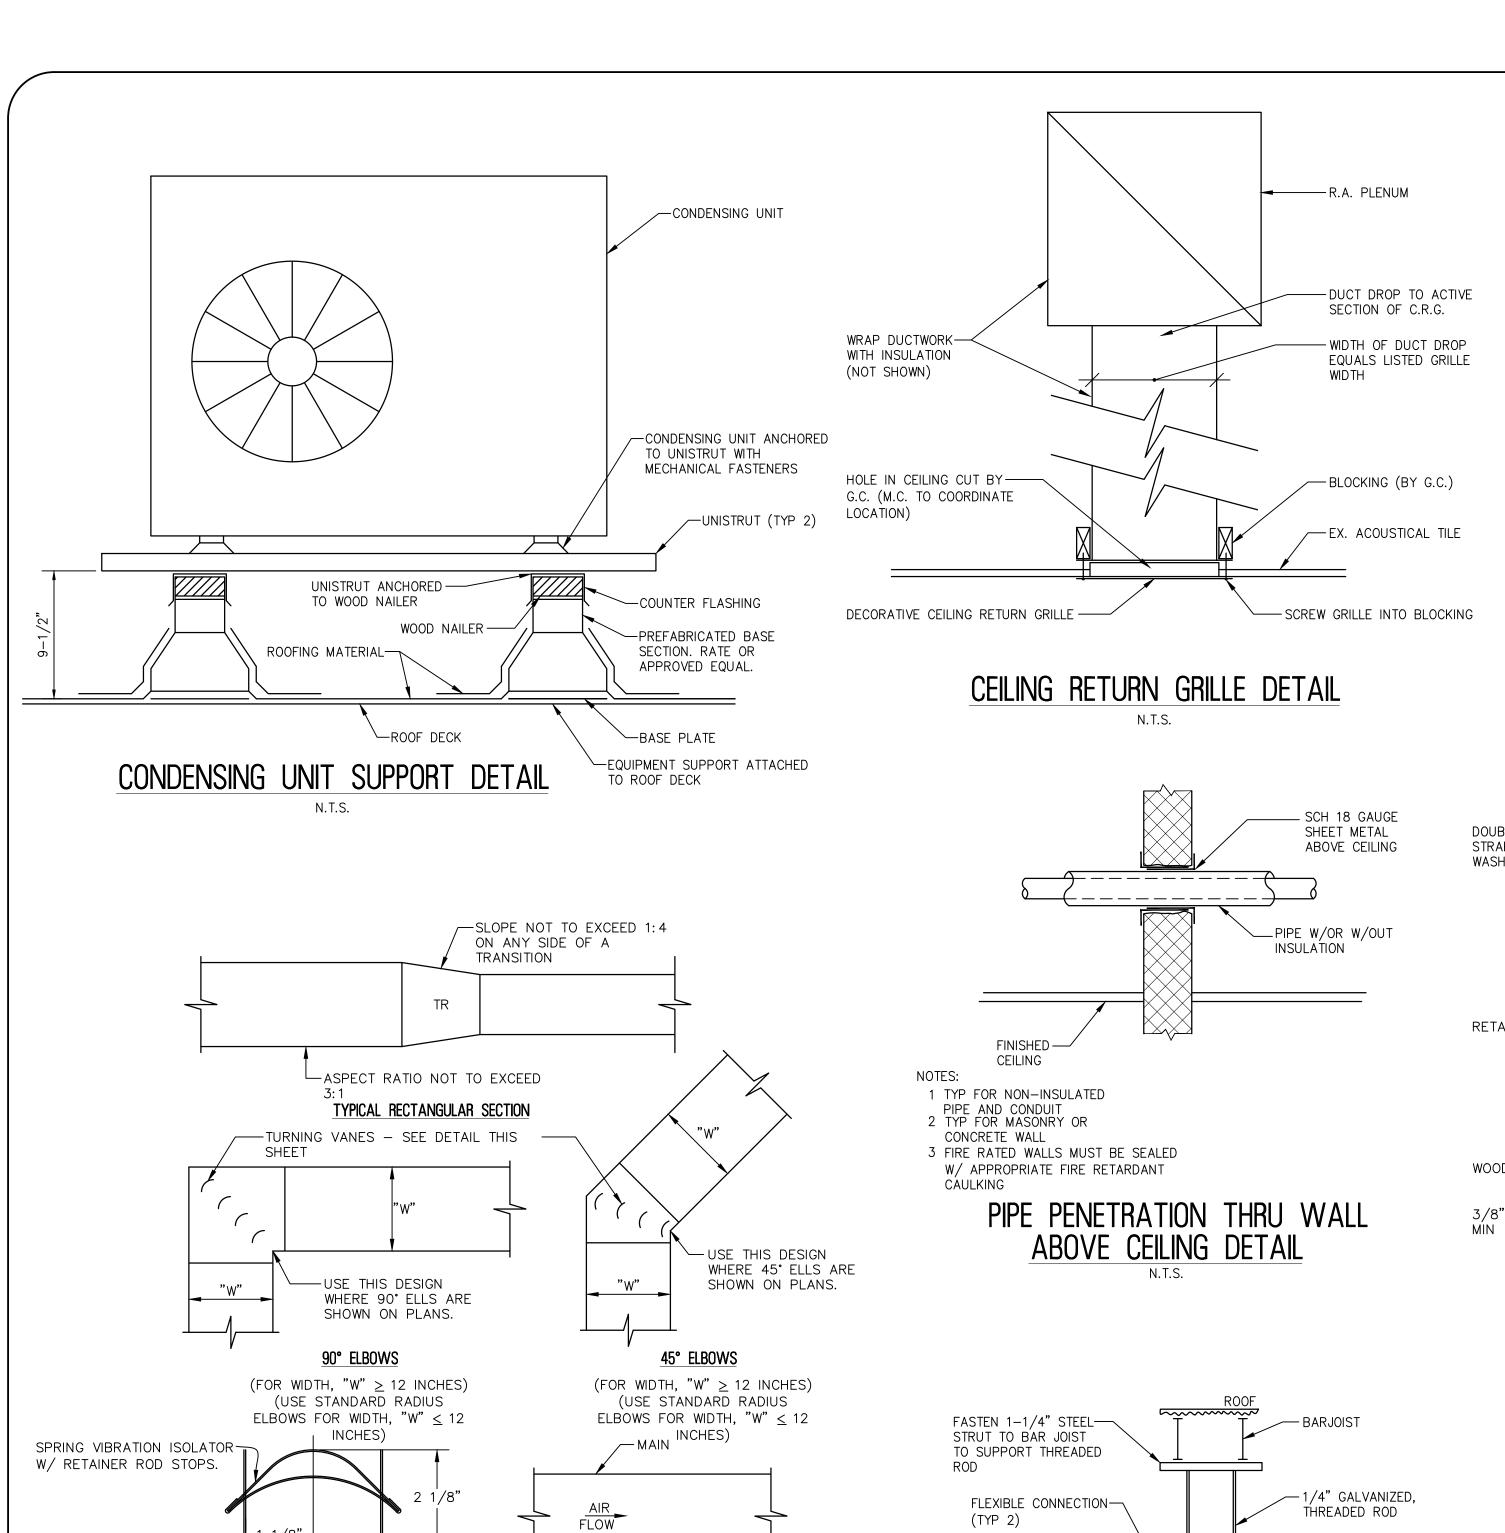
2241869

Checked by

Drawing No.

ob No.

ISSUED FOR BID
DATE: 01-10-2025



← COLLAR

BRANCH DUCT

── - VOLUME DAMPER


TYPICAL BRANCH CONNECTION

RUNNER


DETAILS OF DUCT LAYOUT

N.T.S.


DETAIL OF TURNING VANES

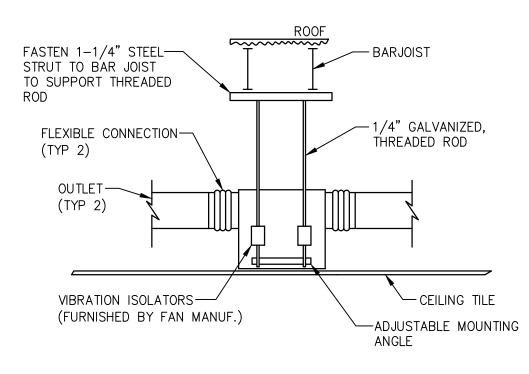


INLINE FAN DETAIL N.T.S.

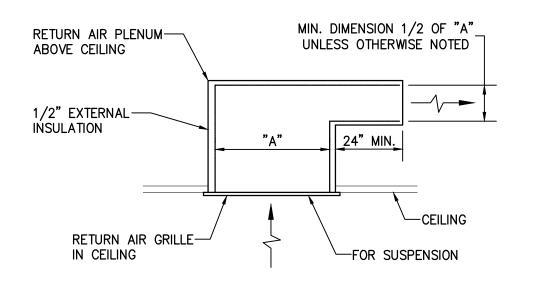


- 1. FACE RETURN AIR BOOT TOWARD AHU/ RTU RETURN AIR INLET WHERE CONSTRUCTION PERMITS. 2. LOCATE ADJACENT BOOTS AT RIGHT ANGLES TO EACH OTHER.
- SOUND ATTENUATING RETURN AIR BOOT

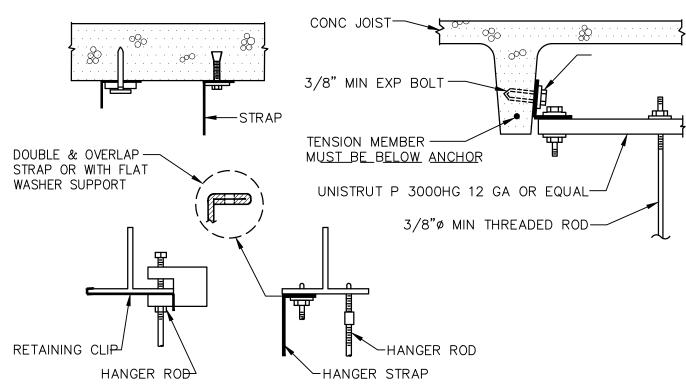

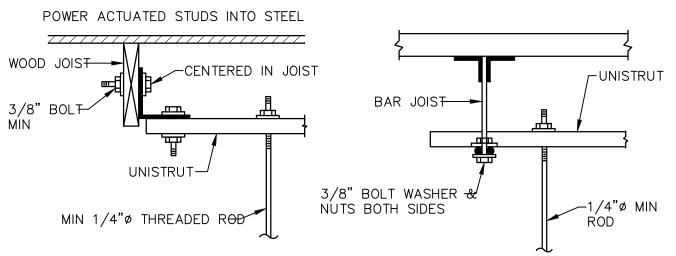


1. ALLOWABLE LOADS AND ELEMENT SIZING SEALED BY REGISTERED ENGINEER IN STATE OF NEW JERSEY.

UPPER ATTACHEMENT AND JOIST HANGERS FOR DUCTWORK DETAIL

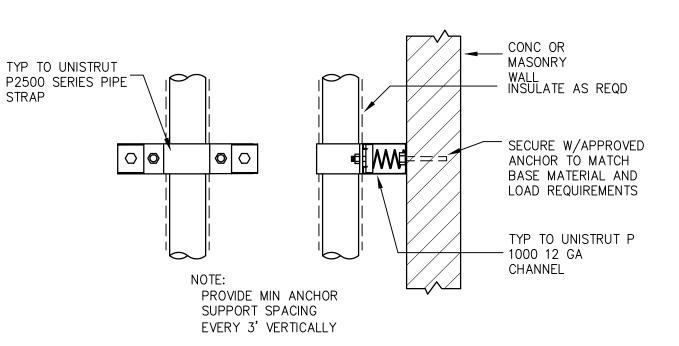

VERTICAL PIPE BRACKET SUPPORT

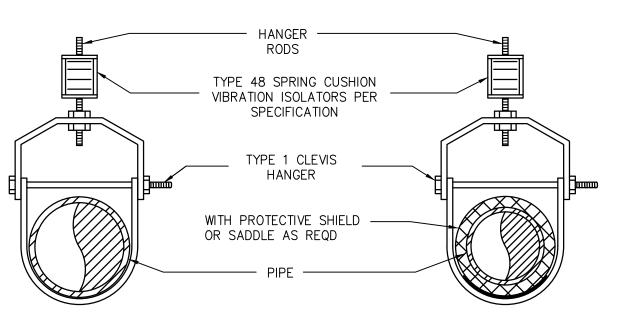

- 1. INSTALL PLUMB 2. BORE OF WASHER OR SPRING RETAINER
- TO BE SAME SIZE AS ROD 3. WELD WASHER OR SPRING RETAINER TO ROD


SINGLE PIPE TYPE 1 CLEVIS HANGER



ISSUED FOR BID DATE: 01-10-2025





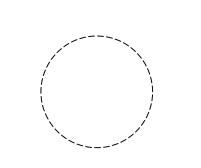

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NJ License No. Al 997600 JOHN BURGDORFER, RA, NCARB NJ License No. Al 12599

ROBERT E. McNAMARA, AIA

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SHEET CONTENTS:

MECHANICAL DETAILS

PROJECT TITLE:

SUBMISSION:

Checked by

Drawing No.


ob No.

RENOVATION FOR MAINTENANCE BUILDING **BURLINGTON COUNTY** 10 HARTFORD ROAD, DELRAN TWP. BURLINGTON CO. NJ

DATE	REVIS	SIONS	BY	CHKD
Date		10.08.24		•
Scale		AS SHOW	Ν	
Drawn	by	B.K.		

M-3.1

2241869

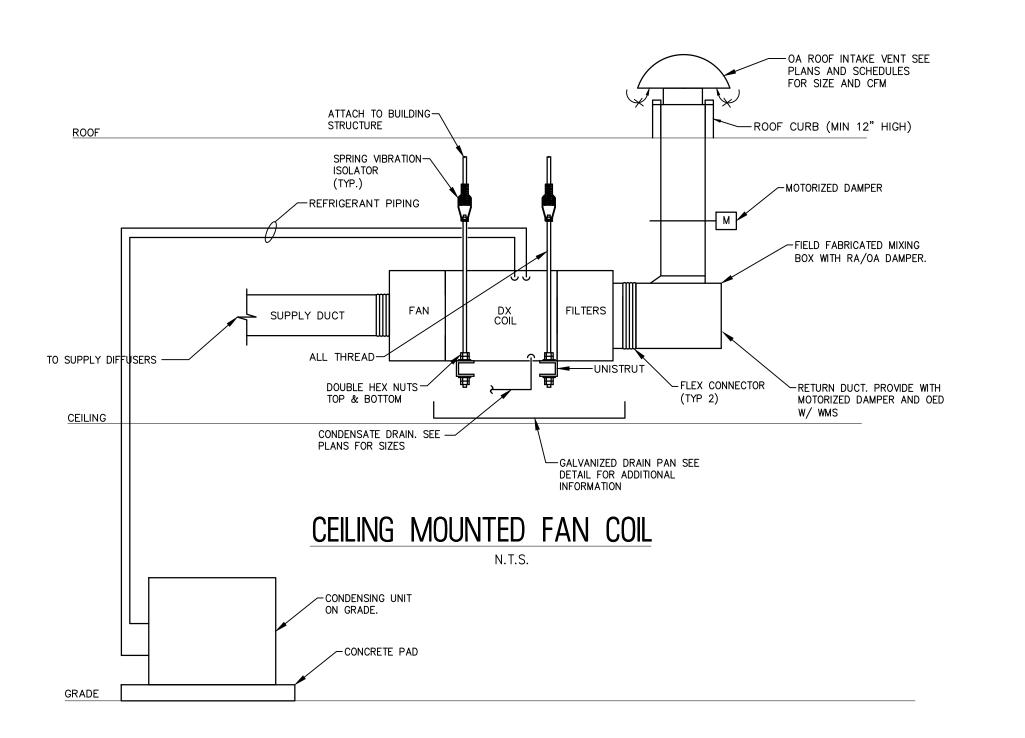

EQUIPMENT

-OVERFLOW DRAIN

SEE NOTE 5

-DO NOT REDUCE PIPE

SIZE FROM OUTLET

DRAIN PAN MAY BE SUPPORTED FROM-

SEAL DRAIN PAN WITH-

SOLDER FLANGE

TO INSIDE OF

DRAIN PAN

NEOPRENE WASHERS

AT SUPPORT RODS

1. CROSS BREAK BOTTOM OF SHEET METAL DRAIN PAN TO

2. SOLDER OR OTHERWISE SEAL ALL JOINTS TO MAKE DRAIN

4. FABRICATE DRAIN PAN FROM 24 GA GALV SHEET METAL

5. ROUTE DRAIN TO CODE APPROVED CONSPICUOUS LOCATION

AND PIPE SEPERATELY FROM CONDENSATE DRAIN PIPE

3. SUSPEND DRAIN PAN WITH EQUIPMENT SUPPORT RODS WHEN

POSSIBLE, OTHERWISE ATTACH WITH STRAPS TO EQUIPMENT

CONDENSATE OVERFLOW DRAIN PAN

PROVIDE SLOPED DRAINAGE TO OUTLET

PAN LEAK TIGHT

EQUIPMENT WITH METAL STRAPS


DRAIN PAN WITH BOTTOM

CONNECTED DRAIN PIPE

DRAIN PAN WITH SIDE CONNECTED DRAIN PIPE

NOTE 3

ATTACHED WITH METAL SCREWS SEE

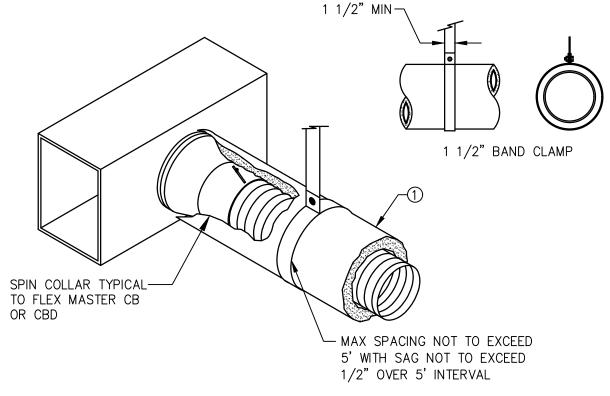


CALICE	TUIZ	1" STRAP	MAXIMUM
GAUGE	THK.	CAPABILITY	LOAD
24	.028	840	168
22	.034	1070	216
20	.040	1298	259

* ELASTIC LIMIT ASSUMED 30ksi; RECOMMEND MAX LOAD (20% OF YIELD STRENGTH).

1. FLEX DUCT WITH EXTERNAL INSULATION AND VAPOR BARRIER JACKETING.

SUGGESTED SUPPORT REQUIREMENTS FOR FLEX & STRAIGHT RECTANGULAR DUCT


___45° TAKE-OFF COLLAR (TYP. OF ALL DIFFUSERS) LOW PRESSURE-∠VOLUME DAMPER SUPPLY DUCT (TYP OF ALL DIFFUSERS) - FLEXIBLE DUCT (10'-0" MAXIMUM) -SUPPORT ON ALL SIDES OF CEILING STAINLESS STEEL-DIFFUSER STRAP CLAMP LAY-IN CEILING TILE LAY-IN CEILING -DIFFUSER — CEILING TILE SUPPORT STAINLESS STEEL-FLEXIBLE DUCT—— — GALVANIZED STEEL STRAP CLAMP (10'-0" MAXIMUM) PLENUM CEILING LINEAR DIFFUSER-FLEXIBLE BRANCH DUCT WORK

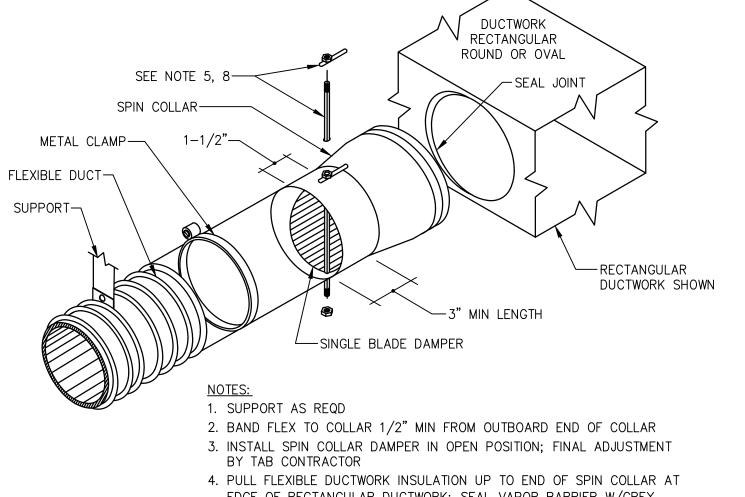

- EDGE OF RECTANGULAR DUCTWORK; SEAL VAPOR BARRIER W/GREY TAPE TO PREVENT MOISTURE MIGRATION
- 5. PROVIDE EXTENSION RODS TO ACCOMMODATE INSULATION, PULL TO EDGE OF DUCTWORK AS REQD AND SEAL TO EFFECT VAPOR BARRIER
- 6. POP RIVET OR SHEET METAL SCREWS, MIN 3 EA AT 120° INTERVALS, CONNECTING STOVEPIPE TO COLLAR. ENSURE RIVETS OR SCREWS DO NOT INTERFERE W/DAMPER
- 7. TAPE AND SEAL ALL JOINTS TO PREVENT LEAKAGE
- 8. INSTALL LOCKING QUADRANT AND HANDLE ON BOTTOM OF DUCT FOR EASY SERVICE (SHOWN ON TOP FOR EASE OF ILLUSTRATION ONLY)


SPIN COLLAR FLEXIBLE DUCT CONNECTOR WITH DAMPER

- 1. CONTRACTOR TO COORDINATE & VERIFY IN FIELD ALL MOUNTING LOCATIONS AND TYPES.
- 2. MOUNT AND ANCHOR CONDENSING UNIT ON EQUIPMENT PAD. CONDENSATE FROM INDOOR UNIT TO BE PIPED TO OUTDOORS. PROVIDE CONDENSATE PUMP, IF REQUIRED.
- 3. REFER TO DIVISION 15 SPECIFICATIONS FOR ADDITIONAL INFORMATION.

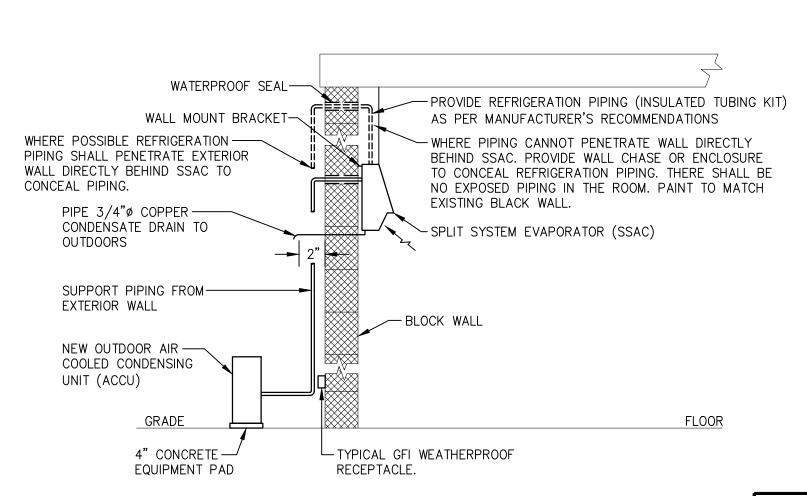

TYPICAL DUCTLESS SPLIT SYSTEM INSTALLATION DETAIL



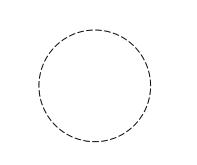

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SHEET CONTENTS:

MECHANICAL DETAILS

PROJECT TITLE:

RENOVATION FOR MAINTENANCE BUILDING **BURLINGTON COUNTY** 10 HARTFORD ROAD.DELRAN TWP. BURLINGTON CO. NJ

SUBMIS	SSION:		
XXX			
DATE	REVISIONS	BY	CHK

10.08.24 AS SHOWN B.K. Orawn by Checked b 2241869 ob No.

M-3.2

Drawing No.

ISSUED FOR BID DATE: 01-10-2025

VENTILATION SCHEDULE VENTILATION AIR REQUIREMENTS (ASHRAE 62, INTERNATIONAL MECH CODE 2021) EXHAUST AIR RETURN AIR SUPPLY AIR DUTDOOR AIR APPROX. | OCCUPANT NUMBER OF TOTAL PEOPLE AREA OUTDOOR ROOM NAME EQUIPMENT PEOPLE OUTDOOR TOTAL AREA BREATHING ZONE ZONE AIR ZONE AIR ZONE OUTDOOR PRIMARY CORRECTED DESIGN DESIGN DESIGN JUTDOOR AIRFLOW RATE DUTDOOR AIRFLOW DISTRIBUTION AIRFLOW OUTDOOR DESIGN TOTAL TOTAL TOTAL TAG AREA DENSITY PEOPLE & / AIRFLOW RATE OUTDOOR DISTRIBUTION AIRFLOW RATE EXHAUST TOTAL NUMBER (SF) # PEOPLE/ OR FIXTURES AIRFLOW AIRFLOW (CFM) Vbz EFFECTIVENESS EFFECTIVENESS (CFM) Voz AIR FRACTION AIRFLOW (CFM) Vot (CFM) (CFM) (CFM) 1000 SF (CFM) (COOLING) Ez (HEATING) Ez (CFM) (CFM) 557 L□BBY 101 FC-1 6 PEOPLE 3 CFM / PERSON 0.06 CFM/SQ FT N/A N/A FC-1/ EF-1 4 CFM / PERSON 400 2 PEOPLE 0.06 CFM/SQ FT 8.0 N/A 500 400 UNISEX BATHROOM 104 FC-1/ EF-1 N/A 48 N/A 1 FIXTURE N/A N/A N/A N/A N/A 70 CFM/FIXTURE FC-1/ EF-1 UNISEX BATHROOM 105 48 N/A N/A N/A N/A N/A N/A N/A N/A 70 CFM/FIXTURE 100 8.0 LOCKER ROOM 106 FC-1/ EF-1 163 N/A N/A 0.5 CFM/SQ.FT N/A 250 N/A 0.8 N/A 150 FC-1/ EF-1 78 N/A LOCKER ROOM 107 0.5 CFM/SQ.FT N/A N/A N/A N/A N/A 0.8 39 50 100 50 TOTAL

CONDE	NSING UNIT SCHEDULE														
TAG	EQUIPMENT	CDDLING		HEATING	CORRECTED COOLING	CORRECTED HEATING	IEER / EER	COP	APPR□XIMATE	UNIT	ELECTRICAL	MIN. CIRCUIT	MAX OVERCURRENT	BASIS OF DESIGN	NDTES
	SERVED	TONAGE	MBH	MBH	CAPACITY	CAPACITY	(MIN.)	(MIN.)	WEIGHT	DIMENSIONS (IN.)	V/PH/HZ	AMPACITY	PR□T. RTG.		
		NDMINAL	(TOTAL)	(TOTAL)	(MBH)	(MBH)			(LBS)	(H × W × D)		(AMPS)	(SAMA)		
CU-3	FC-1	8.0	96.0	108.0	97.8	81.0	22.15	3.61	653	71.62" × 48.87" × 29.16"	208/3/60	63.0	100	TRANE TPEFYP0960A140A	SEE BELOW
NDTES:	1. Nominal cooling capacities ar	re based on indoor	coil EAT of 80		outdoor of 95°F (DB)										

2. Nominal heating capacities are based on indoor coil EAT of 70°F (DB), outdoor of 43°F (WB)

3. Efficiency values for EER, IEER, COP are based on AHRI 1230 test method for mixture of ducted & non-ducted indoor units.

1. VENTILATION RATES ARE CALCULATED IN ACCORDANCE WITH SECTION 403 OF THE 2021 INTERNATIONAL MECHANICAL CODE.

4. Provide added field charge as required as per manufacturers requirements.

5. Corrected capacities shown are based on lowest guaranteed outdoor temperature.

6. Provide Panel Heater Kit to Prevent Ice Buildup on Outdoor Drain Pan

			TOTAL HEATING		INDOOR UNIT				DUTDOOR UNIT						1
TAG	ROOM SERVED	TYPE	CAPACITY	CAPACITY	CFM	APPROXIMATE UNIT	WEIGHT	MODEL	APPROXIMATE UNIT	WEIGHT	MDDEL	ELECTRICAL	SEER/EER	BASIS OF DESIGN	NOTE:
			(BTU/HR)	(BTU/HR)	(LOW TO HIGH)	DIMENSIONS (W \times D \times H) (IN)	(LBS)	NUMBER	DIMENSIONS (W \times D \times H) (IN)	(LBS)	NUMBER	V/PH/HZ		MANUFACTURER	1
SSAC-1/ CU-1	103	DUCTLESS	14,000	9,000	137-167-221-304-381	36-7/16 × 9-3/16 × 12 (+11/16)	29	NTXWPH06B112AA	31-1/2 × 11-1/4 × 21-5/8	83	NTXSPB06B112AA	208/1/60	32.2/19.0	TRANE	1,2,3,4,
SSAC-2/ CU-2	102	DUCTLESS	14,000	9,000	137-167-221-304-381	36-7/16 × 9-3/16 × 12 (+11/16)	29	NTXWPH06B112AA	31-1/2 × 11-1/4 × 21-5/8	83	NTXSPB06B112AA	208/1/60	32.2/19.0	TRANE	1,2,3,4,

PROVIDE UNITS WITH WALL MOUNTED REMOTE CONTROLLER KIT BY MITSUBISHI/TRANE, REFRIGERANT PIPING AND CHARGE, MOUNTING EQUIPMENT, AND ALL OTHER ACCESSORIES REQUIRED TO OPERATE AND INSTALL UNIT.

B. PROVIDE UNIT WITH CONDENSATE PUMP. PROVIDE CONDENSATE PUMPS ABOVE CEILING WITH STAINLESS STEEL DRAIN PAN AND OVERFLOW ALARM.

H. NOMINAL COOLING CAPACITIES ARE BASED ON INDOOR COIL EAT OF 80/67°F (DB/WB), OUTDOOR OF 95°F (DB). 5. NOMINAL HEATING CAPACITIES ARE BASED ON INDOOR COIL EAT OF 70°F (DB), OUTDOOR OF 43°F (WB).

ELEC	TRIC DUCT HEA	ATER SCHEDU	JLE											
											ELECTRICAL			
TAG	UNITS SERVED	HEATER	AIRFLOW	MAXIMUM STATIC	INSIDE DUCT	INSIDE DUCT								
		TYPE	(CFM)	STATIC PRESSURE	WIDTH REQUIRED	HEIGHT REQUIRED	EAT	LAT	мвн	KW	V/PH/HZ	AMPS	BASIS OF DESIGN	NOTES
				LOSS (IN. W.C.)	(IN.)	(IN.)								
EDH-1	FC-1	FINNED TUBULAR	1200	0.10	20	10	55	90	45.4	13.50	208/3/60	37.47	WARREN CBK	1, 2, 3, 4, 5, 6 & 7
NDTES:	1. PROVIDE WITH DIS	SCONNECT SWITCH, S	STARTER/CONTACT	OR AND AIRFLOW SWI	ГСН.			•	•	•				

2. PR□VIDE WITH SCR C□NTR□L WITH 0-10VDC INPUT AND PR□P□RTI□NAL C□NTR□L.

PROVIDE WITH AUTOMATIC AND MANUAL THERMAL CUTOUT.

4. PR□VIDE WITH DRY C□NTACT F□R REM□TE HEATER ENABLE AND C□NTR□L CIRCUIT TRANSF□RMER.

5. HEATER SHALL BE U.L. LISTED. PROVIDE WITH FUSES.

7. PROVIDE WITH 304 STAINLESS STEEL ELEMENTS.

EXHA	UST FAN SCHEDULE												
	ROOMS	FAN		TOTAL S.P.	MAX.	MOTOR HP	DRI∨E	ELECTRICAL		ROOF / WALL	APPROXIMATE	BASIS	
TAG	SERVED/SERVICE	TYPE	CFM	(in. w.⊂.)	RPM	OR WATTS	TYPE	V/PH/HZ	SONES	OPENING SIZE	WEIGHT (LBS)	□F DESIGN	NOTES
EF-1	101,104,105,106,107	INLINE	1,050	0.2	1137	1/3	DIRECT	115/1/60	1.9	24"×14"	49	GREENHECK CSP-A1050-VG	1
NOTES:													,

PROVIDE FAN WITH ALUMINUM WHEEL, GALVANIZED STEEL HOUSING, GRAVITY BACKDRAFT DAMPER, FAN SPEED CONTROLLER, UNIT MOUNTED DISCONNECT SWITCH IN NEMA 1 ENCLOSURE (WITH INTEGRAL STARTER), HANGING VIBRATION ISOLATORS, FLEX DUCT CONNECTIONS, INSULATED HOUSING, MOUNTING ACCESSORIES,

AND ALL OTHER DEVICES AND ACCESSORIES REQUIRED TO INSTALL AND OPERATE FAN.

FAN C	OIL SCHEDULE	•													
				DESIGN	UNIT	DESIGN	DESIGN TONS								
TAG	ROOM(S) SERVED	MOUNTING	SERVED BY	SUPPLY	SUPPLY	DUTDOOR		MAX. COOLING	MAX. HEATING	APPROXIMATE	BASIS OF DESIGN	ELECTRICAL	MCA	M□CA	NOTES
		LOCATION	CONDENSING	AIRFLOW	AIRFLOW	AIRFLOW		CAPACITY	CAPACITY	DIMENSIONS		V/PH/HZ			l
			UNIT	(CFM)	(CFM)	(CFM)		(MBH)	(BTUH)	$(H \times W \times D)$					ı
FC-1	100,101,106,107	CEILING	CU-3	1200	1200	1,200	8	96	57	18.5" × 49.25" × 44.13"	TRANE TPEFYP0960A140A	208/1/60	4.8	15	SEE BELOW
NDTES:	1. PROVIDE SYSTEM WIT	H TEMPERATURE	& HUMIDITY SENSO	RS, CONTROL	LERS, REFRIGE	RANT PIPING	AND CHARGE,	AUXILIARY DRAIN P	AN, AND ALL REQU	JIRED MOUNTING ACCESSORIES	. PROVIDE ALL CONTROL				
	DEVICES REQUIRED	TO OPERATE EG	UIPMENT IN ACCOR	DANCE WITH	THE SEQUENCE	OF OPERATION	□NS.								
	3. PROVIDE WITH SECON	NDARY DRAIN PAN	N AND WATER LEVE	L ALARM											

GRAV	ITY VENTILATOR	RSCHEDI	JLE							
TAG	SERVICE	SYSTEM(S)	CFM	ROOF	THROAT AREA	NUMBER	INTAKE	HOOD	BASIS OF DESIGN	NOTES
		SERVED		□PENING	(SQ, FT.)	OF TIERS	AREA (SQ. FT.)	SIZE		
GI∨−1	INTAKE	FC-1	1,200	26" ×26"	1.4	1	3.02	29″ DIA.	GREENHECK GRSI-16	1
GR∨−1	RELIEF	EXHAUST	1,050	12 " ×18 "	1.5	1	N/A	26"× 39"	GREENHECK GRM-FGR	1

NOTES: 1. PROVIDE WITH BIRDSCREEN, ROOF CURB, AND AUTOMATIC BACKDRAFT DAMPER

TAG	DESCRIPTION	FACE	NECK	DIRECTION		BASIS OF DESIGN	
					MANUFACTURER	MODEL NUMBER	NOTES
Α	DIFFUSER	24"×24"	8″ø	SUPPLY	PRICE	ASCD	1,2,3,4,5
В	DIFFUSER	24"×24"	6″ø	SUPPLY	PRICE	ASCD	1,2,3,4,5
С	REGISTER	12"×12"	12"×12"	EXHAUST	PRICE	80	1,2,3,4,5
D	REGISTER	12"×10"	12"×10"	EXHAUST	PRICE	80	1,2,3,4,5
E	REGISTER	10"×8"	10"×8"	EXHAUST	PRICE	80	1,2,3,4,5
F	REGISTER	24"×24"	24"×24"	RETURN	PRICE	630	1,2,3,4,5
G	REGISTER	12"×12"	12"×12"	RETURN	PRICE	630	1,2,3,4,5
Н	REGISTER	16"×16"	16"×16"	RETURN	PRICE	630	1,2,3,4,5

NOTES: 1. COORDINATE MOUNTING FRAME WITH CEILING/WALL TYPE.

2. COORDINATE COLOR & FINISH WITH ARCHITECT.

3. PROVIDE GRILLE WITH BORDER FLANGE FOR LAY-IN TYPE CEILINGS. SEE PLANS FOR LOCATIONS.

4. PROVIE FIELD FABRICATED FILTER BOX. COORDINATE LOCATION FOR SERVICING AND ACCESSIBILITY.


4. PROVIDE WITH ALUMINUM OPPOSED BLADE DAMPERS. 5. NC (NDISE CRITERIA) LEVEL MAY BE ND GREATER THAN 25.

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RESULTING THEREFROM

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SHEET CONTENTS:

MECHANICAL SCHEDULES

PROJECT TITLE:

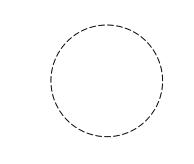SUBMISSION:

Drawing No.

RENOVATION FOR MAINTENANCE BUILDING **BURLINGTON COUNTY** 10 HARTFORD ROAD, DELRAN TWP. BURLINGTON CO. NJ


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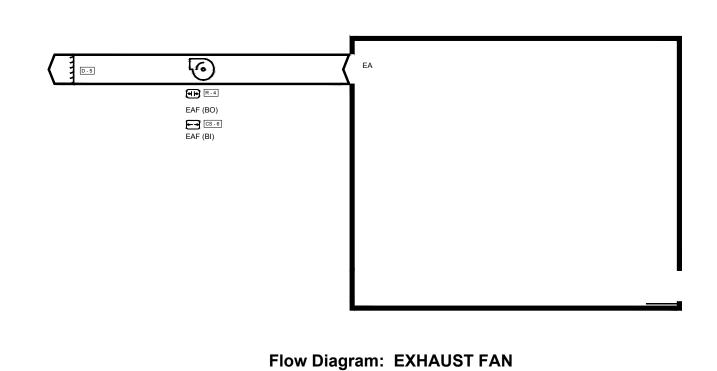
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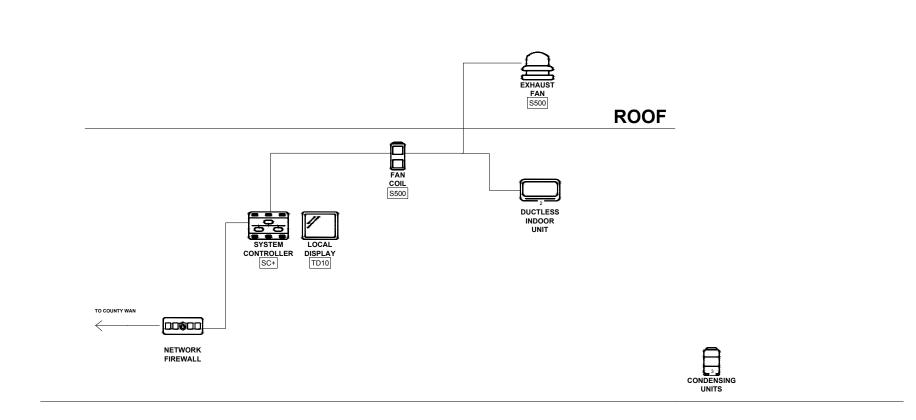
System Point Description		POINTS					ALARMS								
	GRAPHIC	ANALOG HARDWARE INPUT (AI)	BINARY HARDWARE INPUT (BI)	ANALOG HARDWARE OUTPUT (AO)	BINARY HARDWARE OUTPUT (BO)	SOFTWARE POINT (SFT)	HARDWARE INTERLOCK (HDW)	WIRELESS (WLS)	NETWORK (NET)	HIGH ANALOG LIMIT	LOW ANALOG LIMIT	BINARY	LATCH DIAGNOSTIC	SENSOR FAIL	COMMUNICATION FAIL
SUPPLY FAN	X	4	M	X	M	S	T	>	Z	I		m		S	O
SF COMPRESSOR COMMAND					V										
COMPRESSOR COMMAND CMP					X										
CONDENSATE OVERFLOW	X		X									X	X		
DETECTION LOCAL															
CND OVRFL	V	V								V	V			V	
DISCHARGE AIR TEMPERATURE DAT	X	X								X	X			X	
ELECTRIC HEAT SCR	X			X											
SCR															
OUTDOOR AIR DAMPER OAD	X			X											
RETURN AIR DAMPER	X			X											
RAD															
REVERSING VALVE	X				X										
REV VLV	X	X													
SPACE HUMIDITY LOCAL SPH	^	^													
SPACE TEMPERATURE LOCAL SPT	X	X								X	X			X	
SPACE TEMPERATURE SETPOINT	X	X													
LOCAL															
SPT SP BAS COMMUNICATION STATE						X									X
BAS COM															
FILTER TIMER HOURS						X						X	X		
FIL HRS MAINTENANCE DECLUDED						X						X			
MAINTENANCE REQUIRED MNT REQ						^						^			
SPACE TEMPERATURE SETPOINT	X					X									
ACTIVE															
SPT SP ACT						X									
OCCUPIED BYPASS TIMER OCC TMR						^									
OCCUPANCY BAS	X								X						
OCC BAS															

Points List: FAN COIL

		SPT (AI) SPH (AI) OCC BAS (NET)
RAD (AO)		RA
OAD (AO) OA OA TMR	%	DAT (AI)
	CMP (BO) REV VLV (BO) CND OVRFL (BI)	SF (AO)
Flow Diagrar	n: FAN COIL	






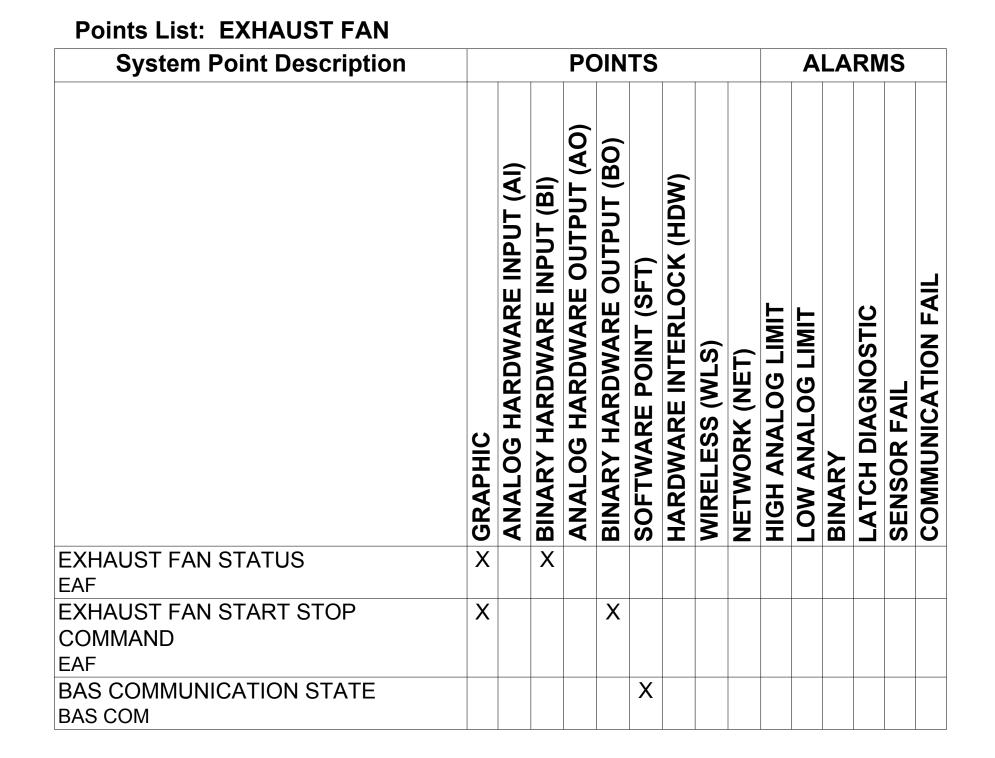

BUILDING AUTOMATION SYSTEM CONTROL SCHEMATIC





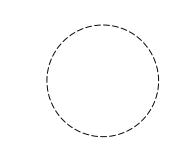

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PROJECT TITLE:

RENOVATION FOR MAINTENANCE BUILDING **BURLINGTON COUNTY** 10 HARTFORD ROAD, DELRAN TWP. BURLINGTON CO. NJ


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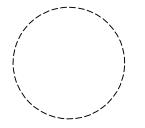
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Checked	d by			
Job No	•	2241869		
Drawing	No.			

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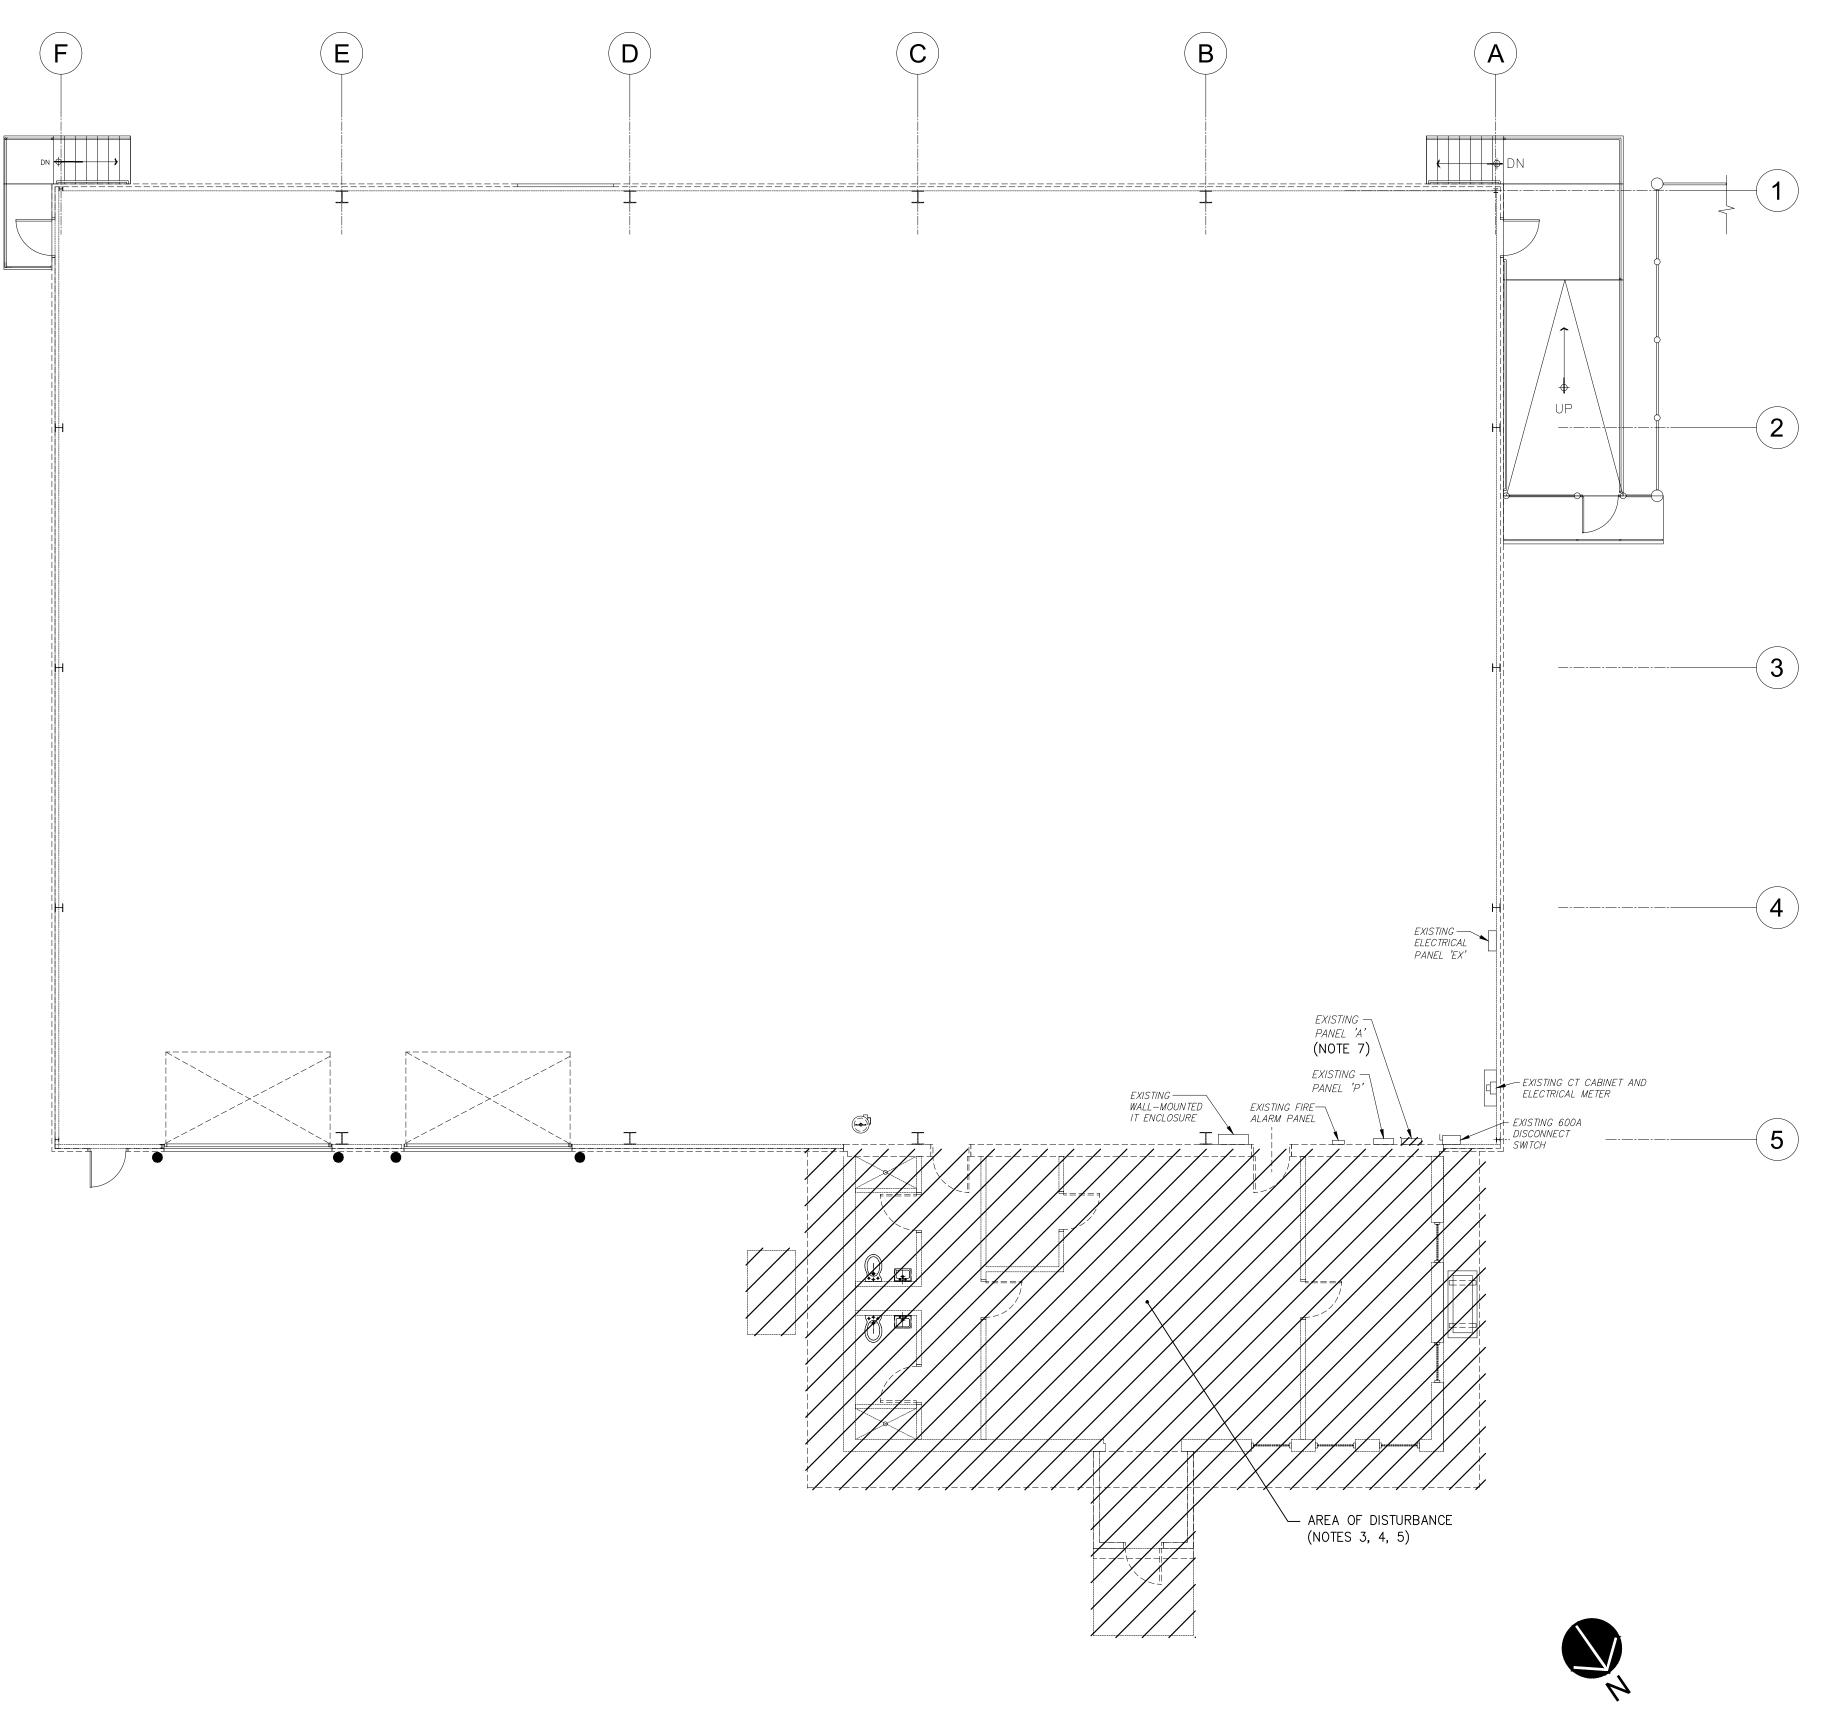
ELECTRICAL COVER

RENOVATION FOR MAINTENANCE BUILDING **BURLINGTON COUNTY** 10 HARTFORD ROAD, DELRAN TWP.

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NJ PROFESSIONAL ENGINEER LIC. No. 56794

DATE: 01-10-2025

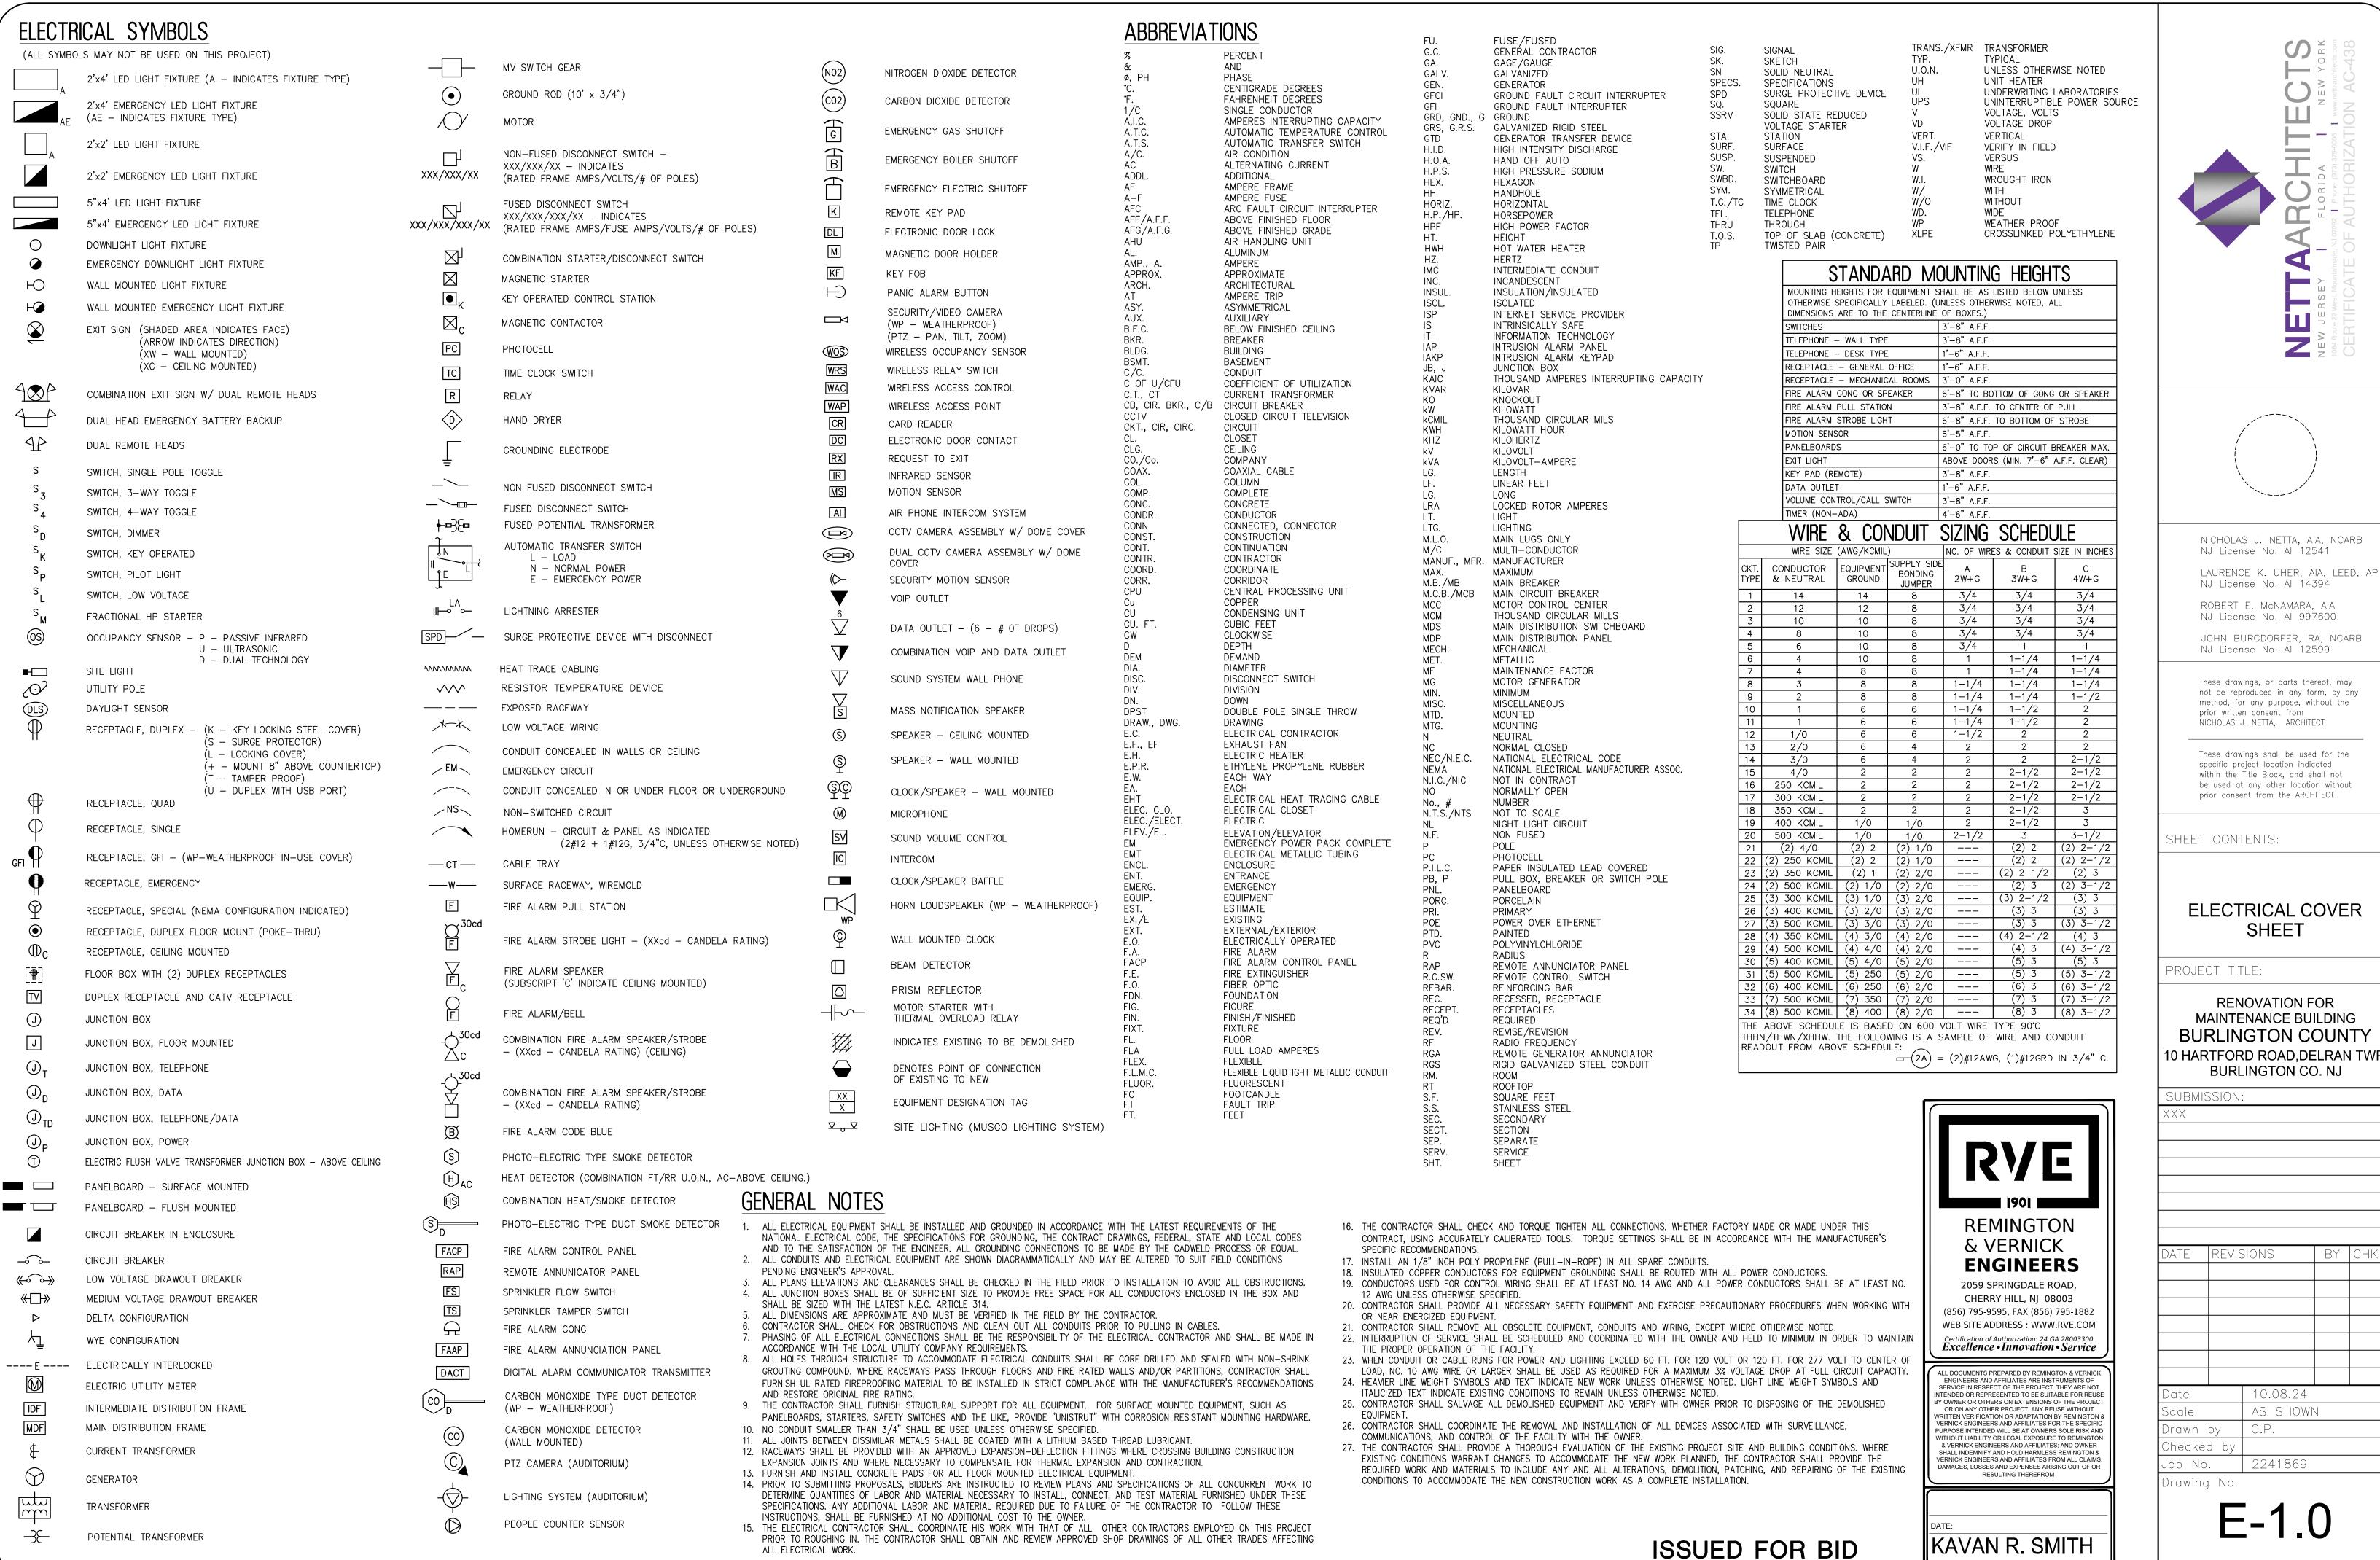

ELECTRICAL DEMOLITION FLOOR PLAN

SCALE: 1/8"=1'-0"

DEMOLITION NOTES:

- 1. ALL NOTES, SYMBOLS, AND ABBREVIATIONS ON DRAWING E-1.0 APPLY TO THIS DRAWING. 2. THIS DEMOLITION PLAN HAS BEEN PROVIDED AS A GUIDE. HOWEVER, ALL DEMOLITION REQUIRED TO SUCCESSFULLY COMPLETE THIS PROJECT SHALL BE INCLUDED IN THE SCOPE OF WORK. IT IS THE INTENT OF THE PLANS AND SPECIFICATIONS TO SECURE A COMPLETELY INTERCONNECTED AND FUNCTIONING SYSTEM AND IF ANY WORKMANSHIP OR MATERIALS ARE REQUIRED WHICH ARE OBVIOUSLY NECESSARY TO CARRY OUT THE FULL INTENT AND MEANING OF THE PLANS AND SPECIFICATIONS OR TO BE REASONABLY INFERRED THEREFROM, THE COST OF SUCH WORKMANSHIP OR MATERIALS SHALL BE INCLUDED IN THE SCOPE OF WORK.
- 3. CONTRACTOR SHALL PROVIDE ALL NECESSARY CONSTRUCTION, DEMOLITION AND DISRUPTION TEMPORARY POWER BY MEANS OF PORTABLE GENERATOR(S) TO MAINTAIN ADEQUATE ELECTRICAL POWER REQUIREMENTS FOR THE DURATION OF DEMOLITION AND RENOVATION FOR NEW OFFICE SPACE.
- 4. CONTRACTOR SHALL DEMOLISH ALL EXISTING ELECTRICAL INFRASTRUCTURE THAT INCLUDE ALL CONDUCTORS, CONDUITS, JUNCTION BOXES, PANELBOARDS, RACEWAYS, ETC. IN ITS ENTIRELY BACK TO SOURCE.
- 5. ELECTRICAL CONTRACTOR SHALL COORDINATE WITH MECHANICAL CONTRACTOR FOR THE DISCONNECTION AND REMOVAL OF ALL HVAC CONDENSING UNITS, SPLIT SYSTEM UNITS, ETC.
- DEMOLISH EXISTING WIRING, RACEWAYS, CONTROLS, ETC. BACK TO SOURCE. 6. THE CONTRACTOR IS RESPONSIBLE FOR REPAIRING, REPLACING AND RESTORING ANY AREAS OF FLOOR, CEILING AND/OR WALLS DAMAGED AS A RESULT OF NEW WORK. RESTORED, REPAIRED, OR REPLACED AREAS SHALL BE RESTORED TO A CONDITION EQUAL TO OR

ISSUED FOR BID

DATE: 01-10-2025

BETTER THAN THEIR ORIGINAL CONDITION. 7. CONTRACTOR SHALL DISCONNECT AND SALVAGE EXISTING CIRCUITS IN EXISTING PANEL 'A'. CONTRACTOR SHALL DEMOLISH EXISTING PANEL 'A' AND PREP FOR NEW.



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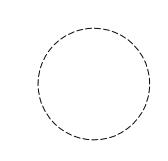
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KAVAN R. SMITH

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ROBERT E. McNAMARA, AIA NJ License No. Al 997600

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SHEET CONTENTS:

ELECTRICAL DEMOLITION FLOOR PLAN

PROJECT TITLE:

RENOVATION FOR MAINTENANCE BUILDING **BURLINGTON COUNTY** 10 HARTFORD ROAD, DELRAN TWP. BURLINGTON CO. NJ

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DATE	REVISIONS	BY	СНК


10.08.24 AS SHOWN LC.P. Drawn by Checked by

2241869

Drawing No.

ob No.

E-1.1

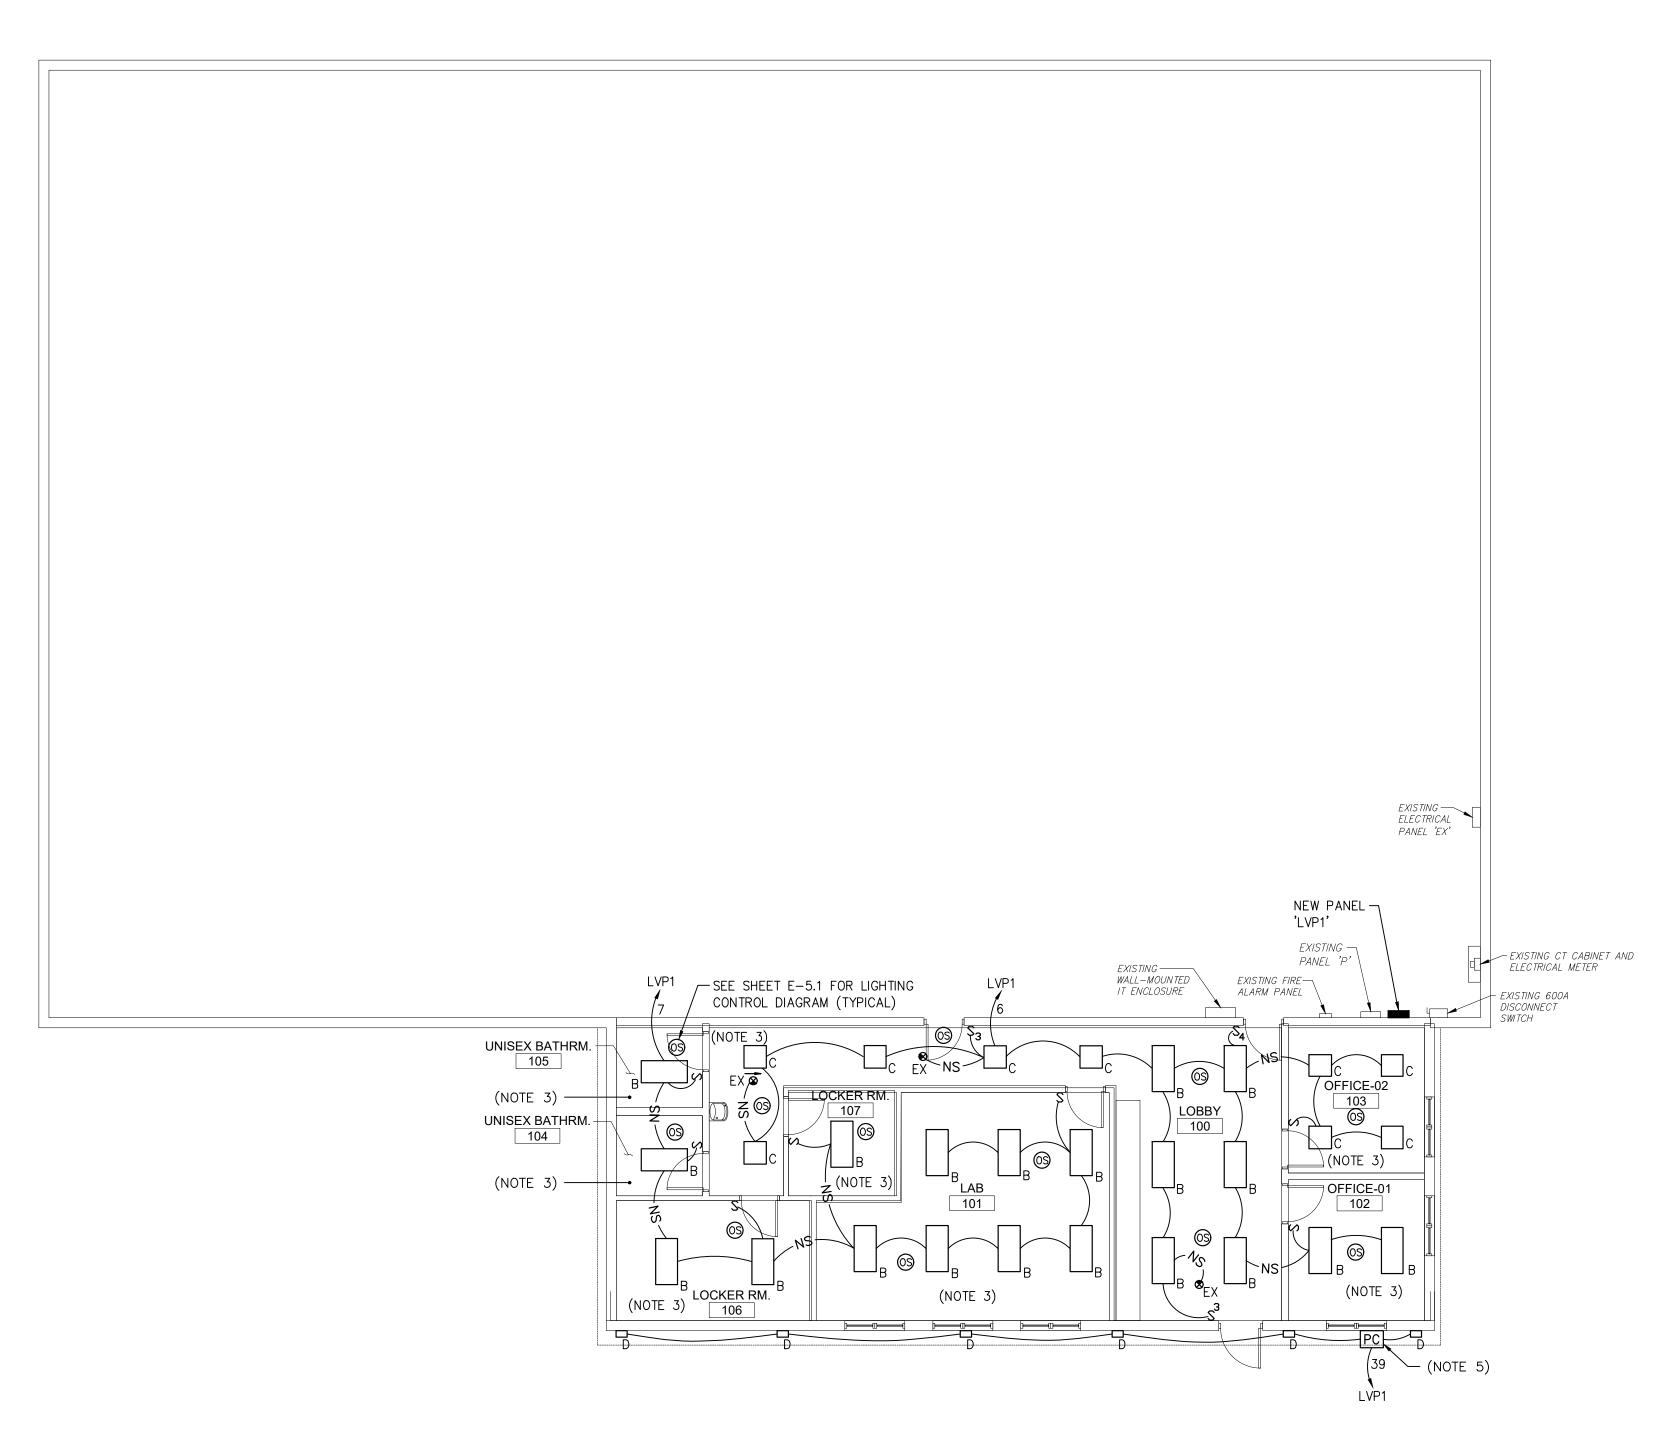

ELECTRICAL LIGHTING FLOOR PLAN

NOTES:

- 1. ALL NOTES, SYMBOLS, AND ABBREVIATIONS ON DRAWING E-1.0 APPLY TO THIS DRAWING. 2. THIS DRAWING IS DIAGRAMMATIC, IT IS THE CONTRACTOR'S RESPONSIBILITY TO CONFIRM EXISTING SITE CONDITIONS AND INSTALLATION CLEARANCES PRIOR TO SHOP DRAWING SUBMISSIONS AND INSTALLATION. SHOULD THE CONTRACTOR DETERMINE THAT THE INSTALLATION OF ANY ELECTRICAL COMPONENT IS RESTRICTED OR NOT ABLE TO BE INSTALLED IN THE SUGGESTED LOCATION, THE CONTRACTOR SHALL READDRESS THE INSTALLATION ACCORDINGLY AND IN COMPLIANCE WITH THE MOST RECENTLY ADOPTED NATIONAL ELECTRICAL CODE APPROVED BY THE AUTHORITY HAVING JURISDICTION AT NO ADDITIONAL COST.
- 3. CONTRACTOR SHALL REFER TO ARCHITECTURAL DRAWING A-601 REFLECTED CEILING PLAN FOR LIGHTING FIXTURE SCHEDULE AND LIGHTING FIXTURE LOCATIONS. 4. PROVIDE 0-10V DIMMING CONTROL WIRING AS REQUIRED.
- 5. PROVIDE SURFACE MOUNTED PHOTOCELL FOR EXTERIOR LIGHTING FIXTURES.



& VERNICK **ENGINEERS**

2059 SPRINGDALE ROAD, CHERRY HILL, NJ 08003 (856) 795-9595, FAX (856) 795-1882 WEB SITE ADDRESS: WWW.RVE.COM Certification of Authorization: 24 GA 28003300 Excellence • Innovation • Service

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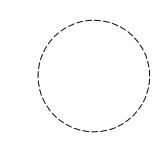
KAVAN R. SMITH NJ PROFESSIONAL ENGINEER LIC. No. 56794

C.P. Drawn by Checked by 2241869 ob No. Drawing No. E-2.1

AS SHOWN

ISSUED FOR BID DATE: 01-10-2025





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SHEET CONTENTS:


ELECTRICAL LIGHTING FLOOR PLAN

PROJECT TITLE:

SUBMISSION:

RENOVATION FOR MAINTENANCE BUILDING **BURLINGTON COUNTY** 10 HARTFORD ROAD, DELRAN TWP. BURLINGTON CO. NJ

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ELECTRICAL POWER FLOOR PLAN

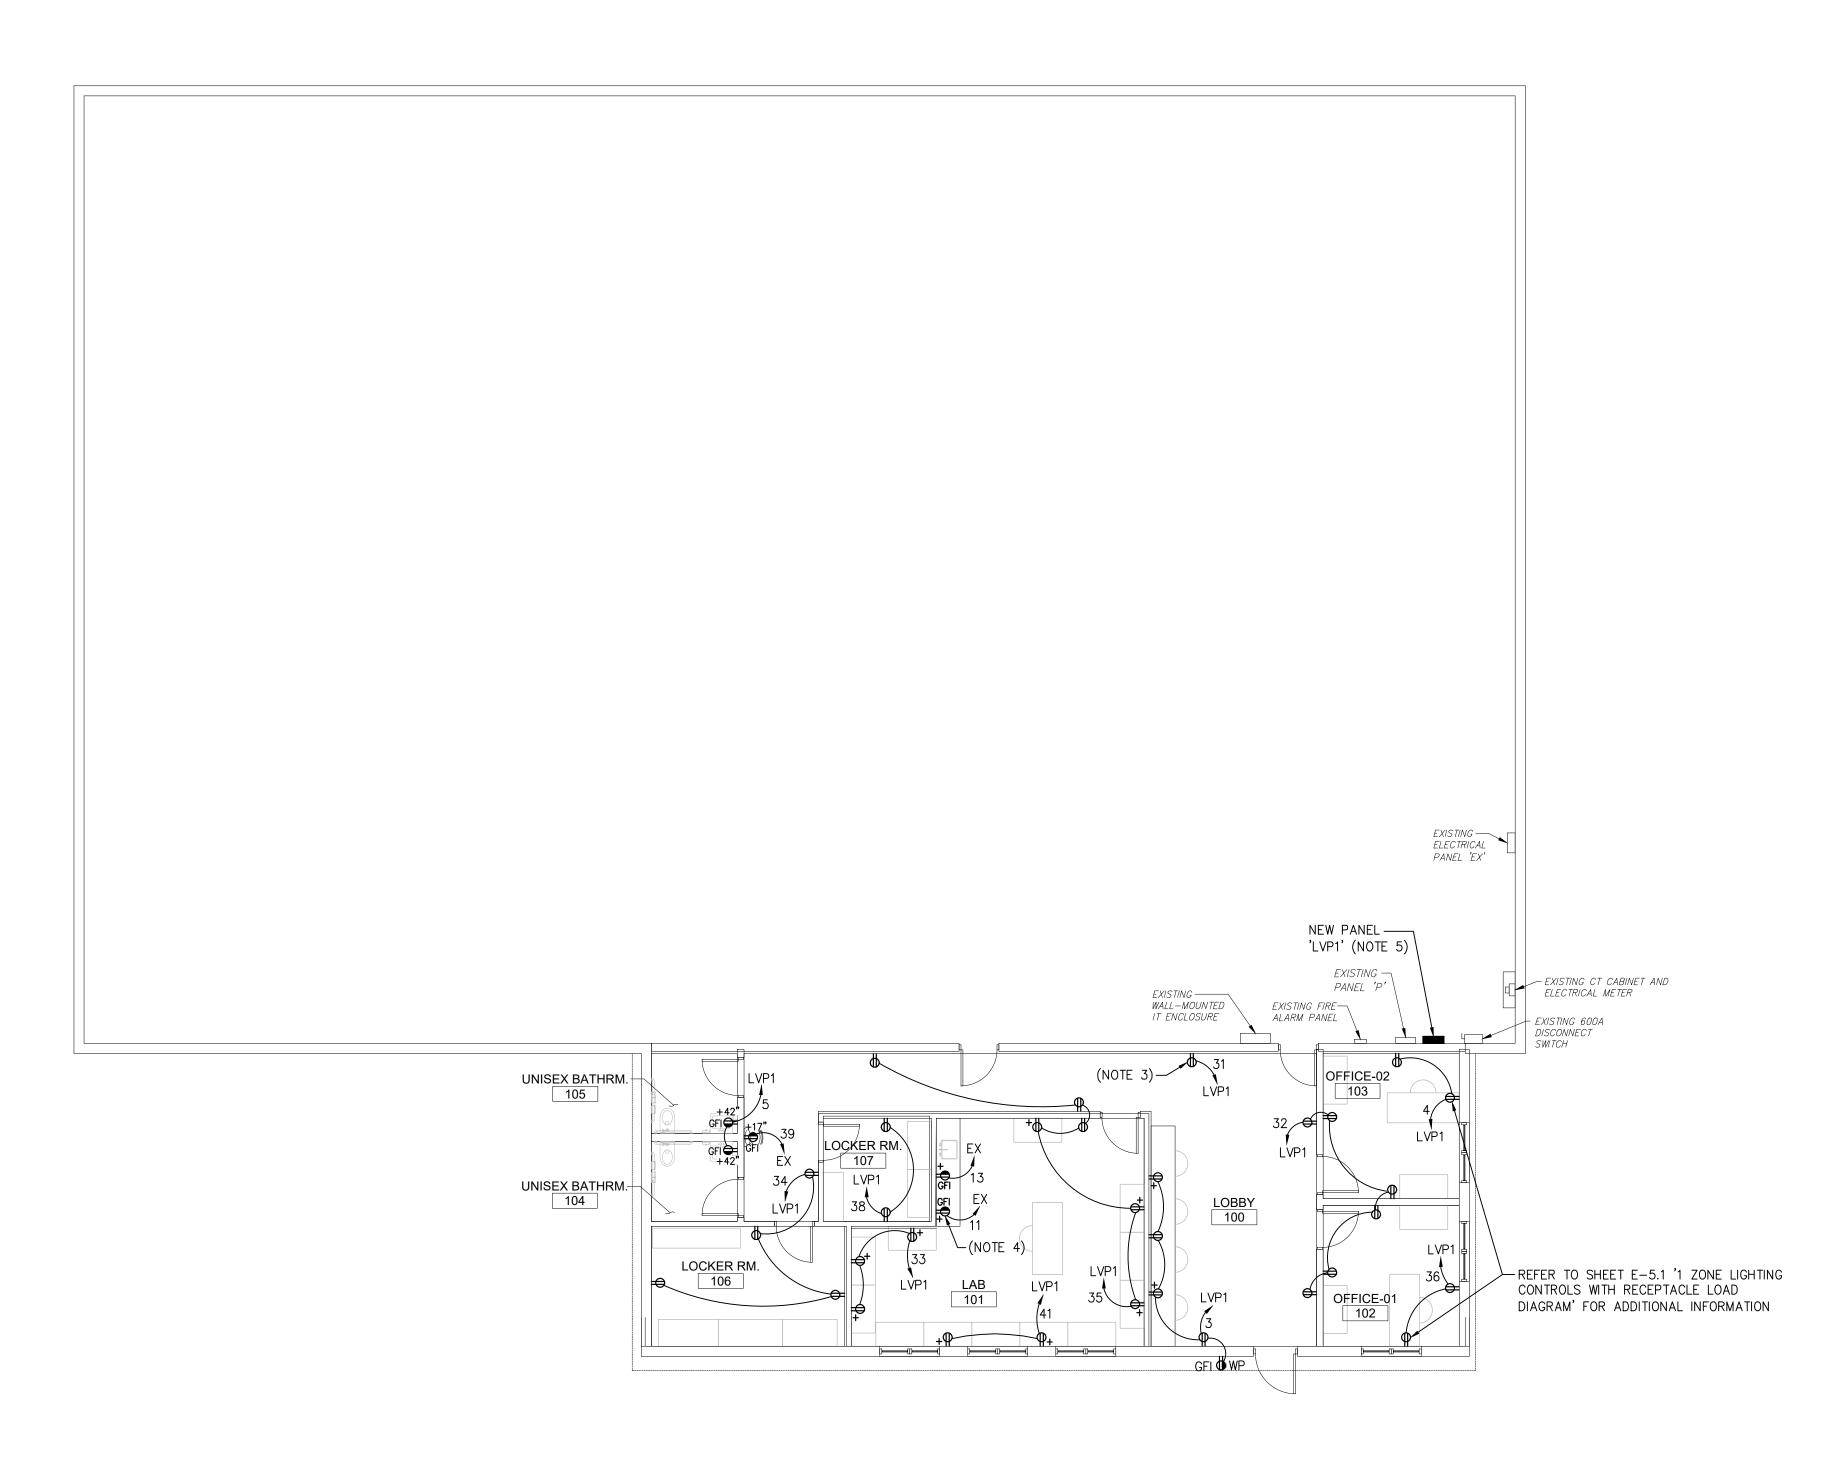- 2. THIS DRAWING IS DIAGRAMMATIC, IT IS THE CONTRACTOR'S RESPONSIBILITY TO CONFIRM EXISTING SITE CONDITIONS AND INSTALLATION CLEARANCES PRIOR TO SHOP DRAWING SUBMISSIONS AND INSTALLATION. SHOULD THE CONTRACTOR DETERMINE THAT THE INSTALLATION OF ANY ELECTRICAL COMPONENT IS RESTRICTED OR NOT ABLE TO BE INSTALLED IN THE SUGGESTED LOCATION, THE CONTRACTOR SHALL READDRESS THE INSTALLATION ACCORDINGLY AND IN COMPLIANCE WITH THE MOST RECENTLY ADOPTED
- ADDITIONAL COST. 3. COORDINATE EXACT LOCATION OF PRINTER PRIOR TO ROUGH-IN INSTALLATION OF
- DEDICATED DUPLEX RECEPTACLE WITH OWNER. 4. COORDINATE EXACT LOCATION OF MICROWAVE PRIOR TO ROUGH-IN INSTALLATION OF DEDICATED GFI DUPLEX RECEPTACLE WITH OWNER.

ISSUED FOR BID

DATE: 01-10-2025

'LVP1'. CONTRACTOR SHALL EXTEND/PROVIDE ALL NECESSARY HARDWARE, RACEWAYS, WIRING, AND ALL ELECTRICAL DEVICÉS FOR A COMPLETE INSTALLATION.



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KAVAN R. SMITH NJ PROFESSIONAL ENGINEER LIC. No. 56794

BURLINGTON COUNTY 10 HARTFORD ROAD, DELRAN TWP. SUBMISSION: ATE REVISIONS 2059 SPRINGDALE ROAD,

> 10.08.24 AS SHOWN C.P. Drawn by Checked by 2241869 ob No.

Drawing No.

E-3.1

NICHOLAS J. NETTA, AIA, NCARB

LAURENCE K. UHER, AIA, LEED, AP

JOHN BURGDORFER, RA, NCARB NJ License No. Al 12599

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RENOVATION FOR

MAINTENANCE BUILDING

BURLINGTON CO. NJ

I BY ICHKE

prior written consent from NICHOLAS J. NETTA, ARCHITECT.

SHEET CONTENTS:

PROJECT TITLE:


NJ License No. Al 12541

NJ License No. Al 14394

ROBERT E. McNAMARA, AIA NJ License No. Al 997600

NOTES:

- 1. ALL NOTES, SYMBOLS, AND ABBREVIATIONS ON DRAWING E-1.0 APPLY TO THIS DRAWING. NATIONAL ELECTRICAL CODE APPROVED BY THE AUTHORITY HAVING JURISDICTION AT NO
- 5. CONTRACTOR SHALL RECONNECT EXISTING SALVAGED CIRCUIT WIRING TO NEW PANEL

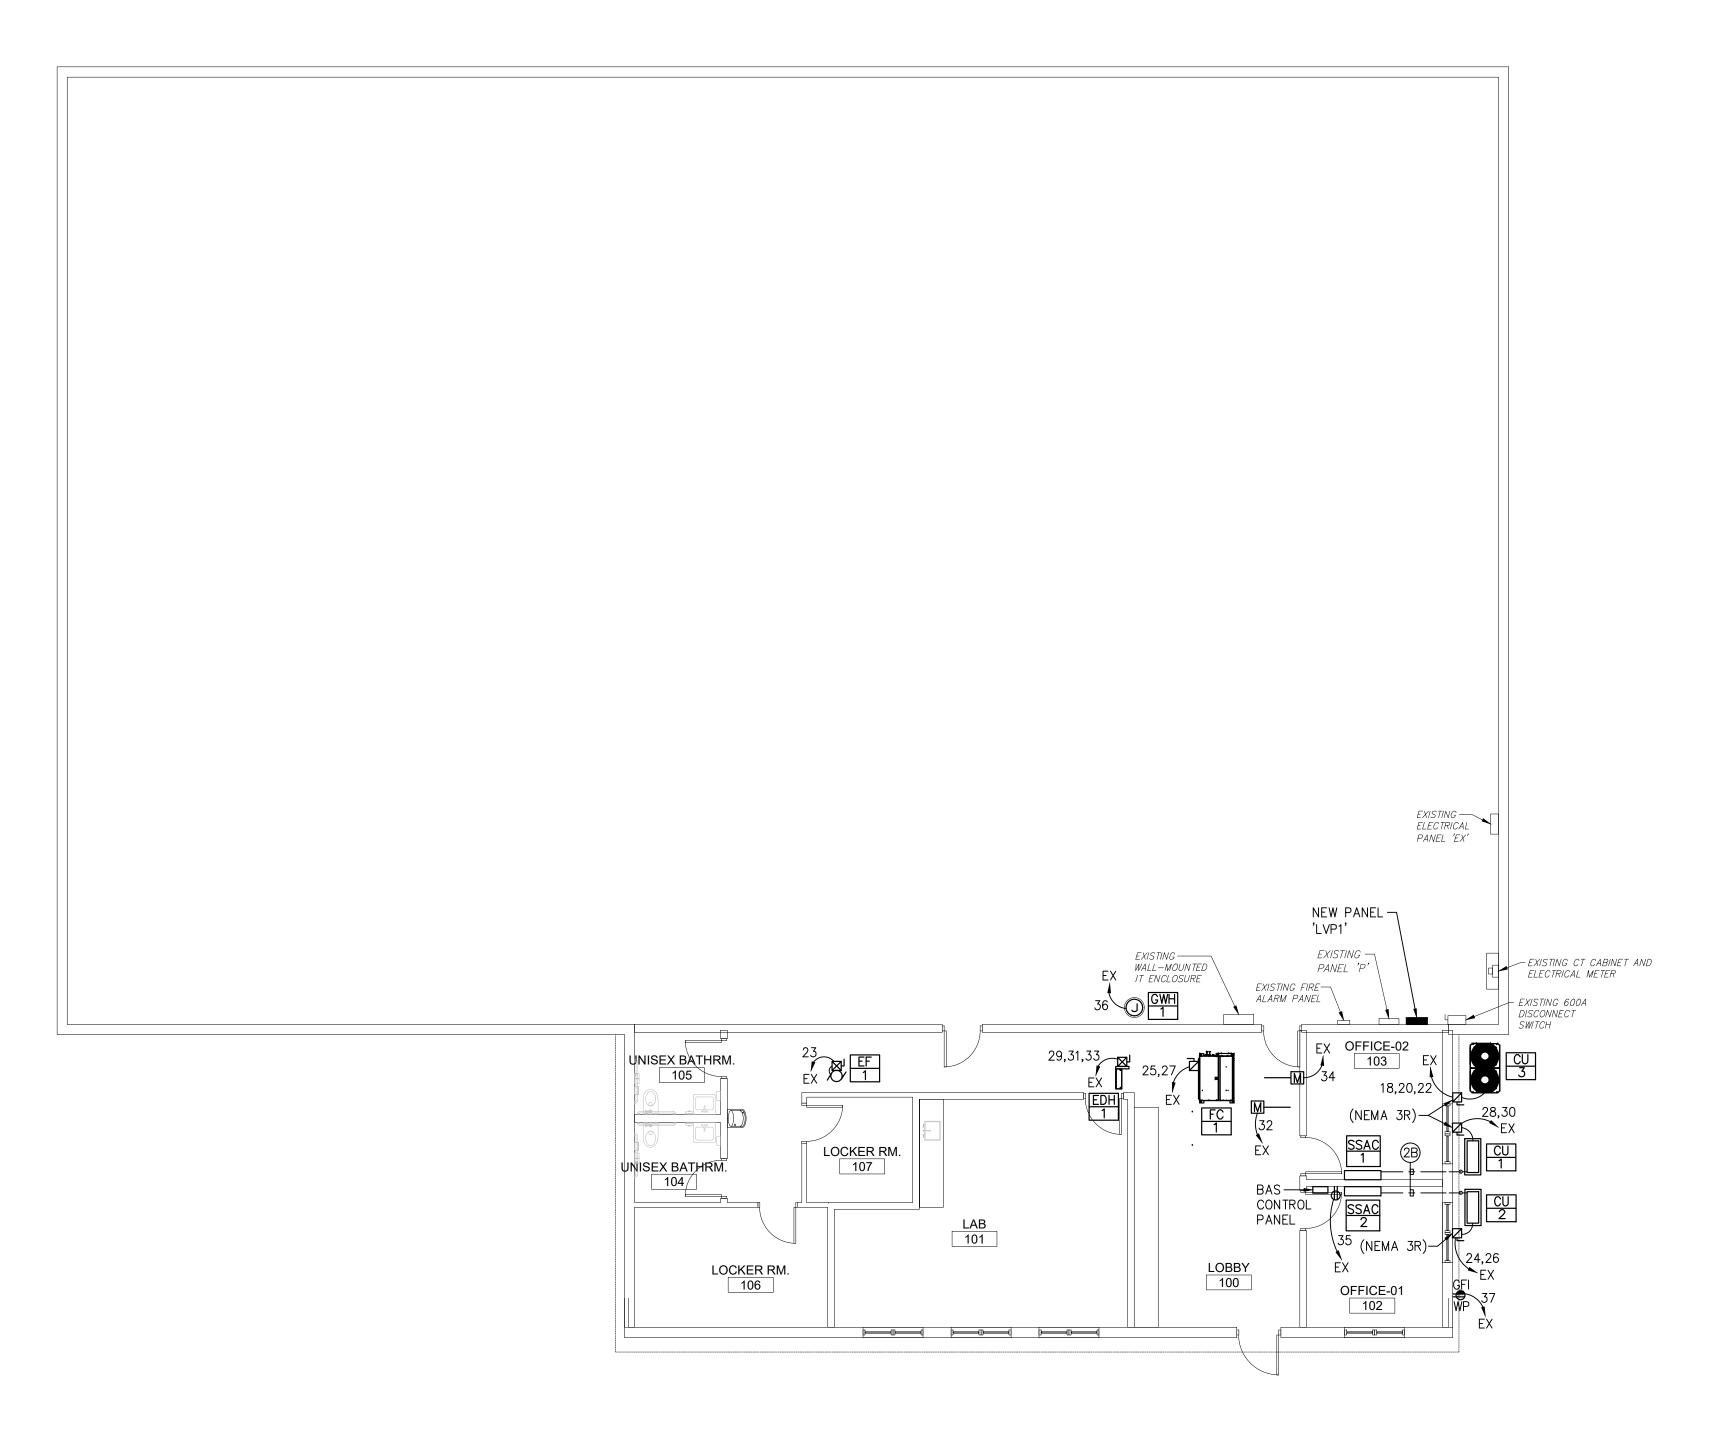

ELECTRICAL HVAC POWER FLOOR PLAN SCALE: 1/8"=1'-0"

- 1. ALL NOTES, SYMBOLS, AND ABBREVIATIONS ON DRAWING E-1.0 APPLY TO THIS DRAWING. 2. THIS DRAWING IS DIAGRAMMATIC, IT IS THE CONTRACTOR'S RESPONSIBILITY TO CONFIRM EXISTING SITE CONDITIONS AND INSTALLATION CLEARANCES PRIOR TO SHOP DRAWING SUBMISSIONS AND INSTALLATION. SHOULD THE CONTRACTOR DETERMINE THAT THE INSTALLATION OF ANY ELECTRICAL COMPONENT IS RESTRICTED OR NOT ABLE TO BE INSTALLED IN THE SUGGESTED LOCATION, THE CONTRACTOR SHALL READDRESS THE INSTALLATION ACCORDINGLY AND IN COMPLIANCE WITH THE MOST RECENTLY ADOPTED NATIONAL ELECTRICAL CODE APPROVED BY THE AUTHORITY HAVING JURISDICTION AT NO ADDITIONAL COST.
- 3. ELECTRICAL CONTRACTOR SHALL COORDINATE WITH HVAC CONTROLS CONTRACTOR FOR ALL LOW-VOLTAGE WIRING REQUIREMENTS.

ISSUED FOR BID

DATE: 01-10-2025




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2059 SPRINGDALE ROAD,



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SHEET CONTENTS:

ELECTRICAL HVAC POWER FLOOR PLAN

PROJECT TITLE:

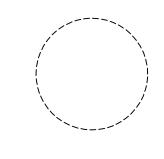
SUBMISSION:

RENOVATION FOR MAINTENANCE BUILDING **BURLINGTON COUNTY** 10 HARTFORD ROAD, DELRAN TWP. BURLINGTON CO. NJ

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awn	by	C.P.		
ecke	d by			
o No		2241869		

E-3.2

Drawing No.

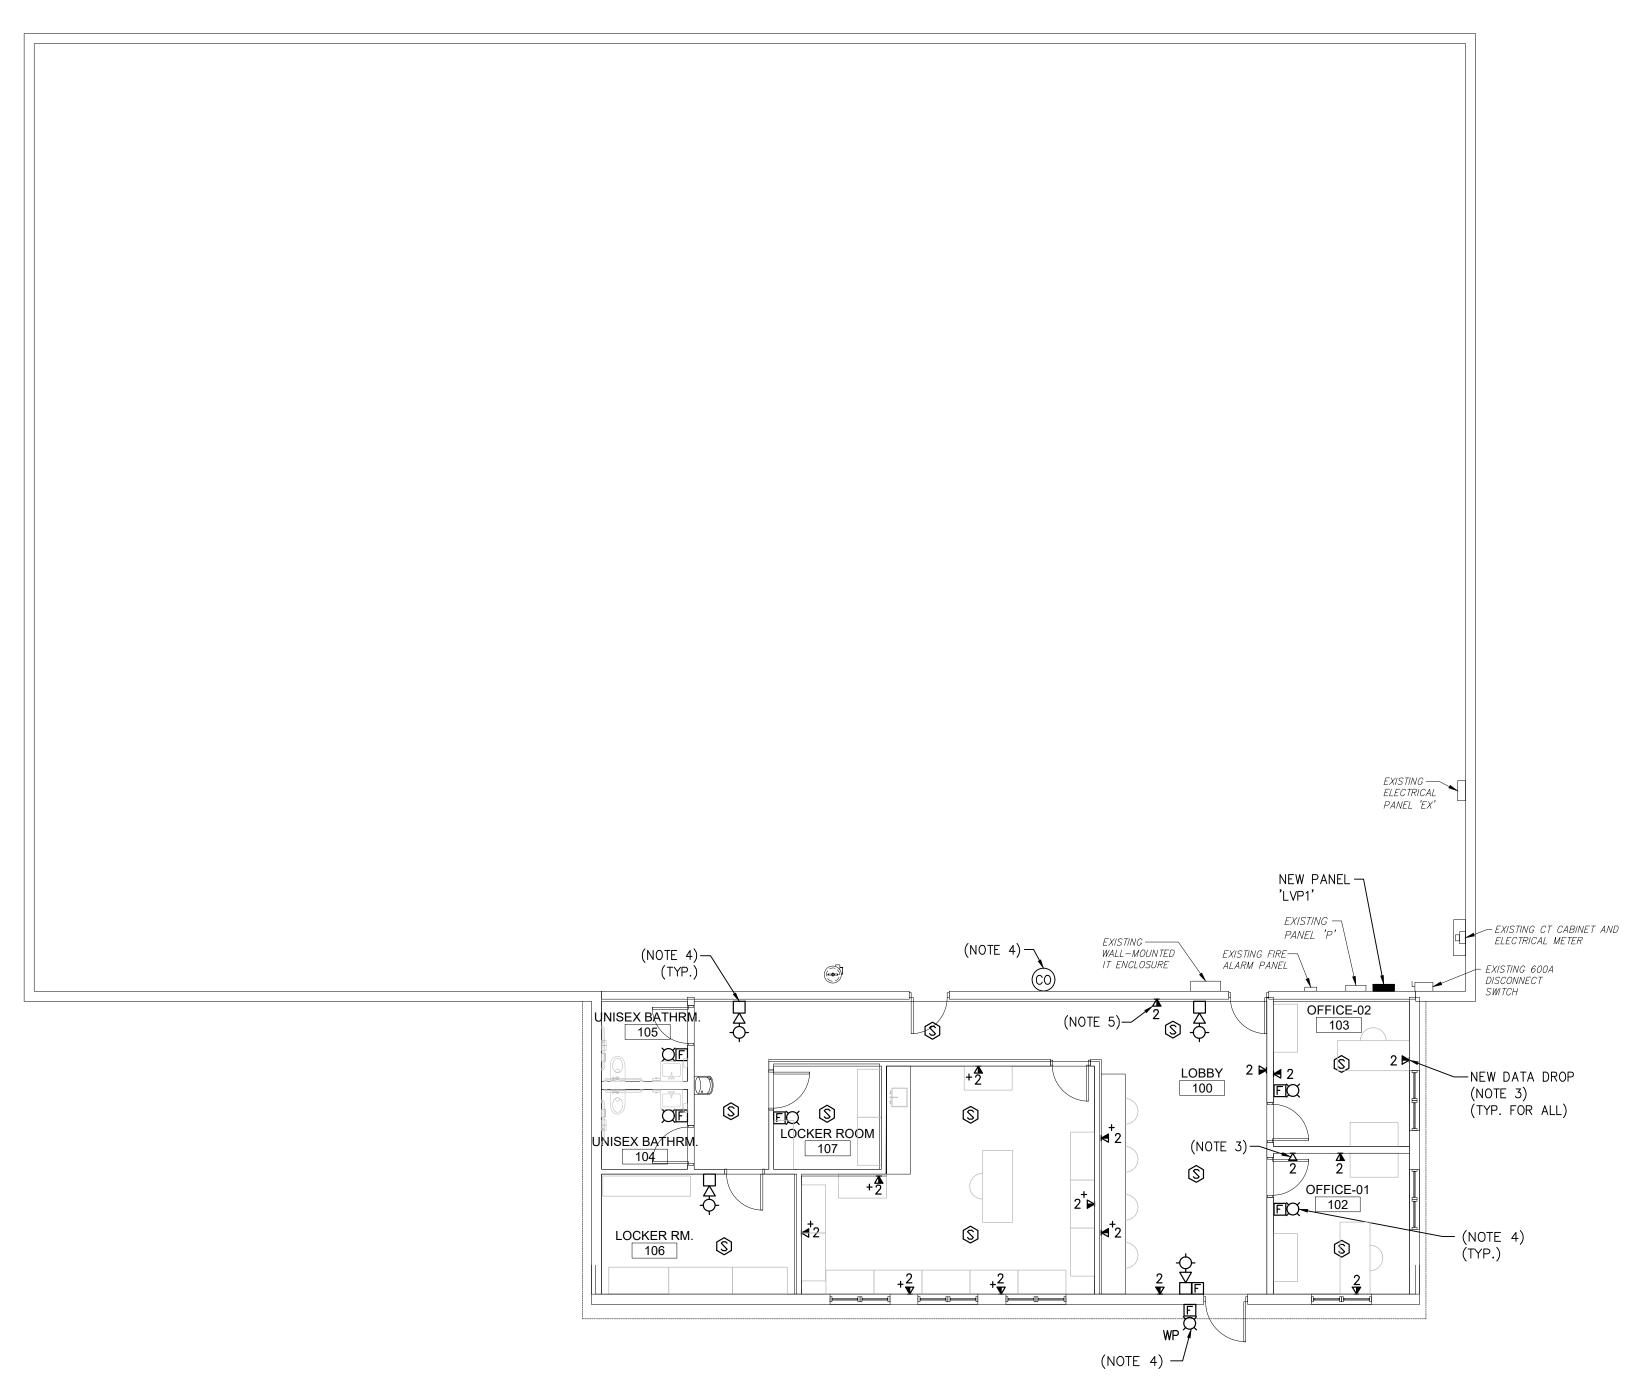

ELECTRICAL SYSTEMS FLOOR PLAN SCALE: 1/8"=1'-0"

NOTES:

1. ALL NOTES, SYMBOLS, AND ABBREVIATIONS ON DRAWING E-1.0 APPLY TO THIS DRAWING. 2. THIS DRAWING IS DIAGRAMMATIC, IT IS THE CONTRACTOR'S RESPONSIBILITY TO CONFIRM EXISTING SITE CONDITIONS AND INSTALLATION CLEARANCES PRIOR TO SHOP DRAWING SUBMISSIONS AND INSTALLATION. SHOULD THE CONTRACTOR DETERMINE THAT THE INSTALLATION OF ANY ELECTRICAL COMPONENT IS RESTRICTED OR NOT ABLE TO BE INSTALLED IN THE SUGGESTED LOCATION, THE CONTRACTOR SHALL READDRESS THE INSTALLATION ACCORDINGLY AND IN COMPLIANCE WITH THE MOST RECENTLY ADOPTED NATIONAL ELECTRICAL CODE APPROVED BY THE AUTHORITY HAVING JURISDICTION AT NO

- ADDITIONAL COST. 3. CONTRACTOR SHALL ROUTE NEW CAT6 CABLING TO EXISTING WALL-MOUNTED IT ENCLOSURE LOCATED IN MAINTENANCE GARAGE. CONTRACTOR SHALL PROVIDE ALL NECESSARY HARDWARE FOR A COMPLETE INSTALLATION.
- 4. PROVIDE ALL WIRING, CONDUIT, PROGRAMMING, TESTING, EXPANSION CARDS, SLAVE FIRE ALARM CONTROL PANELS, ETC. TO CONNECT NEW FIRE ALARM DEVICES INTO THE EXISTING FIRE ALARM SYSTEM IN ACCORDANCE WITH NFPA 72. FIELD VERIFY THE LOCATION, BRAND, CATALOG NUMBER OF ALL EXISTING FIRE ALARM PANELS, CONTROLLERS, DEVICES, ETC. AND INCLUDE ALL COSTS FOR THE CONNECTION OF THE
- NEW FIRE ALARM DEVICES IN THE CONTRACTOR'S BID. 5. COORDINATE EXACT LOCATION OF PRINTER PRIOR TO ROUGH—IN INSTALLATION OF DATA OUTLET WITH OWNER.




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SHEET CONTENTS:

ELECTRICAL SYSTEMS FLOOR PLAN

PROJECT TITLE:

SUBMISSION:


RENOVATION FOR MAINTENANCE BUILDING **BURLINGTON COUNTY** 10 HARTFORD ROAD, DELRAN TWP. BURLINGTON CO. NJ

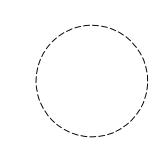
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E-4.1


Drawing No.

ISSUED FOR BID DATE: 01-10-2025



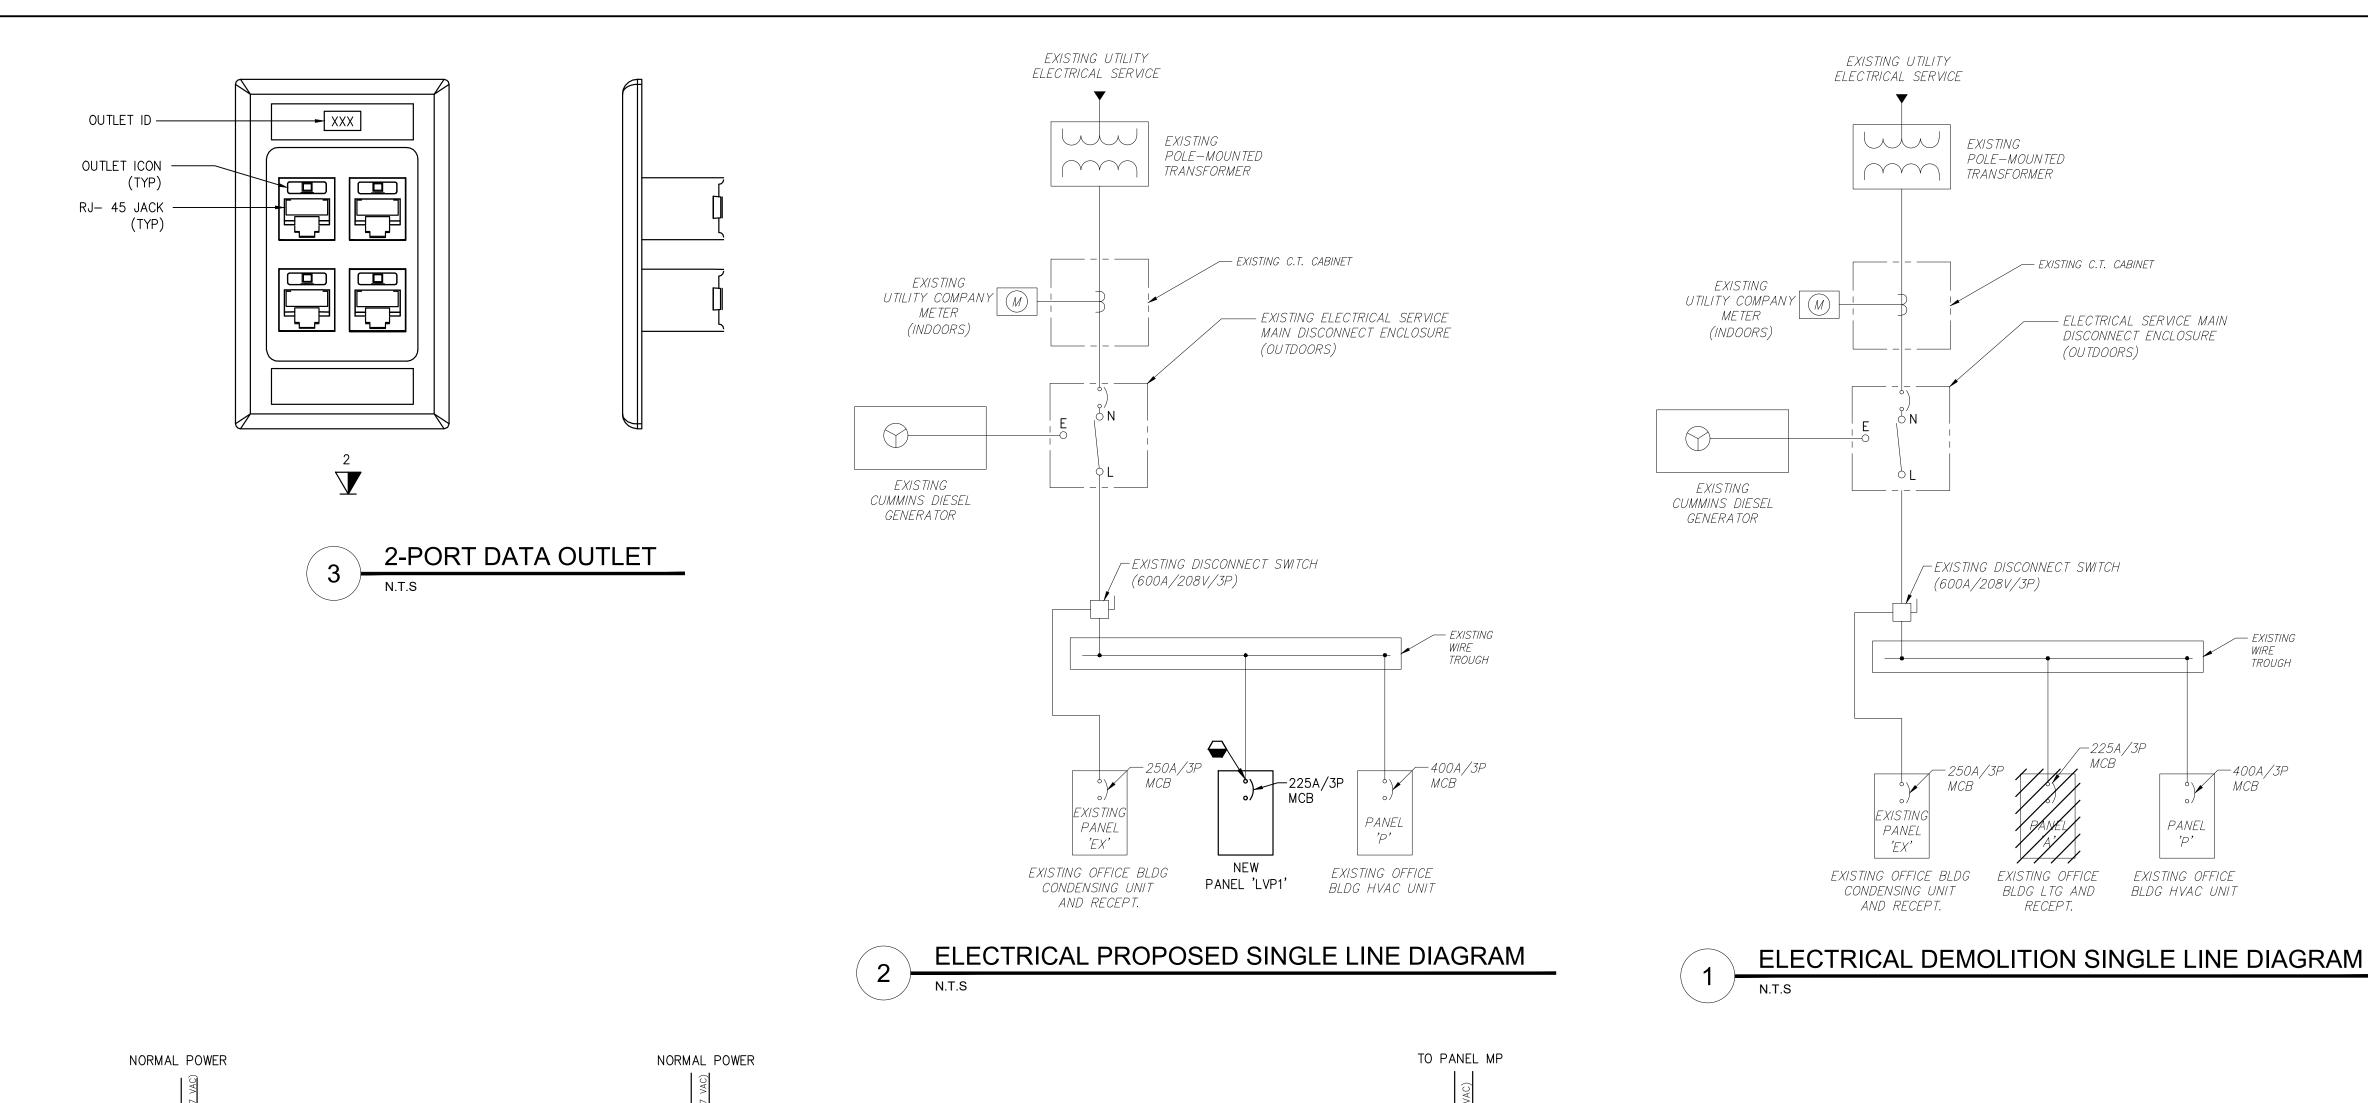


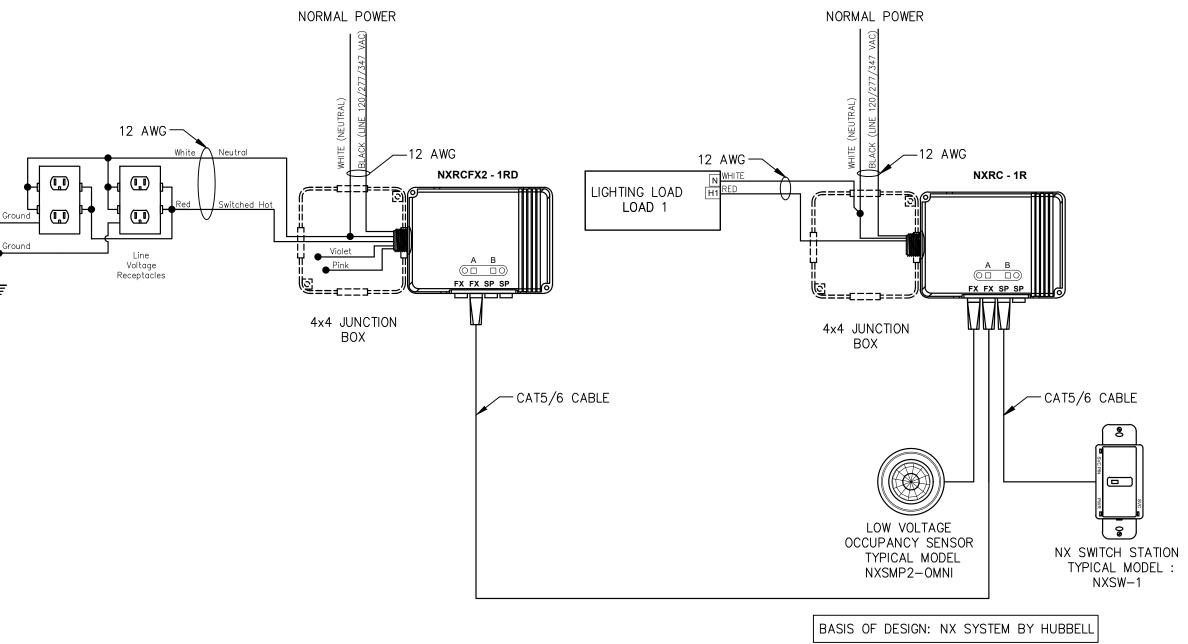1 ZONE LIGHTING CONTROLS WITH RECEPTACLE LOAD DIAGRAM

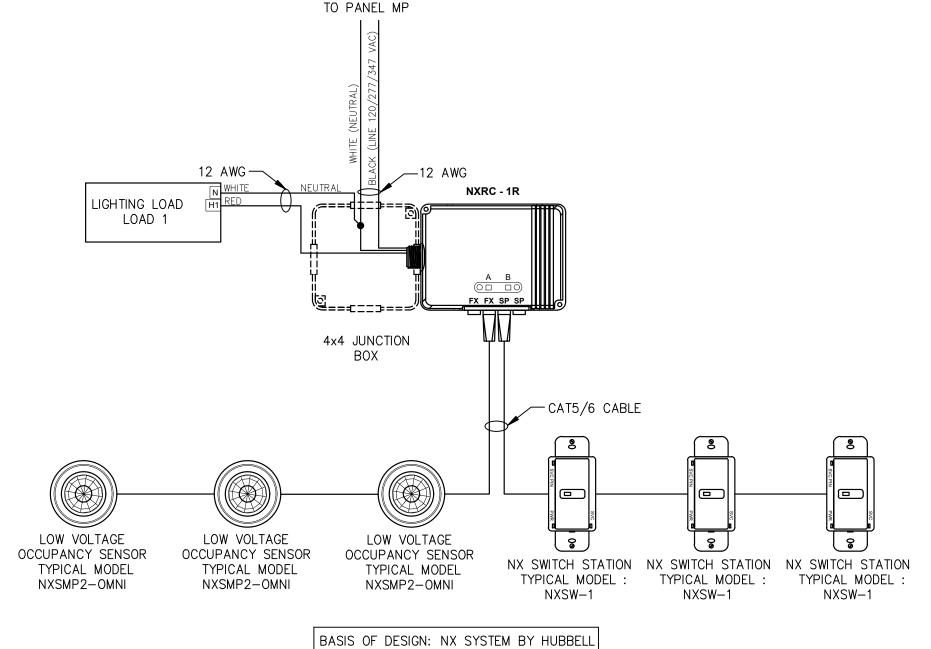

TYPICAL LIGHTING CONTROL DIAGRAM SCALE: N.T.S.



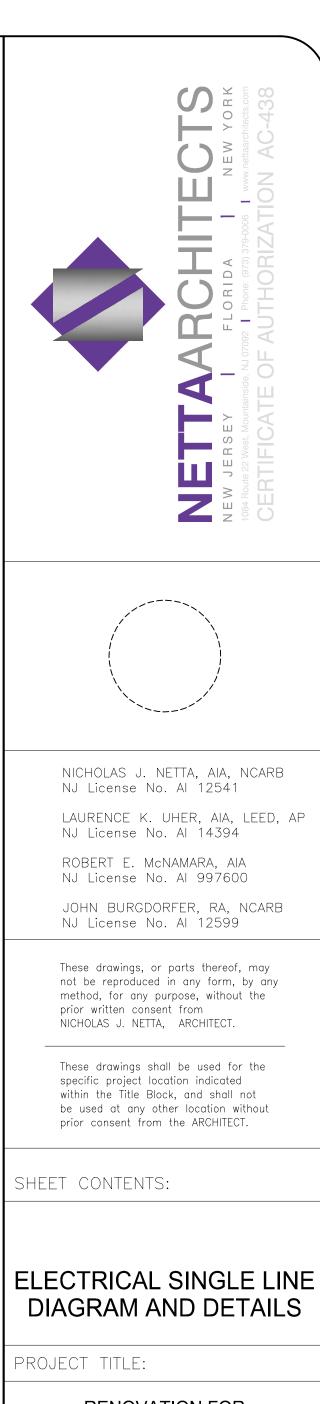

RENOVATION FOR MAINTENANCE BUILDING **BURLINGTON COUNTY** 10 HARTFORD ROAD, DELRAN TWP. BURLINGTON CO. NJ SUBMISSION: ATE REVISIONS

> Drawing No. E-5.1

C.P.

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AS SHOWN

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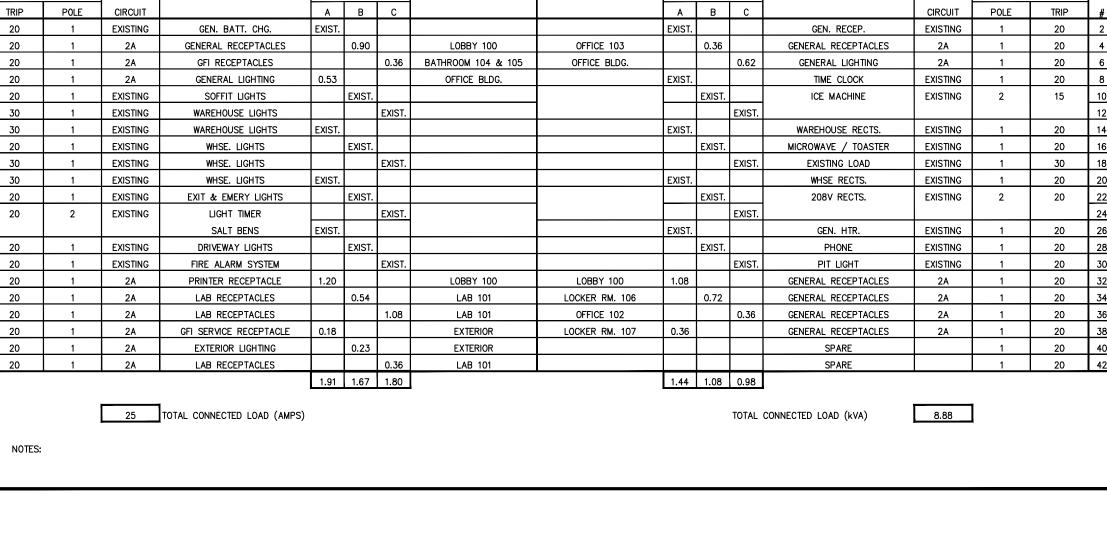
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ISSUED FOR BID DATE: 01-10-2025


OLTAC	GE:	208Y/120V, 3	3ø, 4W+G		х	мсв	250A /	/ 3P		POLES:	. 42			AIC RATING:	10,000	
AIN B	∂US:	225A				MLO				MTG:	SURFAC	JE		LOCATION:	MAINTENANC	E GARAGE
CKT	CIRCUIT	T BREAKER	BRANCH	DESCRIPTION	kVA	PER PH	HASE	REMARKS	REMARKS	kVA	PER PH	HASE	DESCRIPTION	BRANCH	CIRCUIT	BREAKER
#	TRIP	POLE	CIRCUIT	1	A	В	С		<u> </u>	A	В	С		CIRCUIT	POLE	TRIP
1	20	1	EXISTING	REC	EXIST					EXIST			REC	EXISTING	1	20
3	20	1	EXISTING	REC		EXIST					EXIST		REC	EXISTING	1	20
5	20	2	EXISTING	HEAT			EXIST					EXIST	HEAT	EXISTING	2	20
7	<u>. </u>	<u> </u> '		<u> </u>	EXIST			<u></u>	<u> </u>	EXIST				<u> </u>		<u> </u>
	20	1	EXISTING	FREEZER		EXIST					EXIST		HEAT	EXISTING	2	20
1	20	1	2A	MICROWAVE RECEPTACLE			1.20	LAB 101 (NOTE 1)	l			EXIST				
3	20	1	2A	GFI RECEPTACLE	0.18			LAB 101 (NOTE 1)		EXIST			CONDENSING UNIT	EXISTING	2	30
5	20	1		SPARE							EXIST			'		1
7		<u>'</u>		1			EXIST		<u> </u>			7.56				
9	20	3	EXISTING	BATTERY CHARGER	EXIST			1	EXTERIOR	7.56			CU-3	10C	3	100
21	, 	<u> </u> '	<u> </u>			EXIST			(NOTE 1)		7.56				<u> </u>	
23	15	1	2A	EF-1			0.86	LOCKER RM. 107 (NOTE 1)	EXTERIOR			1.14	CU-2	2B	2	15
25	15	2	2B	FC-1	0.50	<u> </u>		LOBBY 100	(NOTE 1)	1.14	<u> </u>					<u> </u>
27	<u>. </u>	<u> </u>	1	1	'	0.50		(NOTE 1)	EXTERIOR		1.14		CU-1	2B	2	15
29	,	\[\]		1			4.49		(NOTE 1)			1.14				<u> </u>
31	50	3		EDH-1	4.49			(NOTE 1)	LOBBY 100 (NOTE 1)	0.10	'		MOTORIZED DAMPER	2A	1	20
33	'	<u> </u>	1		<u> </u>	4.49			LOBBY 100 (NOTE 1)	'	0.10		MOTORIZED DAMPER	2A	1	20
35	20	1	2A	BAS CONTROL PANEL	<u> </u>	′	0.50	OFFICE 102 (NOTE 1)	MAIN. GAR. (NOTE 1)	'	<u> </u>	0.10	GWH-1 (IGNITER)	2A	1	20
37	20	1	2A	ICE MAKER	0.70	′		MAIN. BLDG. (NOTE 1)		'	'		SPACE			$oxed{\Box}$
39	20	1	2A	ELECTRIC WATER FOUNTAIN	′	0.60		CORRIDOR (NOTE 1)	<u> </u>	'	<u> </u>		SPACE			
41	<u> </u>	<u> </u>	<u> </u>	SPACE		<u> </u>			<u> </u>	'	<u> </u> '	$\perp \perp \perp$	SPACE		<u> </u>	
					5.87	5.59	7.05			8.80	8.80	9.94				

NOTES: 1. PROVIDE A COMPATIBLE BRANCH CIRCUIT BREAKER.

OLIA	GE:	208Y/120V,	3ø, 4W+G		х	мсв	225A/3	SP .		POLES:	42			AIC RATING:	42,000		
IAIN I	BUS:	250A				MLO				MTG:	SURFA	CE		LOCATION: MAINTENANCE GARAGE		E GARAGE	
СКТ	CIRCUIT	BREAKER	BRANCH	DESCRIPTION	kVA	PER PI	HASE	REMARKS	REMARKS	kVA	PER PI	HASE	DESCRIPTION	BRANCH	CIRCUIT	BREAKER	CH
#	TRIP	POLE	CIRCUIT		A	В	С			Α	В	С		CIRCUIT	POLE	TRIP	
1	20	1	EXISTING	GEN. BATT. CHG.	EXIST.					EXIST.			GEN. RECEP.	EXISTING	1	20	2
3	20	1	2A	GENERAL RECEPTACLES		0.90		LOBBY 100	OFFICE 103		0.36		GENERAL RECEPTACLES	2A	1	20	4
5	20	1	2A	GFI RECEPTACLES			0.36	BATHROOM 104 & 105	OFFICE BLDG.			0.62	GENERAL LIGHTING	2A	1	20	- 6
7	20	1	2A	GENERAL LIGHTING	0.53			OFFICE BLDG.		EXIST.			TIME CLOCK	EXISTING	1	20	
9	20	1	EXISTING	SOFFIT LIGHTS		EXIST.					EXIST.		ICE MACHINE	EXISTING	2	15	1
11	30	1	EXISTING	WAREHOUSE LIGHTS			EXIST.					EXIST.					1
13	30	1	EXISTING	WAREHOUSE LIGHTS	EXIST.					EXIST.			WAREHOUSE RECTS.	EXISTING	1	20	1
15	20	1	EXISTING	WHSE. LIGHTS		EXIST.					EXIST.		MICROWAVE / TOASTER	EXISTING	1	20	1
17	30	1	EXISTING	WHSE. LIGHTS			EXIST.					EXIST.	EXISTING LOAD	EXISTING	1	30	1
19	30	1	EXISTING	WHSE. LIGHTS	EXIST.					EXIST.			WHSE RECTS.	EXISTING	1	20	2
21	20	1	EXISTING	EXIT & EMERY LIGHTS		EXIST.					EXIST.		208V RECTS.	EXISTING	2	20	_2
23	20	2	EXISTING	LIGHT TIMER			EXIST.					EXIST.					2
25				SALT BENS	EXIST.					EXIST.			GEN. HTR.	EXISTING	1	20	2
27	20	1	EXISTING	DRIVEWAY LIGHTS		EXIST.					EXIST.		PHONE	EXISTING	1	20	2
29	20	1	EXISTING	FIRE ALARM SYSTEM			EXIST.					EXIST.	PIT LIGHT	EXISTING	1	20	3
31	20	1	2A	PRINTER RECEPTACLE	1.20			LOBBY 100	LOBBY 100	1.08			GENERAL RECEPTACLES	2A	1	20	3
33	20	1	2A	LAB RECEPTACLES		0.54		LAB 101	LOCKER RM. 106		0.72		GENERAL RECEPTACLES	2A	1	20	3
35	20	1	2A	LAB RECEPTACLES			1.08	LAB 101	OFFICE 102			0.36	GENERAL RECEPTACLES	2A	1	20	3
37	20	1	2A	GFI SERVICE RECEPTACLE	0.18			EXTERIOR	LOCKER RM. 107	0.36			GENERAL RECEPTACLES	2A	1	20	3
39	20	1	2A	EXTERIOR LIGHTING		0.23		EXTERIOR					SPARE		1	20	4
41	20	1	2A	LAB RECEPTACLES			0.36	LAB 101					SPARE		1	20	4





ISSUED FOR BID
DATE: 01-10-2025

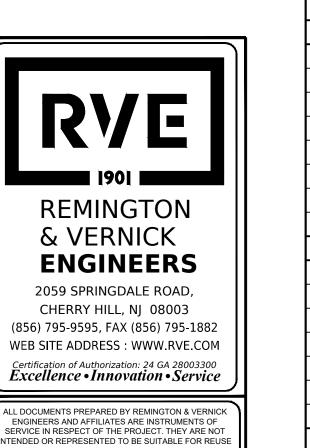

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CHRISTOPHER A. SAPONARO NJ PROFESSIONAL ENGINEER LIC. No. 40059



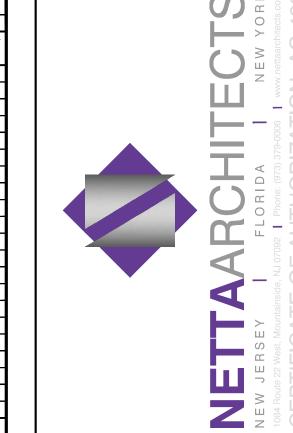

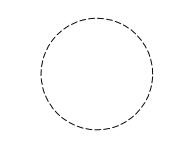NICHOLAS J. NETTA, AIA, NCARB NJ License No. Al 12541 LAURENCE K. UHER, AIA, LEED, AP

ROBERT E. McNAMARA, AIA NJ License No. Al 997600

NJ License No. Al 14394

JOHN BURGDORFER, RA, NCARB NJ License No. Al 12599

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SHEET CONTENTS:

ELECTRICAL SCHEDULES

PROJECT TITLE:

SUBMISSION:


Job No.

Drawing No.

RENOVATION FOR MAINTENANCE BUILDING **BURLINGTON COUNTY** 10 HARTFORD ROAD, DELRAN TWP. BURLINGTON CO. NJ

ATE	REVIS	SIONS	BY	CHKD
ate		10.08.24		
cale		AS SHOW	\	
rawn	by	C.P.		
hecke	d by			
ob No		2241869		

E-5.2

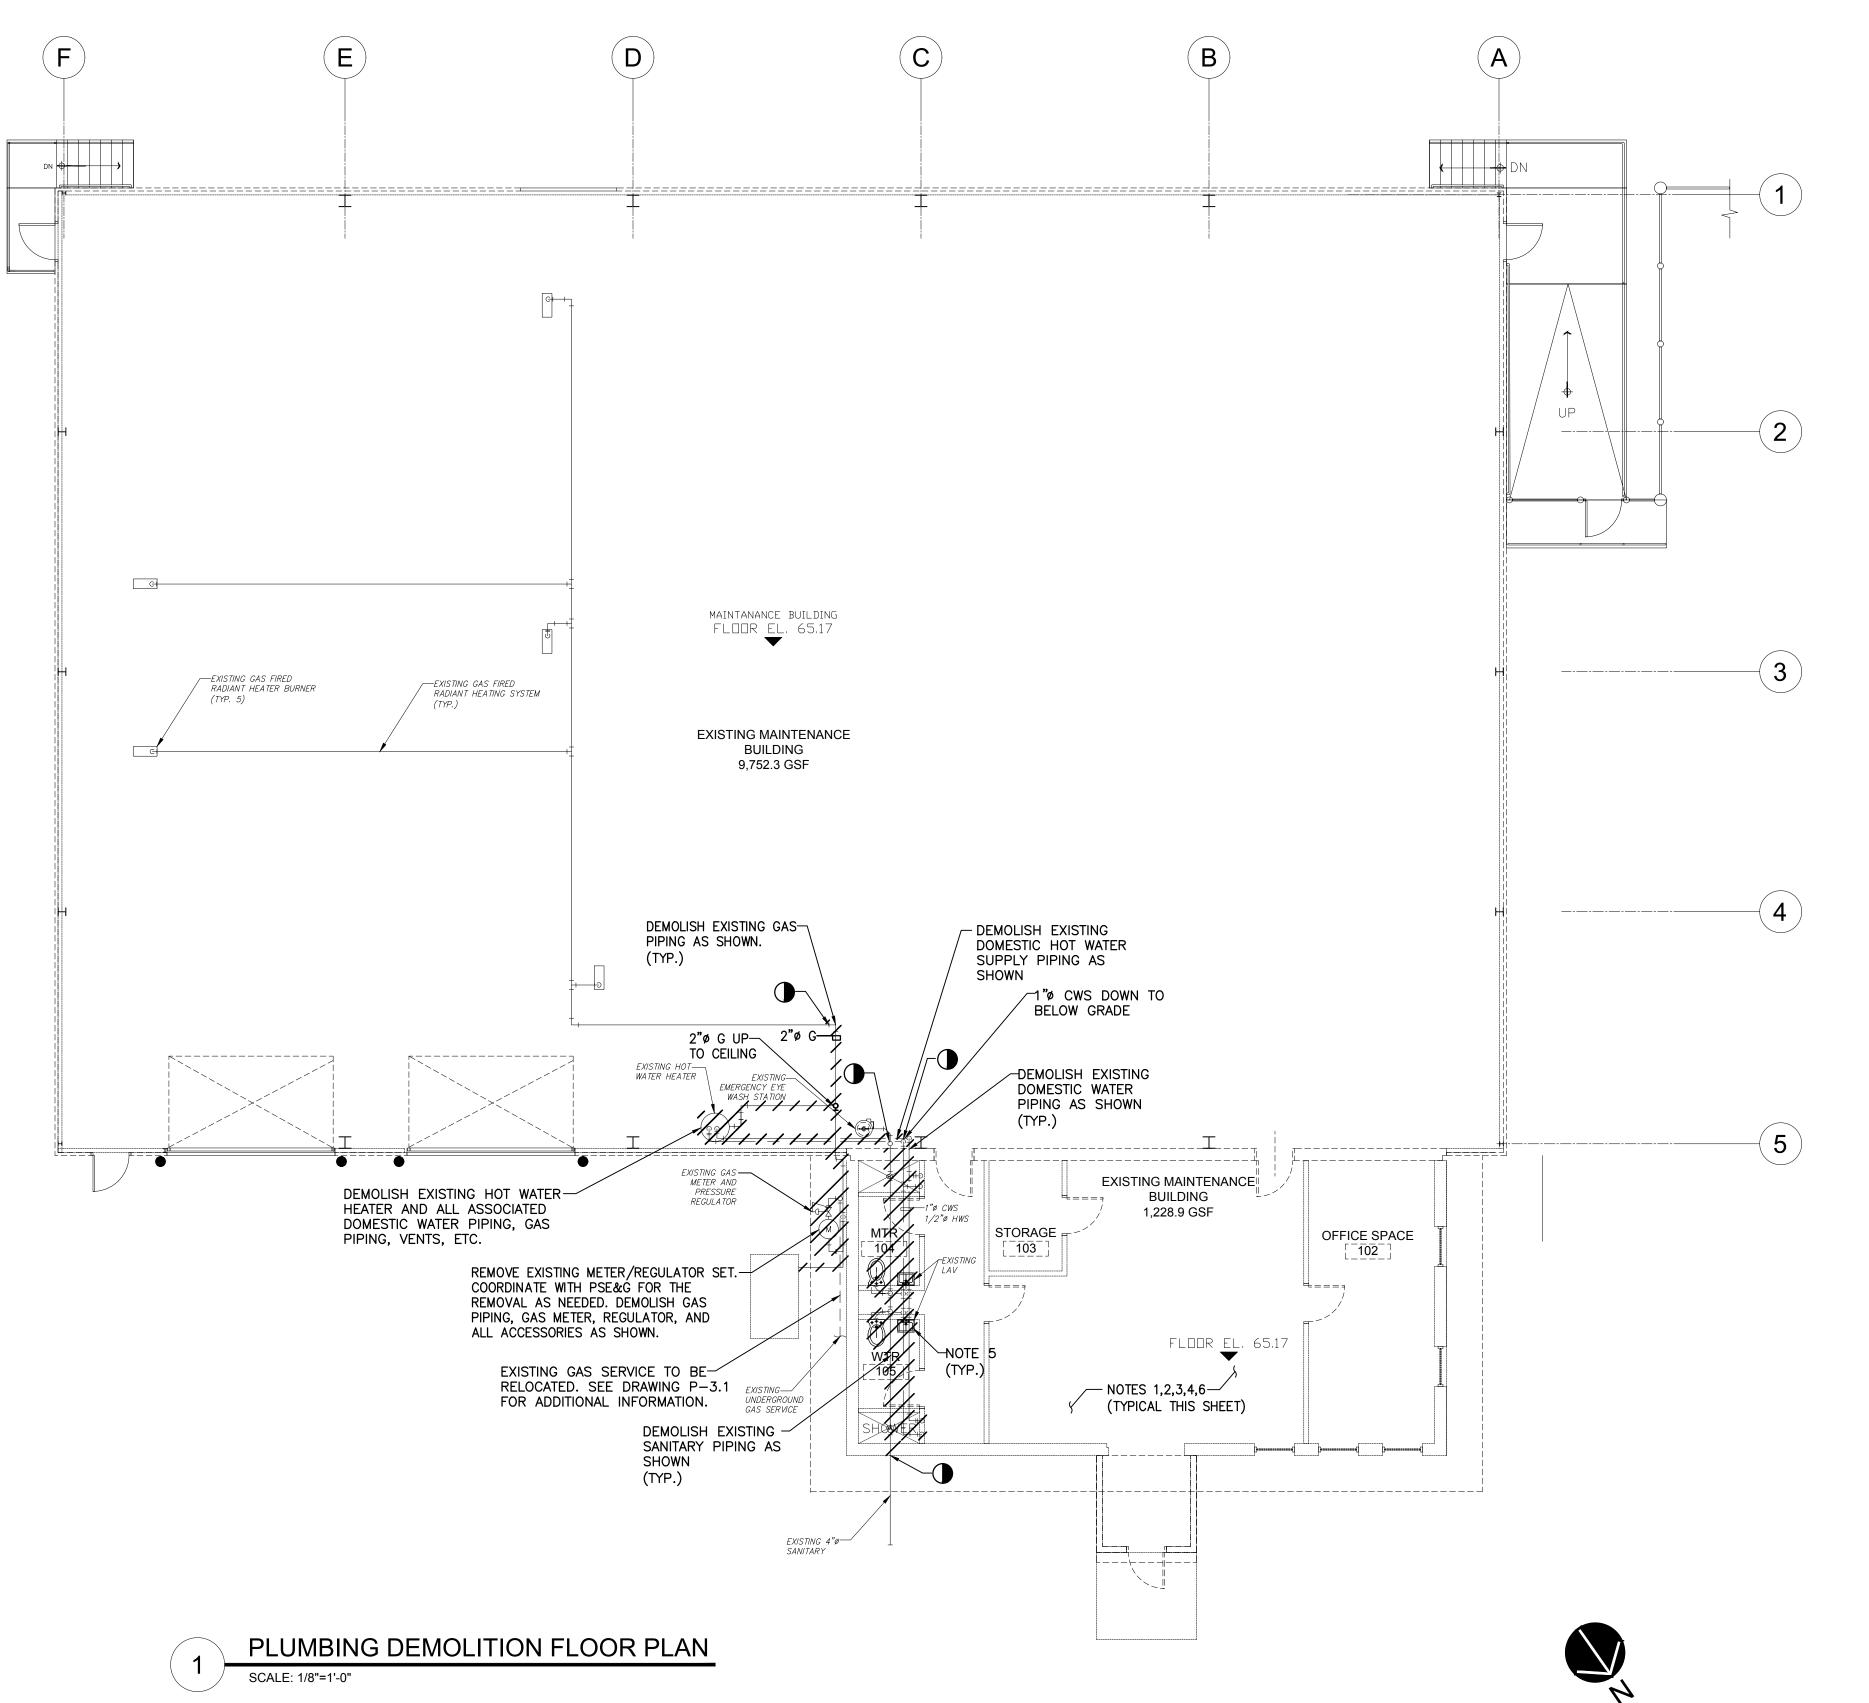

IOTES:


- ALL NOTES, SYMBOLS, AND ABBREVIATIONS ON DRAWING M-1.0 APPLY TO THIS DRAWING.
 THIS DEMOLITION PLAN HAS BEEN PROVIDED AS A GUIDE. HOWEVER, ALL DEMOLITION REQUIRED TO SUCCESSFULLY COMPLETE THIS PROJECT SHALL BE INCLUDED IN THE SCOPE OF WORK. IT IS THE INTENT OF THE PLANS AND SPECIFICATIONS TO SECURE A COMPLETELY INTERCONNECTED AND FUNCTIONING SYSTEM AND IF ANY WORKMANSHIP OR MATERIALS BE REQUIRED WHICH ARE OBVIOUSLY NECESSARY TO CARRY OUT THE FULL INTENT AND MEANING OF THE PLANS AND SPECIFICATIONS OR TO BE REASONABLY INFERRED THEREFROM, THE COST OF SUCH WORKMANSHIP OR MATERIALS SHALL BE INCLUDED IN THE SCOPE OF WORK
- THE CONTRACTOR IS RESPONSIBLE FOR REPAIRING & REPLACING ANY OR ALL FIXTURES AND/OR AREAS OF THE CEILING, FLOOR OR WALL DAMAGED AS A RESULT OF THE NEW/DEMOLITION WORK. REPAIRED & REPLACED FIXTURES AND PORTIONS OF THE CEILING, FLOOR, OR WALL SHALL BE RESTORED TO A CONDITION EQUAL TO OR BETTER THAN THEIR ORIGINAL CONDITION.
 COORDINATE THE DEMOLITION OF EXISTING PLUMBING EQUIPMENT WITH OWNER. OWNER SHALL RESERVE THE RIGHT TO RETAIN
- SALVAGED EQUIPMENT. ALL EQUIPMENT NOT RETAINED BY THE OWNER SHALL BE DISPOSED OF BY THE CONTRACTOR.

 5. FIXTURE AND COMPONENT DEMOLITION SHALL INCLUDE THE FIXTURE OR COMPONENT ELEMENT, ALL TRIM COMPONENTS, FAUCETS, FLUSH VALVES, CARRIERS, SUPPLIES, TRAPS AND RELATED ACCESSORIES.
- 6. PIPING DEMOLITION SHALL INCLUDE DOMESTIC WATER, SANITARY, AND/OR VENT PIPING, NATURAL GAS, HANGERS, INSULATION, VALVES, FITTINGS AND ASSOCIATED ELEMENTS.

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DATE: 01-10-2025



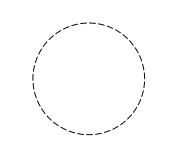

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SHEET CONTENTS:

PLUMBING DEMOLITION FLOOR PLAN

PROJECT TITLE:

RENOVATION FOR
MAINTENANCE BUILDING
BURLINGTON COUNTY

10 HARTFORD ROAD, DELRAN TWP.
BURLINGTON CO. NJ

SUBMISSION: XXX

REVISIONS BY CHK

10.08.24

AS SHOWN

2241869

B.K.

Date
Scale
Drawn by
Checked by
Job No.


Drawing No.

P-1.1



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DATE:
CHRISTOPHER A. SAPONARO
NJ PROFESSIONAL ENGINEER LIC. No. 40059

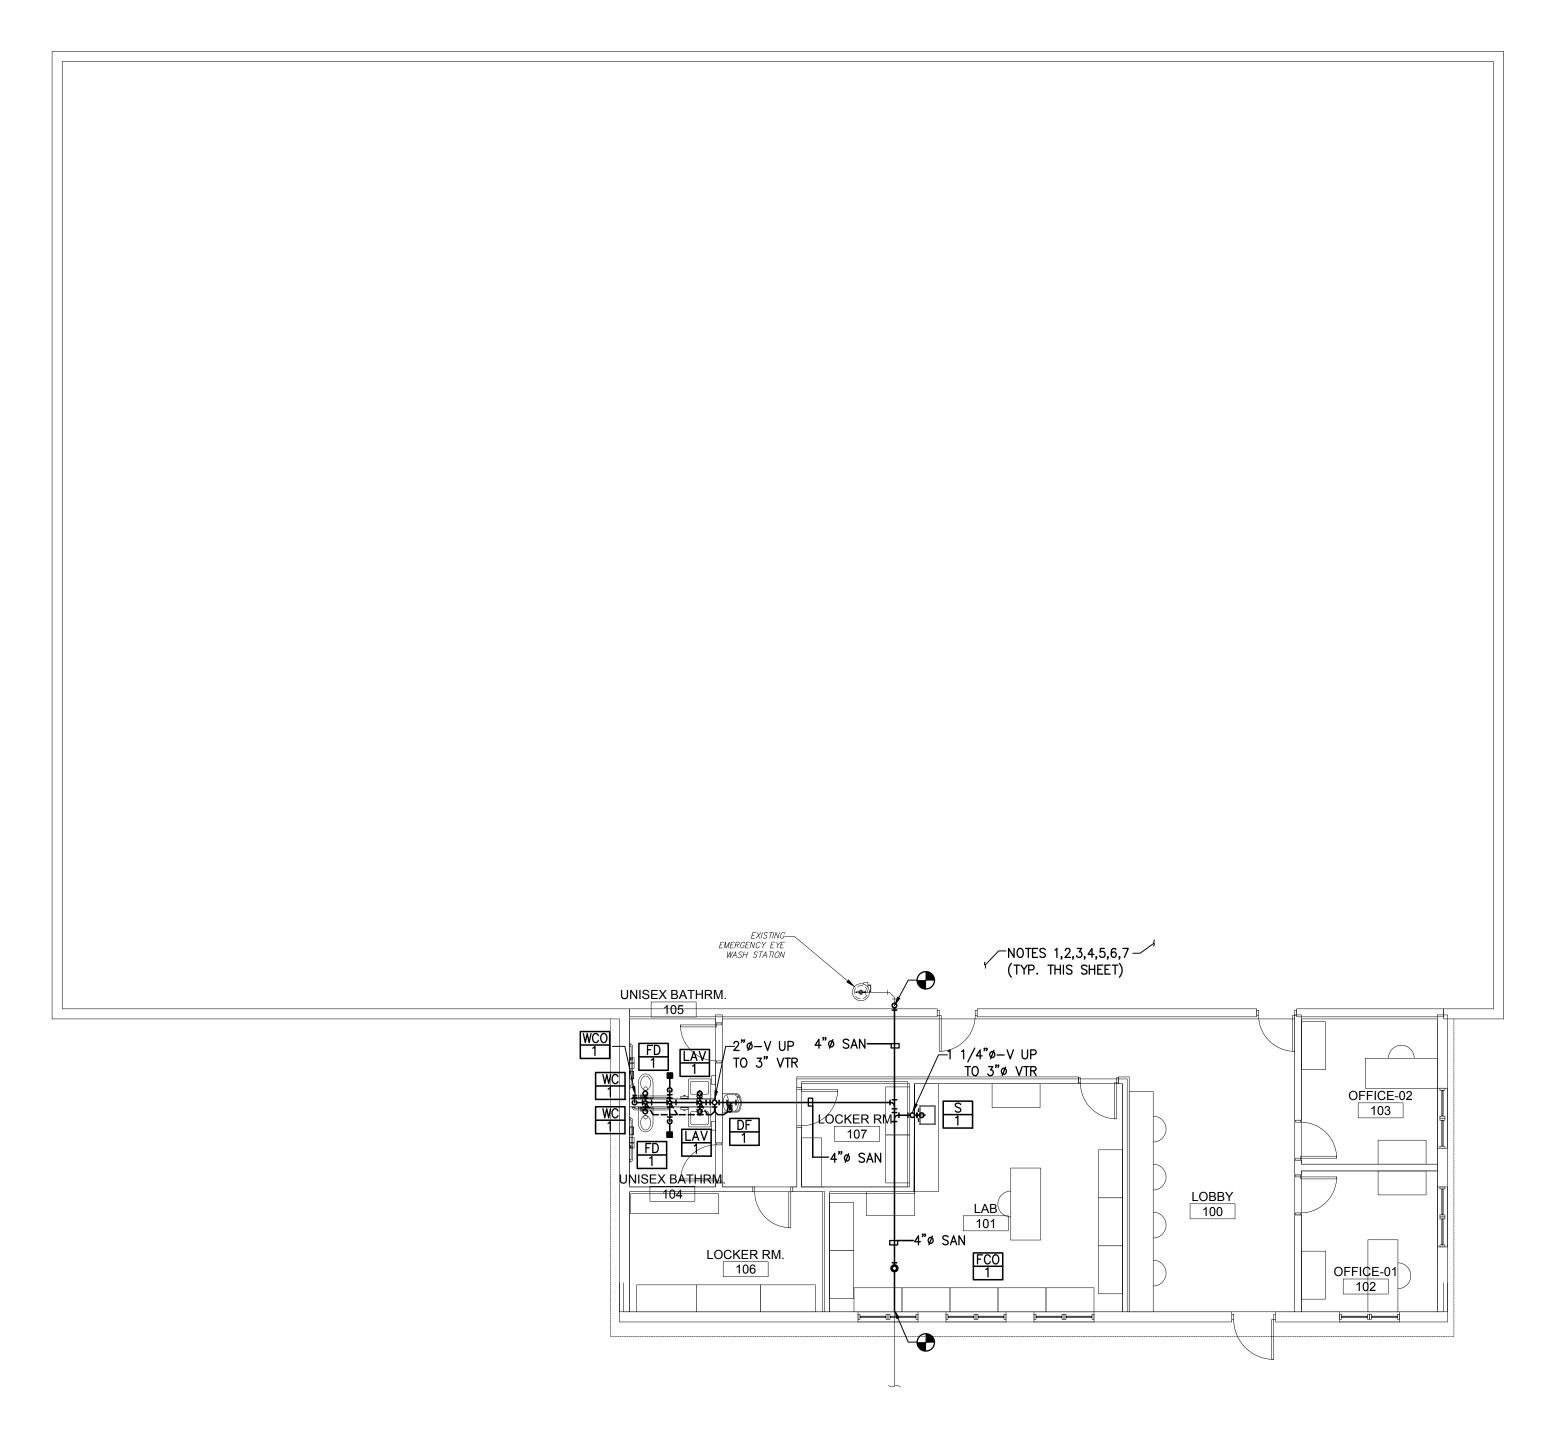

PLUMBING SANITARY PIPING FLOOR PLAN SCALE: 1/8"=1'-0"

NOTES:

- 1. ALL NOTES, SYMBOLS, AND ABBREVIATIONS ON DRAWING M-1.0 APPLY TO THIS DRAWING. 2. ALL INVERTS SHOWN ARE APPROXIMATE. INVERT ELEVATION BASED ON FINISHED FLOOR ELEVATION of 0.00. COORDINATE ALL INVERTS WITH SITE DRAWINGS, SITE CONTRACTOR, AND FIELD CONDITIONS PRIOR TO INSTALLING SANITARY PIPE.
- 3. ALL HORIZONTAL DRAINAGE PIPING 3 INCHES IN DIAMETER AND SMALLER SHALL BE SLOPED A MINIMUM OF 1/4" PER FOOT IN THE DIRECTION OF FLOW. ALL HORIZONTAL DRAINAGE PIPING 4 INCHES THROUGH 6" IN DIAMETER SHALL BE SLOPED A MINIMUM OF 1/8" PER FOOT IN THE DIRECTION OF FLOW. ALL HORIZONTAL DRAINAGE PIPING 8 INCHES AND LARGER IN DIAMETER SHALL BE SLOPED A MINIMUM OF 1/16" PER FOOT IN THE DIRECTION OF FLOW.
- 4. CONTRACTOR SHALL ROUTE DRAINAGE RISERS AND VENT LINES IN THE WALLS WHERE SHOWN. WHERE PIPING CAN NOT BE LOCATED IN WALLS. THE CONTRACTOR SHALL PROVIDE CHASE WALLS AS REQUIRED TO CONCEAL PIPING FROM VIEW. CHASE WALL AND FINISH TO MATCH SURROUNDING WALLS. COORDINATE ALL CHASE WALLS WITH ARCHITECT.
- 5. COORDINATE PIPING LAYOUTS IN ALL AREAS WITH OTHER TRADES PRIOR TO INSTALLATION TO AVOID INTERFERENCES. RELOCATE NEW PIPE TO ACCOMMODATE NEW DUCTWORK, EQUIPMENT, STRUCTURE, CONDUIT, ETC.
- 6. NOT ALL PIPE SIZES AND INLINE DEVICES ARE SHOWN ON THE PLAN FOR CLARITY PURPOSES. SEE THE PLUMBING RISER DIAGRAMS AND DETAIL SHEET(S) FOR ADDITIONAL REQUIREMENTS AND DETAILS. THE CONTRACTOR SHALL PROVIDE ALL REDUCERS, FITTINGS, ETC. AS REQUIRED TO COMPLETE THE NEW WORK EVEN IF NOT SPECIFICALLY SHOWN ON THE PLAN OR RISER DIAGRAMS.
- 7. SANITARY DRAINAGE AND VENT PIPING SHALL BE CAST IRON, SEE SPECIFICATION SECTION 221422 AND 221316 FOR ADDITIONAL REQUIREMENTS.




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ISSUED FOR BID

DATE: 01-10-2025

CHRISTOPHER A. SAPONARO NJ PROFESSIONAL ENGINEER LIC. No. 40059



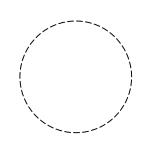

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SHEET CONTENTS:

PLUMBING SANITARY PIPING FLOOR PLAN

PROJECT TITLE:

SUBMISSION:


RENOVATION FOR MAINTENANCE BUILDING **BURLINGTON COUNTY** 10 HARTFORD ROAD, DELRAN TWP. BURLINGTON CO. NJ

DATE	REVIS	SIONS		BY	CHK
D 1 -	•	10.00	\bigcirc \checkmark		

10.08.24 AS SHOWN B.K. Drawn by Checked by 2241869 ob No.

Drawing No.

P-2.1

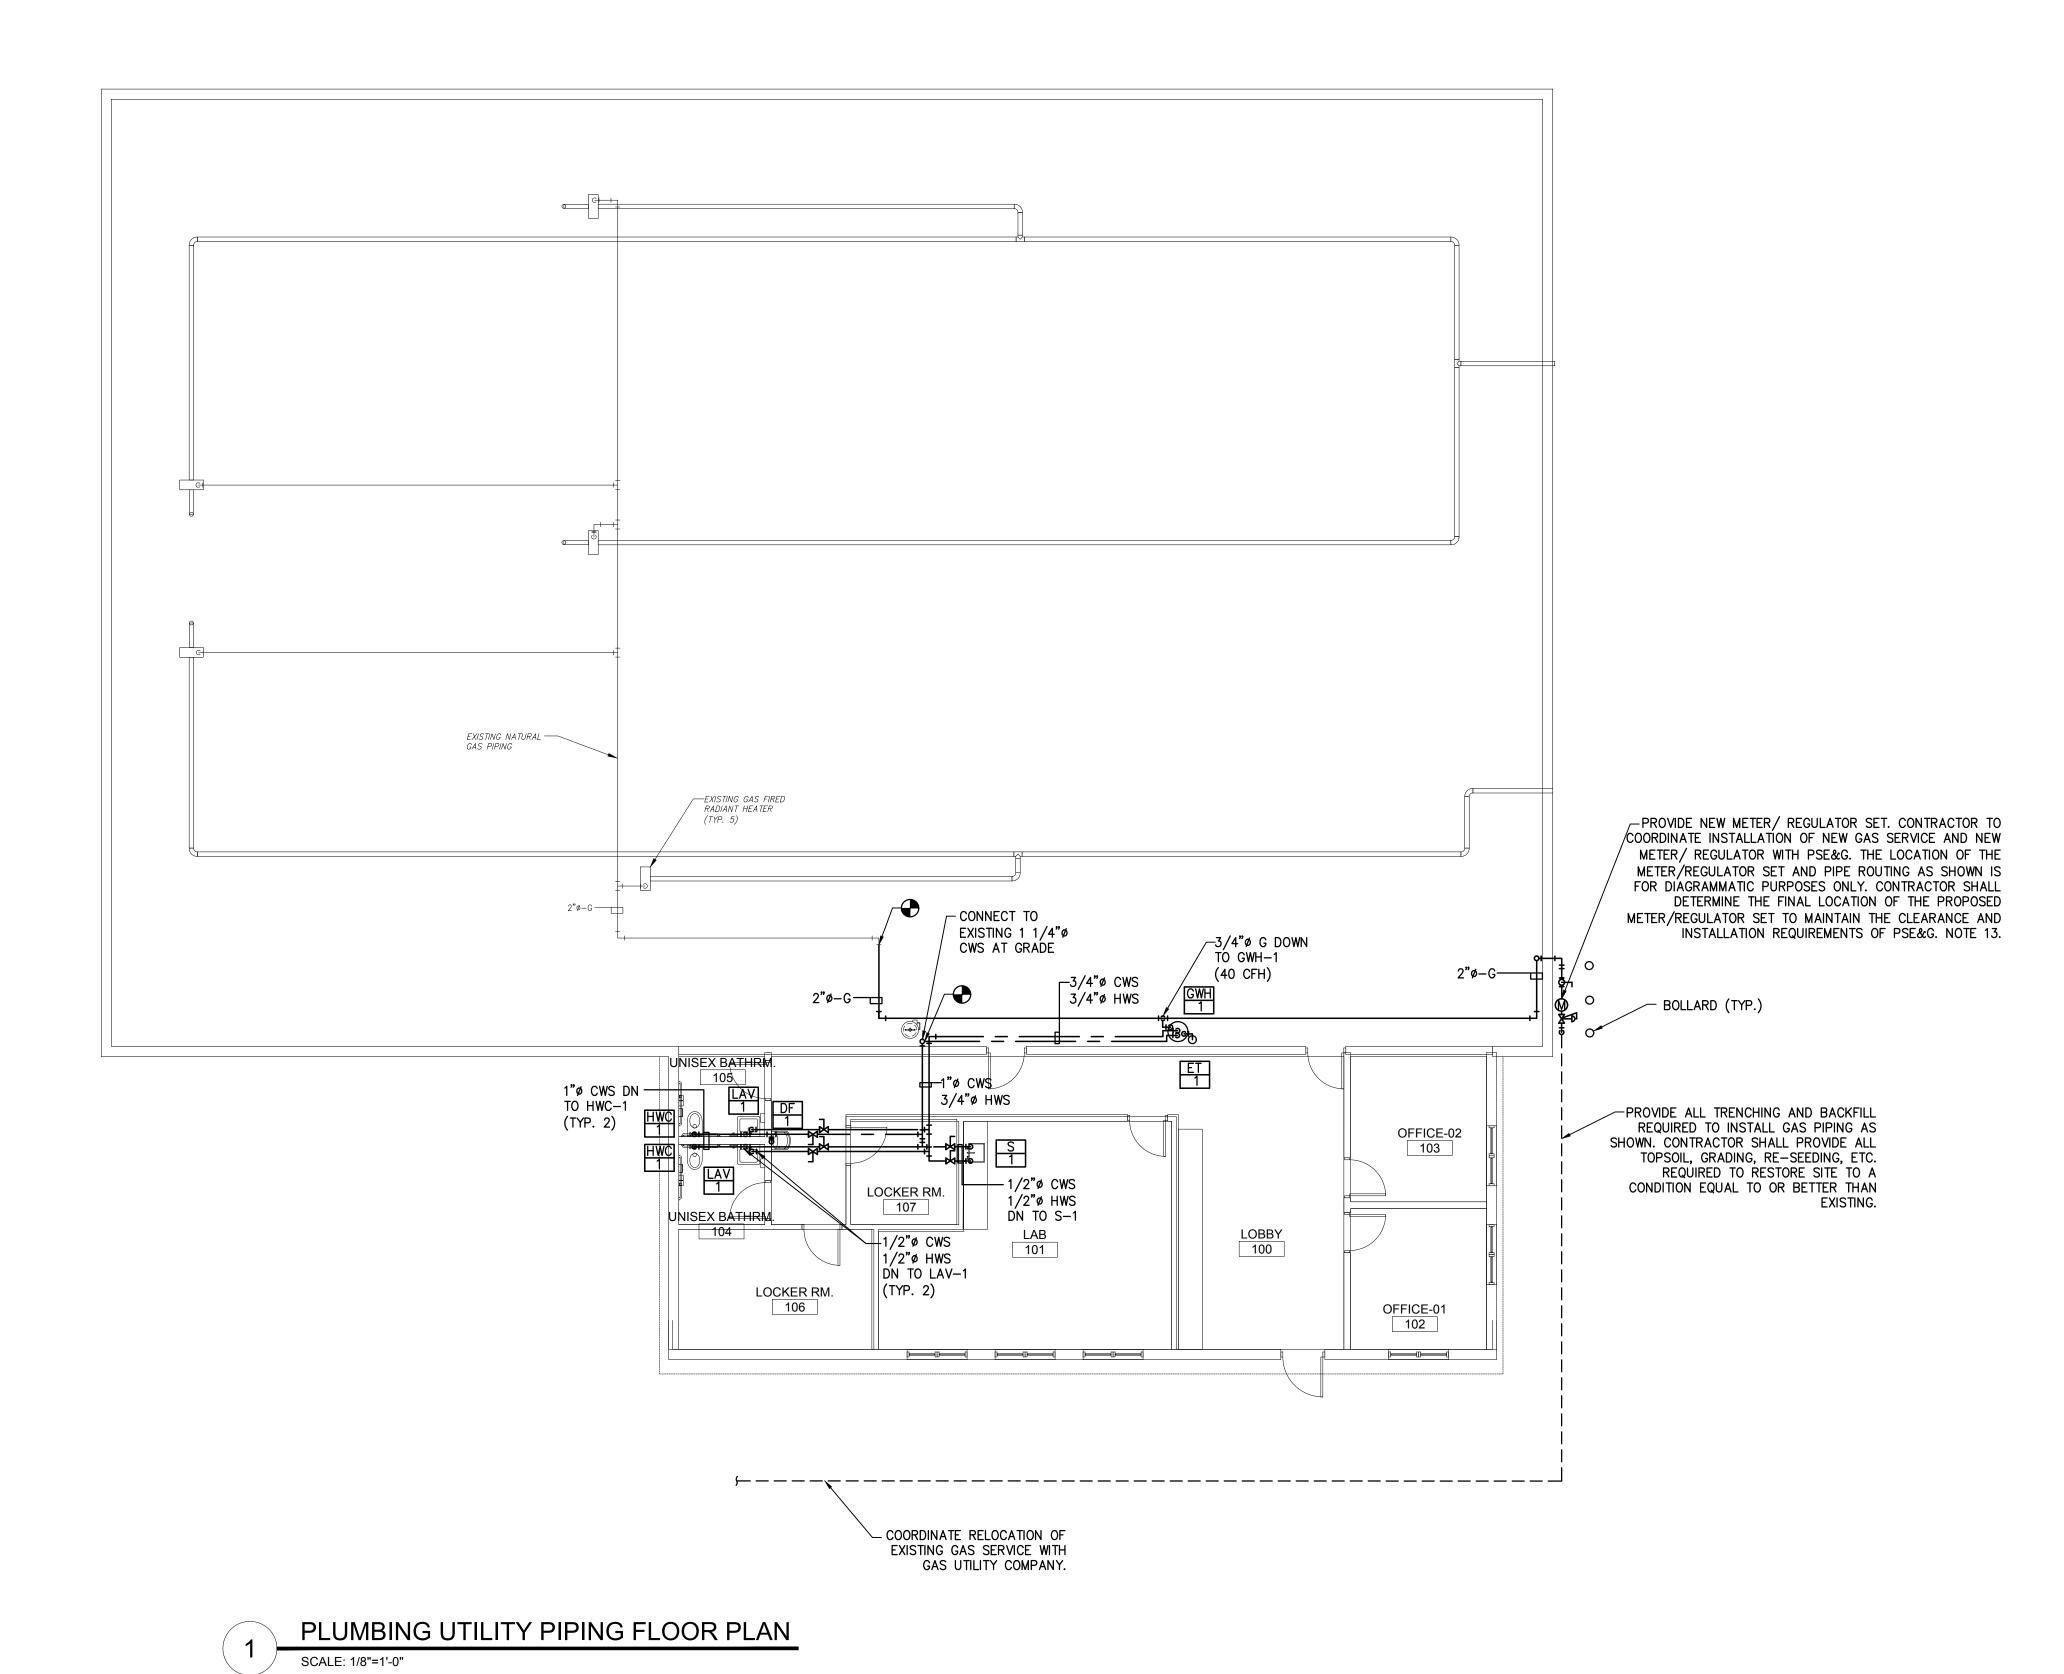

NOTES:

- ALL NOTES, SYMBOLS, AND ABBREVIATIONS ON DRAWING M-1.0 APPLY TO THIS DRAWING.
 COORDINATE PIPING LAYOUTS IN ALL AREAS WITH OTHER TRADES PRIOR TO INSTALLATION TO AVOID INTERFERENCES.
- NOT ALL PIPE SIZES AND IN-LINE DEVICES ARE SHOWN ON THE PLAN FOR CLARITY. THE
 CONTRACTOR SHALL PROVIDE ALL REDUCERS, VALVES, WATER HAMMER ARRESTORS, ETC. AS
 REQUIRED TO COMPLETE THE NEW WORK EVEN IF NOT SPECIFICALLY SHOWN ON THE PLAN,
 RISER, OR DETAIL DRAWINGS.
 PROVIDE LINE SIZE SHUT-OFF VALVES IN BRANCH LINES WHERE BRANCH LINES CONNECT TO
- MAINS.
 5. DOMESTIC WATER PIPING SHALL BE SOLDERED COPPER TUBE. SEE CONTRACT SPECIFICATION
- 6. CONTRACTOR SHALL PROVIDE ALL CUTTING, EXCAVATION, BACKFILL AND REPAIR OF ALL FLOORS, WALLS, ETC. TO PROVIDE THE WORK. ALL FLOORS, WALLS, ETC. THAT HAVE BEEN SAWCUT/DEMOLISHED TO PROVIDE THE WORK SHALL BE REPAIRED TO A CONDITION EQUAL
- TO OR BETTER THAN THE EXISTING CONSTRUCTION.

 7. PROVIDE METAL ENCLOSURE AROUND INSULATED PIPING TO CONCEAL AND PROTECT ALL
- VERTICAL PIPING. PAINT TO MATCH WALL COLOR.

 8. PROVIDE LINE SIZE SHUT—OFF VALVES IN BRANCH LINE WHERE BRANCH LINES CONNECT TO
- 9. FUEL GAS PIPING SHALL BE STEEL PIPE. PAINT ALL EXPOSED FUEL GAS PIPING (INCLUDING VENTS) IN ACCORDANCE WITH THE CONTRACT SPECIFICATIONS. SEE CONTRACT SPECIFICATION
- VENTS) IN ACCORDANCE WITH THE CONTRACT SPECIFICATIONS. SEE CONTRACT SPECIFICATION SECTION 231123.

 10. ALL GAS PRESSURE REGULATORS SHALL BE RATED AT THE MAXIMUM EMERGENCY PRESSURE
- OF 5 PSI.

 11. ALL GAS PRESSURE REGULATORS SHALL BE SERVICE CLASS FUEL GAS PRESSURE
- REGULATORS.

 12. APPROXIMATE LAYOUT OF PROPOSED PIPING IS SHOWN. CONTRACTOR TO VERIFY PIPING
- LAYOUT IN FIELD AND PROVIDE ALL LABOR AND MATERIALS TO AVOID INTERFERENCES.

 COORDINATE FINAL LAYOUT OF PIPING IN FIELD.
- 13. PROVIDE ALL GAS PIPING IN ACCORDANCE WITH THE 2021 INTERNATIONAL FUEL GAS CODE.



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DATE:


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NJ PROFESSIONAL ENGINEER LIC. No. 40059

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SHEET CONTENTS:

PLUMBING UTILITY PIPING FLOOR PLAN

PROJECT TITLE:

RENOVATION FOR
MAINTENANCE BUILDING
BURLINGTON COUNTY

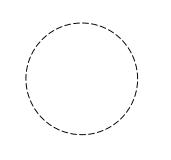10 HARTFORD ROAD, DELRAN TWP.
BURLINGTON CO. NJ


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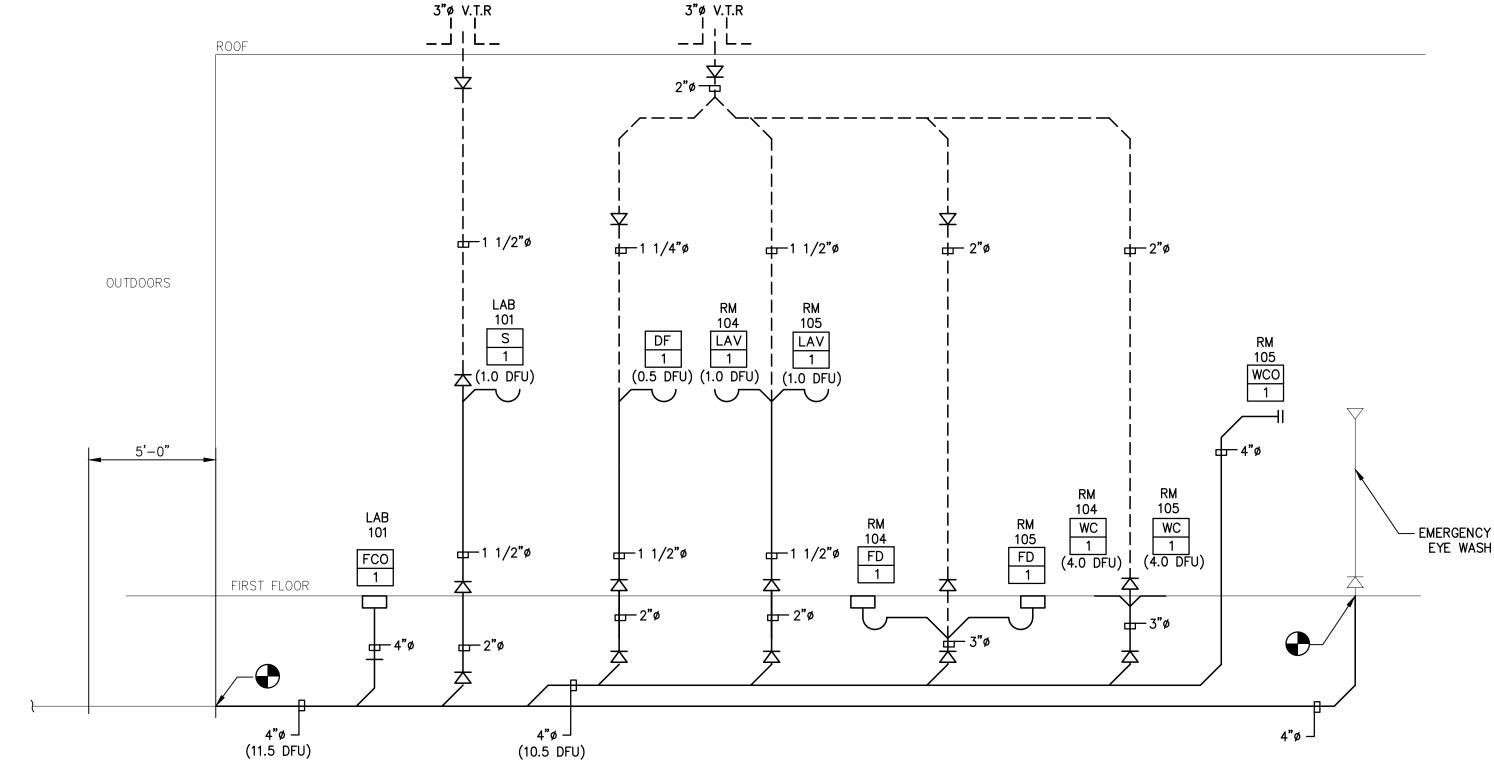
Date 10.08.24
Scale AS SHOWN
Drawn by B.K.
Checked by
Job No. 2241869

P-3.1

Drawing No.

ISSUED FOR BID



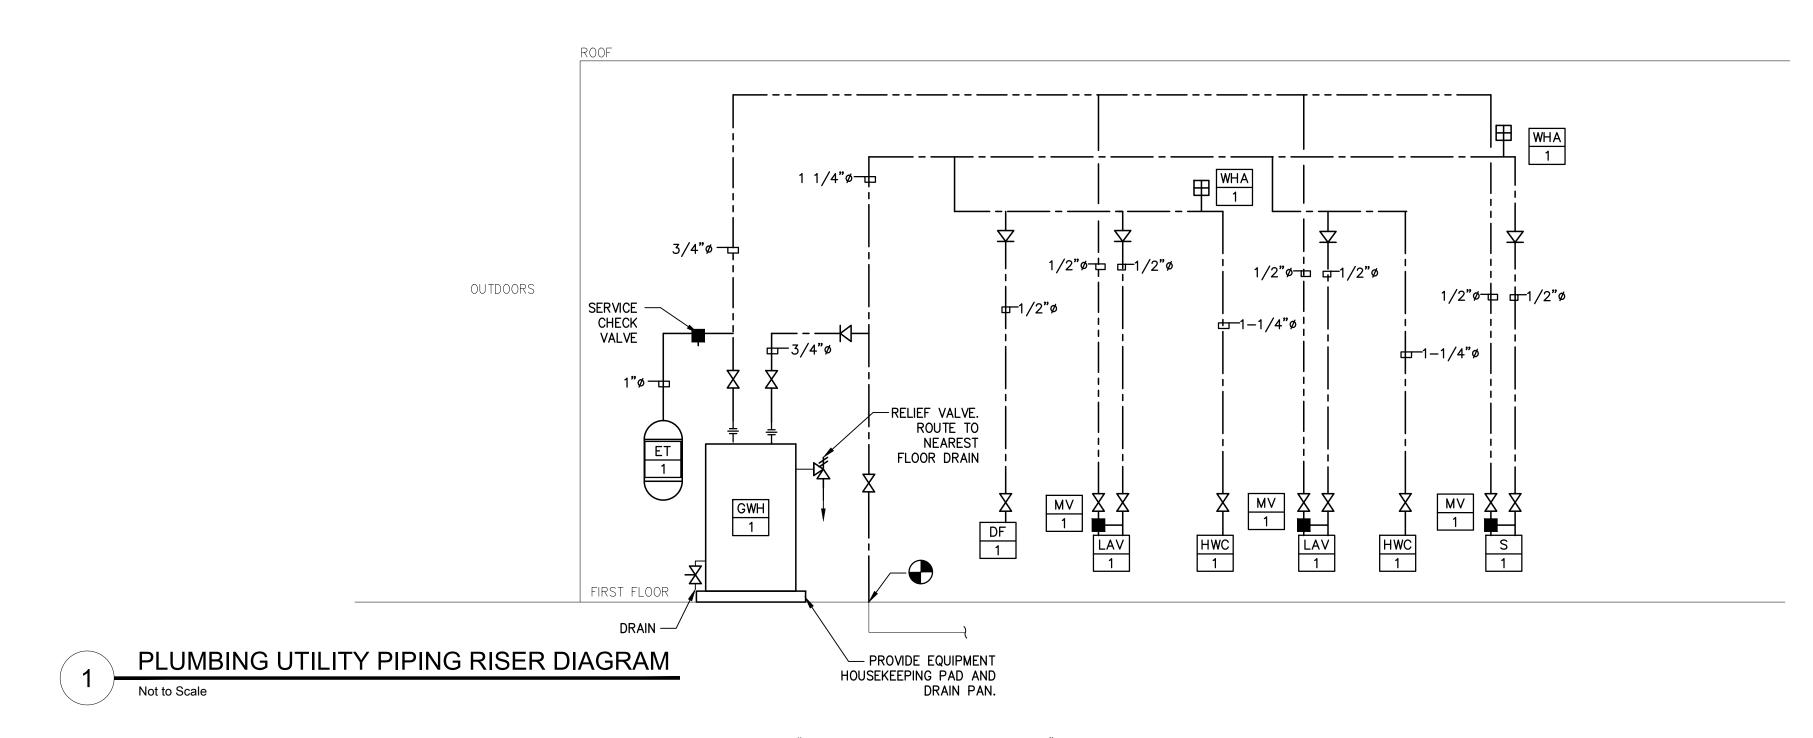

PLUMBING SANITARY PIPING RISER DIAGRAM

UTILITY PIPING RISER DIAGRAM NOTES:

- ALL NOTES, SYMBOLS, AND ABBREVIATIONS ON DRAWING M-1.0 APPLY TO THIS DRAWING.
 NOT ALL PIPE SIZES AND IN-LINE DEVICES ARE SHOWN ON THE PLAN FOR CLARITY, SEE
 THE PLUMBING RISER DIAGRAMS AND DETAIL SHEET(S) FOR ADDITIONAL INFORMATION. THE
 CONTRACTOR SHALL PROVIDE ALL REDUCERS, VALVES, ETC. AS REQUIRED TO COMPLETE THE
 NEW WORK EVEN IF NOT SPECIFICALLY SHOWN ON THE PLAN, RISER, OR DETAIL DRAWINGS.
- 3. REFER TO EQUIPMENT SCHEDULES FOR EQUIPMENT CONNECTION SIZES.4. DOMESTIC WATER PIPING SHALL BE SOLDERED TYPE L COPPER TUBE. SEE
- CONTRACT SPECIFICATIONS FOR ADDITIONAL REQUIREMENTS.


SANITARY PIPING RISER DIAGRAM NOTES:

- ALL NOTES, SYMBOLS, AND ABBREVIATIONS ON DRAWING M-1.0 APPLY TO THIS DRAWING.
 REFER TO PLUMBING FIXTURE SCHEDULES AND FOOD SERVICE DRAWINGS FOR FIXTURE CONNECTION SIZES.
- 3. NOT ALL PIPE SIZES AND IN-LINE DEVICES ARE SHOWN FOR CLARITY, SEE THE PLUMBING DETAIL SHEET(S) FOR ADDITIONAL INFORMATION. THE CONTRACTOR SHALL PROVIDE ALL REDUCERS, VALVES, ETC. AS REQUIRED TO COMPLETE THE NEW WORK EVEN IF NOT SPECIFICALLY SHOWN ON THE PLAN, RISER, OR DETAIL DRAWINGS.
- 4. ALL HORIZONTAL DRAINAGE PIPING 3 INCHES IN DIAMETER AND SMALLER SHALL BE SLOPED A MINIMUM OF 1/4" PER FOOT IN THE DIRECTION OF FLOW. ALL HORIZONTAL DRAINAGE PIPING 4 INCHES THROUGH 6" IN DIAMETER SHALL BE SLOPED A MINIMUM OF 1/8" PER
- FOOT IN THE DIRECTION OF FLOW.

 5. PROVIDE ALL FLOOR DRAINS WITH DEEP SEAL TRAPS.
- 6. SANITARY DRAINAGE AND VENT PIPING SHALL BE CAST IRON, SEE SPECIFICATIONS FOR ADDITIONAL REQUIREMENTS.
- 7. CONTRACTOR SHALL COORDINATE WITH ALL OTHER TRADES AND MODIFY PIPING LAYOUT AS NECESSARY TO AVOID INTERFERENCES. PROVIDE PLUMBING WORK IN ACCORDANCE WITH THE
- 8. IF OFFSETS ARE REQUIRED IN VERTICAL PIPING TO AVOID INTERFERENCES. PROVIDE OFFSET USING 45° FITTINGS. 90° ELBOW FITTINGS SHALL NOT BE USED UNLESS PROVIDED IN ACCORDANCE WITH THE NATIONAL STANDARD PLUMBING CODE.

ISSUED FOR BID

DATE: 01-10-2025

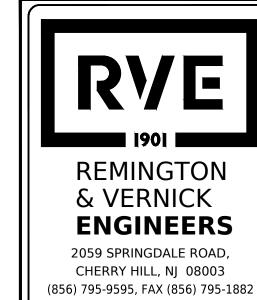


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DATE:

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SHEET CONTENTS:

PLUMBING RISER DIAGRAMS

PROJECT TITLE:

RENOVATION FOR
MAINTENANCE BUILDING
BURLINGTON COUNTY

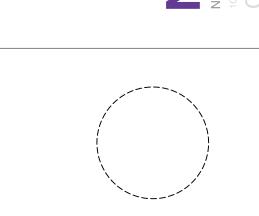10 HARTFORD ROAD, DELRAN TWP.
BURLINGTON CO. NJ

SUBMIS	SSION:		
XXX			
DATE	REVISIONS	BY	CHŁ

Date 10.08.24
Scale AS SHOWN
Drawn by B.K.
Checked by
Job No. 2241869

P-4.1


PLUME	ING FIXTURE SCHED	ULE										
TAG	FIXTURE	DESCRIPTION	MANUF.	MODEL	MANUF.	ACCESSORY	MINIMUM C	ONNECTION	SIZE (in.)		WATER SUPPLY	DRAINAGE FIXTURE
							COLD	НОТ	DRAIN	VENT	FIXTURE UNITS (WSFU's)	UNITS (DFU's)
DF-1	DRINKING FOUNTAIN	SINGLE ADA COOLER REFRIGERATED STAINLESS	ELKAY	LZS8WSSP	ELKAY	51600C FILTRATION KIT, LKAPREZL APRON, MLP100 CARRIER	1/2	N/A	1 1/2	1 1/4	0.25	0.5
ET-1	EXPANSION TANK	DIAPHRAGM EXPANSION TANK	AMTR□L	ST-5C-DD	AMTR□L	HEAVY DUTY BUTYL NSF/ANSI 61	3/4	N/A	N/A	N/A	N/A	N/A
FC0-1	CLEANDUT	HEAVY DUTY ADJUSTABLE FLOOR CLEANOUT	ZURN	Z1400	ZURN	ZN, VP	N/A	N/A	LINE	N/A	N/A	N/A
FD-1	FLOOR DRAIN	HEAVY DUTY SHALLOW SUMP FLOOR DRAIN	WADE	1200	WADE	NICKEL BRONZE TOP, VANDAL PROOF, HEEL PROOF GRATE, SEDIMENT BUCKET, SPECIAL DUTY, DEEP SEAL TRAP	N/A	N/A	3	2	N/A	0.0
HWC−1	WATER CLOSET	ELONGATED 1.6 GPF FLOOR MOUNTED ADA COMPLIANT PRESSURE ASSISTED TANK STYLE WATER CLOSET	ZURN	Z5560	ZURN	RH, Z5972-CDMB, Z5958SS-EL, Z8800-CR	1	N/A	3	2	2.5	4.0
LAV-1	LAVATORY SINK	WALL HUNG VITREDUS CHINA LAVATORY	ZURN DNE SYSTEM	Z5314.464.3.01.41.5	ZURN	4" CENTERSET Z81104-XL-3M MANUAL FAUCET, ADA TRAP PROTECTOR, SUPPLY STOPS, P-TRAP, NOTE 3	1/2	1/2	1 1/2	1 1/2	1.0	1.0
M∨-1	MIXING VALVE	THERMOSTATIC POINT OF USE MIXING VALVE	LEONARD	MODEL 270-LF	N/A	N□TE 3	1/2	1/2	N/A	N/A	N/A	N/A
S-1	COUNTERTOP SINK	STAINLESS STEEL SINGLE BOWL SINK W/FAUCET AND DRAIN	ELKAY	LR2522	ELKAY	PROVIDE WITH LK1000CR FAUCET, OFFSET DRAIN, TRAP, SUPPLIES WITH STOPS.	1/2	1/2	1 1/2	1 1/2	1.5	2.0
WC□-1	WALL CLEAN DUT	WALL CLEAN OUT TEE AND COVER	ZURN	Z1441	ZURN	ZB-VP	N/A	N/A	LINE	N/A	N/A	N/A
WHA-1	WATER HAMMER ARRESTOR	INLINE WATER HAMMER ARRESTOR	WILKINS/ZURN	1250XL-B	N/A	N□TE 4	3/4	N/A	N/A	N/A	N/A	N/A
NULES	1 COLOR/FINISH TO RE AS APPROVED	D BY THE APCHITECT/DWAFP										

1. CULUR/FINISH IU BE AS APPRUVED BY THE ARCHITECT/UWNER.


- 2. PROVIDE ALL ACCESSORIES REQUIRED TO OPERATE AND INSTALL FIXTURES. INSTALL FIXTURES IN ACCORDANCE WITH THE MANUFACTURES RECOMMENDATIONS AND ALL APPLICABLE CODES. COORDINATE FIXTURE DIMENSIONS WITH ARCHITECTURAL DRAWINGS.
- 3. PROVIDE MIXING VALVES IN ACCORDANCE WITH MANUFACTURER'S RECOMMENDATIONS, LOCATE IN ACCESSIBLE LOCATION, PROVIDE ACCESS PANEL AS REQUIRED.
- 4. PROVIDE ACCESS PANELS FOR WATER HAMMER ARRESTORS AS RECOMMENDED BY THE MANUFACTURER. COORDINATE WITH GENERAL CONTRACTOR.


GAS HOT WATER HEATER SCHEDULE											
TAG	MANUF.	MODEL	STORAGE CAPACITY (gallons)	GAS INPUT (BTU)	ENERGY FACTOR	FIRST HOUR RATING	RECOVERY @ 90 °F (gal/hr)	VENT SIZE (in)	COLD WATER INLET (in.)	HOT WATER OUTLET (in.)	NOTES
GHW-1	L□CHIN∨AR	GTN040 35	38	35,500	0.59	65	38	3	3/4	3/4	1

1. PROVIDE WITH LOW-WATER CUT-OFF, INTEGRATED CONTROL WITH LCD DISPLAY, TEMPERATURE/PRESSURE RELIEF VALVES, ALARM CONTACTS, MANUAL RESET HIGH LIMIT, POWER DIRECT VENT SYSTEM,

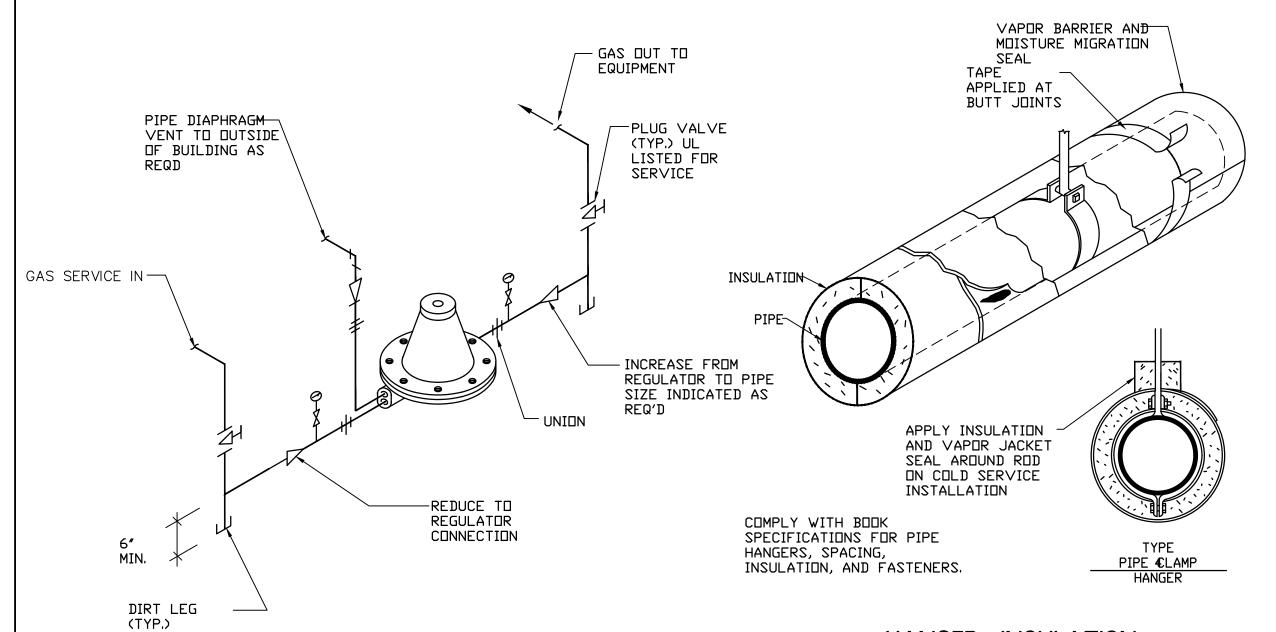

HANGER, INSULATION GAS PRESSURE REDUCING STATION AND VAPOR JACKET DETAIL

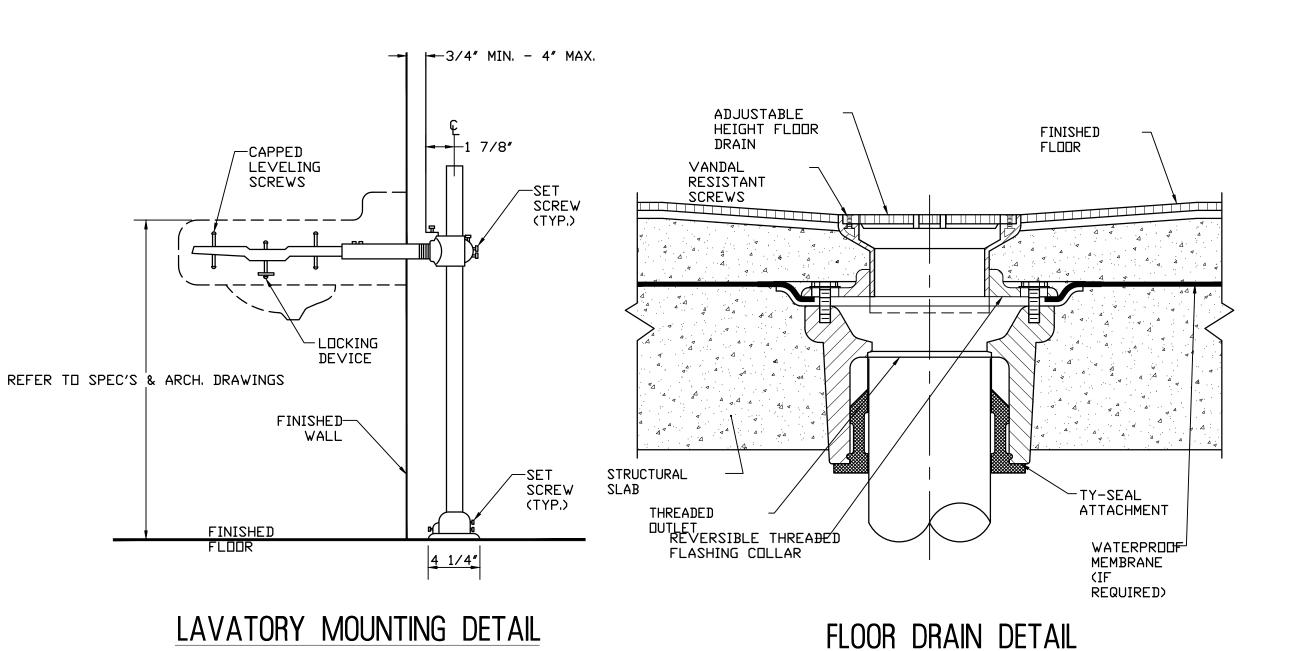


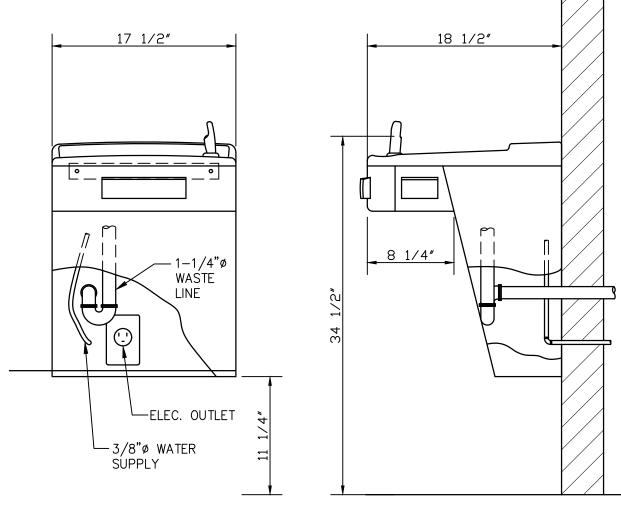


1. IF COOLER IS SET IN ALCOVE OR NEAR CORNER, ALLOW 1-/2" PER SIDE FOR VENTILATION.


2. SIMILAR FOR BARRIER-FREE SPLIT LEVEL COOLER. PROVIDE IN ACCORDANCE WITH THE ARCHITECTURAL DRAWINGS, MANUFACTURER'S RECOMMENDATIONS, AND ALL APPLICABLE CODES AND STANDARDS.

BARRIER-FREE VERSACOOLER

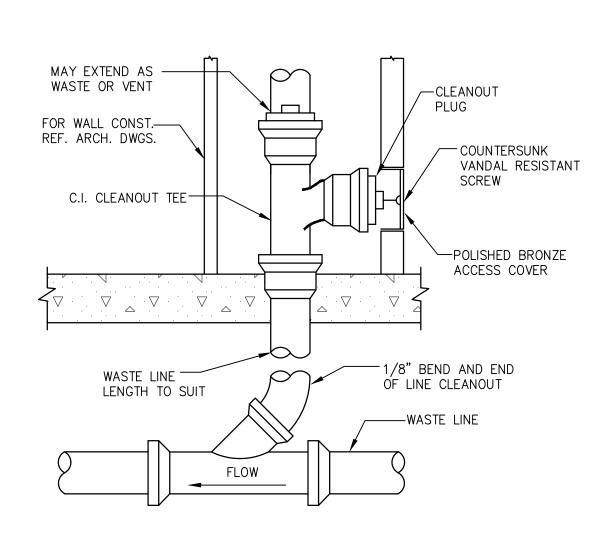

WALL CLEANOUT FOR FINISHED ROOMS

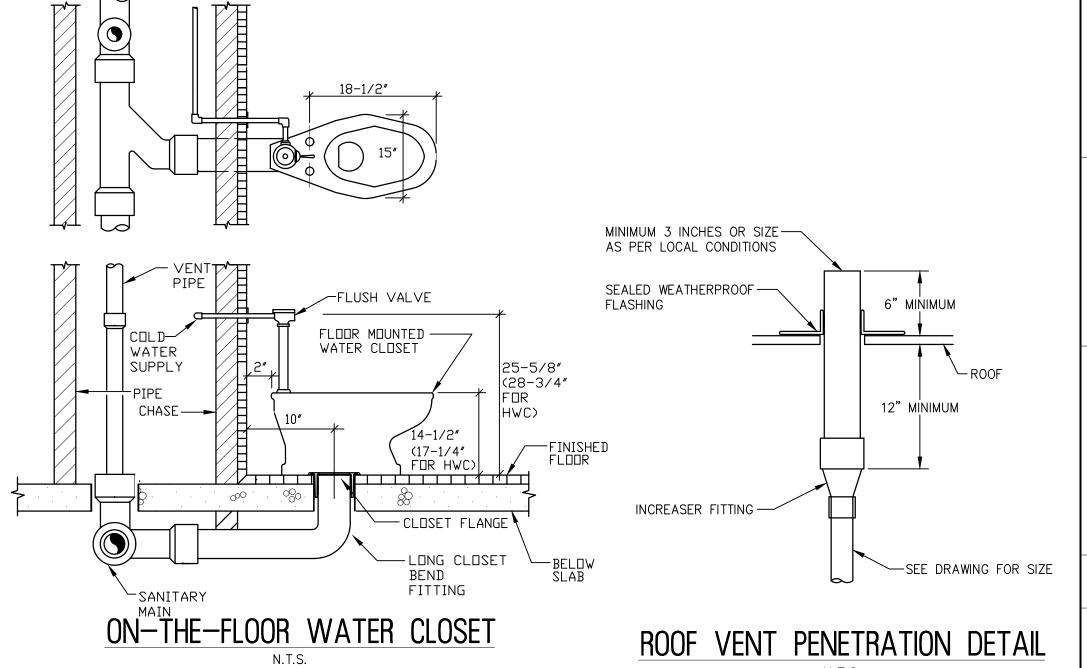

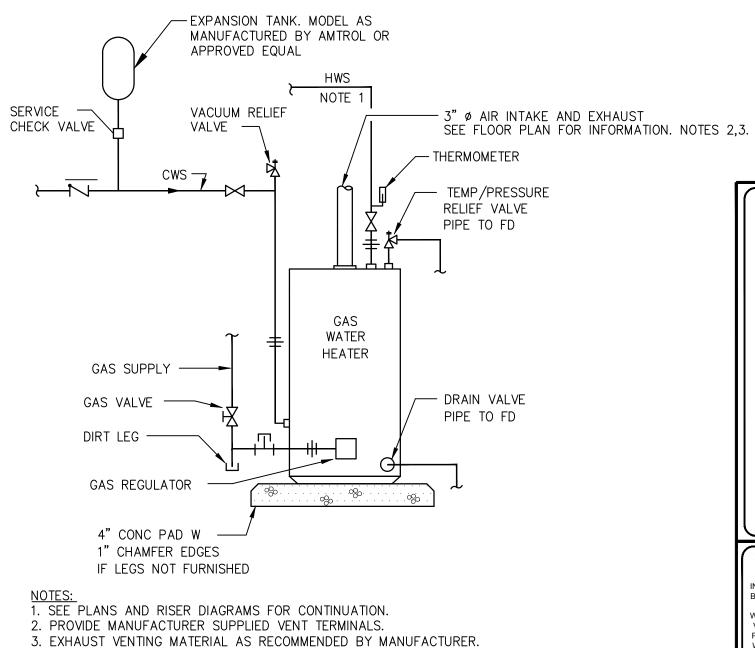

ISSUED FOR BID


DATE: 01-10-2025

HOT WATER SYSTEM PIPING



CHRISTOPHER A. SAPONARO NJ PROFESSIONAL ENGINEER LIC. No. 40059



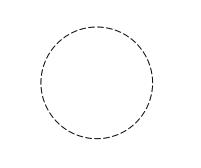

NICHOLAS J. NETTA, AIA, NCARB NJ License No. Al 12541 LAURENCE K. UHER, AIA, LEED, AP NJ License No. Al 14394

ROBERT E. McNAMARA, AIA NJ License No. Al 997600

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SHEET CONTENTS:

PLUMBING DETAILS AND SCHEDULES

PROJECT TITLE:

SUBMISSION:

Checked by


Drawing No.

RENOVATION FOR MAINTENANCE BUILDING **BURLINGTON COUNTY** 10 HARTFORD ROAD, DELRAN TWP. BURLINGTON CO. NJ

DATE	REVIS	SIONS	BY	CHKD
Date		10.08.24		
Scale		AS SHOWI	V	
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3. THE CONTRACTOR IS RESPONSIBLE FOR REPAIRING & REPLACING

REMINGTON & VERNICK ENGINEERS


2059 SPRINGDALE ROAD, CHERRY HILL, NJ 08003
(856) 795-9595, FAX (856) 795-1883

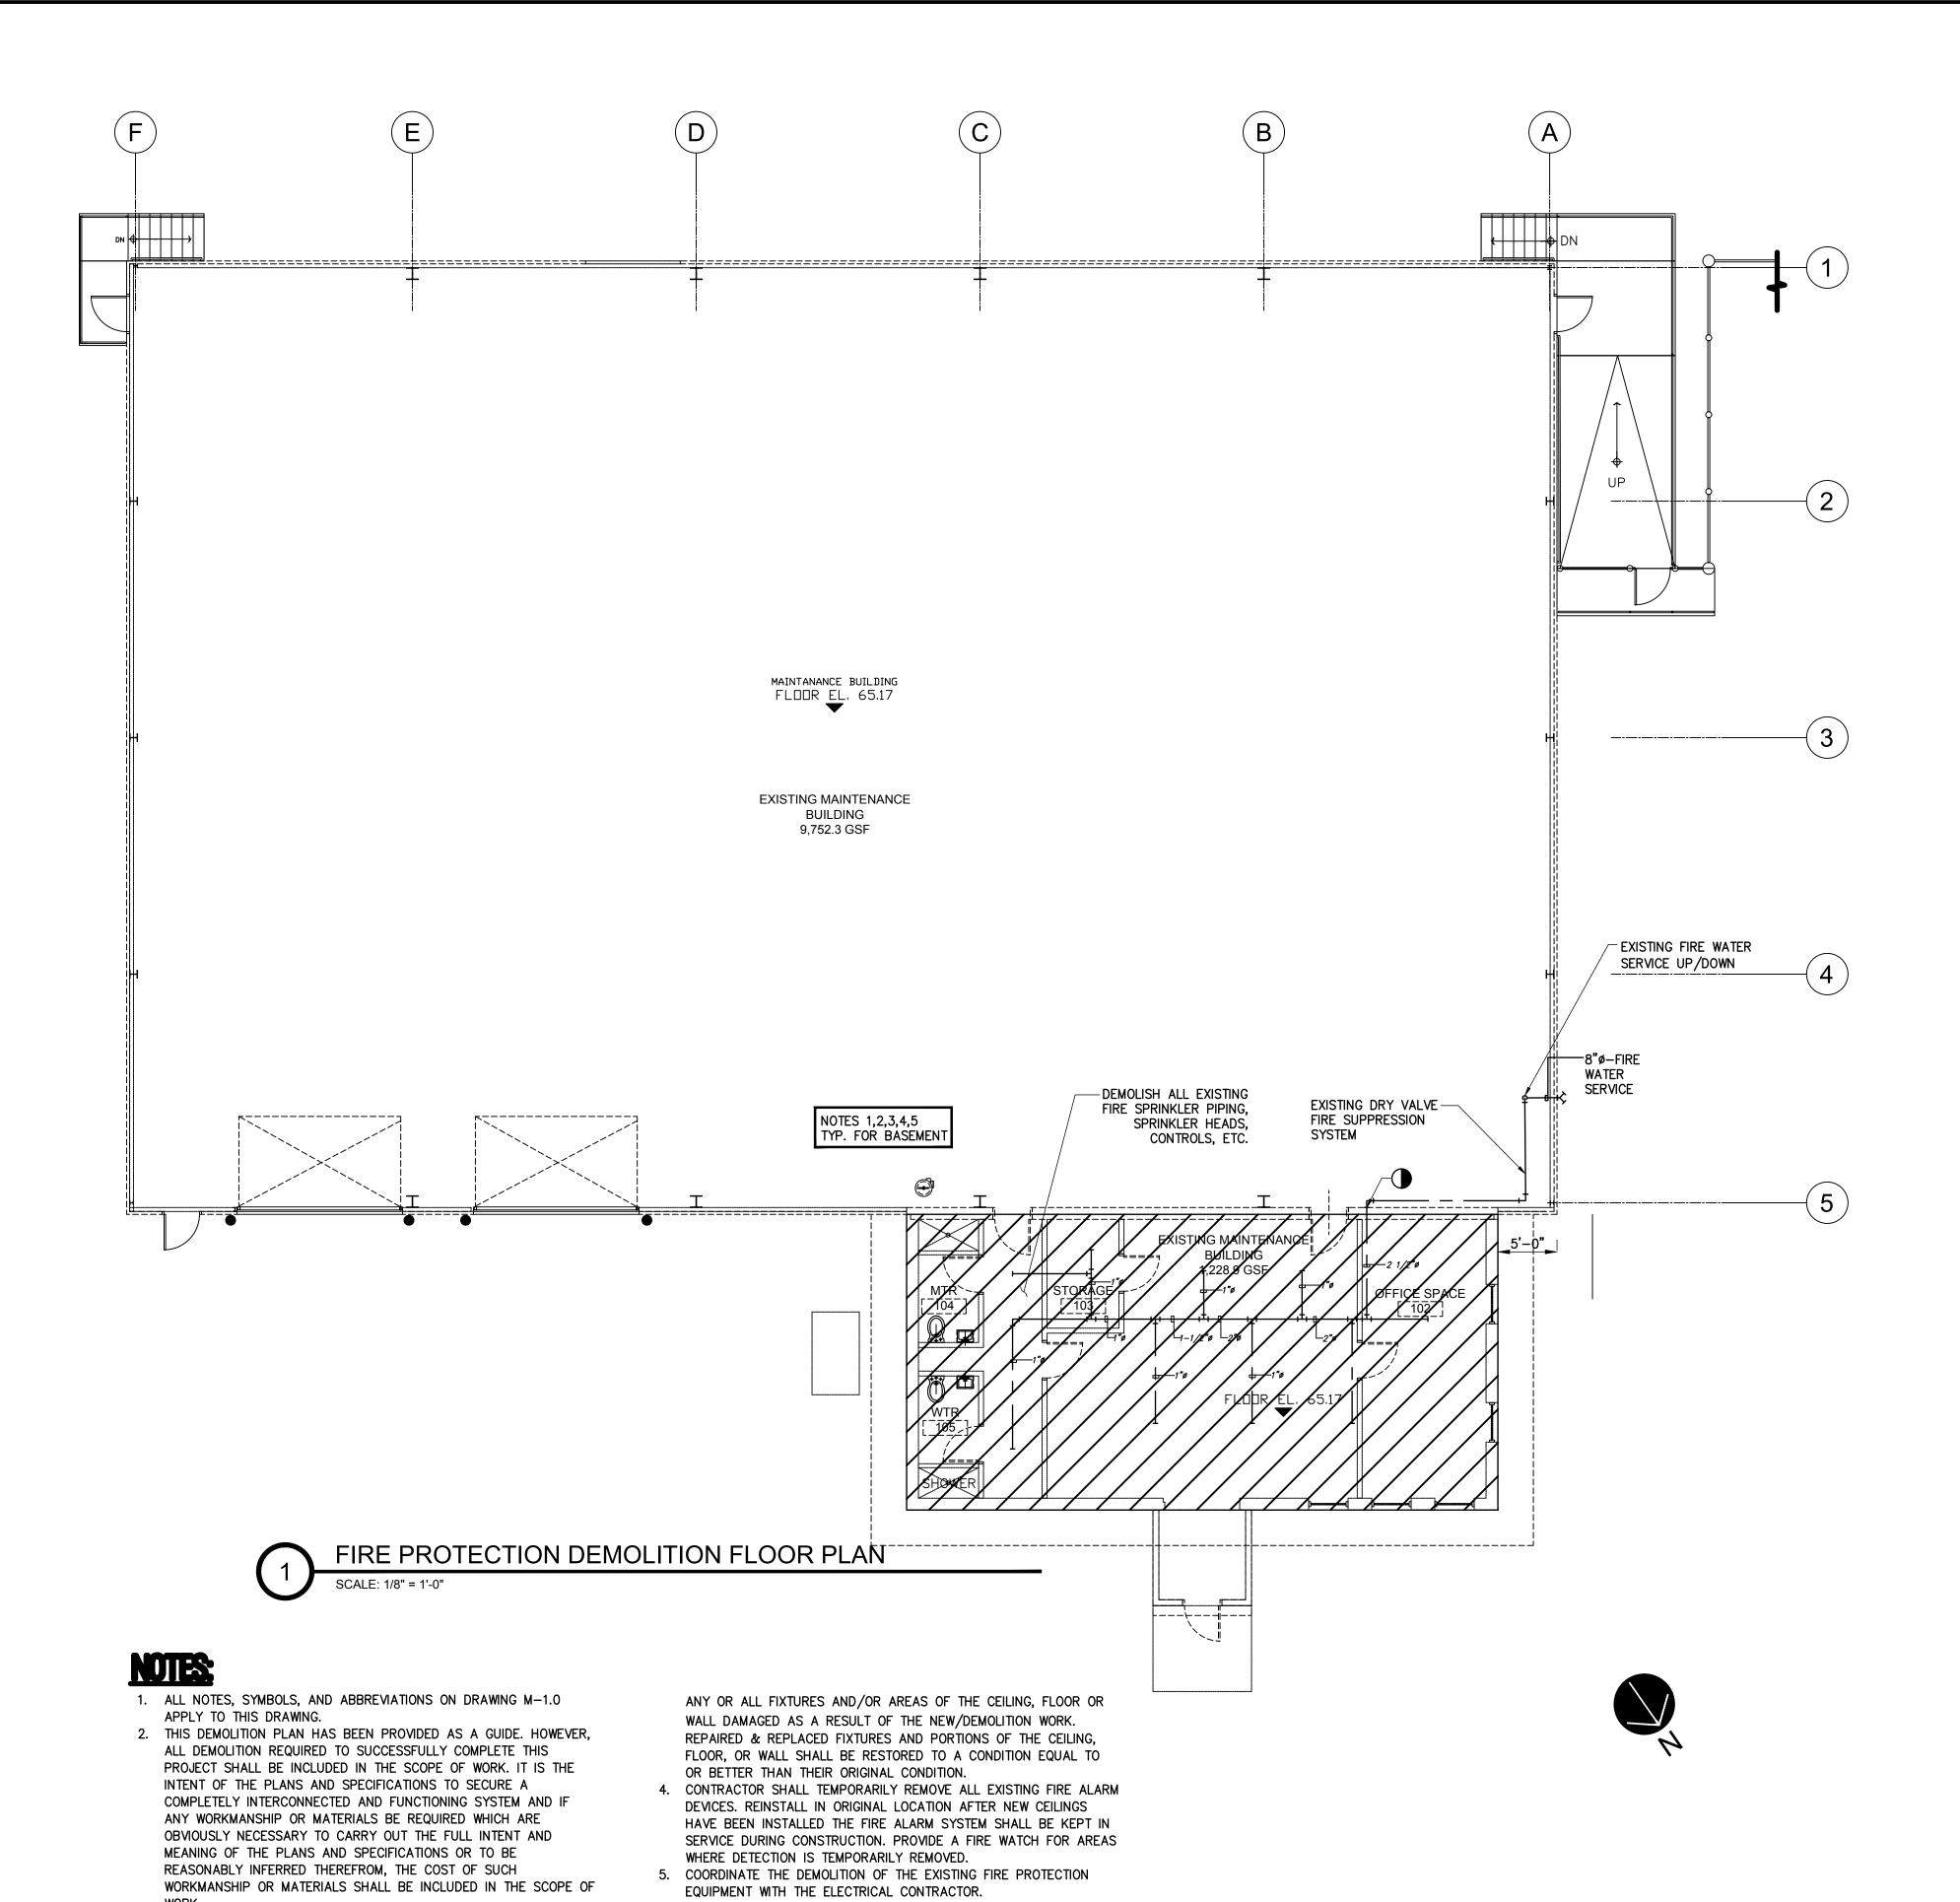CHERRY HILL, NJ 08003
(856) 795-9595, FAX (856) 795-1882
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NJ PROFESSIONAL ENGINEER LIC. No. 40059





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SHEET CONTENTS:

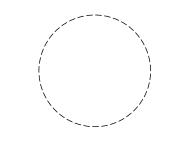FIRE PROTECTION
DEMOLITION FLOOR PLAN


PROJECT TITLE:


RENOVATION FOR
MAINTENANCE BUILDING
BURLINGTON COUNTY

10 HARTFORD ROAD, DELRAN TWP.
BURLINGTON CO. NJ

SUBMISSION	•		
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DATE REVIS	SIONS	BY	CHK
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- 1. ADJUST SPRINKLER DROPS AS NECESSARY TO CLEAR OBSTRUCTIONS SUCH AS THE CEILING "T" BAR SUSPENSION SYSTEM, LIGHT FIXTURES, ETC. PROVIDE A PIPE HANGER IF THE HORIZONTAL OFFSET LENGTH EXCEEDS 24 INCHES.
- 2. THIS SPRINKLER HEAD DROP IS APPLICABLE ONLY WHERE IT IS NOT NECESSARY TO RETAIN AN UPRIGHT SPRINKLER FOR PROTECTION OF COMBUSTIBLE CONSTRUCTION ABOVE THE CEILING.


TYPICAL NEW SPRINKLER HEAD DROP

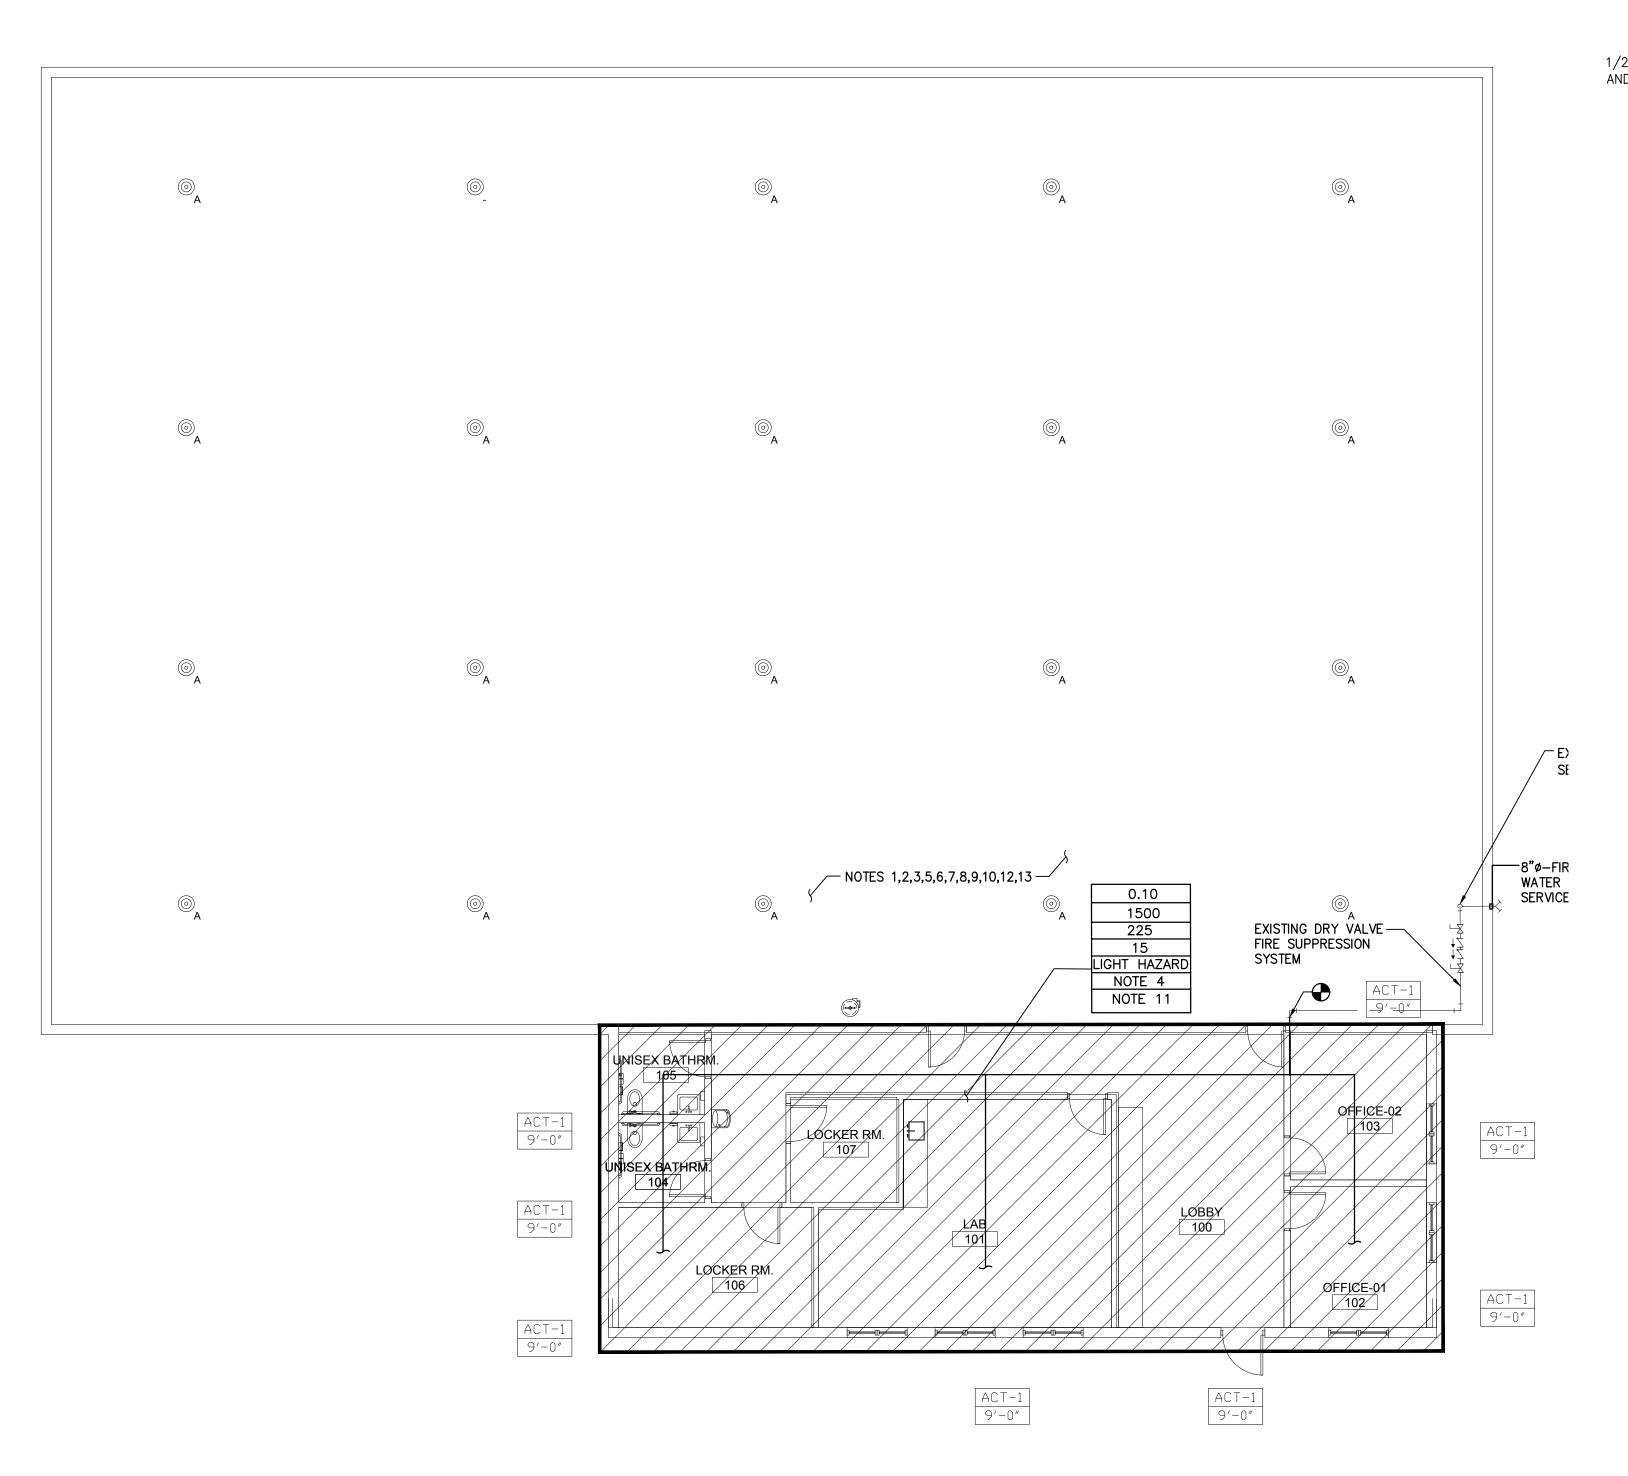-1" BLACK STEEL SCHEDULE 40 PIPING, 1/2" SCHEDULE 80 — CLOSE NIPPLE AND LENGTH A 1/2" X 1" ELBOW LENGTH TO SUIT SPRINKLER BRANCH LINE-1"x1/2" PIPE REDUCING COUPLING SUSPENDED CEILING -

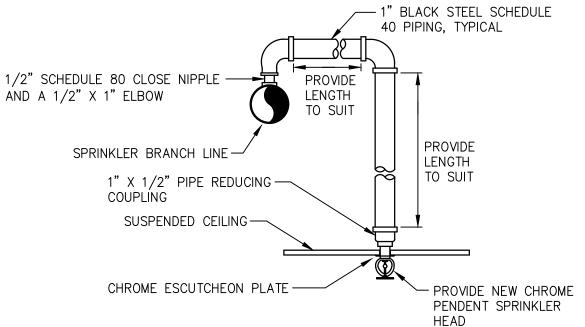CONSTRUCTION ABOVE THE CEILING.

1. ADJUST SPRINKLER DROPS AS NECESSARY TO CLEAR OBSTRUCTIONS SUCH AS THE CEILING "T" BAR SUSPENSION SYSTEM, LIGHT FIXTURES, ETC.PROVIDE A PIPE HANGER IF THE HORIZONTAL OFFSET LENGTH EXCEEDS 24 INCHES. 2. THIS SPRINKLER HEAD DROP IS APPLICABLE ONLY WHERE IT IS NOT NECESSARY TO RETAIN AN UPRIGHT SPRINKLER FOR PROTECTION OF COMBUSTIBLE

NEW SPRINKLER HEAD DROP WITH RECESSED SPRINKLER HEAD

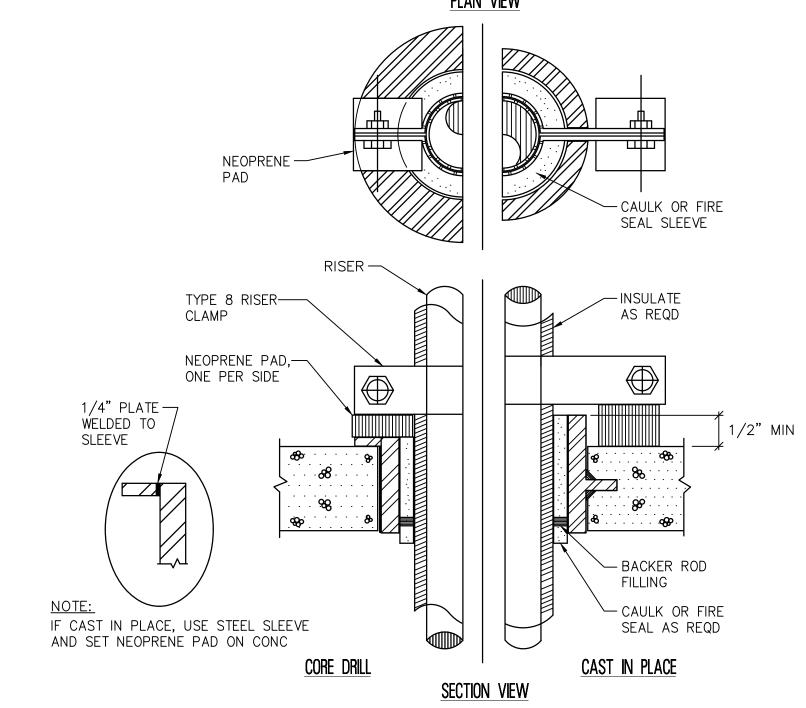

TYPICAL SINGLE PIPE RISER CLAMP WITH VIBRATION ISOLATION

FIRE PROTECTION FLOOR PLAN

LEGEND

SPRINKLER DENSITY-(GPM/2FT) XXX AREA OF SPRINKLER OPERATION (FT2) MAX COVERAGE AREA PER SPRINKLER (FT2) XXX XXX MAX SPACING (FT) NFPA CLASSIFICATION XXX SPRINKLER TYPE XXX NOTES

NOTES:

- 1. ALL NOTES, SYMBOLS, AND ABBREVIATIONS ON DRAWING M-1.0 APPLY TO THIS DRAWING. 2. ALL PIPE SIZES SHOWN ON THE DRAWING ARE EXISTING PIPE SIZES. FIRE PROTECTION CONTRACTOR SHALL SIZE PIPING BASED ON HYDRAULIC CALCULATIONS IN ACCORDANCE WITH NFPA AND SPECIFICATIONS. PRIOR TO PERFORMING HYDRAULIC CALCULATIONS, THE CONTRACTOR SHALL PERFORM A FLOW TEST IN ACCORDANCE WITH NFPA TO DETERMINE STATIC AND RESIDUAL PRESSURES AND CAPACITIES. COORDINATE FLOW TEST WITH LOCAL AUTHORITIES.
- 3. FIRE PROTECTION CONTRACTOR SHALL COORDINATE INSTALLATION OF SPRINKLER HEADS WITH OTHER TRADES TO AVOID INTERFERENCES WITH DUCTWORK PIPING, CONDUIT,
- STRUCTURE, ETC. 4. PROVIDE CONCEALED TYPE SPRINKLER HEADS IN ALL ROOMS WITH SUSPENDED CEILINGS. PROVIDE UPRIGHT OR PENDENT TYPE SPRINKLER HEADS IN AREAS WITHOUT CEILINGS. PROVIDE INTERMEDIATE TEMPERATURE HEADS IN THE ALL AREAS THAT ARE HEATED ONLY. PROVIDE ORDINARY TEMP SPRINKLERS IN STORAGE ROOMS. FOR AREAS WITH SECURITY CEILINGS, PROVIDE SECURE, TAMPER PROOF INSTITUTIONAL SPRINKLER.
- 5. FIRE PROTECTION CONTRACTOR SHALL BE RESPONSIBLE FOR FINAL QUANTITIES AND LOCATIONS IN THE FIELD AS REQUIRED TO AVOID INTERFERENCES WITH DIFFUSERS, DUCTWORK, BUILDING STRUCTURE CONDUIT, ETC. AND THAT THESE FINAL QUANTITIES AND LOCATIONS ARE IN ACCORDANCE WITH NFPA.
- 6. CONTRACTOR SHALL BE REQUIRED TO DEMOLISH ALL EXISTING FIRE PROTECTION SPRINKLERS IN THE AREA WHERE NEW COVERAGE IS TO BE PROVIDED AS SHOWN ON THIS PLAN.
- 7. CONTRACTOR SHALL MAKE ALL REVISIONS TO EXISTING PIPING AND SPRINKLERS AS NECESSARY TO PROVIDE PROPOSED COVERAGE AS SHOWN ON THESE PLANS AND TO RETAIN EXISTING COVERAGE TO ALL OTHER AREAS OF THE BUILDING.
- 8. CONTRACTOR TO INVESTIGATE AND FIELD VERIFY THE EXISTING FIRE PROTECTION SPRINKLER PIPE SIZE AND LAYOUT AS NECESSARY TO PERFORM HYDRAULIC CALCULATIONS AND PROVIDE COVERAGE IN ACCORDANCE WITH THE PLANS AND SPECIFICATIONS. IT IS STRONGLY RECOMMENDED THAT THE CONTRACTOR VISIT THE SITE PRIOR TO SUBMITTING HIS BID TO FULLY UNDERSTAND THE EXISTING CONDITIONS. CONTRACTOR SHALL INCLUDE IN HIS BID ALL MATERIALS AND LABOR NECESSARY TO PERFORM THE SCOPE OF WORK AS SHOWN ON THE CONTRACT DRAWINGS.
- 9. CONTRACTOR SHALL REUSE EXISTING SPRINKLER PIPING, REMOVE EXISTING HEADS, AND REPLACE SPRINKLER HEADS AND DROPS TO ACCOMODATE NEW CEILING. COORDINATE WITH ARCHITECTURAL CEILING PLAN.
- 10. CONTRACTOR TO DEMOLISH EXISTING BRANCH PIPING AND SPRINKLER DROPS, AND PROVIDE NEW DISTRIBUTION BRANCH PIPING AND SPRINKLER DROPS TO PROVIDE COVERAGE IN ACCORDANCE WITH THE CONTRACT DOCUMENTS. PROVIDE HYDRAULIC CALCULATIONS IN ACCORDANCE WITH NFPA 13 FOR THE RECONFIGURED SPACE. SEE ALSO NOTES 6 AND 7.
- 11. CONTRACTOR TO PROVIDE ALL WORK AND MATERIALS, INCLUDING REVISIONS TO SPRINKLER PIPING, IN ALL AREAS, EVEN IF NOT NOTED ON THIS PLAN, AS NECESSARY PROVIDE THE COVERAGE SPECIFIED.
- 12. CONTRACTOR REQUIRED TO PROVIDE ALL FLOW TESTS, ETC. NECESSARY TO PERFORM THE REQUIRED CALCULATIONS AND SYSTEM INSTALLATION AND TESTING. SEE SPECIFICATION SECTION 211313.
- 13. CONTRACTOR TO REMOVE AND REPLACE ALL CEILING TILES, LIGHTING, ETC. NECESSARY TO INSTALL SPRINKLER PIPING.




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CHRISTOPHER A. SAPONARC NJ PROFESSIONAL ENGINEER LIC. No. 40059

ISSUED FOR BID DATE: 01-10-2025





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FIRE PROTECTION FLOOR PLAN

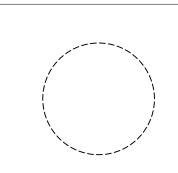PROJECT TITLE:

RENOVATION FOR MAINTENANCE BUILDING **BURLINGTON COUNTY** 10 HARTFORD ROAD, DELRAN TWP.

BURLINGTON CO. NJ
SUBMISSION:
XXX

IREVISIONS BY ICHK 10.08.24

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