


SERVICE IN RESPECT OF THE PROJECT. THEY ARE NOT INTENDED OR REPRESENTED TO BE SUITABLE FOR REUSE OR ON ANY OTHER PROJECT, ANY REUSE WITHOUT VERNICK ENGINEERS AND AFFILIATES FOR THE SPECIFIC PURPOSE INTENDED WILL BE AT OWNERS SOLE RISK AND & VERNICK ENGINEERS AND AFFILIATES: AND OWNER SHALL INDEMNIFY AND HOLD HARMLESS REMINGTON & VERNICK ENGINEERS AND AFFILIATES FROM ALL CLAIMS, RESULTING THEREFROM

AS NOTED

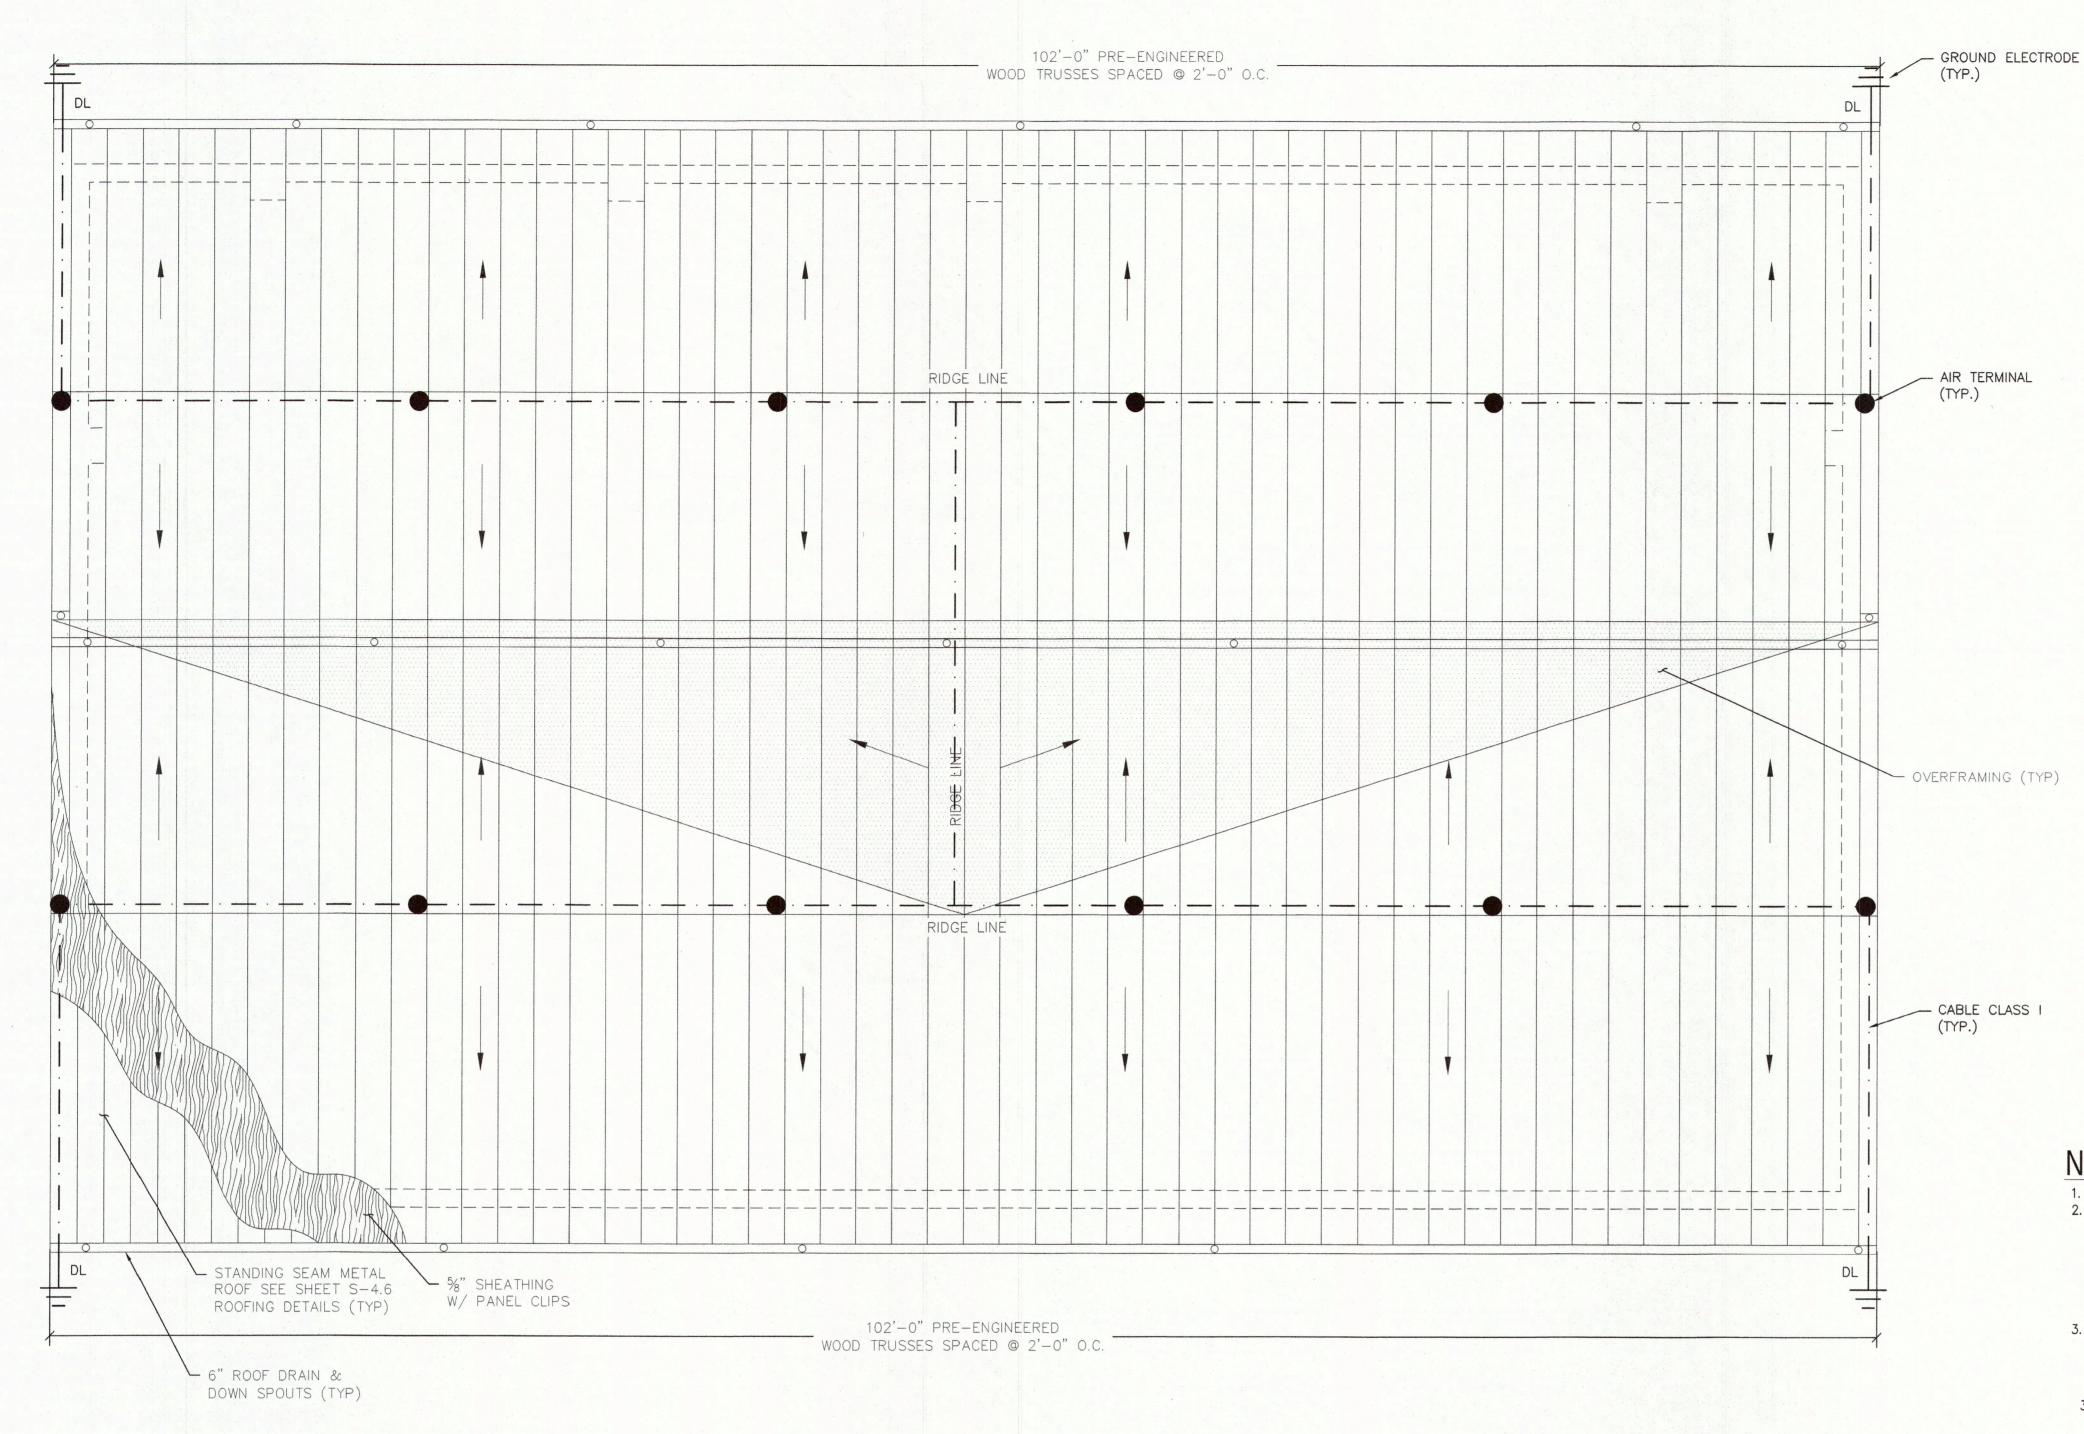

ELECTRICAL LIGHTNING ROOF PLAN SCALE: 3/16"=1'-0"

| • | AIR TERMINAL |
|----------|-------------------------------------|
| | CABLE, CLASS I |
| A | BOND |
| DL | DOWN LEAD CONDUCTOR, ROOF TO GROUND |
| -111 | GROUND ELECTRODE |

- NOTES: 1. ALL NOTES, SYMBOLS, AND ABBREVIATIONS ON DRAWING E-1.0 APPLY TO THIS DRAWING. 2. THIS DRAWING IS DIAGRAMMATIC, IT IS THE CONTRACTOR'S RESPONSIBILITY TO CONFIRM EXISTING SITE CONDITIONS AND INSTALLATION CLEARANCES PRIOR TO SHOP DRAWING SUBMISSIONS AND INSTALLATION. SHOULD THE CONTRACTOR DETERMINE THAT THE INSTALLATION OF ANY ELECTRICAL COMPONENT IS RESTRICTED OR NOT ABLE TO BE INSTALLED IN THE SUGGESTED LOCATION, THE CONTRACTOR SHALL READDRESS THE INSTALLATION ACCORDINGLY AND IN COMPLIANCE WITH THE MOST RECENTLY ADOPTED NATIONAL ELECTRICAL CODE APPROVED BY THE AUTHORITY HAVING JURISDICTION AT NO ADDITIONAL COST.
- 3. ALL MATERIALS AND INSTALLATION WILL CONFORM TO THE MOST RECENT CODE REQUIREMENTS OF THE NATIONAL FIRE PROTECTION ASSOCIATION 780, LIGHTNING PROTECTION INSTITUTE 175 AND UNDERWRITERS LABORATORIES 96 AND 96A, WHOSE INSPECTION WILL BE PERFORMED AT THE COMPLETION OF THE INSTALLATION AND WHOSE CERTIFICATE WILL BE ISSUED UPON FULL PAYMENT OF THE CONTRACT.

3.1. FINAL DESIGN/LAYOUT TO BE FIELD COORDINATED AT THE TIME OF INSTALLATION IN ORDER TO ENSURE THE LIGHTNING PROTECTION SYSTEM (LPS) IS IN COMPLIANCE WITH THE LPS STANDARDS LISTED ABOVE.

- 4. COPPER MATERIALS WILL BE USED FOR CONTACT WITH COPPER SURFACES, THE EARTH, ALKALINE-BASE PAINT, CONCRETE OR MASONRY, OR EXCESSIVE MOISTURE SUCH AS FLAT ROOFS; LEAD OR TIN COATED COPPER WILL BE USED WITHIN 2 FEET OF THE TOP OF A CHIMNEY; AND ALUMINUM MATERIALS WILL BE USED ON ALUMINUM, GALVANIZED STEEL, OR PAINTED METAL SURFACES; IN ACCORDANCE WITH NFPA 780 4.2, UL 96A 7, AND LPI 175
- 5. SOME METAL PARTS OF THE STRUCTURE THAT HAVE A METAL THICKNESS OF 3" OR GREATER MAY BE USED AS STRIKE TERMINATION DEVICES AND CONDUCTORS IN ACCORDANCE WITH NFPA 780 4.6.1.4, UL 96A 8.8.2, AND LPI 175 65.
- 6. CHEMLINK M-1, DURACIL, OR DURALINK ADHESIVE WILL BE USED FOR SECURING TO METAL SURFACES. AN APPROVED ADHESIVE WILL BE USED ON MEMBRANE ROOF AREAS TO SECURE THE CABLES AND BASES IN POSITION. NO MECHANICAL FASTENERS WILL BE DRIVEN INTO MEMBRANE ROOFING. 7. CABLE FASTENERS WILL BE SPACED NO MORE THAN 3' O.C.
- 8. DUE TO SAFETY CONCERNS, EXOTHERMIC WELDING ABOVE GRADE IS NOT PERMITTED. IN LIEU OF EXOTHERMIC WELD, U.L. LISTED BOLT PRESSURE FITTINGS WILL BE USED IN ACCORDANCE WITH NFPA 780 4.12.3, UL 96A 12.13--14, AND LPI 175 43.
- 9. DOWN CONDUCTORS WILL BE ROUTED ON EXTERIOR OF EXISTING BUILDING (NOT CONCEALED INSIDE EXTERIOR WALLS). 10.EACH DOWN CONDUCTOR LOCATED IN A RUNWAY, DRIVEWAY, SCHOOL PLAYGROUND, CATTLE
- YARD, PUBLIC WALK OR SIMILAR LOCATION WILL BE PROTECTED FROM MECHANICAL DAMAGE OR DISPLACEMENT IN ACCORDANCE WITH NFPA 780 4.9.11, UL 96A 9.3.3, AND LPI 175
- 11. UNDERGROUND METALLIC PIPING SYSTEMS WILL BE BONDED AS REQUIRED BY NFPA 780 4.14.4, UL 96A 10.4.1, AND LPI 148. 12.METAL BODIES WITHIN 6 FEET OF LPS CONDUCTORS WILL BE BONDED AS REQUIRED BY
- NFPA 780 4.16, UL 96A 11, AND LPI 175 151. 13.INSTALLATION SHALL BE PERFORMED UNDER THE ONSITE SUPERVISION OF A LPI CERTIFIED
- MASTER INSTALLER. 14.INSTALLATION SHALL BE PERFORMED BY THE WARREN LIGHTNING ROD COMPANY 856-854-7000 OR APPROVED EQUAL.

REMINGTON

& VERNICK **ENGINEERS**


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DENNIS K. YODER NJ PROFESSIONAL ENGINEER LIC. No. 3186



PLANS WHICH DO NOT BEAR AN EMBOSSED SEAL ARE NOT VALID.

ALL DOCUMENTS PREPARED BY REMINGTON & VERNICE ENGINEERS AND AFFILIATES ARE INSTRUMENTS OF SERVICE IN RESPECT OF THE PROJECT. THEY ARE NOT INTENDED OR REPRESENTED TO BE SUITABLE FOR REUSE BY OWNER OR OTHERS ON EXTENSIONS OF THE PROJECT OR ON ANY OTHER PROJECT. ANY REUSE WITHOUT WRITTEN VERIFICATION OR ADAPTATION BY REMINGTON & VERNICK ENGINEERS AND AFFILIATES FOR THE SPECIFIC PURPOSE INTENDED WILL BE AT OWNERS SOLE RISK AND WITHOUT LIABILITY OR LEGAL EXPOSURE TO REMINGTON & VERNICK ENGINEERS AND AFFILIATES; AND OWNER SHALL INDEMNIFY AND HOLD HARMLESS REMINGTON & VERNICK ENGINEERS AND AFFILIATES FROM ALL CLAIMS DAMAGES, LOSSES AND EXPENSES ARISING OUT OF OR RESULTING THEREFROM.

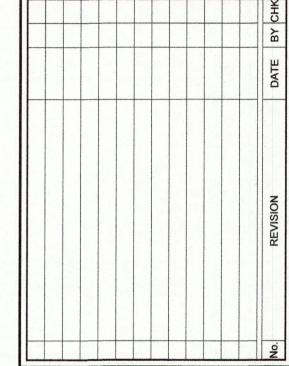

A P JAD IMP ELECT

BROWNING ROA TER

DRAWN BY: DESIGN BY: CHECKED BY: SCALE: DM KM AS NOTE DATE : SHEET No. : 3/24 E-3.4 JOB No. : 0424M081